AGENDA CITY OF STURGEON BAY AESTHETIC DESIGN & SITE PLAN REVIEW BOARD

Monday, August 8, 2022 6:00 p.m. Council Chambers, City Hall 421 Michigan Street, Sturgeon Bay, WI

- 1. Roll call.
- 2. Adoption of agenda.
- 3. Approval of minutes from July 25, 2022.
- 4. Consideration of: 65' x 300' Building for Fincantieri Bay Shipbuilding located at 605 N. 3rd Avenue.
- 5. Adjourn.

NOTE: DEVIATION FROM THE AGENDA ORDER SHOWN MAY OCCUR.

Notice is hereby given that a majority of the Common Council may be present at this meeting to gather information about a subject over which they have decision-making responsibility. If a quorum of the Common Council does attend, this may constitute a meeting of the Common Council and is noticed as such, although the Common Council will not take any formal action at this meeting.

Committee members

Thad Birmingham Nancy Schopf Mark Struck Dave Augustson Kelsey Fox Rick Wiesner Pam Jorns

August 3, 2022 1:00 p.m. CS

AESTHETIC DESIGN AND SITE PLAN REVIEW BOARD Monday, July 25, 2022

The Aesthetic Design and Site Plan Review Board meeting was called to order at 6:05 p.m. by Chairperson Rick Wiesner in the Council Chambers, City Hall, 421 Michigan Street.

Roll Call: Members Rick Wiesner, Dave Augustson, Thad Birmingham and Mark Struck were present. Pam Jorns, Kelsey Fox and Nancy Schopf were excused. Staff present were City Administrator Josh Van Lieshout, Community Development Director Marty Olejniczak, Planner/Zoning Administrator Christopher Sullivan-Robinson and Community Development Administrative Assistant Cindy Sommer.

Adoption of Agenda: Moved by Mr. Birmingham, seconded by Mr. Augustson to adopt the following agenda.

- 1. Roll call.
- 2. Adoption of agenda.
- 3. Approval of minutes from June 27, 2022.
- 4. Consideration of: Revised building design for WWP Development, LLC, Sturgeon Bay Terrace located at 100 E. Maple Street.
- 5. Consideration of: Door County Facilities & Parks Maintenance Garage addition located at 916 N. 14th Ave.
- 6. Adjourn.

All ayes. Carried.

Approval of minutes from June 27, 2022: Moved by Mr. Augustson, seconded by Mr. Struck to approve the minutes. All ayes. Carried.

Consideration of: Revised building design for WWP Development, LLC, Sturgeon Bay Terrace located at 100 E. Maple Street.

Mr. Sullivan-Robinson introduced the revised building plan for WWP Development, LLC, Sturgeon Bay Terrace. The original building plan was approved about a year ago and consisted of a three level building, which has now been revised to two levels. The developer is seeking approval of the final site and landscape plans. The noted revisions are that there is no third level, the previous proposed balconies have been removed, the window layout has been changed, however the general building design and materials will remain unchanged. There are no landscape requirements from a zoning standpoint. Some of the landscape plan and other improvements spills over onto city property, which will be subject to a formal agreement.

Mr. Olejniczak also explained that when the new plans were submitted, American Transmission Company (ATC) made contact and indicated that parts of the transmission line were placed outside of the existing easement and they are seeking an extended easement. The proposed building will have to be moved approximately four feet west to accommodate the existing line and extended easement. This would slightly shift the outside seating and some of the landscaping, but otherwise the plan will not change and any overflow of landscaping and outside seating has already been agreed upon with the City.

Mr. Van Lieshout further explained that none of the features will change, the building will just be moved approximately four feet. The City is working with ATC on the details of the easement, however contesting the change would likely be very costly and cause extended delays.

Peter Gentry of WWP Development, LLC, 6140 N. Shoreside Circle, Sturgeon Bay, explained that moving the building is feasible, though unexpected. The aesthetics of the building would not change. The landscape plan is good and they are already approved for a zero setback. They were ready to break ground last year but the DNR found methane and a mitigation plan was necessary, thereby delaying the project. Building costs have substantially increased, which required them to scale back their plan and remove one story of the building, which would have been a residential rental unit. The full windows have been changed to

transom windows, but otherwise the building remains much the same. The landscape plan is slightly changed because fill was added as part of the DNR mitigation plan, which reduced the grade somewhat. The siding will be gunship gray with cedar accents and dumpster enclosure. The roof will be a darker shade of gray and pergolas will have a dark metal powder coat. Signage will be downward directed LED lighting.

Committee members complimented Mr. Gentry on the attractive plan that fits in well with the city aesthetics.

Motion made by Mr. Struck to approve the building design and landscape plan as presented but subject to the building location being moved to meet the anticipated ATC easement requirements. Motion seconded by Mr. Birmingham. All ayes. Motion carried.

Consideration of: Door County Facilities & Parks Maintenance Garage addition located at 916 N. 14th Ave.

Mr. Sullivan-Robinson introduced a proposed 40' x 60' x 18' building addition by the County of Door to an existing facility building at John Miles County Park. The addition will be just east of the current ADRC building and have metal siding and roof with wainscoting, large overhead doors and entry doors. Lighting will be downward directed. The design features will match the ADRC building and be compatible with the other existing buildings. There are no storm water management concerns. The color palette is shown in the provided packet of material. Staff recommends approval of the proposed addition as presented.

Mr. Wayne Spritka, Director of Door County Facilities and Parks Department, 421 Nebraska Street, presented the project and explained that the current building does not have water and sewer for employee restrooms. They have moved all of their operations to John Miles County Park and have outgrown their buildings. The landscape plan depicted in the packet is not very detailed and the trees shown will be moved to the west side with other trees and shrubs. The county is looking at PV solar to be added to the roof, but no decision has been made on the scope of the plan, which could involve either the east and west sides of the roof, or even the entire roof. Panels are typically placed at 30 degrees, which will change the height of the roof somewhat.

The existing building was previously an ambulance garage, then revamped into a tire garage. The county considered razing the building and doing a complete rebuild, but determined that an addition is the better plan. The design will match the current ADRC building to the best of their ability with current available materials. The east side may remain as it is but, if cost effective, may also be re-sided. The lighting plan will match what is already in place throughout the grounds.

Mr. Augustson moved to approve the proposed addition as presented with the landscape changes on the west side. Motion seconded by Mr. Struck. All ayes. Motion carried.

Adjourn: Moved by Mr. Augustson, seconded by Mr. Wiesner to adjourn. All ayes. Motion carried. The meeting adjourned at 6:41 p.m.

Respectfully submitted,

Cindy Sommer Community Development

Administrative Assistant

Christopher Sullivan-Robinson Planner/Zoning Administrator 421 Michigan Street Sturgeon Bay, WI 54235



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MEMO

To: Aesthetic Design and Site Plan Review Board

From: Christopher Sullivan-Robinson

Date: October 2, 2022

Subject: 65' x 300' Building for Bay Shipbuilding located at 605 N 3rd Ave

Fincantieri Bay Shipbuilding is requesting approval of a certificate of appropriateness for the construction of a new 19660ft² building (Building 110) located off the southwest corner of 3rd Ave and Florida St. The building dimension is 65 ft x 302.5 ft. The overall height to lowest grade is 34 feet. Lighting, and landscaping have not been provided for review. Signage is shown on the east building elevation; however, no specific details have been provided.

ZBA Approval: On March 22, 2022 the Zoning Board of Appeals (ZBA) approved two variances for this project allowing the proposed building to be placed 2 feet from the west and north property lines with the condition that the 3rd Avenue Beautification Plan be extended from Iowa St to Florida St. The building plans provided have been modified compared to the plan approved by ZBA. The changes include a shorter building by approximately 45 feet and excluded the guard shack. In addition, the façade excludes decorative windows on the south, east, and north elevation.

Below are relevant guidelines and criteria should consider:

(1) Site Layout:

- a. The site shall be designed to accomplish a desirable transition from the public streetscape, and between commercial, industrial, and residential land use areas.
- b. Stormwater drainage shall be designed so as not to alter the natural drainage systems or cause flooding or erosion on neighboring properties.

(2) Building Design:

- a. Buildings should be sited and designed to be aesthetically pleasing as viewed from adjoining public streets. Excessively long, unbroken building facades shall be avoided. Building materials and design features shall be consistent with the general design theme and/or proposed use of the development.
- b. Buildings on in-fill sites shall be compatible with surrounding buildings in terms of scale, massing, height, entrances, and windows.
- c. Blank walls viewable from the street are undesirable.

(3) Landscaping:

- a. To reduce erosion and surface runoff, trees and other vegetative land cover shall be removed only where necessary for the construction of structures or paved areas.
- b. Vegetative landscaping shall be used to soften the appearance of blank walls.

c. Fences and retaining walls shall be surfaced, painted, landscaped or otherwise treated to blend with their surroundings.

Recommendation: City staff recommend approval of the submitted plans subject to the conditions of the Zoning Board of Appeals and including decorative windows on all sides visible from the right-of-way to be approved by the chairperson.

CITY OF STURGEON BAY

AESTHETIC DESIGN & SITE PLAN REVIEW BOARD APPLICATION FOR CERTIFICATE OF APPROPRIATENESS

Name:_Fincanti	Name:_Fincantieri Bay Shipbuilding						
Owner of Premises:_Fincantieri Bay Shipbuilding							
Address or Legal Description of Premises: 605 N. Third Avenue							
Fincantieri Bay S Site plan approva Building 110, alo recently awarded contract and ther and capacity at the make the new Bu entire yard's made	ecific Item Requested for Approval:						
7/27/2022 Date	_Aaron Bley Applicant						
	Date Received: 8/1/22 Staff Signature: CHAIS S. Date Approved/Denied:						

Zoning Board of Appeals Tuesday, March 22, 2022

A meeting of the City of Sturgeon Bay Zoning Board of Appeals was called to order at 12:00 p.m. by Chairperson William Murrock in Council Chambers, City Hall, 421 Michigan Street.

Roll call [#1]: Members William Murrock, Dave Augustson, Nancy Schopf and Morgan Rusnak and alternate member Michael Marit were present. Members Bill Chaudoir was excused. Also present were Community Development Director Marty Olejniczak, Planner/Zoning Administrator Chris Sullivan-Robinson and Administrative Assistant Suzanne Miller.

Adoption of Agenda [#2]: Moved by Marit, seconded by Augustson to adopt the following agenda:

- 1. Roll call.
- 2. Adoption of agenda.
- 3. Approval of minutes from December 14, 2021.
- 4. Public Hearing: Petition for variance from Section 20.27(2) of the City of Sturgeon Bay Zoning Code for Fincantieri Bay Shipbuilding located at 605 N 3rd Ave; parcel #281-62-01000704C.
- 5. Consideration of: Petition for variance from Section 20.27(2) of the City of Sturgeon Bay Zoning Code for Fincantieri Bay Shipbuilding located at 605 N 3rd Ave; parcel #281-62-01000704C.
- 6. Adjourn.

All ayes. Motion carried.

Approval of Minutes from December 14, 2021 [#3]: Moved by Schopf, seconded by Rusnak to approve the minutes from December 14, 2021. All ayes. Motion carried.

Public hearing [#4]: Petition for variance from Section 20.27(2) of the City of Sturgeon Bay Zoning Code for Fincantieri Bay Shipbuilding (FBS) located at 605 N 3rd Ave; parcel #281-62-01000704C. Chairperson Murrock opened the public hearing at 12:04 p.m.

Zoning Variance request read aloud by Miller.

Introduction given by Sullivan-Robinson described Fincantieri Bay Shipbuilding's (FBS) petition for two variances to accommodate construction of a 65' x 350' x 32' high machine shop along 3rd Avenue near the northeast corner of their property (350' along 3rd Ave. [east] & 65' along Florida St. [north]). Proposals show the building 2' off the north property line and 2' off the east property line. Property is zoned Heavy Industrial (I-2), which requires the building to have a 50' setback along 3rd Ave. and a 20' setback along Florida St. FBS is proposing a land swap along the north lot line with the City to allow the northward positioning needed to keep the building outside of the FEMA floodplain. Sullivan-Robinson instructed the Authority that to be granted the variance, FBS must: 1. Prove an unnecessary hardship 2. Identify physical property limitations that require the variance 3. Prove the variance would not negatively impact the public interest.

Sullivan-Robinson reported positives include elimination of areas of outside storage that encroach into City right-of-way, improved curb appeal, some additional green space, and a better-designed/looking building than some of FBS's existing structures. Negatives include the

undesirable 2-foot separation between the property line and an industrial building and the effects that pushing an industrial building close to the street may have on the aesthetics of 3rd Ave.

Also of concern is how much variance is needed from 3rd Ave based on the space FBS requires to reasonably access the graving dock/gantry crane area. He informed the Authority that approval of the variance can be subject to added conditions to address the aesthetics of the structure such as building materials, beautifying the frontage along 3rd Ave. and/or site clean-up items.

Jan Allman, Sr. V.P. for Public Affairs and Community Relations and Aaron Bley, Facilities Manager, both representing FBS and Stuart Johnson of A.C.E. Building Services were present.

Allman explained: 1.) The age and poor condition of the existing building, that does not meet code (no sprinkler system), they plan to replace. 2.) The importance of keeping the new building out of the flood plain 3.) The necessity of placing the building as proposed to allow continued efficient production and safe operation of the shipyard without limiting production. She reported they would not be able to operate due to limited space between the new building and the gantry crane if prohibited from moving the new building northward. She stated FBS will look at requests from the Authority regarding aesthetics. She described the land swap as a long sliver along the northside of the property of ~3,000sq.ft., presented a printed layout, and stated FBS already has equipment/materials and fencing in that area and has a high-level agreement with the City to make the swap. She stated there will be no additional fencing installed as the building will become the fence. Indoor production allowed via the new building will reduce noise, dust, and debris in the area. Allman reported the original beautification project (south of lowa St.) will be installed in second quarter 2022.

Bley reported the new building will replace the old machine shop. Location of the building in relation to the graving dock/gantry crane is critical to move parts and materials, build ships and launch ships. He reported they have no second option and without the variance to relocate the building, the effect on production will be drastic. He reported boring results were very positive and bedrock was reached at 12 feet. The south end of the building will include the guard shack resulting in a facelift for the north entrance to FBS. Utility services are already inside the shipyard and conveniently located.

Johnson described the proposed pre-engineered metal building that will match the other new buildings in appearance.

Noralea Lautenbach of 632 No. 3rd Ave. spoke in favor of the variance as an improvement in appearance over the present "mess" and raised several concerns: 1.) The lack of parking on 3rd Ave. She and her immediate neighbors do not have parking on the street (east side) in front of their homes and the FBS workers are "nasty" when neighbors park on the west side of the street. 2.) There are no trees along the west side of 3rd Ave. in this area. 3.) Snow removal is problematic as plow deposits a great deal of snow on their side of the street and the sidewalk.

Chris Kellems of 120 Alabama St. spoke in favor of the proposal, especially improved dust control. She spoke of a missed opportunity for solar panels on the roof of new buildings and raised concern regarding seagull nesting on the roof.

No one spoke in opposition of the variance request and there were no letters of correspondence in favor of or against the variance request.

Allman responded FBS would look at snow removal issues, is willing to plant trees, is planning to

dispose of some of the items stored outside and will be using more inside storage. FBS has a sustainability program and are evaluating the use of solar. Brey reported the roofs are designed to support the weight of future solar panels and FBS participates in a seagull mitigation program with the DNR in the summer. The building must be 65 feet to accommodate the length of shafts and other components.

The public hearing was declared closed at 12:21 p.m.

Consideration of petition for variance from Section 20.27(2) of the City of Sturgeon Bay Zoning Code for Fincantieri Bay Shipbuilding located at 605 N 3rd Ave; parcel #281-62-01000704C. [5]:

Discussion: Authority members voiced support for the proposal as the area will be cleaned up and sound will be mitigated through indoor production. Augustson stated he would like to see more green space and maintain views of the yard. Augustson also stated: 1.) The building allows completion of Navy contracts, 2.) The flood plain and space limitations of the property leave no other options for placement, and 3.) The City and Utilities property to the north of the lot line provide adequate green space. Schopf stated support due to improved aesthetics in the area and the project supporting the economy of the City.

Motion #1: Augustson made a motion to approve the petition for variance from Section 20.27(2) of the City of Sturgeon Bay Zoning Code for Fincantieri Bay Shipbuilding located at 605 N 3rd Ave; parcel #281-62-01000704C, allowing FBS to construct a building encroaching the setback from the north lot line by 18 feet and allowing the structure's corner to be sited within two feet of the lot line. Second by Shopf. All ayes by roll call vote. Motion carried.

Discussion: Authority members discussed the size of the building and amount of area along 3rd Ave. available for green space.

Motion #2: Murrock made a motion to approve the petition for variance from Section 20.27(2) of the City of Sturgeon Bay Zoning Code for Fincantieri Bay Shipbuilding located at 605 N 3rd Ave; parcel #281-62-01000704C, allowing FBS to construct a building encroaching the setback from 3rd Avenue by 48 feet with the condition that FBS extend the current 3rd Avenue Beautification Project from its current termination at lowa St. to the end of the FBS property at Florida St. Shopf seconded the motion. All ayes by roll call vote. Motion carried.

Adjourn [#6]: Motion to adjourn by Augustson, seconded by Shopf. All ayes. Motion carried. The meeting adjourned at 1:05 p.m.

Respectfully submitted,

Suzanne Miller


Administrative Assistant

Printed 03/17/2022 courtesy of Door County Land Information Office

... from the Web Map of ... (//www.co.door.wi.gov)

Door County, Wisconsin ... for all seasons!



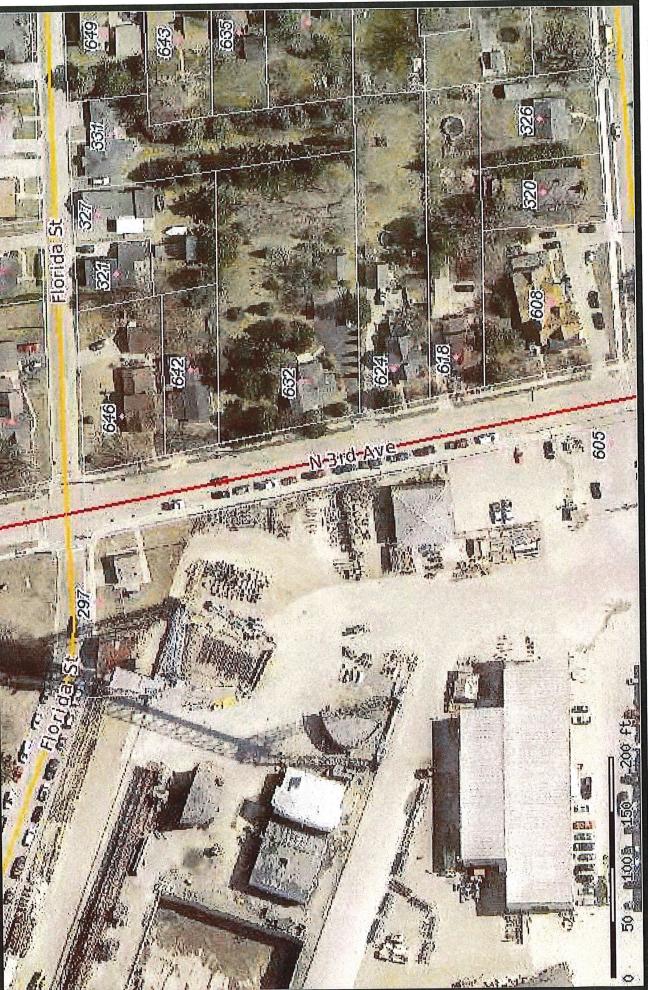



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632 N 3rd Ave - Google Maps 3/17/22, 12:49 PM

Google Maps 632 N 3rd Ave



Sturgeon Bay, Wisconsin

Google

Street View - Aug 2019

642 N 3rd Ave - Google Maps

Google Maps 642 N 3rd Ave





Sturgeon Bay, Wisconsin

Google

Street View - Aug 2019

608 N 3rd Ave - Google Maps

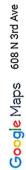

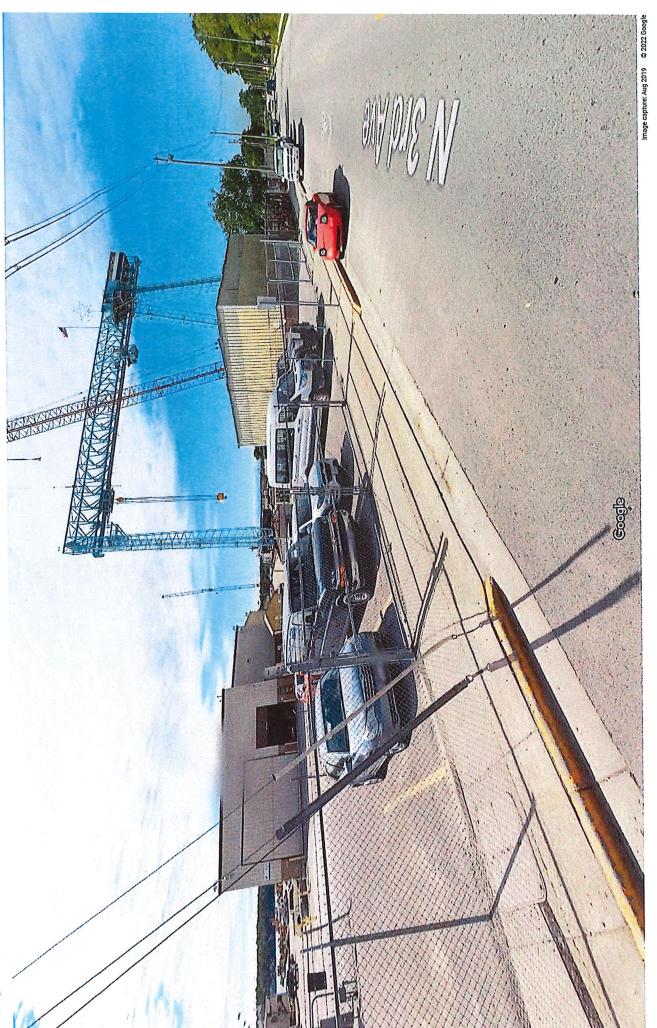


Sturgeon Bay, Wisconsin

Google

Street View - Aug 2019



The Metl-Span CF Light Mesa insulated metal panel is well suited for exterior and interior walls and ceiling applications. The shallower version of the Mesa profile creates symmetry on the outside of the building and room to room within. The minor rib provides a flattened appearance. Light Mesa panels are ideal for commercial, institutional and industrial applications.

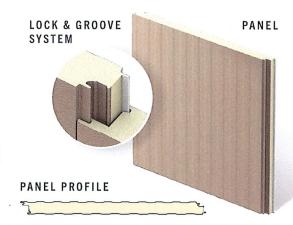

PRODUCT SPECIFICATIONS

WIDTH • 30", 36", 42"

THICKNESS • 2", 21/2", 3", 4", 5", 6", 8"

Note: 5", 6" & 8" available for Interior Panels Only

LENGTH

NON-DIRECTIONAL EMBOSSED

8'-0" to 32'-0" Horizontal 8'-0" to 52'-0" Vertical

UNEMBOSSED

8'-0" to 16'-0" Horizontal 8'-0" to 16'-0" Vertical

 $\textbf{EXTERIOR} \ \ \textbf{PROFILE} \ \ \textbf{Lightly profiled 1/16} \ \ \text{deep, longitudinal planks}$ spaced at nominal 4" on center, embossed

or unembossed

EXTERIOR FACE • G-90 galvanized or AZ-50 aluminum-zinc coated steel in 26, 24 and 22 Ga.

INTERIOR PROFILE. Light Mesa, nominal 1/16" deep, embossed or unembossed

INTERIOR FACE • G-90 galvanized or AZ-50 aluminum-zinc coated steel, 304 or 316 stainless steel in 26, 24, 22" Ga.

JOINT • Offset double tongue-and-groove with extended metal shelf for positive face fastening

U-FACTORS AND R-VALUES*

U-FACTOR (BTU/h-ft²-°F)

R-VALUE (h-ft2-°F/BTU)

PANEL	WIDTH: 42"		PANEL	WIDTH: 42"	
	35°	75°		35°	75°
2"	0.059	0.073	2"	17.5	13.9
2.5"	0.046	0.058	2.5"	21.9	17.4
3"	0.039	0.048	3"	26.2	20.9
4"	0.029	0.036	4"	35.0	27.8
5"	0.023	0.030	5"	43.7	34.8
6"	0.019	0.024	6"	52.5	41.8
8"	0.014	0.020	8"	70.0	55.7

^{**} Based on ASTM C518, ASTM C1363 and thermal modeling

This profile is not for use as an exterior wall of a low temp application

DESIGN FEATURES & BENEFITS

- Consistent high quality with foamed-in-place panel manufacturing
- · Flat surface, easily washable
- · Utilizes concealed clips and eliminates thermal short circuits
- · Easy and fast installation, with reduced construction labor costs
- Interior and exterior applications
- USDA Compliant stainless steel for use in aggressive or daily wash-down areas

^{~ 22} Ga not available for stainless steel

TESTING: CF LIGHT MESA INSULATED METAL WALL PANEL

TEST/ APPROVAL	TEST METHOD	TEST TITLE	RESULTS			
Fire US	ASTM E84	Surface Burning Characteristics of Building Materials	Flame spread <25, smoke developed <450			
	ASTM E119	Fire Tests of Building Construction Materials	One hour non-load bearing rating with two layers Type X Gypsum			
			Vertical or horizontal installation			
	FM 4880	Class 1 Fire Rating of Insulated Wall, Ceiling and Roof Panels	Product approved Exterior wall requires FM 4881 approval			
	NFPA 259	Test Method for Potential Heat of Building Materials	Potential heat of foam plastic insulation contained in the assembly tested in accordance with NFPA 285			
	NFPA 285-19	Evaluation of Fire Propagation Characteristics of Exterior Non-Load Bearing Wall Assemblies	Panel assembly met the requirements of the standard			
	NFPA 286	Fire Tests for Evaluating Contribution of Wall and Ceiling Finish to Roof Fire Growth	Test specimen met the criteria of the IBC Section 803.1.2.1			
Fire Canada	CAN/ULC S101	Fire Endurance Tests of Building Construction and Materials	One hour non-load bearing fire rating with two layers of Type X Gypsum			
	CAN/ULC S101	Fire Endurance Tests of Building Construction and Materials	Meets 15 minute stay-in-place requirements			
	CAN/ULC S102	Surface Burning Characteristics of Building Materials and Assemblies	Meets the National Building Code of Canada requirements			
	CAN/ULC S134	Fire Test of Exterior Wall Assemblies	Complies with the fire-spread and heat-flux limitations required by the National Building Code of Canada			
	CAN/ULC S138	Fire Growth of Insulated Building Panels in a Full-Scale Room Configuration	Met the criteria of the standard			
Structural	ASTM E72	Strength Tests of Panels for Building Construction	See Load Chart			
	ASTM E1592	Structural Performance of Metal Roof and Siding Systems by Uniform Static Air Pressure Differences	See Load Chart			
	FM 4881	Class 1 Exterior Wall Structural Performance	See FM Wall Load Chart			
Thermal Performance	ASTM C518	Steady-State Thermal Transmission Properties by Means of the Heat-Flow Meter Apparatus	K-Factor of 0.114 BTU.in/hr.ft².°F at 35° F mean core K-Factor of 0.144 BTU.in/hr.ft².°F at 75° F mean core			
	ASTM C1363	Thermal Performance of Building Materials and Envelope Assemblies	See Thermal Performance Guide			
Air Infiltration	ASTM E283	Rate of Air Leakage Through Curtain Walls Under Specified Pressure Differences	<0.01 cfm/ft² at 20 psf Vertical or horizontal installation			
Water Infiltration						
			Vertical or horizontal installation			
Special Approval	Miami-Dade NOA	Product Approval for City of Miami and Dade County	Product has City of Miami and Dade County Notice of Acceptance			
	State of Florida	Product Approval for the State of Florida	Product has State of Florida approval			

Note: Miami Dade and Florida testing is not available on 8" thickness.

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GENERAL	CIVIL	ARCHITECTURAL	STRUCTURAL	$\prod_{i=1}^{n}$
A.C.E. BUILDING SERVICES 3510 SOUTH 26TH STREET MANITOWOC, WISCONSIN 54220 P: 920-682-6105	BADHUIN SURVEYING & ENGINEERING 312 N. 5TH AVENUE STURGEON BAY, WISCONSIN 5435 P: 920-743-8211	A.C.E. BUILDING SERVICES 3510 SOUTH 26TH STREET MANITOWOC, WISCONSIN 54220 P: 920-682-6105	STRUKTURA, LLC 2147 BLUFF OAK DRIVE CARY, NORTH CAROLINA 27519 P: 919-257-9341	8. 9. 10
G 1.0 TITLE SHEET	C1.0 PLOTPLAN	A 1.0 WALL TYPES, ABBREVIATIONS, AND SYMBOLS A 3.1 FLOOR PLAN A 3.2 TOILET ROOM PLAN & TOILET ROOM ELEVATIONS A 4.1 SCHEDULES A 5.1 EXTERIOR ELEVATIONS A 6.1 BUILDING SECTIONS A 6.2 WALL SECTIONS A 6.3 WALL SECTIONS A 6.4 WALL SECTIONS A 6.5 STAIR SECTIONS	\$ 1.0 GENERAL NOTES \$ 1.1 GENERAL NOTES \$ 1.1 GENERAL NOTES \$ 2.0 OVERALLE FOUNDATION PLAN \$ 2.0A PARTIAL FOUNDATION PLAN \$ 2.0B PARTIAL FOUNDATION PLAN \$ 2.1A MEZZANINE FRAMING PLAN (SOUTH) \$ 2.1B WALL REINFORCING PLAN (NORTH) \$ 3.0 ANCHOR BOLT SETTING DETAILS \$ 4.0 FRAMING ELEVATIONS \$ 4.1 FRAMING ELEVATIONS \$ 4.2 FRAMING ELEVATIONS \$ 5.5 FOUNDATION DETAILS \$ 5.5.1 FOUNDATION DETAILS \$ 5.5.2 FOUNDATION DETAILS \$ 5.5.3 MASONRY DETAILS \$ 5.5.4 PRECAST & STEEL DETAILS	

PROJECT INFORMATION

- ALL WORK SHALL COMPLY WITH ALL STATE AND LOCAL CODES.
 PROPOSED BUILDING YOUME = 655.826 CU.F.
 A. CLASS OF COMSINICION 1796 S. 826 CU.F.
 CLASS OF COMSINICION 1796 S. 8275 R. 8275

- AL DIT DOORS TO BE COUPED WITH:

 A. DIT LIGHTS:

 DIT SIGHTS SHALL NOT EXCEED 5 WATTS PER SIDE INSTALLED WATTAGE.

 MEANS OF EGRESS ILLUMINATION LEVEL SHALL NOT BELESS THAN I FOOT CANDER AT WATERS OWNERS.

 EMBERGY FOWER FOR WALAS OF EGRESS SHALL PROVIDE POWER FOR FOO MINDIES AND CONSIST OF STORAGE BATTLESS. JOHN EDITED HIS CONSIST OF STORAGE BATTLESS.

 B. PROPER BATTLESS HAND DO NOT EXCURE TWISTING OF THE WASHEST HAND DO NOT EXCURE THE STORAGE.

 C. HRESHOLDS THAT DO NOT EXCEED 1/27.

 REFERENCIALISMS FOR SEPROYED IF REQUIRED BY CODE.

- FIRE EXTINGUISHERS TO BE PROVIDED IF REQUIRED BY CODE.
 SMCKE DETECTORS TO BE PROVIDED IF REQUIRED BY CODE.
 OCCUPANT LOAD PER TABLE 1004.1.2
 - HIST FLOOR:

 FACTORY (50%) STORAGE (50%) AVERAGE 300 SQ.FT. PER PERSON
 = 66 OCCUPANTS

MEZIANNE

OFFICES = 5 OCCUPANTS

LUNCHROOM = 31 OCCUPANTS

TOTAL MEZIANNE OCCUPANTS = 36 OCCUPANTS

TOTAL BUILDING OCCUPANT LOAD = 102 PERSONS 11. EGRESS WIDTH REQUIRED PER 1005.3.2

102 OCCUPANTS x 0.2" PER OCCUPANT = 20" INCHES REQUIRED.
 4 DOORS x 32" EACH = 128" PROVIDED [O.K.]

12. MAX. TRAVEL EXIT DISTANCE PER 1017.2 = 300, C.P.O.T. = 100' (MAX.) PER

12 MAC INVECTOR DISTANCE FR. 1017-2-30. C.F.0.1-1-10 [may-11].

13. PLUMBING HAURES [FACTORY AND STORAGE] OCCUPANTIS.

URINAL AND LAV = 1 PER 100 OCCUPANTS, LAV CONTROLE SACH SEX-2

IN MBTS = 200+1 INFEMALE =100 FOR A TOTAL OF 300 OCCUPANTS.

PROJECT NOTES

EXTENT OF WORK

THE INTENT OF THE CONTRACT DOCUMENTS IS TO INCLUDE ALL ITEMS INCESSARY FOR THE PROPER EXECUTION AND COMPLETION OF THE WORK. BY THE CONTRACTOR SHANDANCE SYTHE CONTRACTOR SHALL BE REQUIRED TO THE DATED CONSISTENT WITH THE CONTRACT DOCUMENTS AND REASONABLY INFERSIBLE FROM THEM AS BEING INCESSARY TO PRODUCE THE INTENDED RESULTS.

SITE VISIT

THE CONTRACTOR SHALL VISIT THE SITE. BECOME FAMILIAR WITH LOCAL CONDITIONS UNDER WHICH THE WORK IS TO BE PERFORMED AND CORRELLAR PERSONAL OASERVAITIONS WITH REQUIREMENTS OF THE CONTRACT DOCUMENTS.

NOTICE TO BIDDERS

NIDDERS SHALL REVIEW ALL DRAWINGS AND ALL SPECIFICATION SECTIONS TO DETERMINE THE IMPACT OF OTHER SECTIONS OF WORK ON THEIR OWN WORK.

C.E. BUILDING SERVICE Structural CIVIL &

> 0 BUILDING

NEW MACHINE SHOP B FINCANTERI - BAY SHIP BUILDING 605 NORTH 3RD AVENUE STURGEON BAY, WISCONSIN 54235

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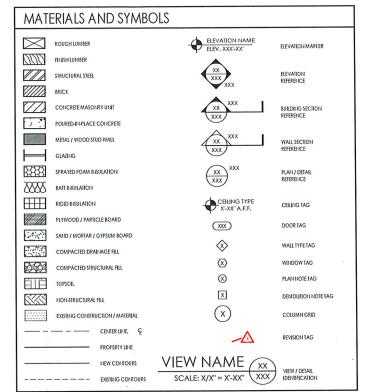
SHEET INFORMATION A.C.E. JOB NO. 141/22

DATE: APRIL 18, 2022 DRAWN BY: GAD SCALE: 12" = 1'-0"

TITLE SHEET

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ABBR	EVIATIONS										
A.B.	ANCHOR BOLT	CORR	CORRIDOR.	FAB	FABRICATED	LL	LIVE LOAD	R.C.	ROOF CONDUCTOR	THK	THICK
A.D.A.	AMERICAN WITH		CORRUGATED	FDN	FOUNDATION	LAM	LAMINATE(D)	R.D.	ROOF DRAIN	101	TOTAL
10000	DISABILITIES ACT	CPT	CARPET	FIN	HN8H	LAV	LAVATORY	R.H.	RIGHT HAND	TV	TELEVISION
A.F.F.	ABOVE FINISHED	D	DEPTH	FL.	FLOOR	LB	POUND	R.O.	ROUGH OPENING	TYP	TYPICAL
	FLOOR	D.F.	DRINKING FOUNTAIN	FT	FOOT, FEET	LOUV	LOUVER	REF	REFERENCE	UNFIN	UNFINISHED
A/C	AIR CONDITIONING	D.L.	DEAD LOAD	FIG	FOOTING	M.B.	MARKER BOARD	REG	REGISTER	UTIL	UTILITIES
ACOUS	ACOUSTIC(AL)	DBL	DOUBLE	FURN	FURNACE, FURNITURE	MO.	MASONRY OPENING	REINF	REINFORC (ING, MENT)	V	AIMAT
ADD	ADDITION	DEG	DEGREE	FURR	FURRING	MACH	MACHINE	REQID	REQUIRED	V.B.	VIPILY BASE
ADJ	ADJUSTABLE	DEPT	DEPARTMENT	G	GAS	BRIAM	MAINTENANCE	RESIL	RESILIENT	V.C.T.	VINYL COMPOSITION
ALT	ALTERNATE	DET	DETAIL	G.B.	GRAB BAR	MATL	MATERIAL	REV	REVISION		TILE
ALUM	ALUMINUM	DIA	DIAMETER	G.C.	GENERAL	MAX	MUMIXAM	RM	ROOM	VENT	VENTILATION
APPROX	APPROXIMATE	DIAG	DIAGONAL		CONTRACTOR	MECH	MECHANICAL	\$.C.	SOLID CORE	VERT	VERTICAL
ARCH	ARCHITECT(URAL)	DIM	DIMENSION	G.M.	GAS METER	MEMB	MEMBRANE	\$.\$.	STAINLESS STEEL	VEST	VESTIBULE
ATTEN	ATTENUATION	DISP	DISPENSER	GA	GAUGE	MEZZ	MEZZANINE	SAN	SANITARY SEWER	VOL	VOLUME
AUTO	AUTOMATED	DIV	DIVIDION	GALV	GALVANZED	MFR	MANUFACTURER	SECT	SECTION	W	WIDTH, WATER
B.L.	BORROWED LITE	DN	DOWN	GYP. BD.	GYPSUM BOARD	MH	MANHOLE	SECUR	SECURITY	W.C.	WATER CLOSET, WATER
B.M.	BENCH MARK	DR	DOOR	H, HGT	HEIGHT	MIN	MINIMUM	SERV	SERVICE		COOLER
B.O.	BOTTOM OF	DS	DOWNSPOUT	H.B.	HOSE BIBB	MISC	MISCELLANEOUS	SHT	SHEET	W.C.O.	WALL CLEAN OUT
B.T.U.	BRITISH THERMAL UNIT	DW	DRYWALL	H.M.	HOLLOW METAL	MIL	METAL	SIM	SIMILAR	W.H.	WATER HEATER
BD	BOARD	E.LF.S.	EXTERIOR INSLUATION	H.V.A.C.	HEATING, VENTILATION	MULL	MULLION	SPEC(S)	SPECIFICATION(S)	W/	WITH
BLDG	BUILDING		HINISH SYSTEM		AND AIR CONDITIONING	N	HTROM	SPKLR	SPRINKLER	W/O	WITH OUT
BLK(G)	BLOCK[ING)	E.J.	EXPANSION JOINT		HOT WATER	NLC.	NOT IN CONTRACT	\$Q	SQUARE	WD	WOOD WEIGHT
BOT	BOTTOM	E.W.	EACH WAY	H.W.		N.T.S.	NOTTO SCALE	ST, STORE	STORAGE	WT	
BRG	BEARING	E.W.C.	ELECTRIC WATER COOLER	HC	HANDICAPPED HEAD	NO	NUMBER	STD	STANDARD	MWM	WELDED WIRE MESH YARD
C.B.	CATCH BASIN, CHALK			HD		NOM	NOMINAL	STL	STEEL	YD	TAKU
	BOARD	EA	EACH	HDR HDWR	HEADER HARDWARE	O.C., O/C	ONCENTER	STRM	STORM SEWER		
C.F.	CUBIC FEET	EL. ELEV ELEC	ELEVATION, ELEVATOR ELECTRIC	HORIZ	HORIZONTAL	O.D.	OUTSIDE DIAMETER	STRUCT	STRUCTURAL-		
C.G.	CORNER GUARD		EMERGENCY	HR	HOREONIAL	OH	OVERHEAD	SUSP	SUSPENDED		
C.J.	CONTROL JOINT	EMER			HEATER	P.LAM.	PLASTIC LAMINATE	ī	TREAD		
C.L.	CENTER LINE	ENCL	ENCLOSED	HTR LD.	INSIDE DIAMETER	PL	PLATE	T&B	TOP AND BOTTOM		
C.M.P.	CORRUGATED METAL PIPE	ENG	ENGINEER(D)			PLAS	PLASTIC	T&G	TOUNGE AND GROOVE		
C.O.	CLEAN OUT	EQ	EQUAL	INSUL	INSULATION INTERIOR	PLBG	PLUMBING	T.B.	TACK BOARD		
C.W.	COLD WATER	EQUIP EXCAV	EQUIPMENT EXCAVATE	174 V34	INVERT	PLYWD	PLYWOOD	T.O.	TOP OF		
CAB	CABINET		EXCAVATE	J.B.	JOST BEARING	PR	PAIR	T.O.B.	TOP OF BEAM		
CLG	CEILING	EXIST, (EX) EXP		JAN	JANTOR	PREFAB	PREFABRICATED	1.O.F.	TOP OF FOOTING		
CLG	CLEAR	EXT	EXPOSED EXTERIOR	JAN	JOIST	PSF	POUNDS PER SQUARE	J.O.J.	TOP OF MASONRY		
CMU	CONCRETE MASONRY	F.A.C.E.		л	JOIST		FOOT	I.O.P.	TOP OF PIER		
Citio	UNIT	r.A.C.E.	FAMILY AND CONSUMER	K.O.	KNOCK OUT	PSI	POUNDS PER SQUARE	1.0.5.	TOP OF STEEL		
COL	COLUMN		EDUCATION	KO.	ONE THOUSAND		INCH	T.S.	TUBE STEEL		
COMP	COMPOSITION	F.C.O.	FLOOR CLEAN OUT	MF	POUNDS	PT, P.T.	POINT, PORCELAIN TILE, PAINT, PRESSURE	I.W.	TACK WALL		
	COMPACT	F.D.	FLOOR DRAIN	KJT	KITCHEN		TREATED	TEL	TELEPHONE		
CONC	CONCRETE	F.E.	FIRE EXTINGUISHER	1	LENGTH	Q.T.	QUARRY TILE	TEMP	TEMPERED		
CONT	CONTINUOUS	F.F.	FINISHED FLOOR	LH.	LEFT HAND	R	RADIUS, RISER	TERR	TERRAZZO		
				Lit	COLINIA	•					







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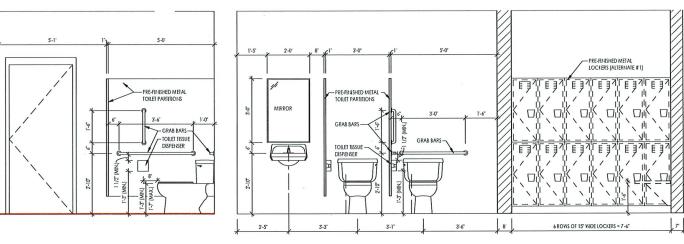
I - BA 3RD BAY, NEW M FINCANTERI -605 NORTH 3 STURGEON B

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SHEET INFORMATION A.C.E. JOB NO. 141/22


DATE: APRIL 18, 2022 DRAWN BY: GAD

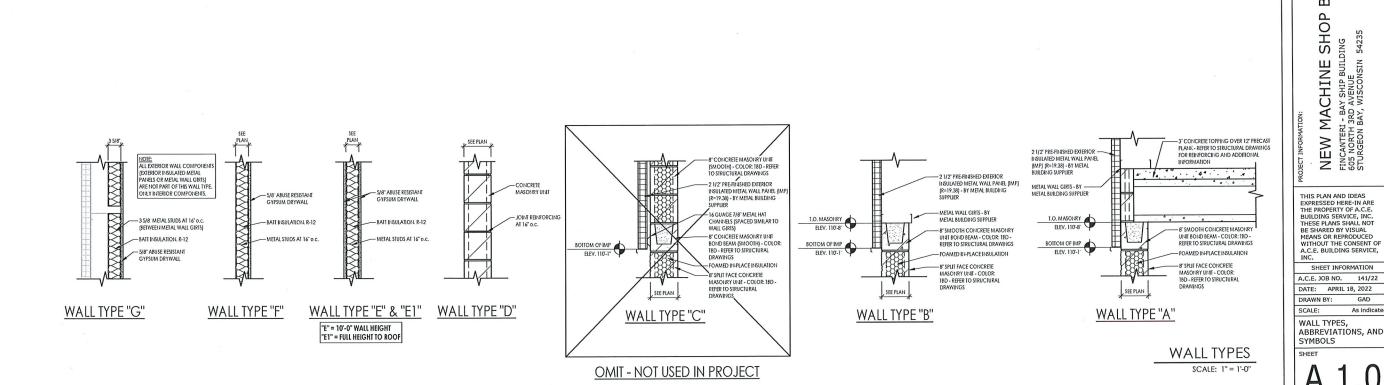
SCALE: As indicated FLOOR PLAN

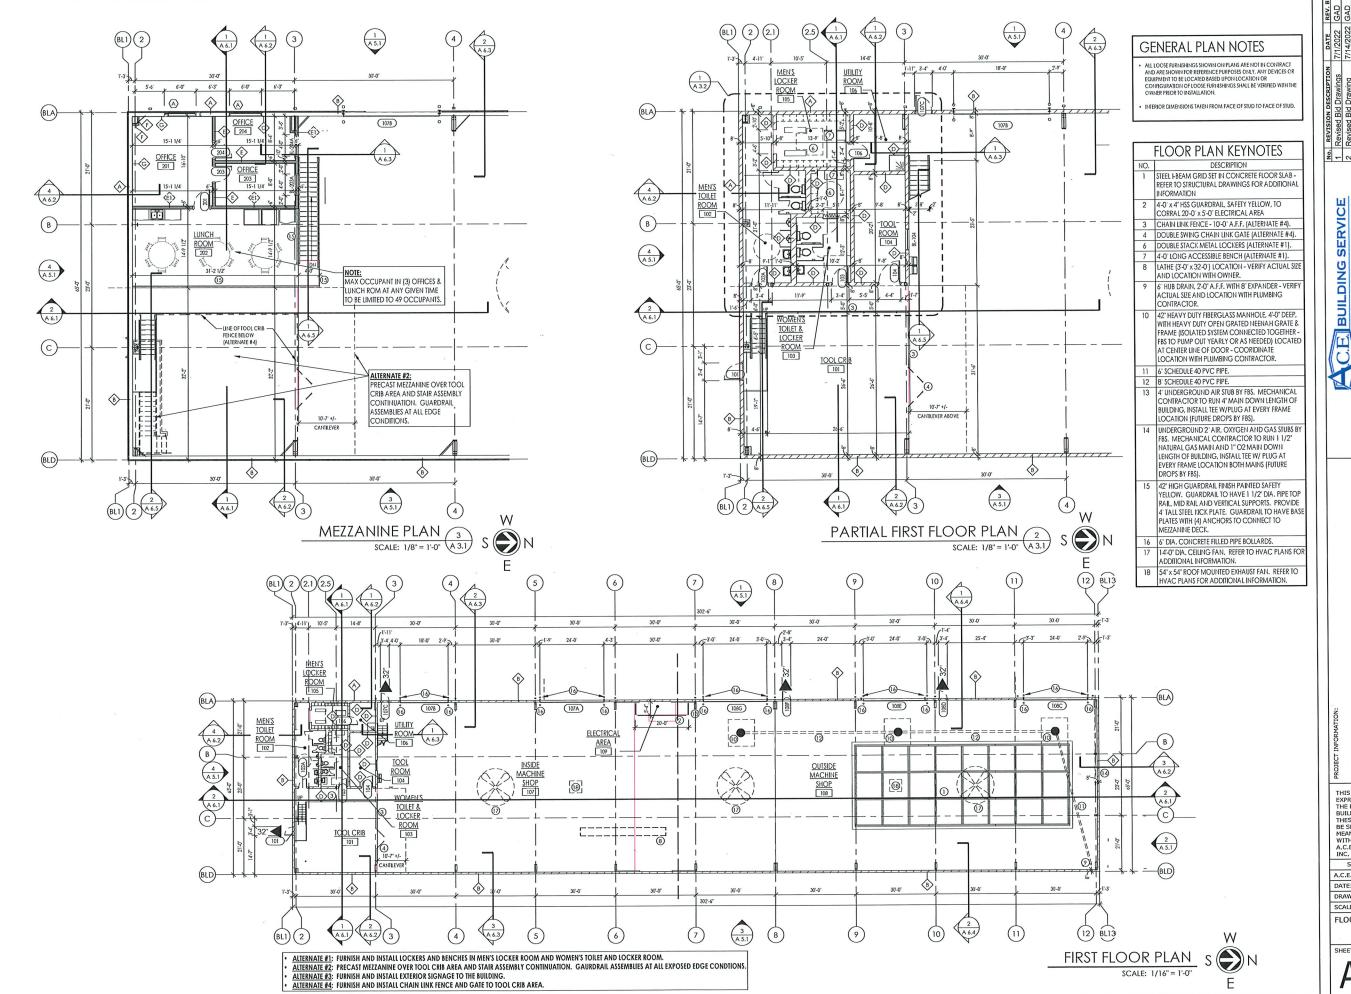

WOMEN'S TOILET ROOM #103 EAST WALL 5
SCALE: 1/2" = 1'-0" A 3.2

WOMEN'S TOILET & LOCKER ROOM #103 - SOUTH WALL SCALE: 1/2" = 1'-0" (A 3.2)

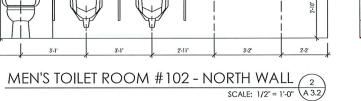

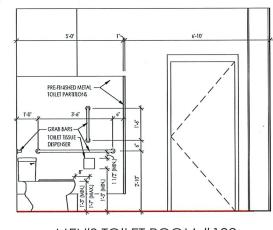

MEN'S TOILET ROOM #102 - EAST WALL SCALE: 1/2" = 1'-0" A 3.2

ALTERNATE #1: FURNISH AND INSTALL LOCKERS AND BENCHES IN MEN'S LOCKER ROOM AND WOMEN'S TOILET AND LOCKER ROOM.


ALTERNATE #2: PRECAST MEZZANINE OVER TOOL CRIB AREA AND STAIR ASSEMBLY CONTINUATION. GAURDRAIL ASSEMBLIES AT ALL EXPOSED EDGE CONDITIONS.

ALTERNATE #4: FURNISH AND INSTALL CHAIN LINK FENCE AND GATE TO TOOL CRIB AREA.

1	FOILET ROOM KEYNOTES
NO.	DESCRIPTION
1	42' GRAB BAR
2	36" GRAB BAR
3	18" GRAB BAR
4	TOILET TISSUE DISPENSER (SEE NOTE 1)
5	24' x 36" WALL MOUNTED MIRROR WITH STAINLESS STEEL CHANNEL TRIM
6	SOAP DISPENSER (SEE NOTE 1)
7	PAPER TOWEL DISPENSER (SEE NOTE 1)
8	PRE-FINISHED METAL TOILET PARTITIONS
9	20' x 42' ACCESSIBLE BENCH - WALL MOUNTED (ALTERNATE #1)
10	20' x 48' ACCESSIBLE BENCH W/ BACK REST-FLOOR MOUNTED (ALTERNATE #1)
11	12' x 48' BENCH - FLOOR MOUNTED (ALTERNATE #1)
12	15" WIDE x 15" DEEP DOUBLE STACK LOCKER (ALTERNATE #1)

TOILET ROOM NOTE:

1. OWNER AND CONTRACTOR TO DETERMINE STYLE, FINISH AND LOCATION OF ITEMS.

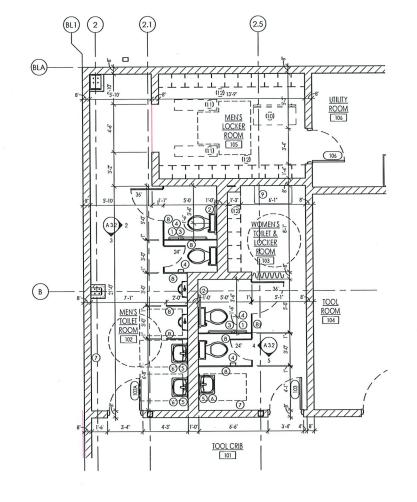

MENS' TOILET ROOM #102, WOMEN'S TOILET & LOCKER ROOM #103 AND MEN'S LOCKER ROOM #105 1 SCALE: 1/4" = 1'-0" (A 3.2)



C.E. BUILDING SERVICE Civil & Structural

No. REVI

BUILDING NEW MACHINE SHOP B FINCANTERI - BAY SHIP BUILDING 605 NORTH 3RD AVENUE STURGEON BAY, WISCONSIN 54235

110

TOILET ROOM PLAN & TOILET ROOM ELEVATIONS

					DOOR	SCH	EDUL	.E				
								FR	AME			
DOOR NO.	DOOR SIZE	ELEV.	MAT'L	GLASS TYPE	HARDWARE SET NO.	ELEV.	MATL	FRAME DEPTH	HEAD	JAMB	FIRE RATING	REMARKS
101	3'-0" x 7'-0"	D-2	HM	1	SEE NOTE	F-1	HM	53/4			-	
102A	3'-0" x 7'-0"	D-1	HM	-	SEE NOTE	F-2	HM	5 3/4"			-	
103	3'-0" x 7'-0"	D-1	HM	-	SEE NOTE	F-2	HM	5 3/4"			-	-
104	4'-0" x 7'-0"	D-2	HM	3	SEE NOTE	F-2	HM	53/4			-	-
106	3'-0" x 7'-0"	D-1	HM	-	SEE NOTE	F-2	HM	5 3/4'			-	-
107A	24'-0" x 18'-0"	D-3	STL	-	SEE NOTE	-	STL				-	•
107B	18'-0" x 18'-0"	D-3	STL	-	SEE NOTE	-	STL				-	-
107C	3'-0" x 7'-0"	D-2	HM	1	SEE NOTE	F-2	HM	53/4			-	-
108C	24'-0" x 18'-0"	D-3	STL	-	SEE NOTE	-	STL					-
108D	3'-0" x 7'-0"	D-2	HM	1	SEE NOTE	F-2	HM	5 3/4"			-	
108E	24'-0" x 18'-0"	D-3	STL	-	SEE NOTE	-	STL					-
108F	3'-0" x 7'-0"	D-2	HM	1	SEE NOTE	F-2	HM	5 3/4"			-	-
108G	24'-0" x 18'-0"	D-3	STL	-	SEE NOTE	-	STL				-	•
201	3'-0" x 7'-0"	D-2	WD	3	SEE NOTE	F-1	HM	8 1/4"				
203	3'-0" x 7'-0"	D-4	WD	3	SEE NOTE	F-1	HM	8 1/4"			-	-
204	3'-0" x 7'-0"	D-4	WD	3	SEE NOTE	F-1	HM	8 1/4"			-	-

BORROWED LITE NO. BL-104 BL-203A

KEY	DESCRIPTION
ACT-1	"ARMSTRONG" 2x2 VINYL COATED ACOUSTIC CEILING TILE ON STAND 15/16" GRID.
ACT-2	"ARMSTRONG" 2x2 CIRRUS TEGULAR REVEAL EDGE WITH STANDARD GRID, 3" BATT INSULATION
CMU	CONCRETE MASONRY UNIT
CONC.	CONCRETE
CPT	2x2 COMMERICAL GRADE CARPET TILES
EP	1/16" SINGLE FULL BROADCAST SOLID EPOXY FLOOR WITH URETHANE COAT. INCLUDE SEPARATE EXPOXY PRIMER FOR A TOTAL OF (4) STEPS.
ES	EXPOSED STRUCTURE
EX	EXISTING FINISH
GYP	ABUSE RESISTANT GYPSUM BOARD
HM	HOLLOW METAL- FINISH PAINTED
P-1	BLOCK FILLED, PRIMED AND FINISH PAINTED
P-2	PRIMED AND FINISH PAINTED
PC	PRECAST PLANK - FINISH PAINTED
SC	SEALED CONCRETE
VB	VINYL BASE

ROOM FINISH LEGEND

HM	HOLLOW METAL- FINISH PAINTED								
P-1	BLOCK FILLED, PRIMED AND FINISH PAINTED								
P-2	PRIMED AND FINISH PAINTED								
PC	PRECAST PLANK - FINISH PAINTED								
SC	SEALED CONCRETE								
VB	VINYL BASE								
	ROOM FINISH REMARKS								
NO.	DESCRIPTION								
1	INYL BASE ON INSIDE AND OUTSIDE OF OFFICES								

			ВС	RRC	WED	LITE SC	HEDULE				
)	8			GLASS	FRAME	2	DETAILS		SILL	FIRE	
	BORROWED LITE SIZE	ELEV.	MATL	TYPE	DEPTH	HEAD	JAMB	SILL	HEIGHT	RATING	REMARK\$
	4'-0" x 4'-0"	BL-1	HM	4	53/4				3-4"	-	-
	4'-0" x 4'-0"	BL-1	HM	2	8 1/4'				3'-6"	-	-
	4'-0" x 4'-0"	BL-1	HM	2	8 1/4'				3'-6"	-	-


	GLASS TYPES
1	1" TEMPERED INSULATED LOW-E GLASS
2	1" INSULATED LOW-E GLASS
3	1/4" TEMPERED GLASS
4	1/4' FLOAT GLASS


DOOR HARDWARE NOTE:

DOOR HARDWARE TO BE "SCHLAGE" GRADE 1 LEVER HANDLED KEYED ENTRIES ALL DOORS, LCN CLOSER ALL DOORS, 1 1/2 STAINLESS B.B. BUTTS ALL DOOR, THRESHOLDS ALL EXTERIOR AND RATED DOORS, SWEEPS ALL EXTERIOR DOORS, WEATHER STRIP ALL EXTERIOR DOORS, WEATHER STRIP ALL EXTERIOR DOORS, ALL DOORS TO HAVE A PAIR OF STEEL KICK PLATES 8" x 24" HIGH AND LATCHGUARD. FINISH ALL HARDWARE AS SATIN CHROME.

FINISHED FLOOR

TYPE "A"

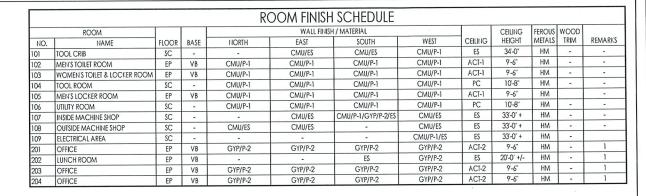

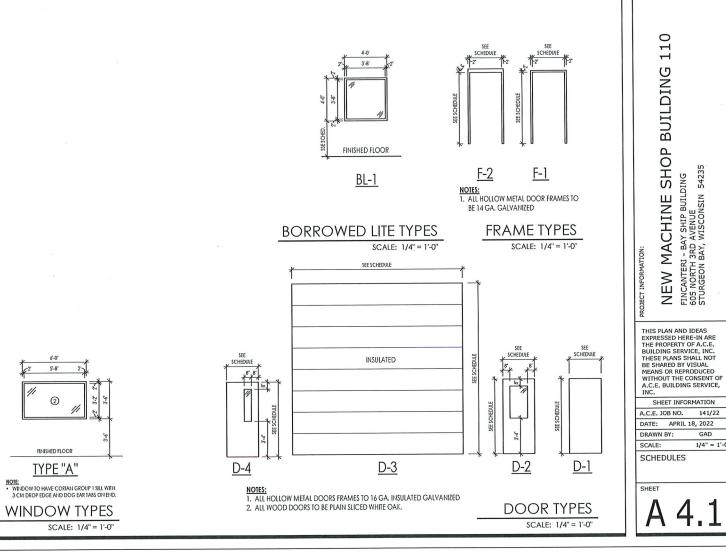

C.E. BUILDING SERVICE

110

BUILDING


NEW MACHINE SHOP B FINCANTERI - BAY SHIP BUILDING 605 NORTH 3RD AVENUE STURGEON BAY, WISCONSIN 54235

1/4" = 1'-0'

Structural

3

CIVII

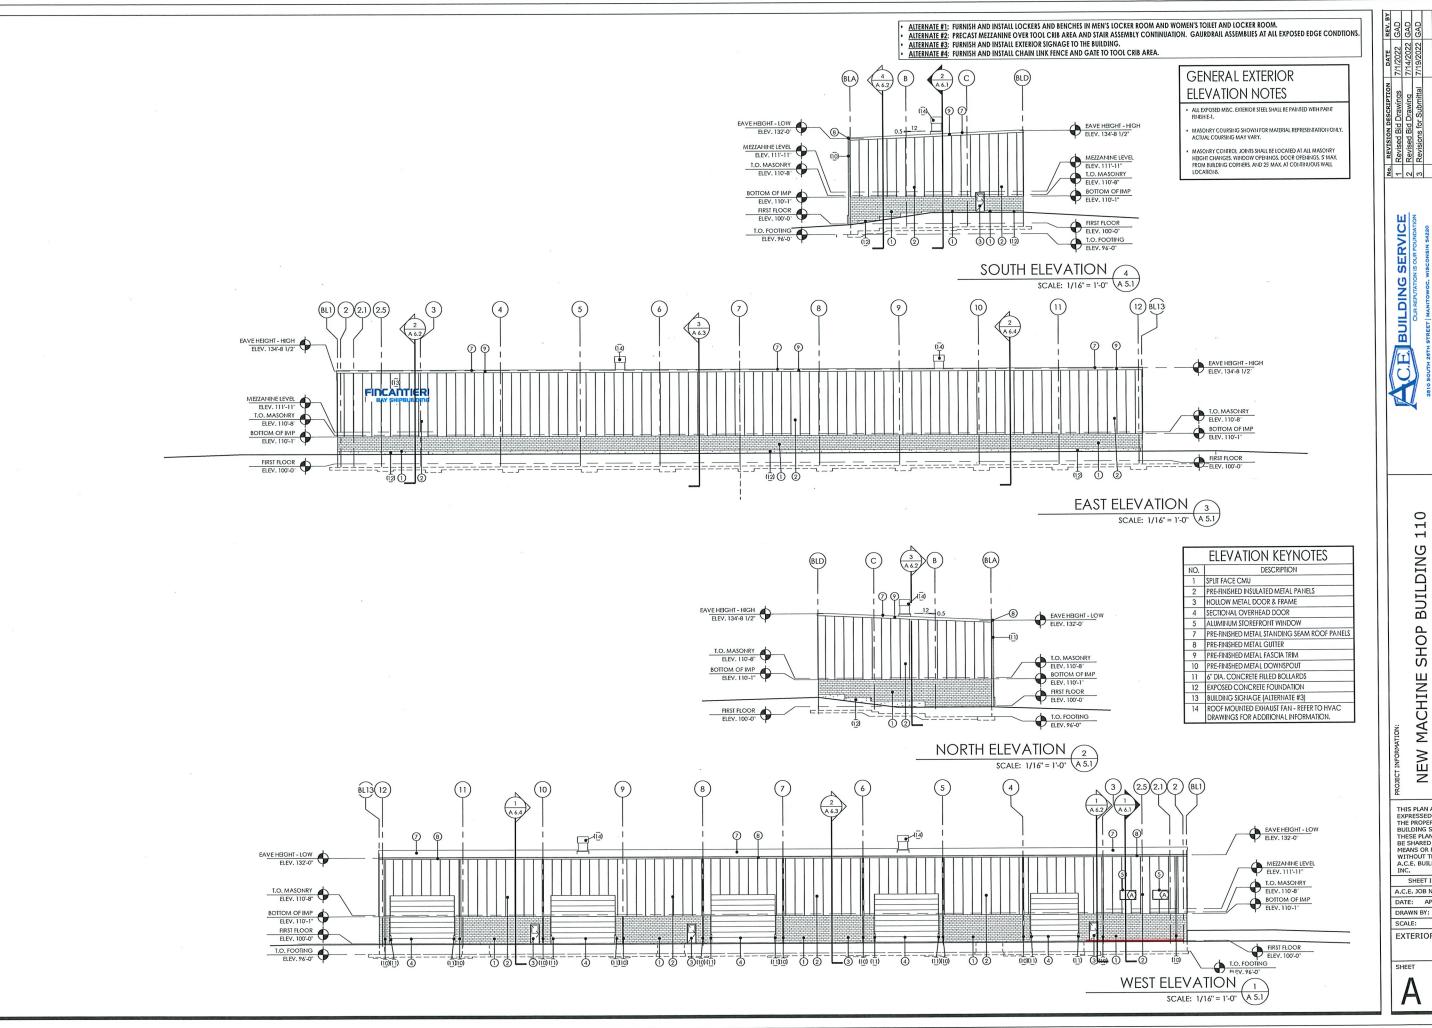

3 Civil SMI


> BUILDING NEW MACHINE SHOP B FINCANTERI - BAY SHIP BUILDING 605 NORTH 3RD AVENUE STURGEON BAY, WISCONSIN 54235

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SHEET INFORMATION A.C.E. JOB NO. 141/22 DATE: APRIL 18, 2022

DRAWN BY: GAD As indicated

EXTERIOR ELEVATIONS



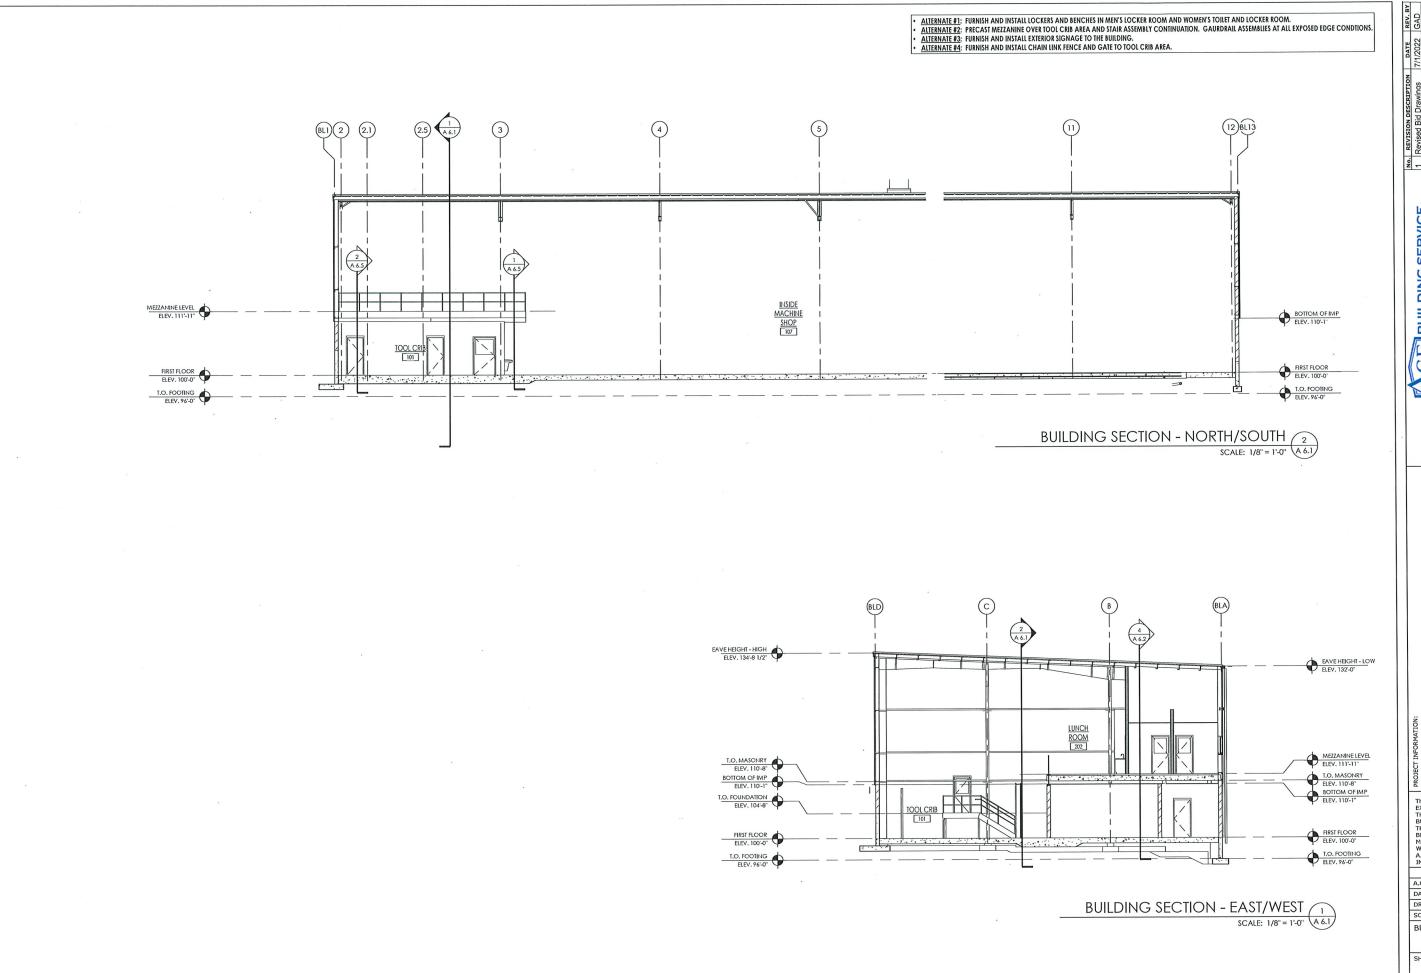

NEW MACHINE SHOP BUILDING 110 FINCANTER! - BAY SHIP BUILDING 605 NORTH 3RD AVENUE STURGEON BAY, WISCONSIN 54235

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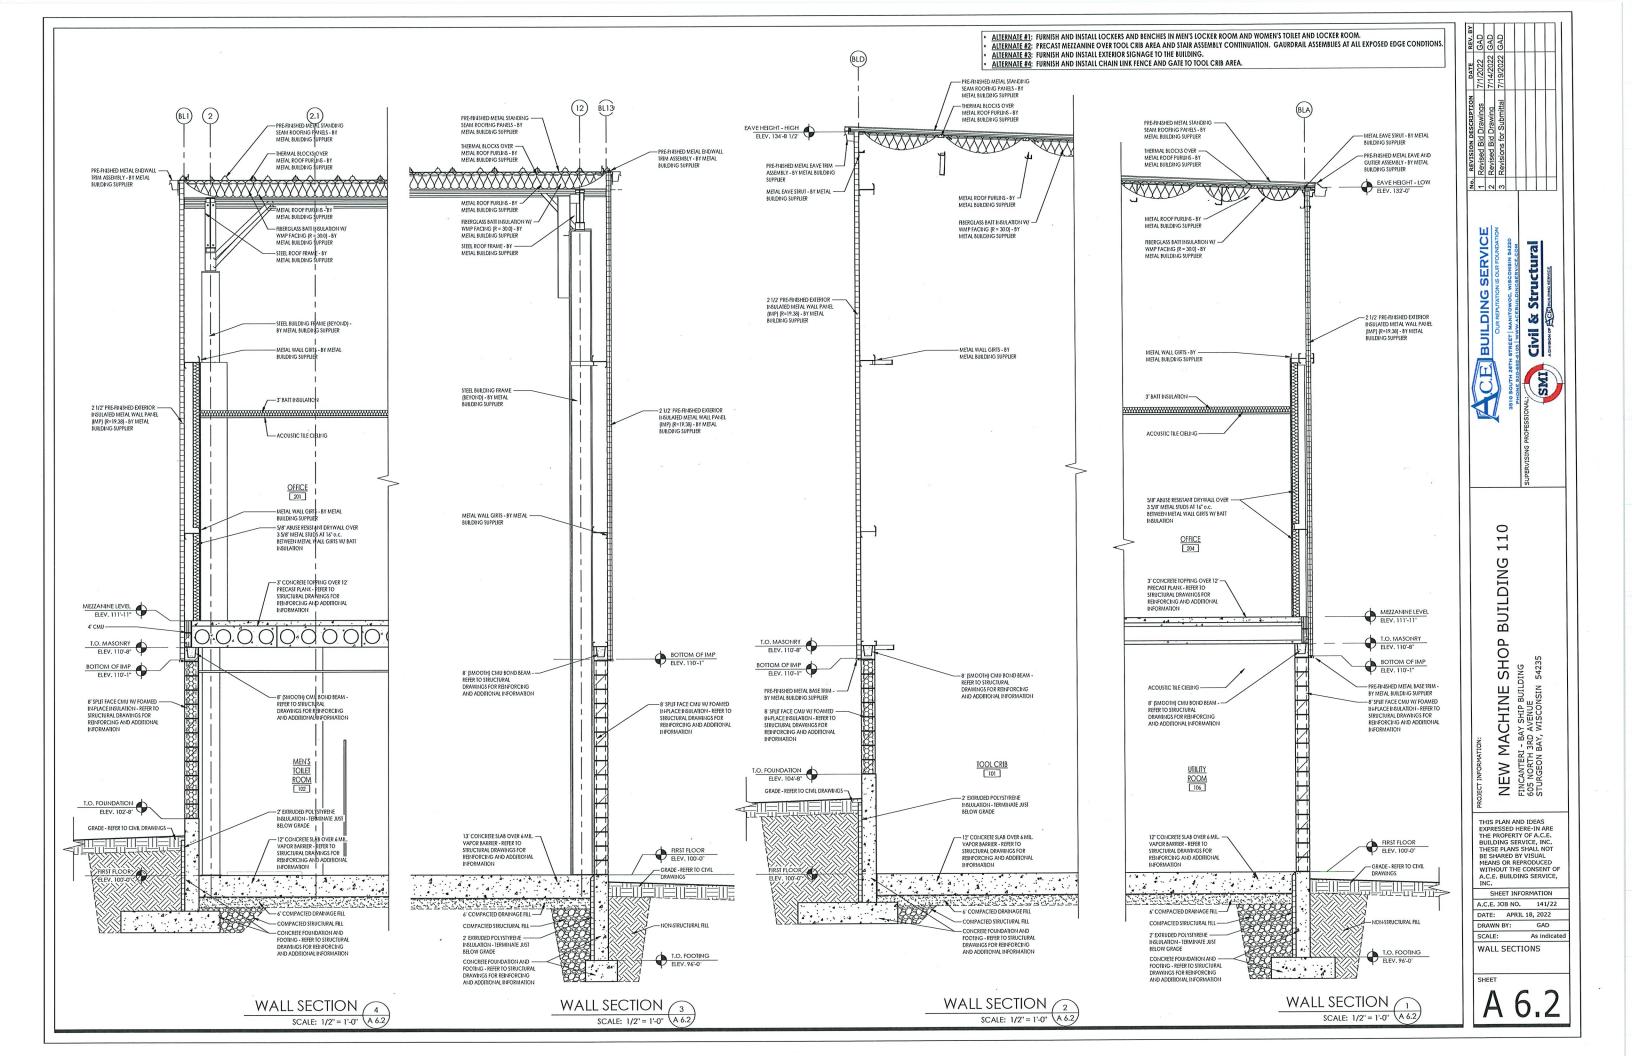
A.C.E. JOB NO. 141/22


DATE: APRIL 18, 2022
DRAWN BY: GAD

SCALE: As indicated
BUILDING SECTIONS


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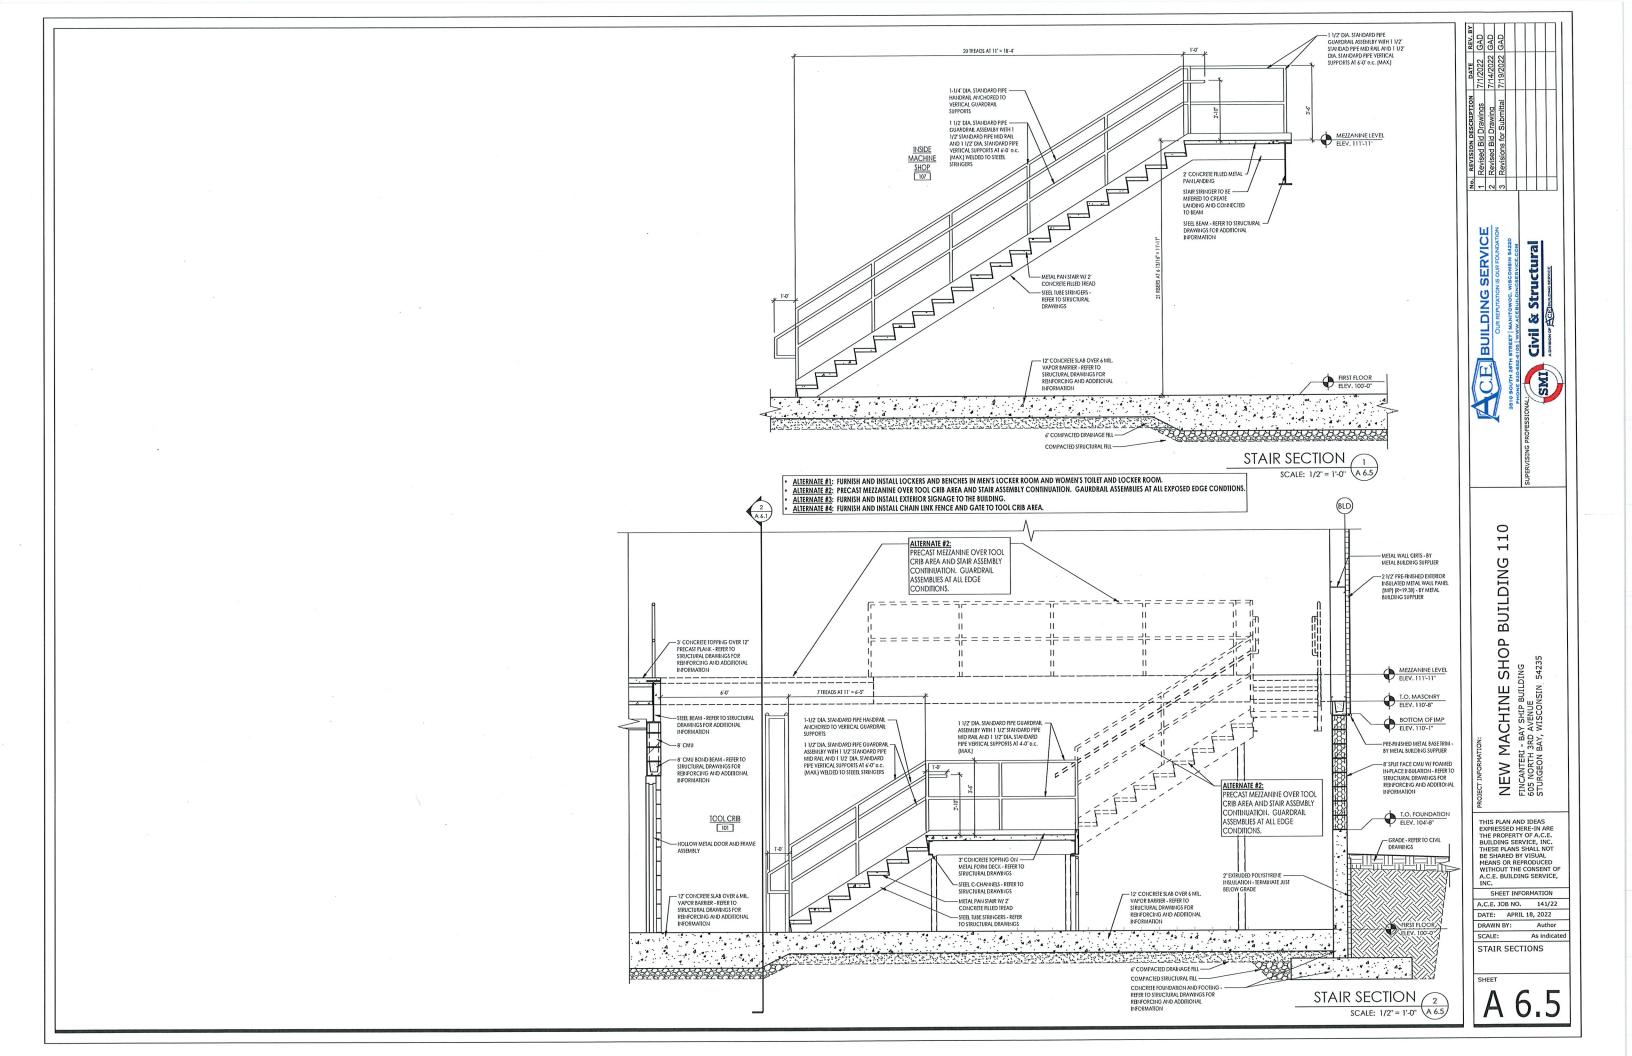
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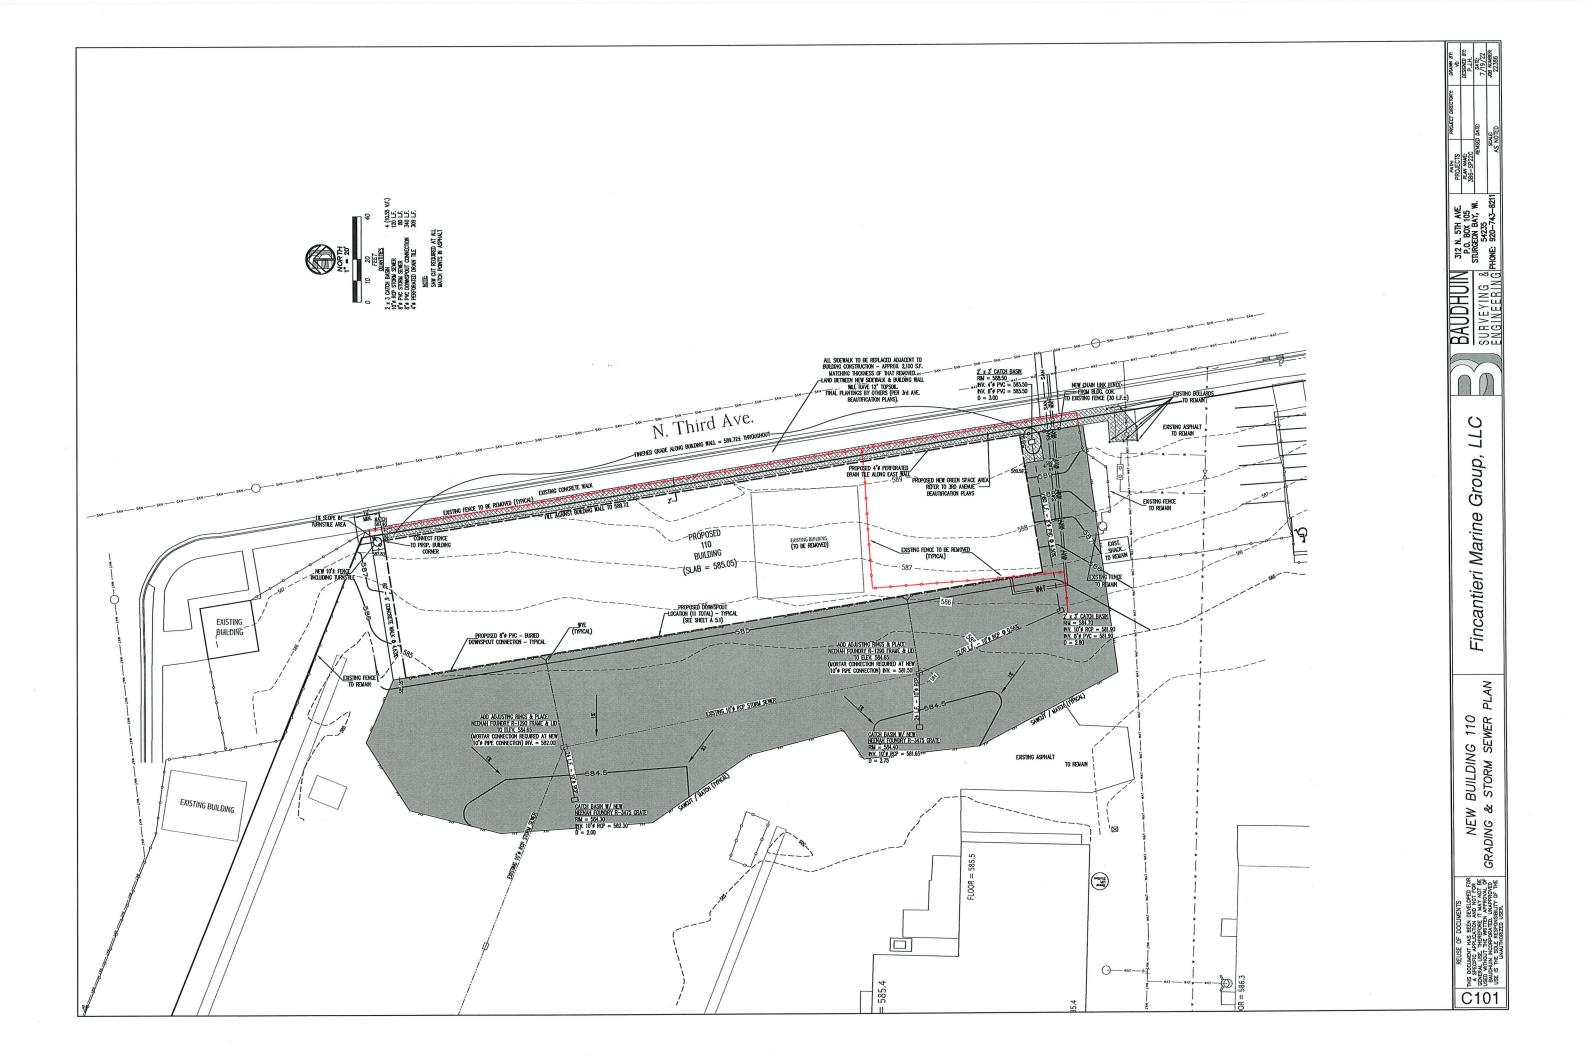






SERVIC Structural CE BUILDING めい CIVII SMI 0 Ü BUILDING IOP 54235 SH MACHINE 1- BA 3RD BAY, NEW M FINCANTERI -605 NORTH 3 STURGEON B. THIS PLAN AND IDEAS THIS PLAN AND IDEAS EXPRESSED HERE-IN ARE THE PROPERTY OF A.C.E. BUILDING SERVICE, INC. THESE PLANS SHALL NOT BE SHARED BY VISUAL MEANS OR REPRODUCED WITHOUT THE CONSENT OF A.C.E. BUILDING SERVICE, INC. SHEET INFORMATION A.C.E. JOB NO. 141/22 DATE: APRIL 18, 2022 DRAWN BY: Author SCALE: As indicated WALL SECTIONS

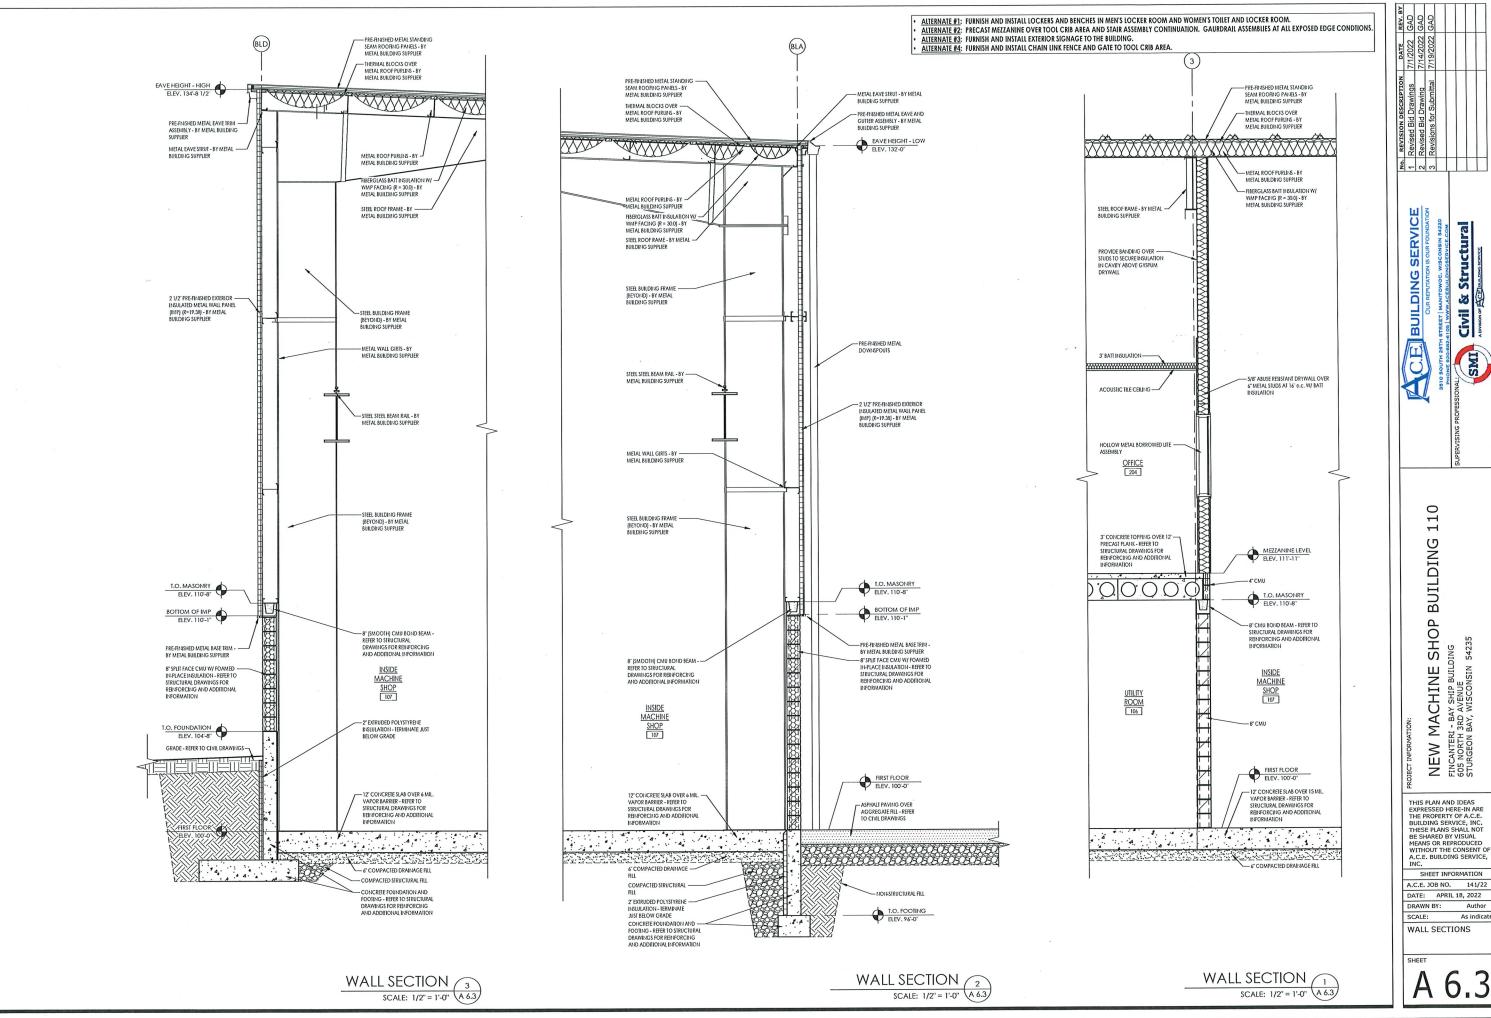




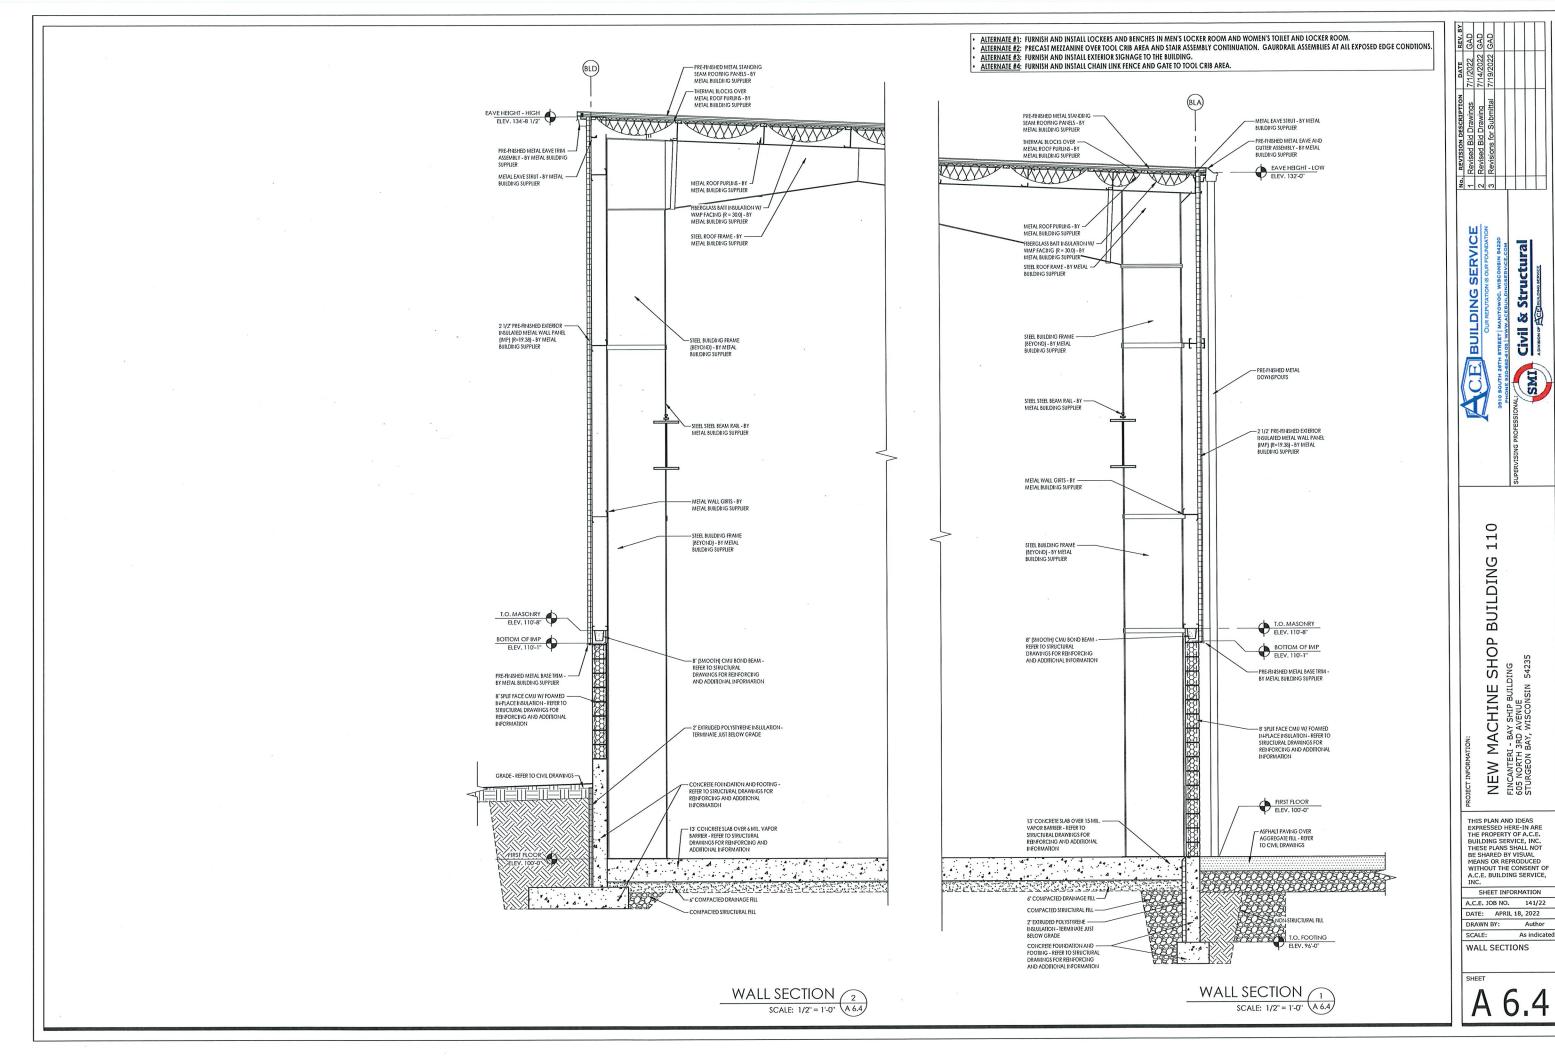

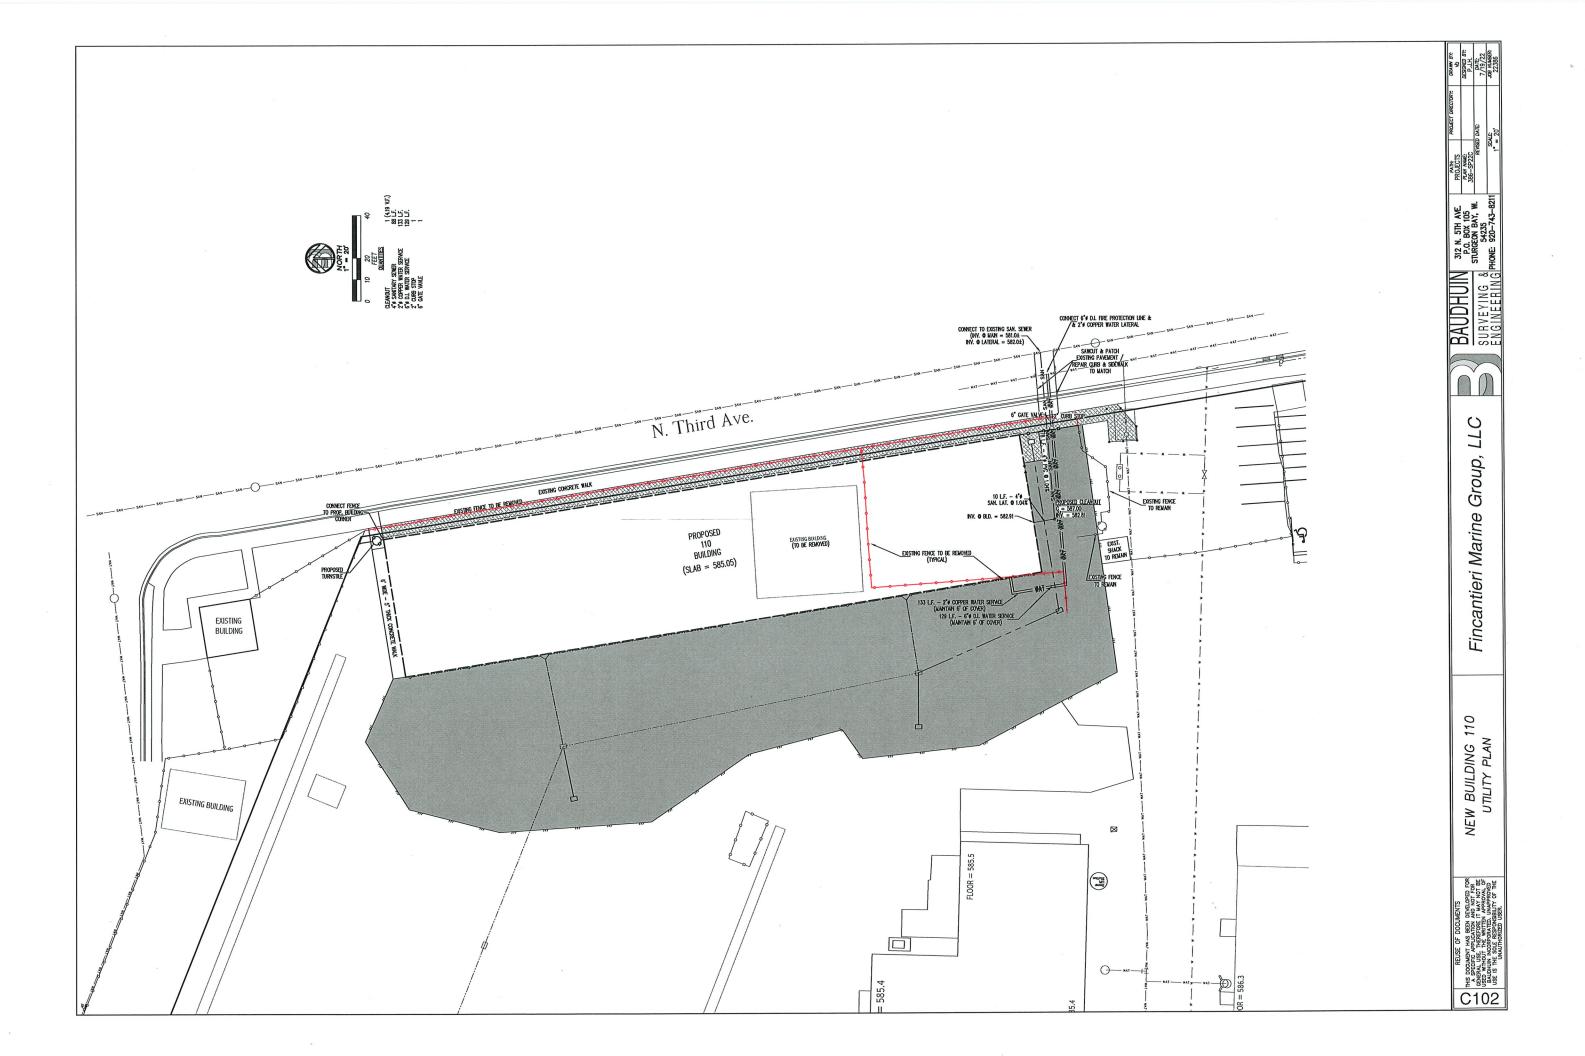


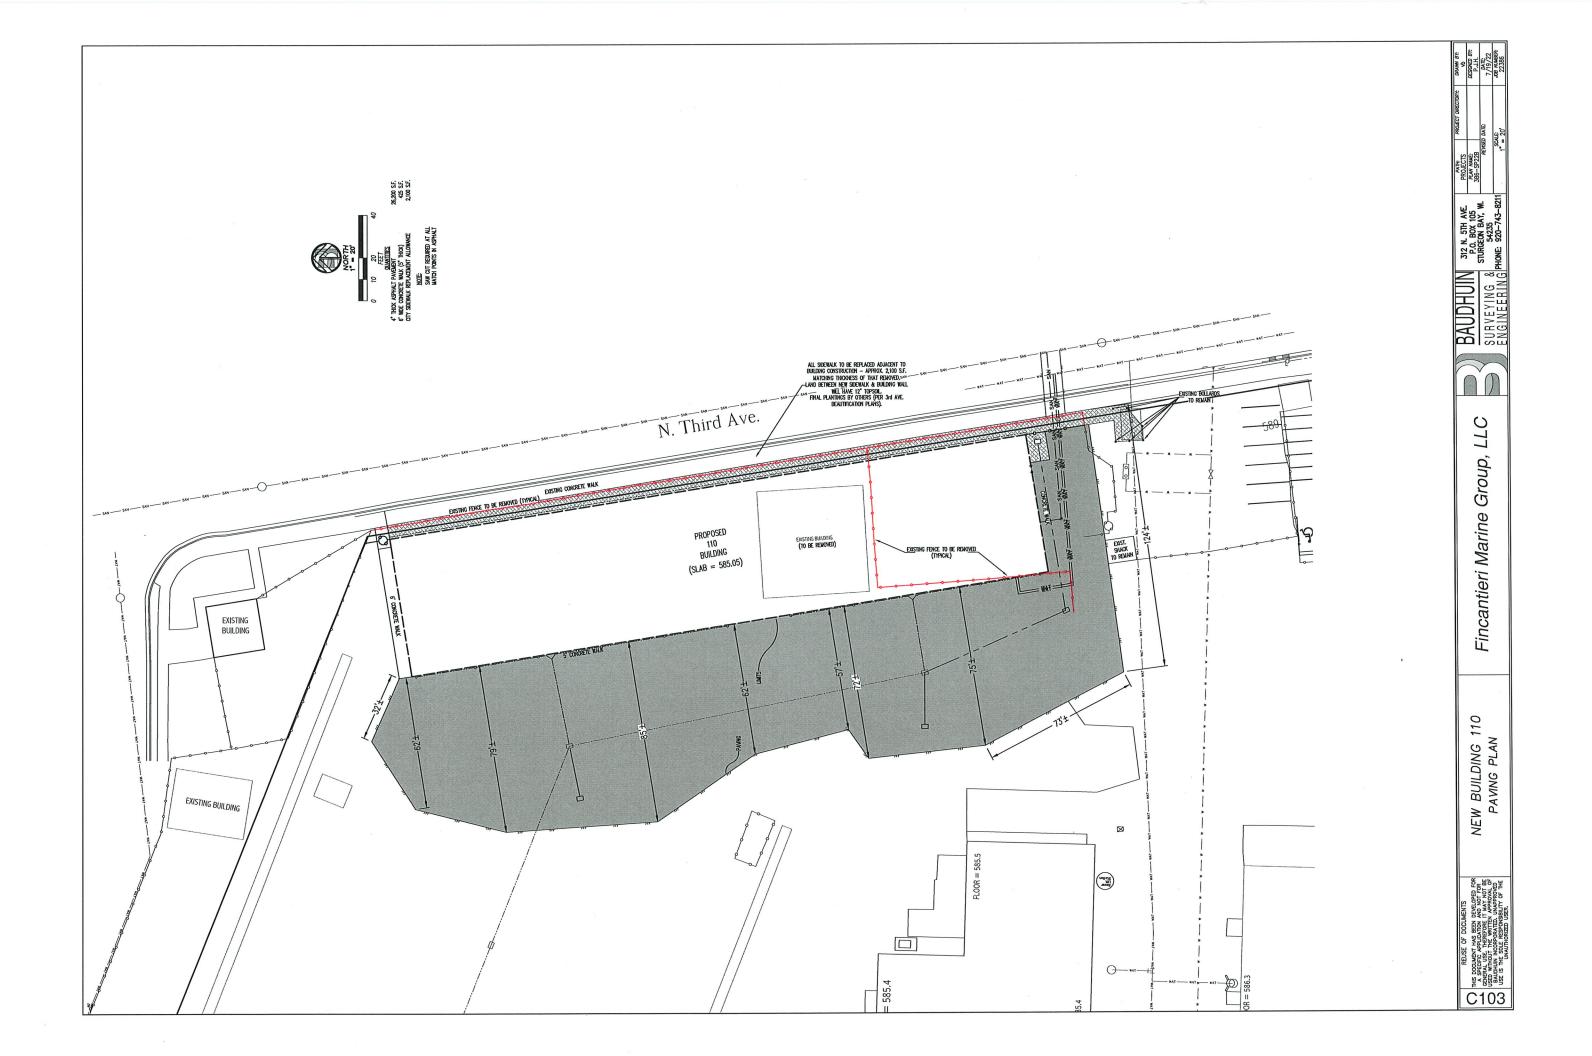




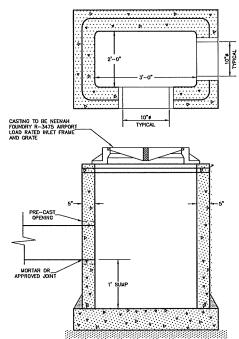


Standard Gate Valve Box Setting

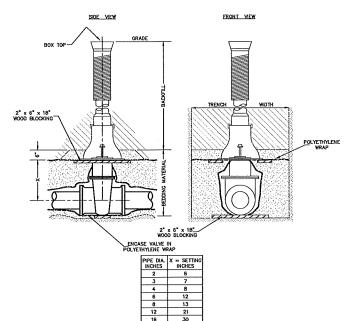


Pavement Cross-Section NO SCALE

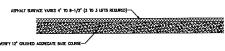

Concrete Walk Cross-Section

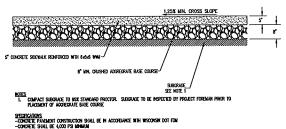

Sanitary Cleanout Detail

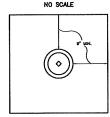

PLAN VIEW

