

WATER POLLUTION CONTROL PLANT PHOSPHORUS REMOVAL MAGNETITE FEEDER PROJECT TOWN OF SOUTHINGTON, CONNECTICUT PROJECT # 2025-01 MARCH 2025


LIST OF DRAWINGS		
SHEET NO.	DRAWING NO.	DRAWING TITLE
1	G-001	COVER SHEET
2	M-601	MECHANICAL PLAN PHOSPHORUS REMOVAL BUILDING - PROCESS AREA
3	M-604	MECHANICAL SECTIONS - PHOSPHORUS REMOVAL BUILDING
4	PI-604	PIPING & INSTRUMENTATION DIAGRAM - PHOSPHORUS REMOVAL SYSTEM
5	E-601	ELECTRICAL PLAN PHOSPHORUS REMOVAL BUILDING - PROCESS AREA

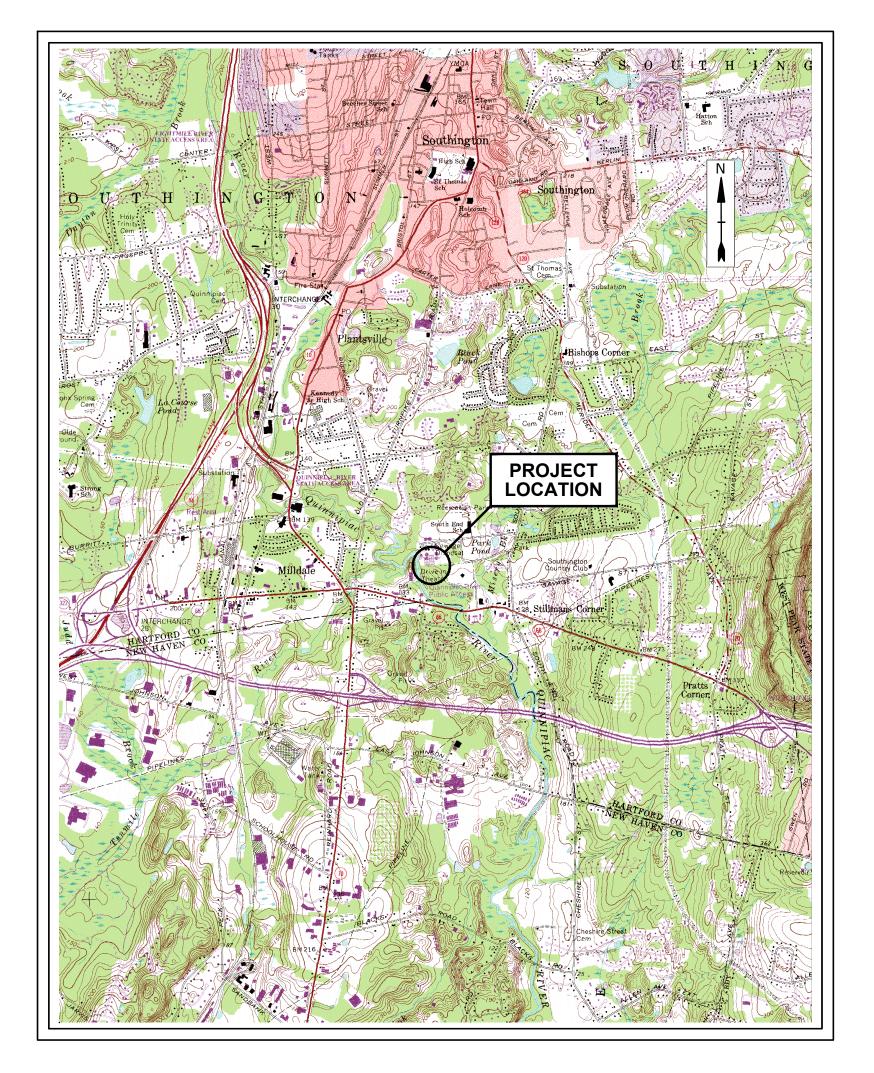

PREPARED BY:

Tighe&Bond

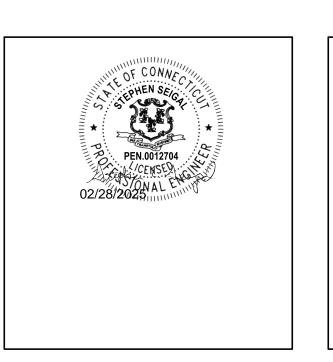

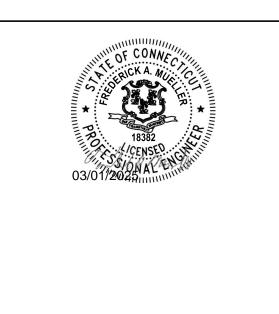


WPCP SUPERINTENDENT KIARI WILLIAMS

LOCATION PLAN

SCALE

COMPLETE SET 5 SHEETS

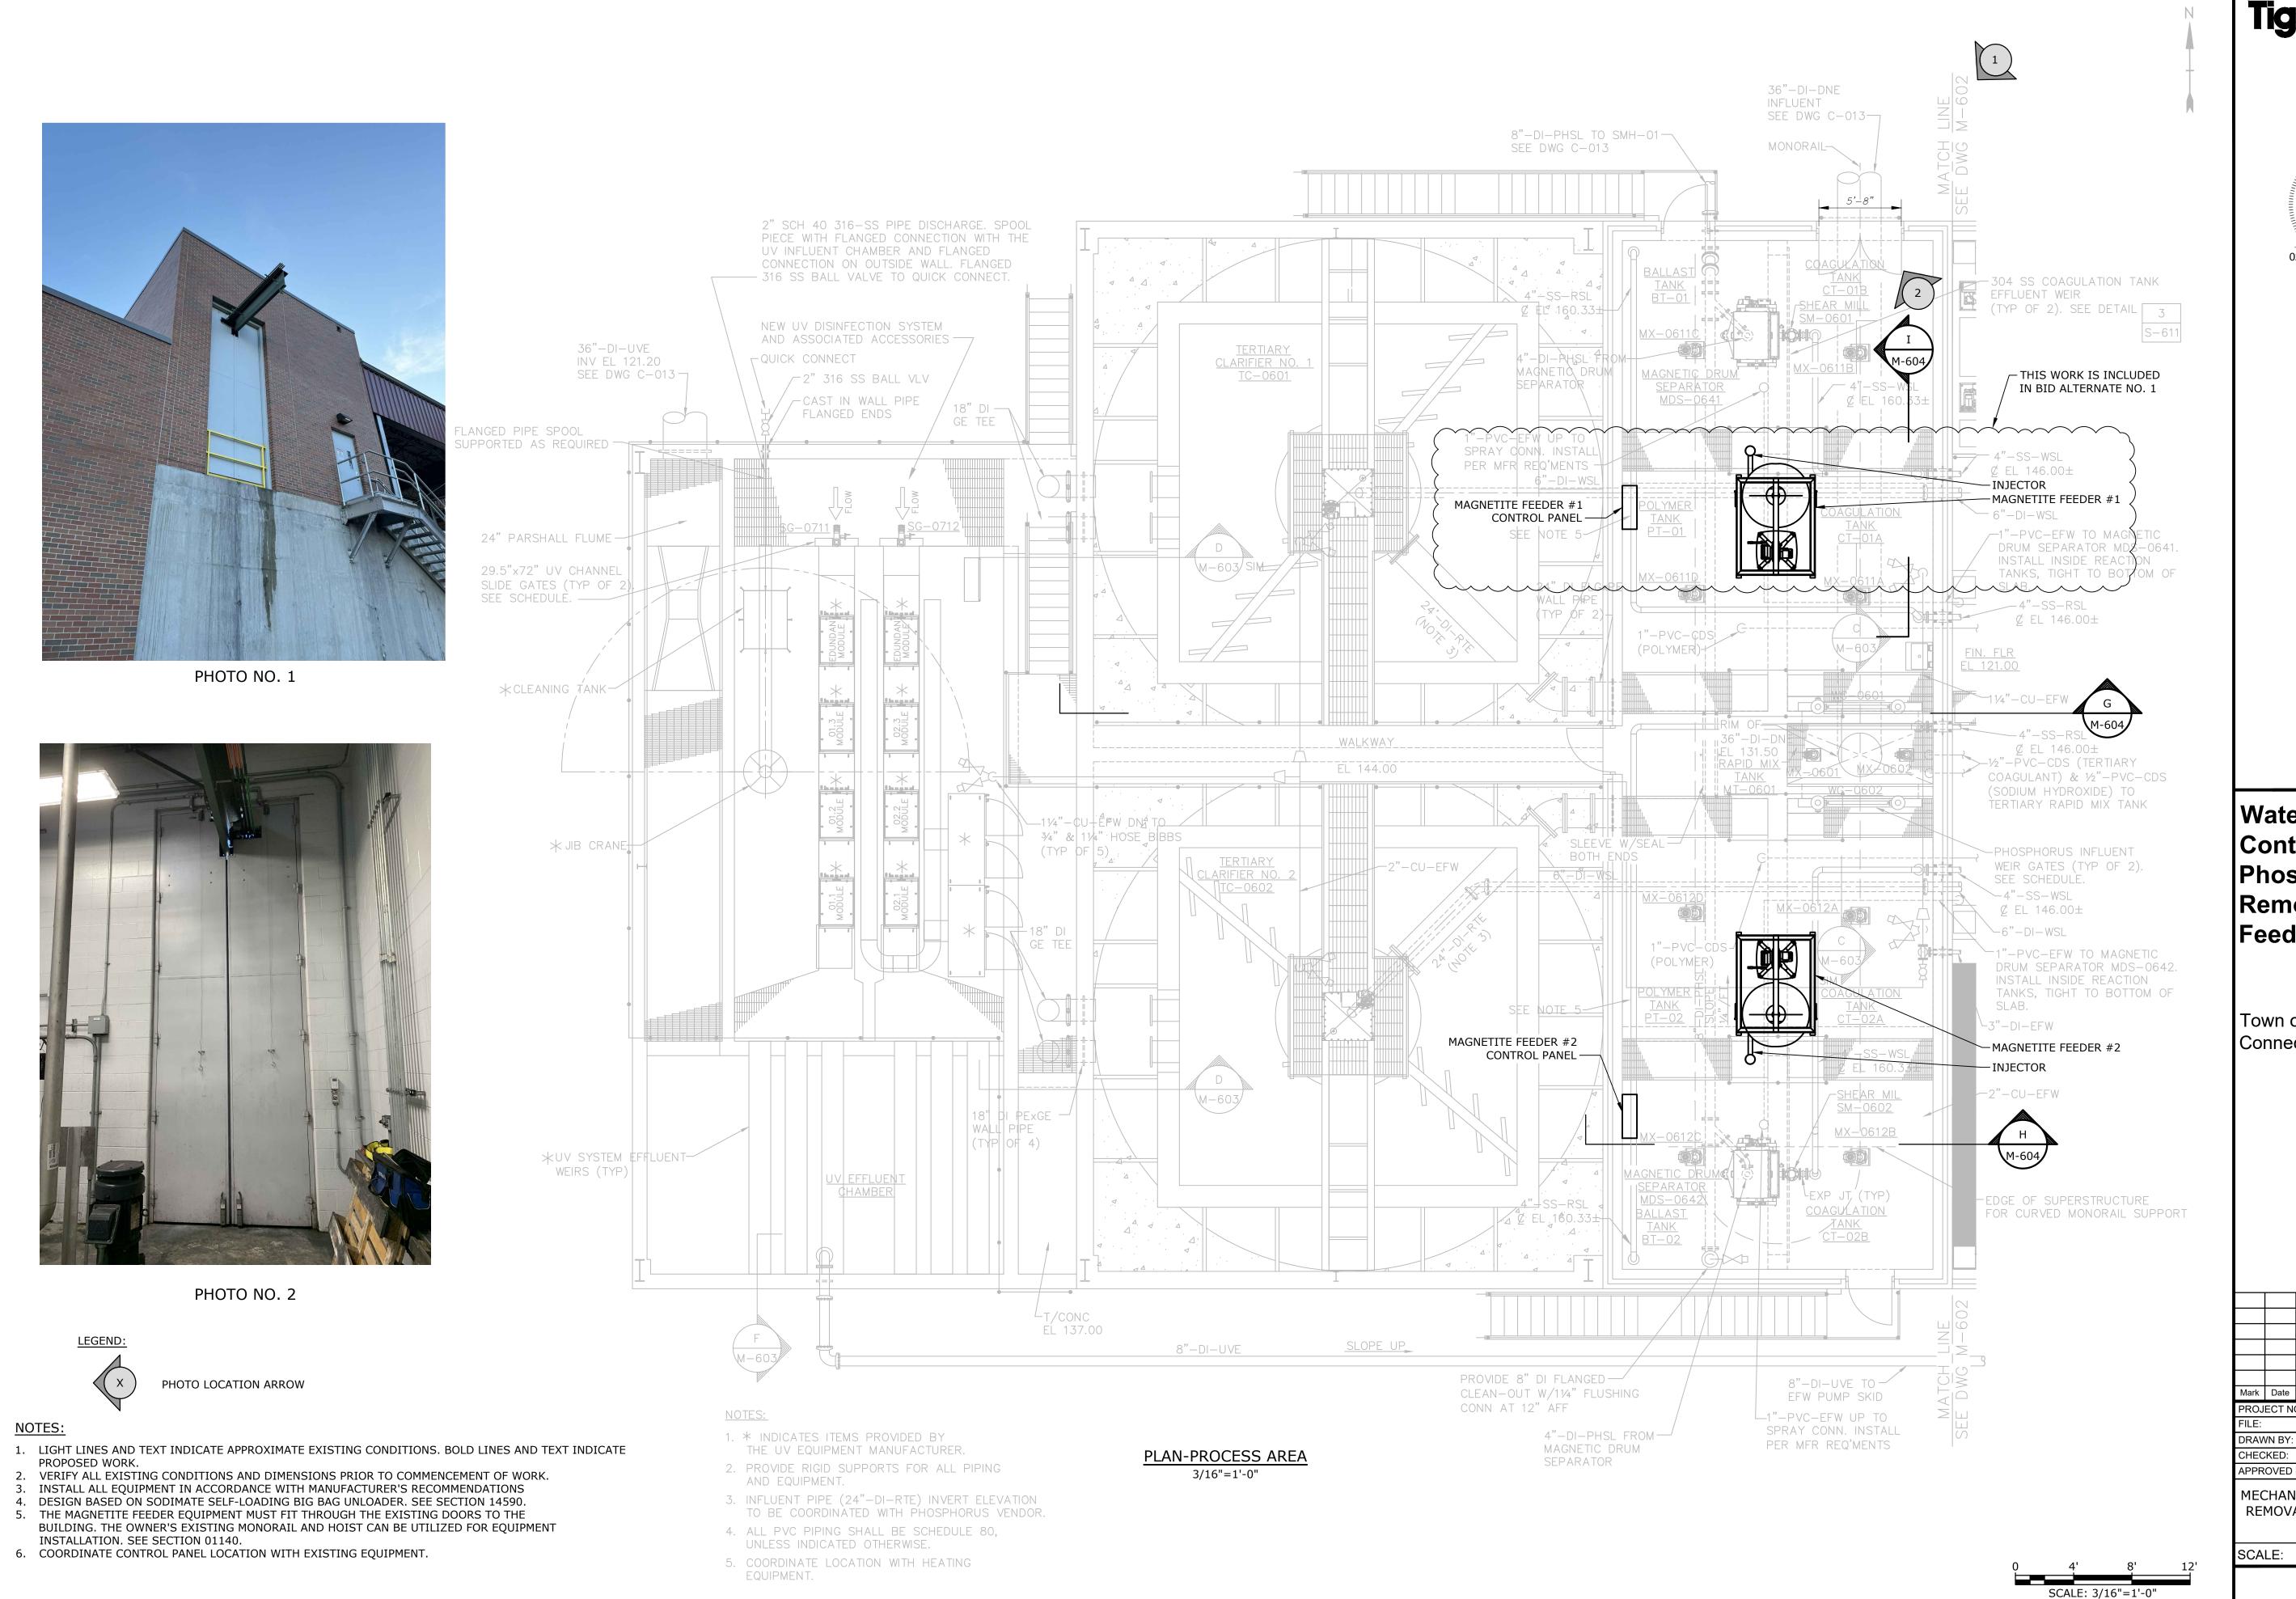

FILENAME: J.\S\\$1928 SOUTHII SAVE DATE: 2/27/2025 8:50 PLOT DATE: 2/27/2025 9:38 Tighe&Bond
www.tighebond.com





Water Pollution Control Plant Phosphorus Removal Magnetite Feeder Project

Town of Southington, Connecticut

Mark Date Description

PROJECT NO: S-1928/062

FILE: M-601

PROJECT NO: S-1928/062

FILE: M-601

DRAWN BY: PML

CHECKED: FAM


APPROVED BY: SES

MECHANICAL PLAN PHOSPHORUS REMOVAL BUILDING - PROCESS AREA


SCALE: AS SHOWN

M-601

SHEET 2 OF 5

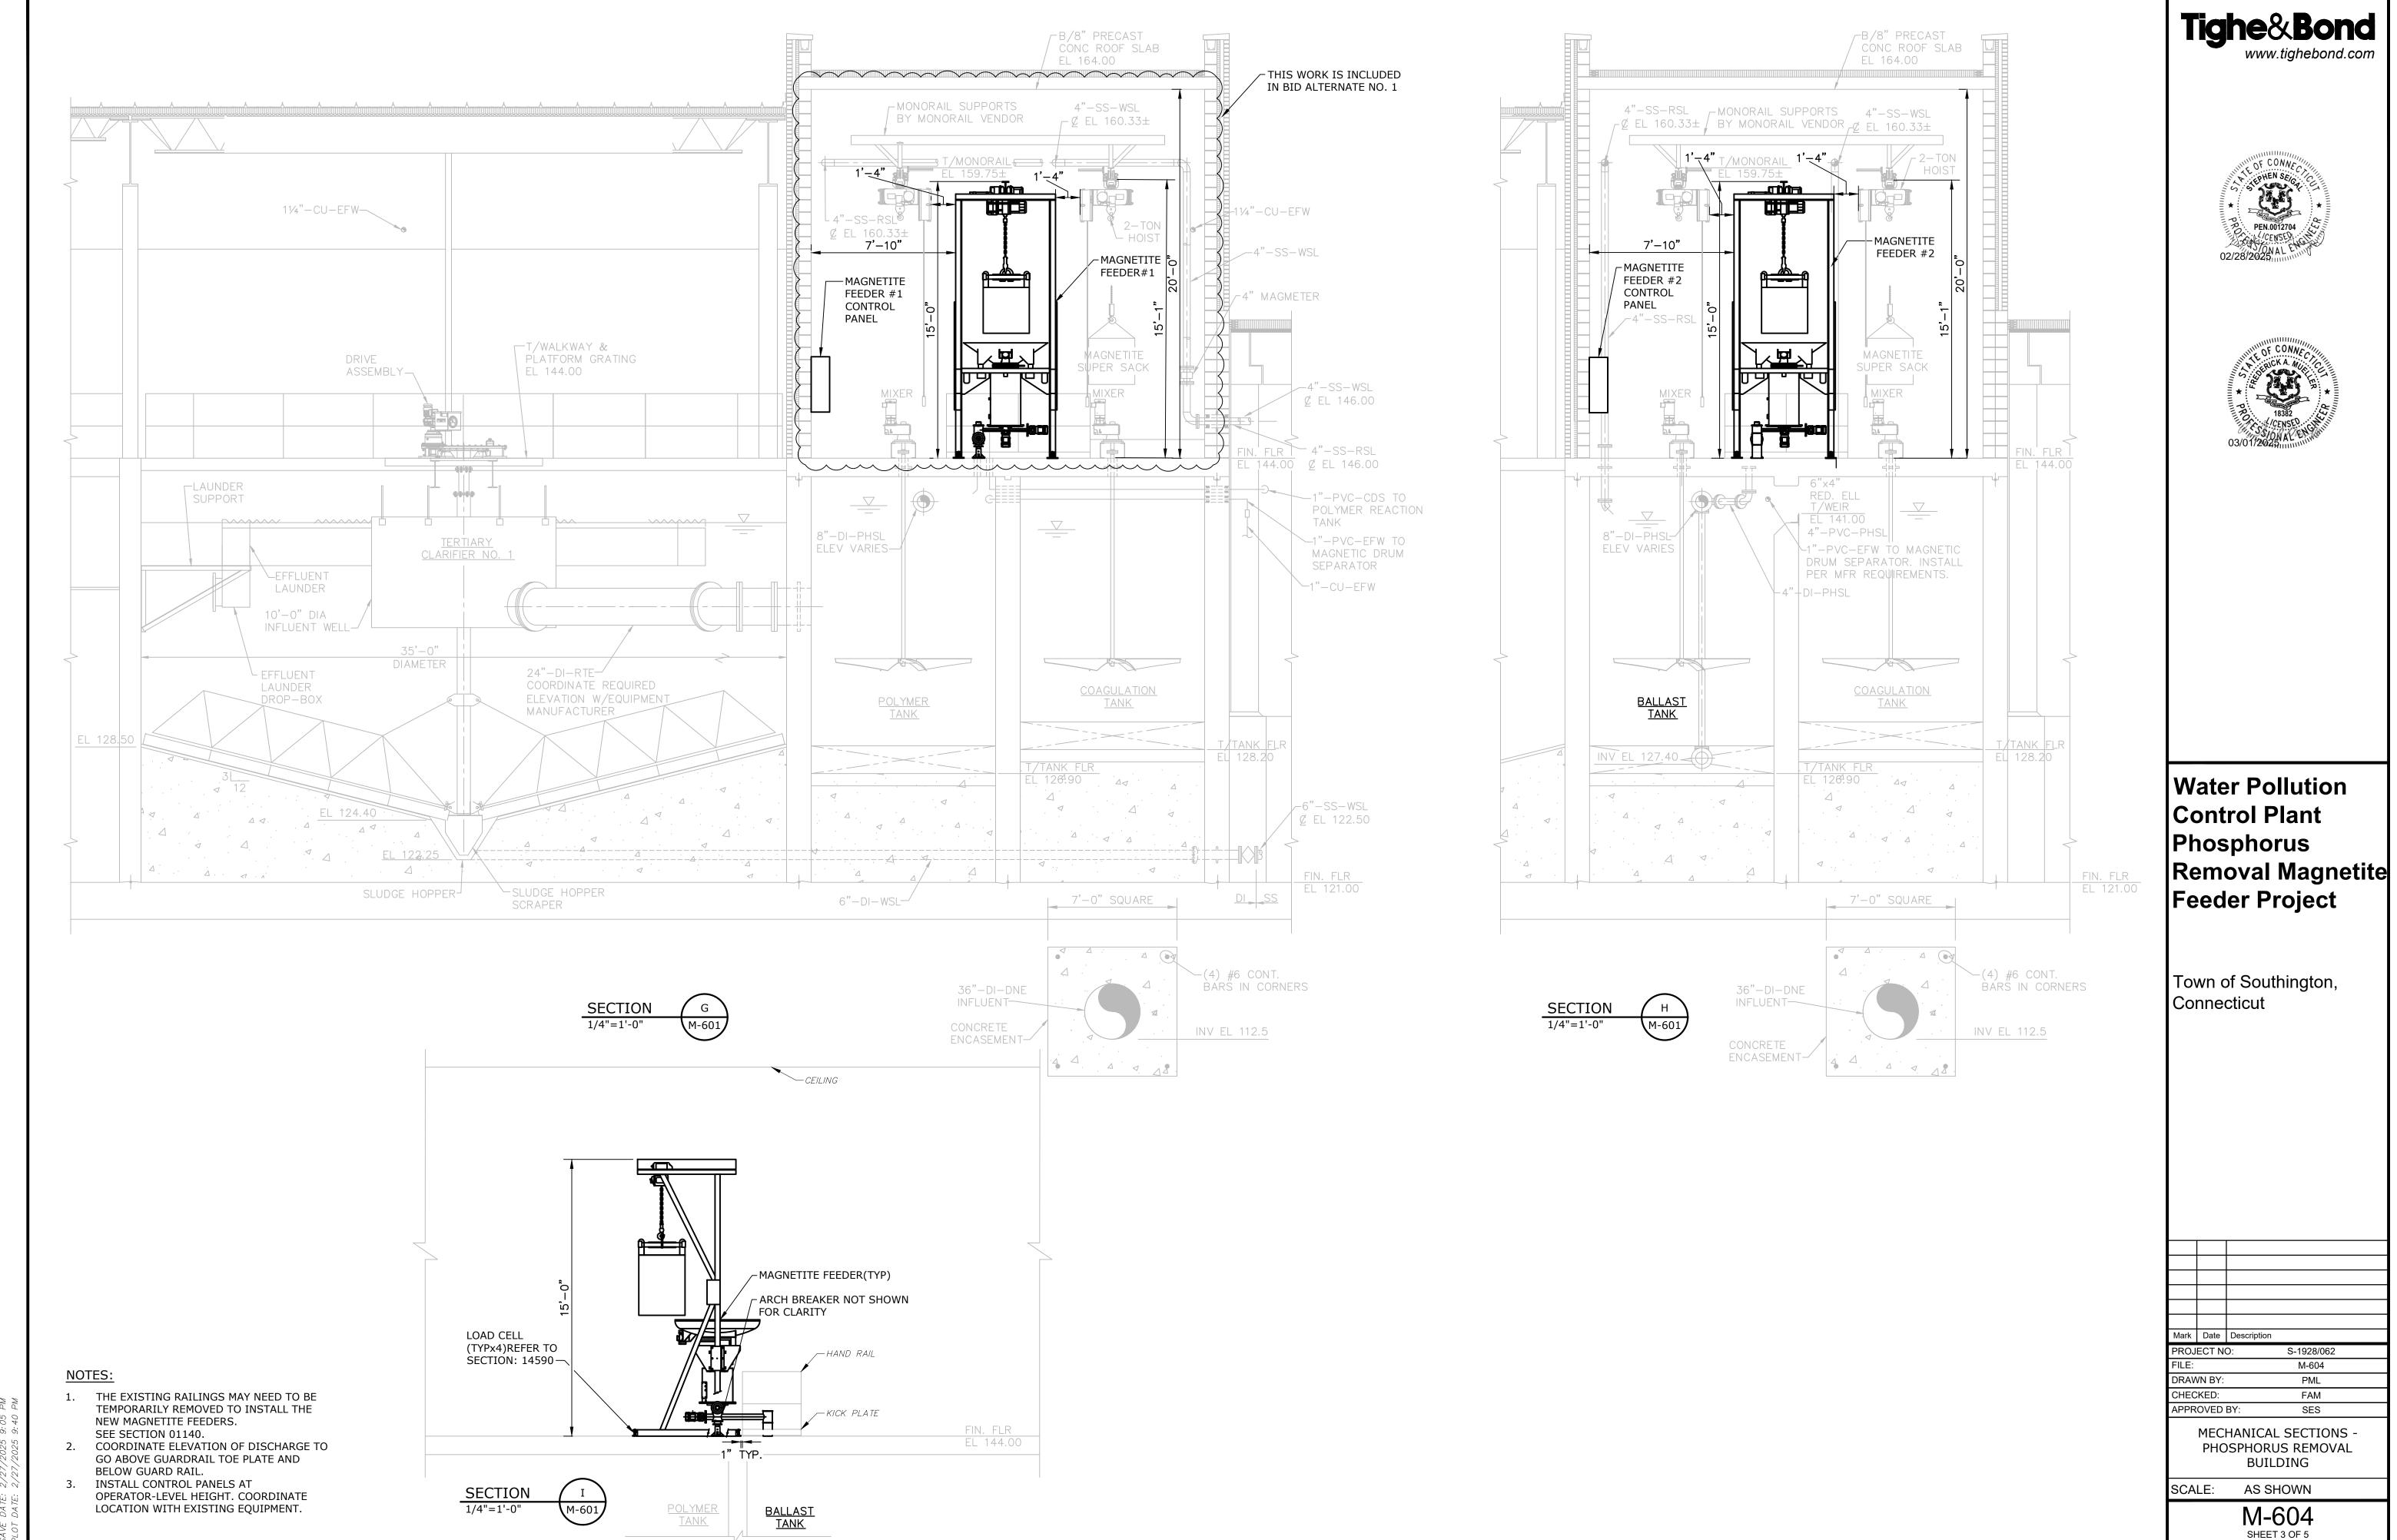

VAME: J:\S\S1928 SOUTHINGTON\O62 — MAG HOPPER\DRAWINGS\AUTOCAD\SHEET\S192 - DATE: 2/27/2025 9:05 PM

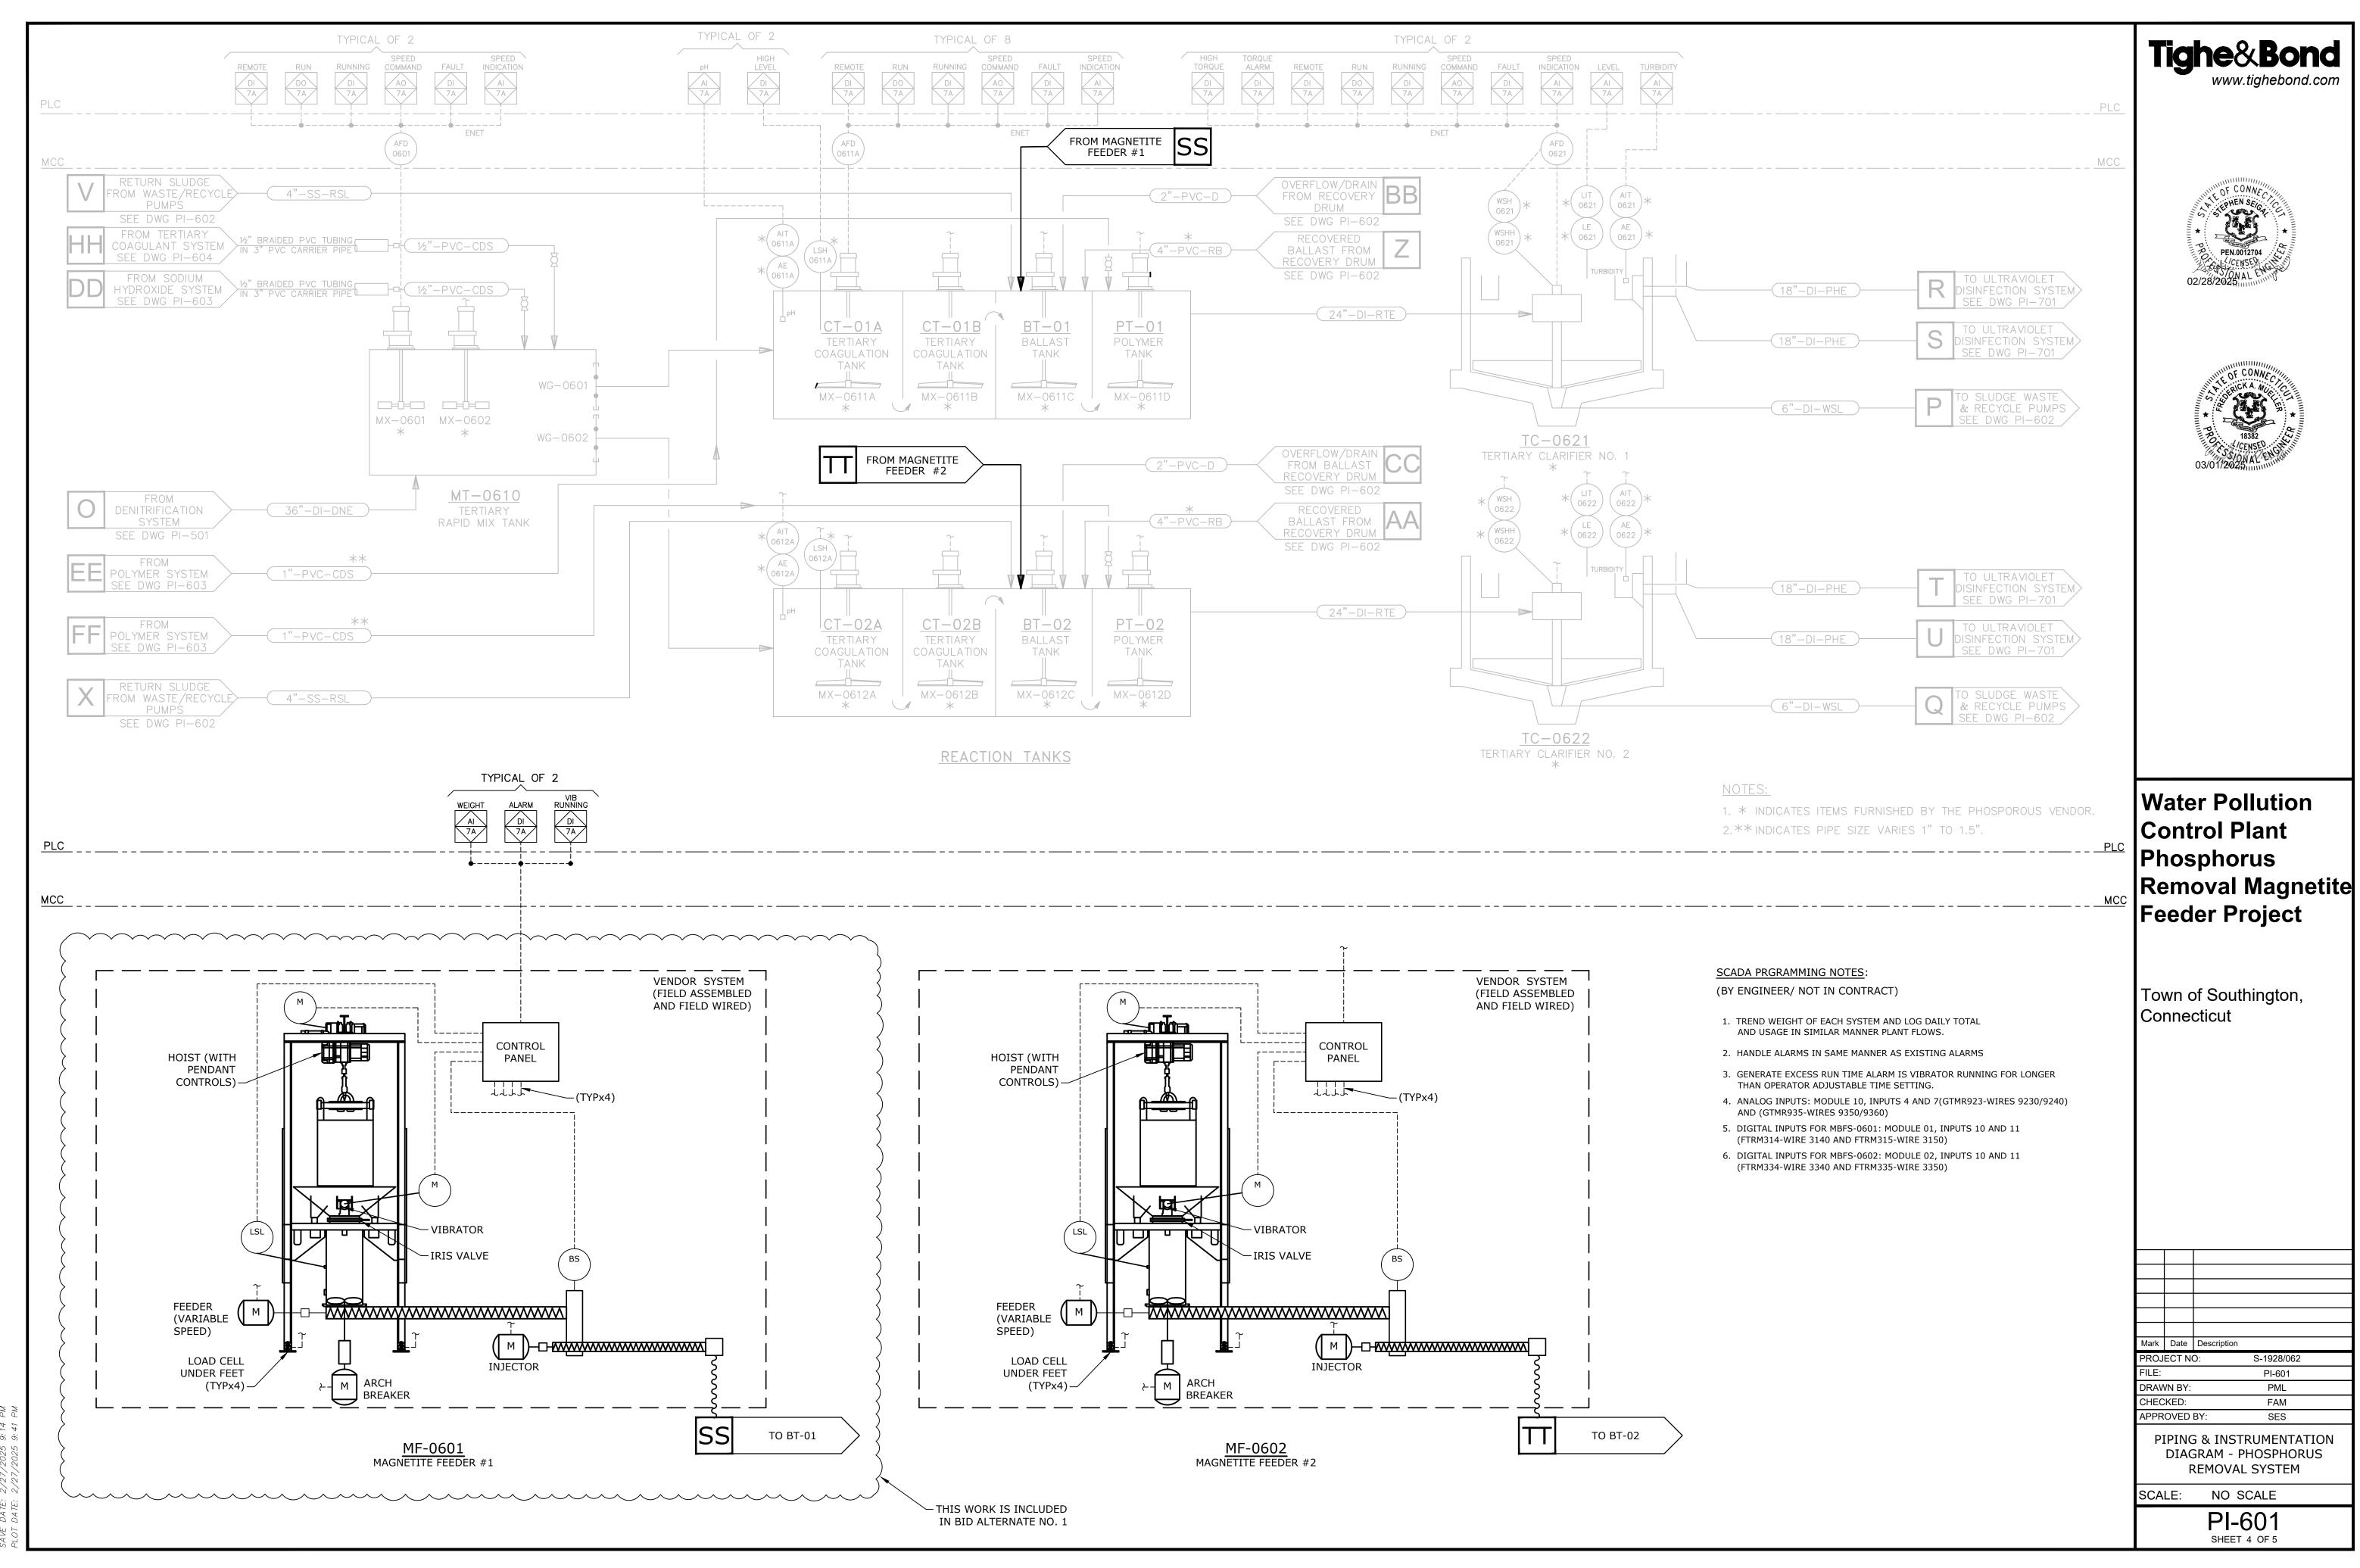

8 SOUTHINGTON\062 - MAG HOPPER\DRAWINGS\AUTOCAD\SHEET\S192

BOLD LINES AND TEXT INDICATE PROPOSED WORK

LIGHT LINES AND ITALIZED TEXT INDICATE APPROXIMATE EXISTING CONDITIONS

→ MCC-9 HOMERUN TO EQUIPMENT. "MCC-9" INDICATES EQUIPMENT ID

M

MOTOR LOAD

LSL

INSTRUMENT OR CONTROL DEVICE. "LSL" INDICATES INSTRUMENT OR DEVICE ID NUMBER/TAG.

ABBREVIATIONS

WIRE SIZE OR IDENTIFICATION NUMBER MFR MANUFACTURER

AMPERES P POLE

WG AMERICAN WIRE GAUGE PH PHASE

DG BUILDING PLC PROGRAMMABLE LOGIC CONTROLLER


C CONDUIT SW SWITC

CB CIRCUIT BREAKER TSP TWISTED SHIELDED PAIR CABLE

CP CONTROL PANEL TYP TYPICAL

MCC MOTOR CONTROL CENTER V VOLT

MISC MISCELLANEOUS W WATT, WIRE

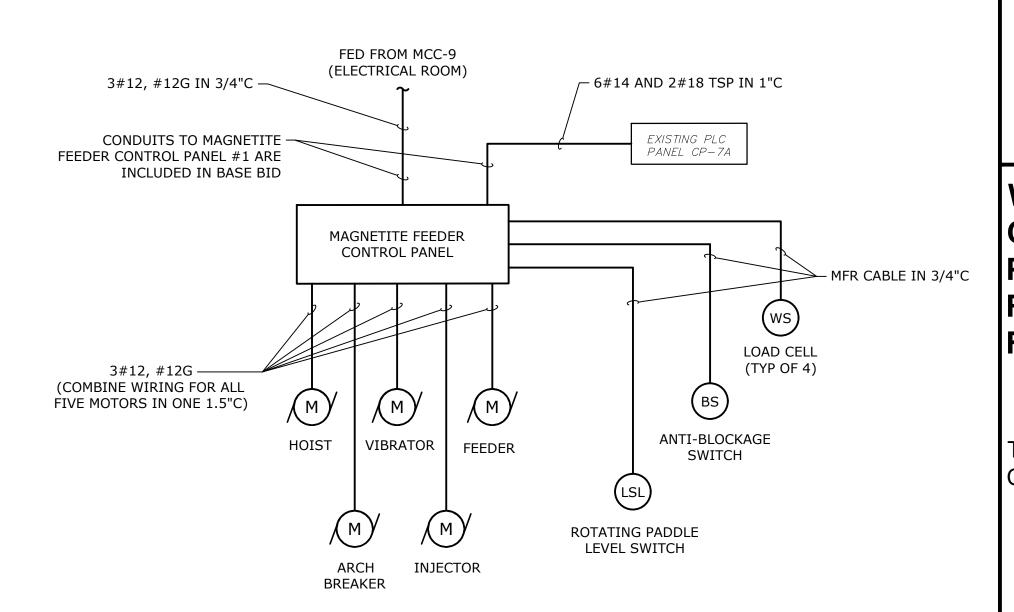

MAGNETITE FEEDER WIRING DIAGRAM (TYP OF 2)

NO SCALE

KEY NOTES:

INSTALL A DUAL FEEDER MCC BUCKET WITH 20A, 480V, 3P CIRCUIT BREAKER FOR EACH MAGNETITE FEEDER IN A SPARE MCC BUCKET SPACE. PROVIDE ALL NECESSARY HARDWARE AND ACCESSORIES AS REQUIRED FOR A COMPLETE INSTALLATION. PROVIDE A NEW DOOR FOR THE MCC BUCKET WITH THROUGH-THE-DOOR CIRCUIT BREAKER HANDLES. THE EXISTING MCC IS AN EATON SERIES 2100. SHUTDOWN OF MCC-9 SHALL OCCUR BETWEEN OCTOBER 31 AND MARCH 31 OR BE COORDINATED WITH OWNER TWO WEEKS IN ADVANCE. DISRUPTION OF POWER TO MCC-9 SHALL NOT BE MORE THAN 1.5 HOURS.

RELOCATE EXISTING LIGHTING FIXTURES ABOVE MAGNETITE FEEDER TO AVOID ANY PHYSICAL CONFLICT. CONFIRM WITH OWNER THE NEW LOCATION OF LIGHTING FIXTURE.

CONDUITS BETWEEN MAGNETITE FEEDER CONTROL PANEL AND MAGNETITE FEEDER SHALL BE RUN ALONG THE CEILING ABOVE THE MONORAIL. REFER TO DRAWING M-604 FOR ELEVATION DETAILS.

PLAN-PROCESS AREA
3/16"=1'-0"

Tighe&Bond





Water Pollution Control Plant Phosphorus Removal Magnetite Feeder Project

Town of Southington, Connecticut

Mark Date Description
PROJECT NO: S-1928/062
FILE: E-601

PROJECT NO: S-1928/062

FILE: E-601

DRAWN BY: AP

CHECKED: MJR

APPROVED BY: SES

ELECTRICAL PLAN PHOSPHORUS REMOVAL BUILDING - PROCESS AREA

SHEET 5 OF 5

scale: AS SHOWN
E-601

