

Project #19-016 UT1 Larry Verizon Cell Tower Located at 1750 N 800 W

REPORT SUMMARY

Project Name: Proponent / Owner:

UT1 Larry Verizon Cell Tower Troy Benson / GunHo Logan, LLC

Project Address:

1750 N 800 W

Request:

Design Review & Conditional Use Permit

Current Zoning: Type of Action: Hearing Date

Industrial Park (IP) Quasi-Judicial

May 9, 2019

Submitted By: Aaron Smith, Planner II

RECOMMENDATION

Staff recommends that the Planning Commission **conditionally approve** a Design Review and Conditional Use Permit for Project #19-016, UT1 Larry Verizon Cell Tower, in the Industrial Park (IP) zone located at 1750 N 800 W. TIN #07-176-0020.

Current Land use adjoining the subject property

	IP: Industrial Uses	East:	IP: Industrial Uses
South:	IP: Industrial Uses	West:	IP: Industrial Uses

Proposal

This is a proposal for an unmanned communications facility consisting of antennas mounted to a new 70' monopole with outdoor equipment, generator, and 20' x 38' fenced ground lease area. The ground equipment includes a diesel generator, a steel equipment cabinets and space for up to 2 additional cabinets. The tower has a 6' tall lighting rod on top and a large antenna array located on the upper area of the pole, and two microwave dishes located near the middle of the pole. The antenna array consists of three directional facing groups of 8' tall antennas. The three arrays project out from the side of the pole approximately 4-7' in a triangular shaped pattern. The proposed location is in the southwest corner of the GunHo Logan property.

Land Development Code

The Land Development Code (LDC) 17.38 requires a Design Review and Conditional Use permit for all new wireless telecommunications facilities and specifies design requirements. Monopoles are allowed to be 70' tall within the IP zone. A 2' horizontal setback for every 1' of pole height from public and private streets is required. Equipment must be screened from public view. Antennas and their supporting structure mounted to the side or top of the pole shall be slim in profile and not extend more than 1' beyond the side of the pole. To the extent reasonably feasible, stealth design should be used to mitigate negative visual effects. Co-location is encouraged in order to discourage the proliferation of wireless communications facilities.

Setbacks

The Land Development Code (LDC) requirements for setbacks in the IP zone are as follows (as measured from property lines):

Front:

20'

Side:

20'

Rear:

10'

The following setbacks are proposed for the pole base (as measured from the exterior property line to the proposed pole location):

Front (East): 140'
Side (South): 20'
Side (North): 132'
Rear (West): 62.5'

The nearest streets are 800 W and 730 W. 800 W is a public street and is located approximately 250' from the monopole. The 730 W is a private street and is located approximately 140' from the pole.

As proposed, the pole meets minimum requirements of the LDC.

Design

Stealth Design

The LDC 17.38 requires "stealth" design measures to limit the negative visual impacts of telecommunication and wireless towers to neighboring properties. Blending or mimicking nearby architecture or vegetation is encouraged to help camouflage the towers and their associated equipment. The applicant does not propose any stealth design as the area around the site is industrial in nature. Staff agrees with the assessment that "stealth" design, such as paint or color, in this area is likely to draw more attention to the pole. Additionally, there are large utility poles that serve the nearby electrical substation that are similar in height and materials to the requested pole.

Co-location

Co-location onto existing towers is encouraged to limit the proliferation of wireless facilities. The LDC requires that the applicant demonstrate to the decision-making body that reasonable efforts were made to co-locate onto nearby existing facilities and explain why co-location is not feasible in this particular application. The applicant states that the nearest tower is .79 miles from this location and is a Verizon tower. Co-locating to this tower would not help meet Verizon's coverage objectives. There is also a tower approximately .89 miles from the site, but the applicant indicates that there is inadequate ground space near the site for equipment that supports the antennas.

Side Projection

The LDC allows Antennas and other exterior equipment to project out from the side of the pole no more than one (1) foot and are intended to be as slim as possible. The array could be mounted vertically near the pole; however, this presents issues that prohibits any future colocation possibility because the slim vertical alignment covers the majority of the upper pole section. The applicant proposes a full antenna array that projects approximately 4-7' in a triangular shaped pattern from the pole. The applicant states that the full array is requested as it will allow for more technology to be pushed through the antennas, that is will allow for more cell traffic, and it would allow two (2) other carriers to co-locate on the tower. Staff concurs with this finding, as providing additional space on a pole in this location will reduce the need for additional poles in locations that may have a greater visual impact. As conditioned, the project meets the requirements in the LDC.

Airport Approach Clearance

The proposed site is within the Approach Zone for the main runway of the Logan-Cache Airport. Construction of a monopole within the zone will require approval of the Federal Aviation Authority. As a condition of this permit, approval for the proposed cell tower must be issued by the FAA and provided to the Community Development Department prior to issuance of a building permit.

Summary

The applicant has indicated there is a need for improved wireless communications service in this area. They were not able to find a suitable existing facility for co-location and would like to construct a new facility that meets their needs. The new facility meets the maximum height allowance, and they are requesting an allowance for a wider array configuration so that they can accommodate co-location at this site in the future. The three-sided array, which extends a approximately 4-7' from the pole, is the slimmest option that allows for co-location. Staff prefers more intensive use of this new pole as opposed to having other carriers construct additional poles in the area. Staff did not find a significant architectural feature, color, or pant that could be incorporated to improve "stealth" design of the pole.

AGENCY AND CITY DEPARTMENT COMMENTS

No comments were received from city departments.

PUBLIC COMMENTS

Notices were mailed to property owners within 300 feet of the subject property. As of the time of this report, no written comment had been received. Staff did speak with the Logan Cache Airport Manager Lee Ivie regarding the need for FAA approval for the tower.

PUBLIC NOTIFICATION

Legal notices were published in the Herald Journal on 4/27/2019 and the Utah Public Meeting website on 5/2/2019. Public notices were mailed to all property owners within 300 feet of the project site on 4/22/2019.

RECOMMENDED CONDITIONS OF APPROVAL

This project is subject to the proponent or property owner agreeing to comply with the following conditions as written, or as may be amended by the Planning Commission.

- 1. All standard conditions of approval will be recorded with the Design Review and are available in the Community Development Department.
- 2. The tower shall be no taller than 70'.
- 3. The fencing enclosing the equipment shall be a solid material fence and/or landscaping so that all equipment is completely screened.
- 4. The Planning Commission uses their discretionary authority in LDC 17.43 to allow the antennas placed in a horizontal array pattern as proposed to allow for co-location ability on the tower facility for additional carriers rather than the slim vertical pattern which would prohibit future co-location.
- 5. Approval for the proposed cell tower must be issued by the FAA and provided to the Community Development Department prior to issuance of a building permit.

RECOMMENDED FINDINGS FOR APPROVAL FOR THE CONDITIONAL USE PERMIT

The Planning Commission bases its decisions on the following findings supported in the administrative record for this project:

- 1. The proposed project is compatible with surrounding land uses and will not interfere with the use and enjoyment of adjacent properties as 70' is a consistent and compatible tower height within the surrounding neighborhood.
- 2. The Conditional Use Permit conforms to the requirements of Title 17 of the Logan Municipal Code.
- 3. The project meets the goals and objectives of the Industrial Park designation within the Logan General Plan by providing reliable and quality public service options.
- 4. The project met the minimum public noticing requirements of the Land Development Code and the Municipal Code.

This staff report is an analysis of the application based on adopted city documents, standard city development practices, and available information. The report is to be used to review and consider the merits of the application prior to and during the course of the Planning Commission meeting. Additional information may be revealed by participants at the Planning Commission meeting which may modify the staff report and become the Certificate of Decision, The Director of Community Development reserves the right to supplement the material in the report with additional information at the Planning Commission meeting.



APPLICATION FOR PROJECT REVIEW

☐ Planning Commission	□ Land Use	Appeal Board	□ Administrative	Review
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Date Received Received By Receipt Number Zone Application Number								
Date Received	Received By	Applic	00 19-016					
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✓ Design Review □ Code Amendment	✓ Conditional Use ☐ Appeal	Type of Application (C ⊕ Subdivision □ Variance	heck all that apply): Zone Chai 4950' Des	-	□ Administrative Design Review □ Other			
PROJECT NAME								
UT1 Larry PROJECT ADDRESS 7	UU West Loga	n UT 84321			07 -176 - 0020			
1750 North 8 AUTHORIZED AGENT FOR P	ROPERTY OWNER (Must	be accurate and comp	lete)		MAIN PHONE #			
Troy Benson MAILING ADDRESS		CITY		STATE	(801) 608-7042 ZIP			
7896 South High		e 200 Cotton	nwood Heights	UT	84121			
PROPERTY OWNER OF REC	ORD (Must be listed)				MAIN PHONE #			
Gunto Logan,		CITY	STATE	ZIP	(801) 224-4771			
1750 North 800 EMAIL ADDRESS Khodge, @ rockie		Logun	UT	84321				
DESCRIBE THE PROPOSED F	PROJECT AS IT SHOULD	BE PRESENTED /Se	parate sheet		Total Lot Size (acres)			
(Include as much detail as po	ssible - attach a separate	sheet if needed)	ittached v	A .				
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I certify that the information con			Signature of P	roperty Owne	r's Authorized Agent			
supporting plans are correct an am authorized to sign all further	-		T	. /				
on behalf of the property owner.		ints	cli	all				
I certify that I am the property o		• • • • • • • • • • • • • • • • • • •	Signature of P	roperty Owne	<u>-</u>			
property and that I consent to the I understand that all further loga			KIL	1.1				
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City of Logan—Community Development RE: UT1 Larry (Verizon Site Name) 290 North 100 West Logan, UT 84321 04/01/2019

Verizon Wireless Communication Facility

Project Description: Verizon Wireless is proposing to construct a new communication facility at approximately 1750 North 800 West. The communication facility would include a 70' tall tower, a single equipment cabinet (2 planned for future use) and a backup diesel generator, within a 20' x 38' lease area. The equipment would be surrounded by a 6' tall chain-link fence with barbed wire and gray privacy slats. Antennas would be placed on an array, not projecting outward more than 8' from the tower. (12) 8' tall antennas (4) per sector would be attached to the array and a 6' tall lighting rod would be attached to the top of the tower.

The necessity for the site at this location, is to provide better coverage to the area and to offload some of the traffic that is overloading Verizon's existing site at 1000 North Main Street.

The subject location is zoned Industrial Park (IP) and all of the adjoining parcels are also IP. Per code, monopoles are allowed, with a CUP, in an IP zone with a 70' maximum height. The proposed tower height is 70'. Code also states that the antennas shall not extend more than one foot beyond the side of the tower or pole. For this site, Verizon is requesting that a full array be allowed, meaning there will be (12) antennas at the top of the tower (at one level) and they will extend by about 8' from the pole. Allowing a fully array serves several purposes:

- Allows more technology to be pushed thru the antennas
- Site operates more efficiently, for example, it can handle more traffic
- It would allow (2) other carriers to co-locate on the tower. If the antennas have to hug the pole, then Verizon will have to take up at least (3) levels on the tower, which would take up about 30' of tower space, which eliminates the possibility for other carriers to co-locate on the tower.

A full array also fits into the appearance of the Industrial Park zone.

This location meets the required setback from the nearest right-of-way line. The setback for the tower is 2:1 of the height of the tower, which amounts to 140'. The nearest right-of-way line borders 730 West and the tower would be setback 140' from the right-of-way line. Code also requires a setback if the site is adjacent to or within a residential zone. There are not any residentially zoned properties in the area.

Code encourages co-locating on existing cell towers. The nearest cell tower is approximately .79 miles from the proposed site location and it is a Verizon site. Adding additional equipment to the existing Verizon site would not help Verizon with their coverage objective for the new site. There is another existing cell tower approximately .89 miles from the proposed site location, but there is not any available ground space near the site that Verizon could use for their equipment that supports the antennas.

Should any more information be required, I can be reached at (801) 608-7042.

Regards,

Troy Benson

Technology Associates EC INC.

Real Estate Specialist | <u>troy.benson@taec.net</u> | (801) 608-7042 7896 South Highland Drive, Suite 200 | Cottonwood Heights | Utah 84121

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Verizon Verizon UT1 - LARRY

SITE INFORMATION

APPLICANT: VERIZON WIRELESS 9656 SOUTH PROSPERITY ROAD WEST JORDAN, UTAH 84088

SITE ADDRESS: 1750 NORTH 850 WEST LOGAN, UTAH 84321

LATITUDE AND LONGITUDE: N 41'45'48.67", W 111'51'09.83"

ZONING JURISDICTION:

LOGAN CITY

PROJECT DESCRIPTION:

VZW IS PROPOSING TO CONSTRUCT AN UNMANNED COMMUNICATIONS FACILITY CONSISTING OF ANTENNAS MOUNTED TO A NEW MONOPOLE WITH OUTDOOR EQUIPMENT AND GENERATOR


TYPE OF CONSTRUCTION:

OUTDOOR EQUIPMENT AND GENERATOR, MONOPOLE, AND ANTENNAS

HANDICAP REQUIREMENTS:

Facility is unmanned and not for human Habitation, Handicap access requirements $\underline{\text{DO}}$. Not apply

POWER COMPANY: LOGAN CITY POWER

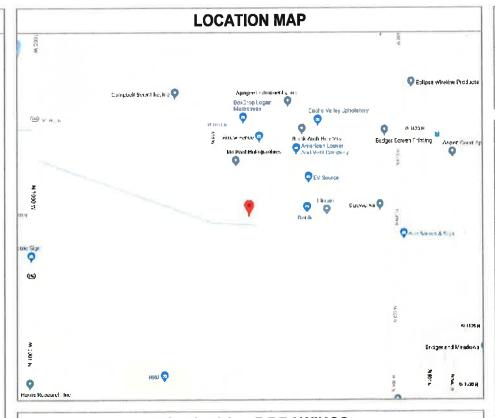

DO NOT SCALE DRAWINGS

CONTRACTOR SHALL VERIFY ALL PLANS, AND EXISTING DIMENSIONS, AND CONDITIONS ON THE JOB SITE, AND SHALL MANEDIATELY NOTIFY THE ENGINEER IN WRITING OF ANY DISCREPANCIES BEFORE PROCEEDING WITH THE WORK OR BE RESPONSIBLE FOR SAME

CONTACT INFORMATION

SITE ACQUISITION: TECHNOLOGY ASSOCIATES EC, INC 7896 SOUTH HIGHLAND DRIVE, SUITE 200 COTTONWOOD HEIGHTS, UTAH 84121 CONTACT: TROY BENSON

DRIVING DIRECTIONS

FROM THE VZW WEST JORDAN OFFICES, TAKE I-15 NORTH TO BRIGHAM CITY EXIT \$362 FOR HWY 91 TOWARDS LOGAN. GO EAST THEN NORTH FOR 28 MILES INTO AND THROUGH LOGAN TO 1800 NORTH. TURN LEFT AND GO WEST FOR 0.92 MILES TO 730 WEST. TURN LEFT AND GO SOUTH FOR 0.12 MILES TO THE END OF THE ROAD AT THE CULL-DE-SAC. THE VZW SITE WILL BE LOCATED ON THE RIGHT (WEST) SIDE OF THE ROAD ALONG THE SOUTH PROPERTY LINES.

APPROVALS

VERIZON WIRELESS REPRESENTATIVE:
VERIZON WIRELESS RF ENGINEER:
TAEC SITE ACQUISITION:
TAEC CONSTRUCTION MANAGER:
SITE OWNER:

DRAWING INDEX

SHEET NO.	SHEET TITLE	R E V	REV
T100	TITLE SHEET, VICINITY MAP, GENERAL SITE INFORMATION	0	
SURV	SITE SURVEY	0	
C100	OVERALL SITE PLAN	0	
C101	ENLARGED SITE PLAN	0	
C200	SITE ELEVATIONS	0	



UNDERGROUND SERVICE ALERT, CALL 'BLUE STAKES OF UTAH' @ 811 OR 1-800-662-4111

THREE WORKING DAYS BEFORE YOU DIG





WEST JORDAN, UTAH 84088



UTAH MARKET OFFICE 7896 SOUTH HIGHLAND DRIVE, SUITE 200 COTTONWOOD HEIGHTS, UTAH 84121

CORPORATE OFFICE
3115 SOUTH MELROSE DRIVE, SUITE #110
CARLSBAD, CALIFORNIA 92010

DRAWN BY:	JAY C
CHECKED BY:	TROY B



UT1 - LARRY SW SEC 21, T12N, R1E 1750 NORTH 800 WEST LOGAN, UTAH 84321 -- RAWLAND SITE --

SHEET TITLE
TITLE SHEET
VICINITY MAP
GENERAL INFORMATION

SHEET NUMBER

T100

ASAC INFORMATION SHEET 91:003

INFORMATION REGARDING SURVEY DATA SUBMITTED TO THE FAA

FAA Order 8260.19c requires proponents of certain proposed construction (located beneath instrument procedures) provide the FAA with a site survey and/or letter, from a licensed land surveyor, which certifies the site coordinates and the surface elevation at the site. On October 15, 1992, the FAA started using the North American Datum of 1983 (NAD-83), and therefore all site coordinates should be based on NAD-83. The FAA requires that the survey letter contain an accuracy statement that meets accuracy tolerances required by the FAA. The most requested tolerances are +/- 50 feet in the horizontal statement that meets accuracy tolerances required by the FAA. The most requested tolerances are +/- 50 feet in the horizontal and +/- 20 feet in the vertical (2-C). When the site coordinates and/or site elevation can be certified to a greater accuracy than requested by the FAA, please do so.

the survey. In order to avoid FAA processing delays, the original site survey or certifying letter should be attached to the 7460 when it is filed at the FAA's regional office. It must be signed and sealed by the licensed land surveyor having performed or supervised

The FAA accuracy codes and a sample accuracy statement are listed below

ACCURACY CODES:

9	8	7	6	5	4	ယ	2	-	Code	ΙΉ
Unknown	+/ - 1 NM	+/- 1/2 NM	+/ - 1000 ft	+/- 500 ft	+/- 250 ft	+/ - 100 ft	+/- 50 ft	+/- 15 ft		HORIZONTAL
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Unknown	+/ - 1000 ft	+/- 500 ft	+/- 250 ft	+/- 125 ft	+/- 50 ft	+/- 20 ft	+/- 10 ft	+/ - 3 ft	Tolerance	RTICAL

Date: MARCH 15, 2019

Re: UT1 - LARRY


SW 1/4 OF SECTION 21, TOWNSHIP 12 NORTH, RANGE 1 EAST, SALT LAKE MERIDIAN

I certify that the latitude of N 41°45′48.67″, and the longitude of W 111°51′09.83″, are accurate to within 15 feet horizontally and the site elevation of 4460 feet, AMSL (American Mean Sea Level), is accurate to within +/- 3 feet vertically. The horizontal datum (coordinates) are in terms of the North American Datum of 1983 (NAD-83) and are expressed as degrees, minutes and seconds, to the nearest (tenth/hundredth) of a second. The vertical datum (heights) are in terms of the (NAVD88) and are determined to the nearest foot.



Professional Licensed Land Surveyor: 1-A FAA Letter

Jerry Fletcher, Utah LS no. 6436064

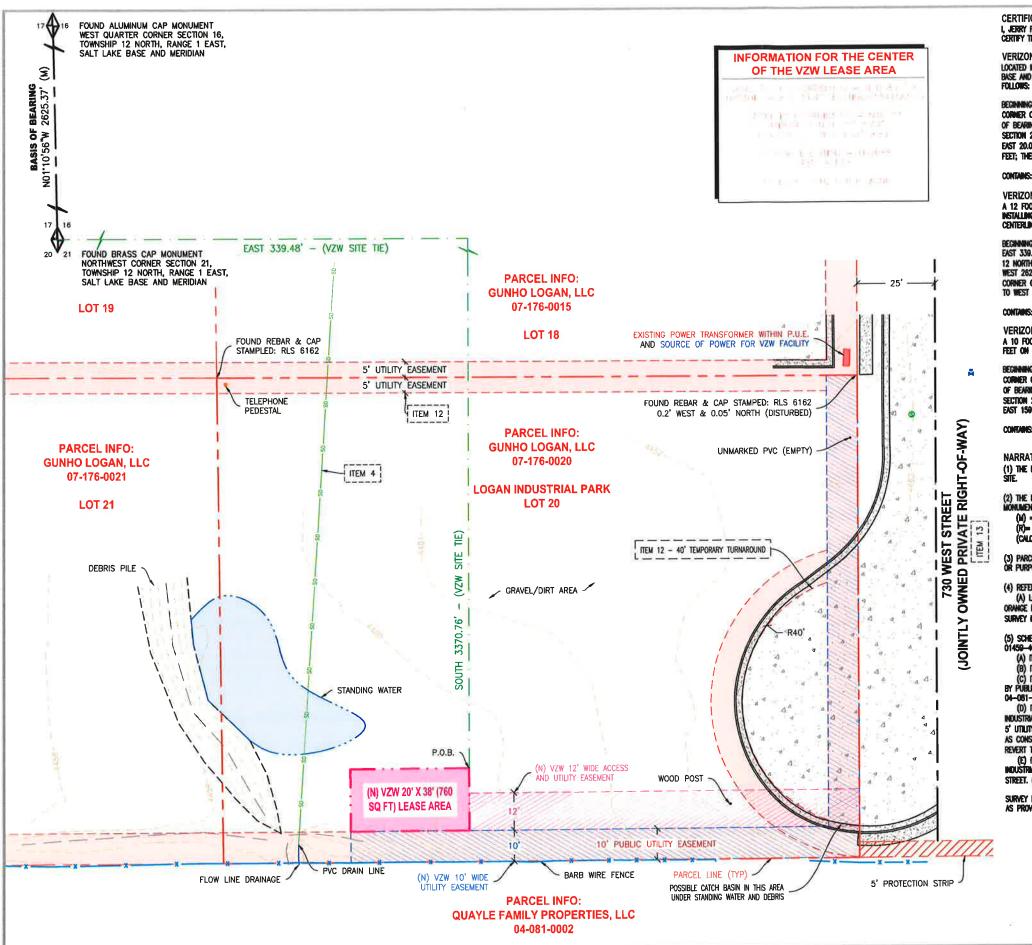

SITE SURVEY

CERTIFICATE OF SURVEY:

I, Jerry Fleicher, Professional Land Surveyor, State of Utah, License Number 6436064, Certify That I have supervised a survey on the ground as shown hereon:

VERIZON WIRELESS LEASE SITE DESCRIPTION:

LOCATED IN THE SOUTHMEST QUARTER OF SECTION 21, TOWNSHIP 12 NORTH, RANGE 1 EAST, SALT LAKE BASE AND MERIDIAN, CACHE COUNTY, STATE OF UTAH, AND BEING MORE PARTICULARLY DESCRIBED AS

BECRINING AT A POINT LOCATED EAST 339.48 FEET AND SOUTH 3370.76 FEET FROM THE NORTHWEST CORNER OF SECTION 21, TOWNSHIP 12 NORTH, RANGE 1 EAST, SALT LAKE BASE AND MERIDIAN, (BASIS OF BEARING BEING NORTH 01"10"56" WEST 2625.37 FEET BETWEEN THE NORTHWEST CORNER OF SAID SECTION 21, AND THE WEST QUARTER CORNER OF SECTION 16) AND RUMBING THENCE SOUTH 00'19'05" EAST 20.00 FEET; THENCE SOUTH 89'40'55" WEST 38.00 FEET; THENCE NORTH 00'19'05" WEST 20.00 FEET; THENCE NORTH 89'40'55" EAST 38.00 FEET TO THE POINT OF BEGINNING.

CONTAINS: 760 SQ. FT. OR 0.017 ACRES, MORE OR LESS, (AS DESCRIBED)

VERIZON WIRELESS ACCESS AND UTILITY EASEMENT DESCRIPTION: A 12 FOOT WIDE ACCESS AND UTILITY EASEMENT FOR THE PURPOSE OF INCRESS AND EGRESS, AND INSTALLING UNDERGROUND UTILITIES, BEING 6 FEET ON EACH SIDE OF THE FOLLOWING DESCRIBED

BEGINNING AT A POINT ON THE EAST LINE OF THE VERIZON WIRELESS LEASE AREA, SAID POINT BEING EAST 339.55 FEET AND SOUTH 3384.76 FEET FROM THE NORTHWEST CORNER OF SECTION 21, TOWNSHIP 12 NORTH, RANGE 1 EAST, SALT LAKE BASE AND MERIDIAN, (BASIS OF BEARING BEING NORTH 01'10'56" WEST 2625.37 FEET BETWEEN THE NORTHWEST CORNER OF SAID SECTION 21, AND THE WEST QUARTER CORNER OF SECTION 16) AND RUNNING THENCE HORTH 89'40'55" EAST 126.06 FEET, MORE OR LESS, TO WEST RIGHT-OF-WAY LINE OF 730 WEST STREET AND TERMINATING.

CONTAINS: 0.035 ACRES, MORE OR LESS, (AS DESCRIBED).

VERIZON WIRELESS UTILITY EASEMENT DESCRIPTION:

A 10 FOOT WIDE UTILITY EASEMENT FOR THE PURPOSE OF INSTALLING UNDERGROUND UTILITIES, BEING 5 FEET ON EACH SIDE OF THE FOLLOWING DESCRIBED CENTERLINE:

BECOMMONG AT A POWE LOCATED EAST 301.82 FEET AND SOUTH 3395.97 FEET FROM THE NORTHWEST CORNER OF SECTION 21, TOWNSHIP 12 NORTH, RANGE 1 EAST, SALT LAKE BASE AND MERIDAAN, (BASIS OF BEARING BEING MORTH 01"10"56" WEST 2825,37 FEET BETWEEN THE MORTHWEST CORNER OF SAID SECTION 21, AND THE WEST QUARTER CORNER OF SECTION 16) AND RUMMING THENCE MORTH 89"40"55" EAST 159.00 FEET THENCE NORTH 149.91 FEET AND TERMINATING.

CONTAINS: 0.071 ACRES, MORE OR LESS, (AS DESCRIBED).

(1) THE PURPOSE OF THIS SURVEY IS TO LOCATE AND SURVEY A PROPOSED COMMUNICATIONS TOWER

(2) THE BASIS OF BEARING USED FOR THIS SURVEY IS AS SHOWN ON THIS PLAT, FROM FOUND MONUMENTS AS LOCATED IN THE FIELD.

(M) = MEASURED BEARING OR DISTANCE. (R)= RECORDED BEARING OR DISTANCE. (CALC)= CALCULATED BEARING OR DISTANCE.

(3) PARCEL LINES ARE SHOWN AS REFERENCE PER RECORD INFORMATION AND DOES NOT CONSTITUTE OR PURPORT TO BE A BOUNDARY SURVEY.

(4) REFERENCE PLATS:

(A) LOGAN INDUSTRIAL PARK, RECORDED IN ENTRY NO. 484771, ON NOVEMBER 28, 1983. (FOUND ORANGE REBIR AND CAPS STAMPED: 6162 (WAYNE CROW) AT SEVERAL LOT CORNERS, RECORD OF

(5) SCHEDULE B NOTES PER STEWART TITLE INSURANCE AGENCY OF UTAH, INC. COMMITMENT NO. 01459-40497, DATED DECEMBER 26, 2018:

(A) ITEM 1,3,4,5,6,10,11,14, & 15 - ARE BLANKET EXCEPTIONS NOT SHOWN ON THIS PLAT. (B) ITEM 2.7,8,9,16, & 17 - ARE NOT SURVEY MATTERS AND ARE NOT SHOWN ON THIS PLAT. (C) ITEM 4 — EASEMENTS, LIENS, OR ENCUMBRANCES, OR CLAMS THEREOF, WHICH ARE NOT SHOWN BY PUBLIC RECORDS. STORM DRAIN LINE FROM PARCEL 07—176—0015 TO PARCEL DRAINING TO PARCEL 04-081-0002 SOUTH OF SITE DOES NOT APPEAR TO HAVE A RECORDED EASEMENT.

(D) ITEM 12 - SUBJECT TO EASEMENTS, RESTRICTIONS, AND DEDICATIONS SHOWN ON LOGAN NOUSTRIAL PARK, IN ENTRY NO. 484771, 10' UTILITY EASEMENT ALONG EAST, AND SOUTH PARCEL LIMES 5' UTILITY EASEMENT ALONG NORTH LINE, 40' TEMPORARY CUL-DE-SAC DOES NOT MATCH PLAT SHOW AS CONSTRUCTED, IF/WHEN TEMPORARY CUL-DE-SAC IS REMOVED THE AREA AND EASEMENT SHOULD REVERT TO OWNER UTILITY EASEMENT SHOULD THEN BE LOCATED ALONG LOT LINE. (SHOWN ON PLAT)

(E) ITEM 13 — ACCESS TO PARCEL IS VIA PRIVATE ROAD, 730 WEST STREET AS SHOWN ON LOGAN INDUSTRIAL PARK IS JOINTLY OWNED BY SUBDIVISION LOT OWNERS HAWING ACCESS TO 1800 MORTH

SURVEY MATTERS FROM ABOVE REFERENCED TITLE REPORT HAVE BEEN REVIEWED AND SHOWN OR LISTED





WEST JORDAN, UTAH 84088



UTAH MARKET OFFICE 7896 SOUTH HIGHLAND DRIVE, SUITE 200 COTTONWOOD HEIGHTS, UTAH 84121

CORPORATE OFFICE 3115 SOUTH MELROSE DRIVE, SUITE #110 CARLSBAD, CALIFORNIA 92010



JERRY F DRAWN BY: JERRY F CHECKED BY:

03.11.2019 SITE SURVEY REV DATE DESCRIPTION




UT1 - LARRY SW SEC 21, T12N, R1E 1750 NORTH 800 WEST LOGAN, UTAH 84321 -- RAWLAND SITE --


SHEET TITLE


SITE SURVEY

SHEET NUMBER **SURV**

SCALE: 1" = 30'-0"

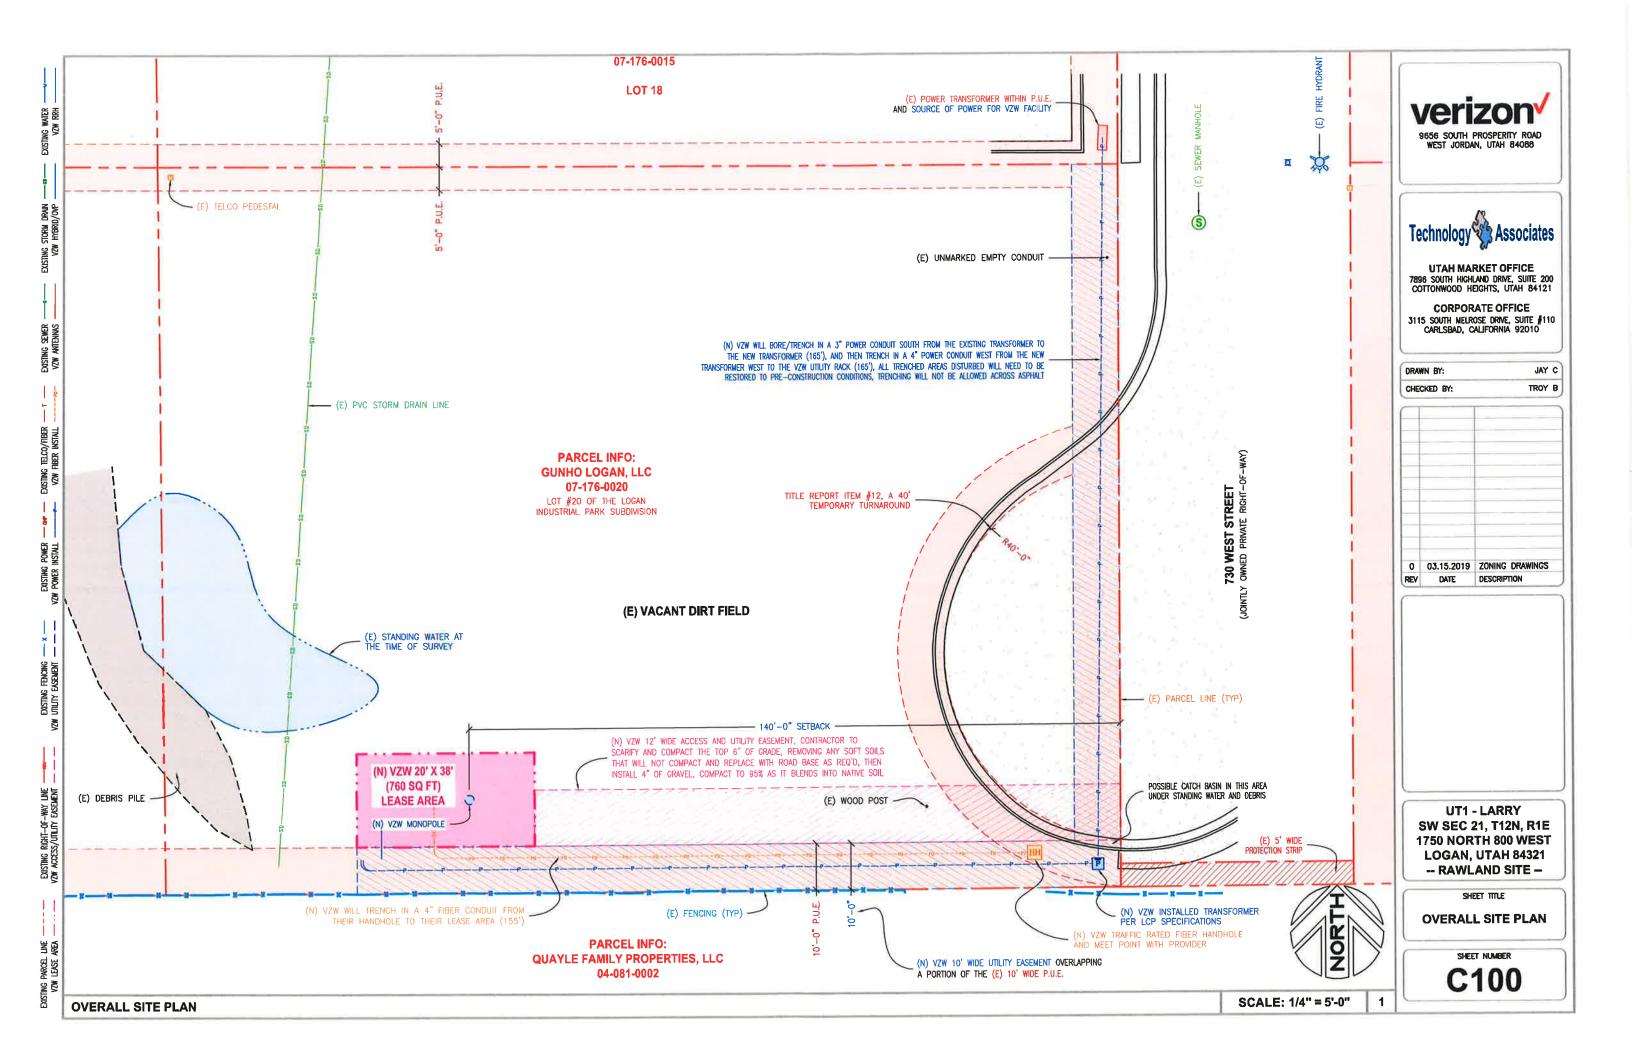

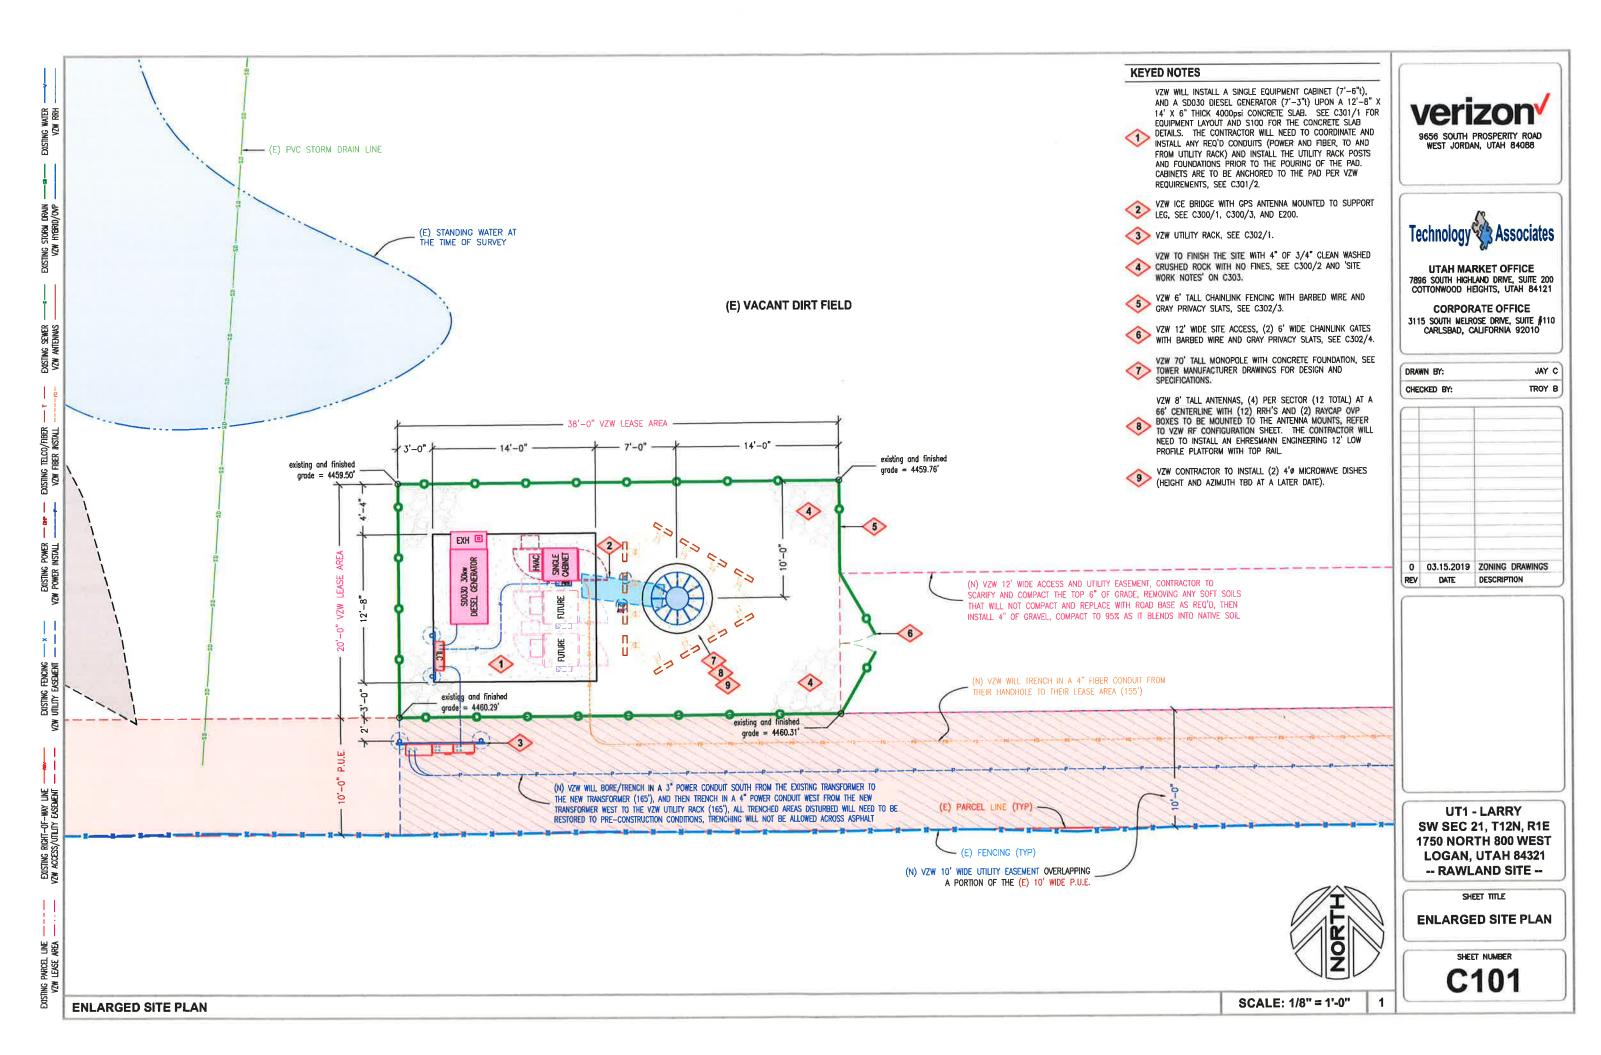

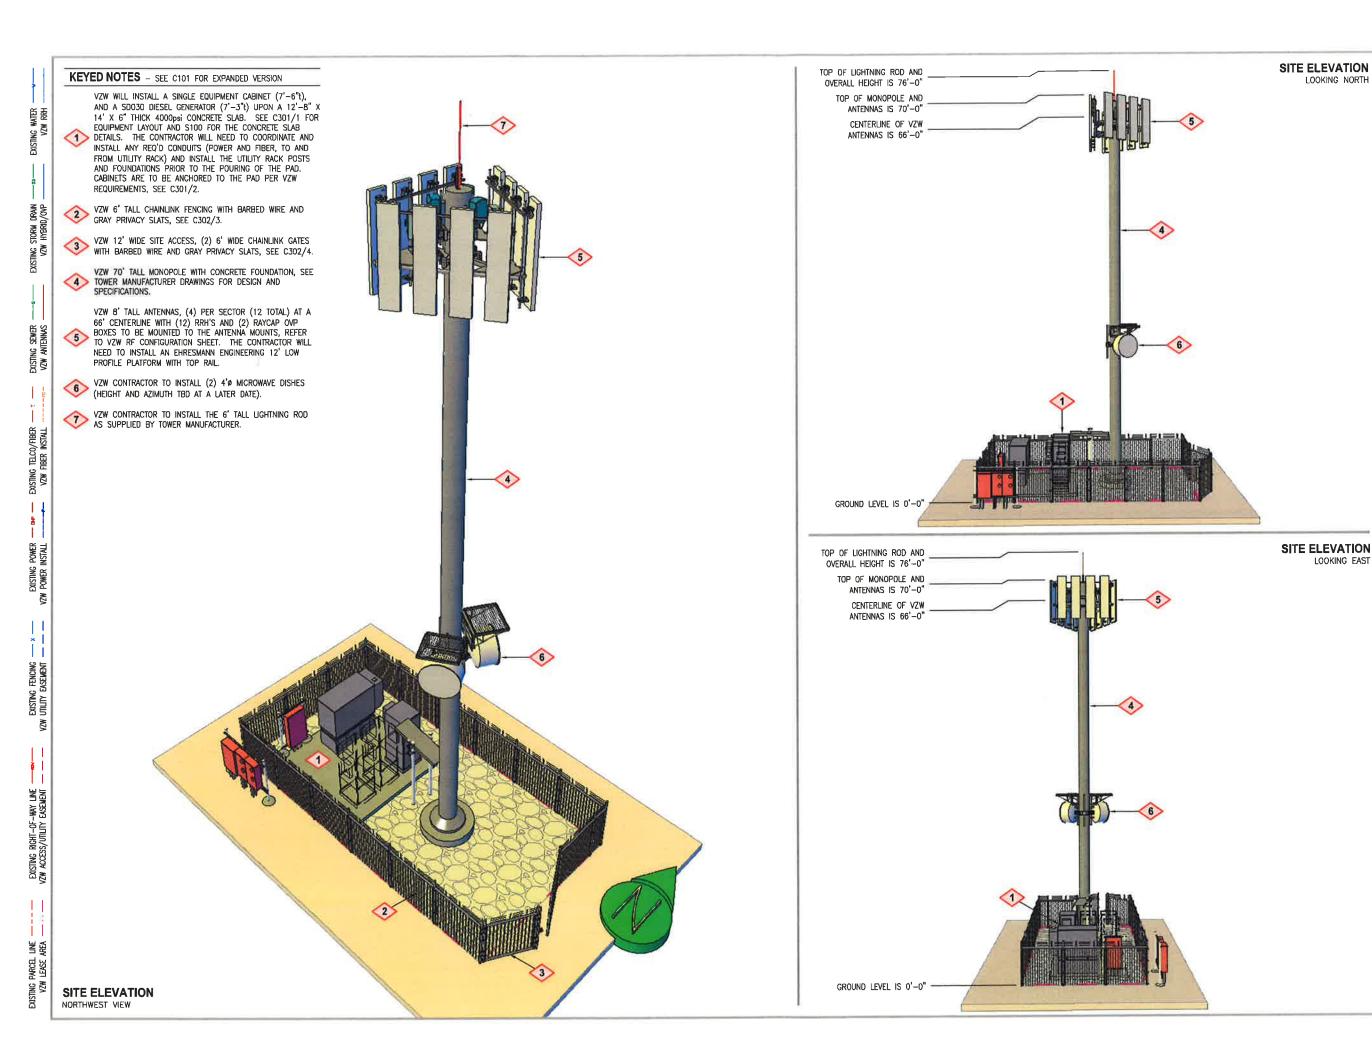



LOOKING NORTH


9656 SOUTH PROSPERITY ROAD WEST JORDAN, UTAH 84088



UTAH MARKET OFFICE 7896 SOUTH HIGHLAND DRIVE, SUITE 200 COTTONWOOD HEIGHTS, UTAH 84121

CORPORATE OFFICE 3115 SOUTH MELROSE DRIVE, SUITE #110 CARLSBAD, CALIFORNIA 92010

JAY C DRAWN BY: TROY B CHECKED BY:

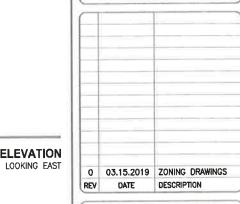

UT1 - LARRY SW SEC 21, T12N, R1E 1750 NORTH 800 WEST LOGAN, UTAH 84321 -- RAWLAND SITE --

SHEET TITLE

SITE ELEVATIONS

C200