18620 W 10 Mile, #220

JGRIFFIS@ expressivearchitecture.com

eA Project # 19.016

SITE PLAN REVIEW March 31, 2021 OWNER REVIEW March 11, 2021 OWNER REVIEW

**ISSUE / REVISION DATE** 

Architectural

**AS.101** 

SYMBOL LEGEND			
<b>Ø</b>	EXHAUST FAN, ROUTE TO EXTERIOR		
<b>₽</b> sa	SMOKE ALARM		
<b>₽</b> 80	COMBINATION SMOKE ALARM & CARBON MONOXIDE DETECTOR		


SMOKE ALARMS SHALL BE LISTED IN ACCORDANCE W/ UL 217 AND INSTALLED IN ACCORDANCE W/ THE PROVISIONS OF MRC15 AND THE HOUSEHOLD FIRE WARNING **EQUIPMENT PROVISIONS OF NFPA 72** 

SMOKE ALARMS SHALL BE INTERCONNECTED SO THAT ACTIVATION OF ONE ALARM SHALL ACTIVATE ALL OF THE ALARMS IN THE DWELLING UNIT

SMOKE ALARMS SHALL RECEIVE PRIMARY POWER FROM THE BUILDING WIRING AND BACK-UP POWER FROM A BATTERY

SINGLE STATION CARBON MONOXIDE ALARMS SHALL BE LISTED AS COMPLYING w/ UL 2034 AND SHALL BE INSTALLED IN ACCORDANCE w/ MRC15 AND MANUFACTURER'S INSTALLATION INSTRUCTIONS

- 1. ALL WORK SHALL BE COMPLETED PER 2015 MICHIGAN RESIDENTIAL CODE
- 2. ALL WOOD EXPOSED TO THE WEATHER, IN CONTACT WITH THE GROUND OR ENTERING EXTERIOR MASONRY WALLS SHALL BE PRESERVATIVE TREATED
- 3. ALL FASTENERS FOR PRESERVATIVE TREATED WOOD SHALL BE HOT-DIPPED GALVANIZED STEEL OR STAINLESS STEEL.
- 4. ALL STRUCTURAL CONNECTORS & HANGERS SHALL BE HOT-DIPPED GALVANIZED STEEL.
- 5. CONTRACTOR SHALL FIELD VERIFY ALL EXISTING CONDITIONS. IF A DISCREPANCY IS DISCOVERED, COORDINATE WITH ARCHITECT TO RESOLVE THE ISSUE TO ACHIEVE THE INTENT OF THE DRAWINGS.
- 7. COORDINATE WITH OWNER ALL ACTUAL FINISHES AND MATERIAL SAMPLES
- 8. ELECTRICAL SHALL BE DESIGN/BUILD PER LATEST NEC. COORDINATE FIXTURES, SPECIAL RECEPTACLES AND REQUIREMENTS WITH OWNER. LIGHTING SHALL BE PROVIDED BY OWNER, INSTALLED BY CONTRACTOR.
- DATA SHALL BE DESIGN/BUILD. COORDINATE SPECIAL RECEPTACLES AND REQUIREMENTS WITH OWNER.
- 10. HEATING VENTILATION AIR CONDITIONING SHALL BE DESIGN/BUILD PER LATEST CODES. COORDINATE SYSTEM TYPES AND PERFORMANCE SPECIFICATIONS WITH OWNER.
- 11. PLUMBING SHALL BE DESIGN/BUILD PER LATEST CODES. COORDINATE SYSTEM TYPES AND PERFORMANCE SPECIFICATIONS WITH OWNER.
- 12. ALL DIMENSIONS ARE TO FACE OF NEW STUDS (ROUGH FRAMING), FACE OF BRICK OR FACE OF SHEATHING, FACE OF EXISTING FINISHED WALLS TO REMAIN, CENTERLINE OF OPENINGS FOR DOORS AND WINDOWS
- 13. ALL WINDOWS WITH SILLS 24" OR LESS A.F.F. AND 6'-0" OR MORE ABOVE EXTERIOR GRADE SHALL HAVE WINDOW OPENING CONTROL DEVICES PER MRC 312.2
- 14. EXIST WINDOW SIZES SHOWN ON PLANS ARE FOR ESTIMATING PURPOSES ONLY. ALL NEW WINDOW SIZES TO BE FIELD MEASURED BY WINDOW MANUFACTURER/INSTALLER AS REQUIRED.

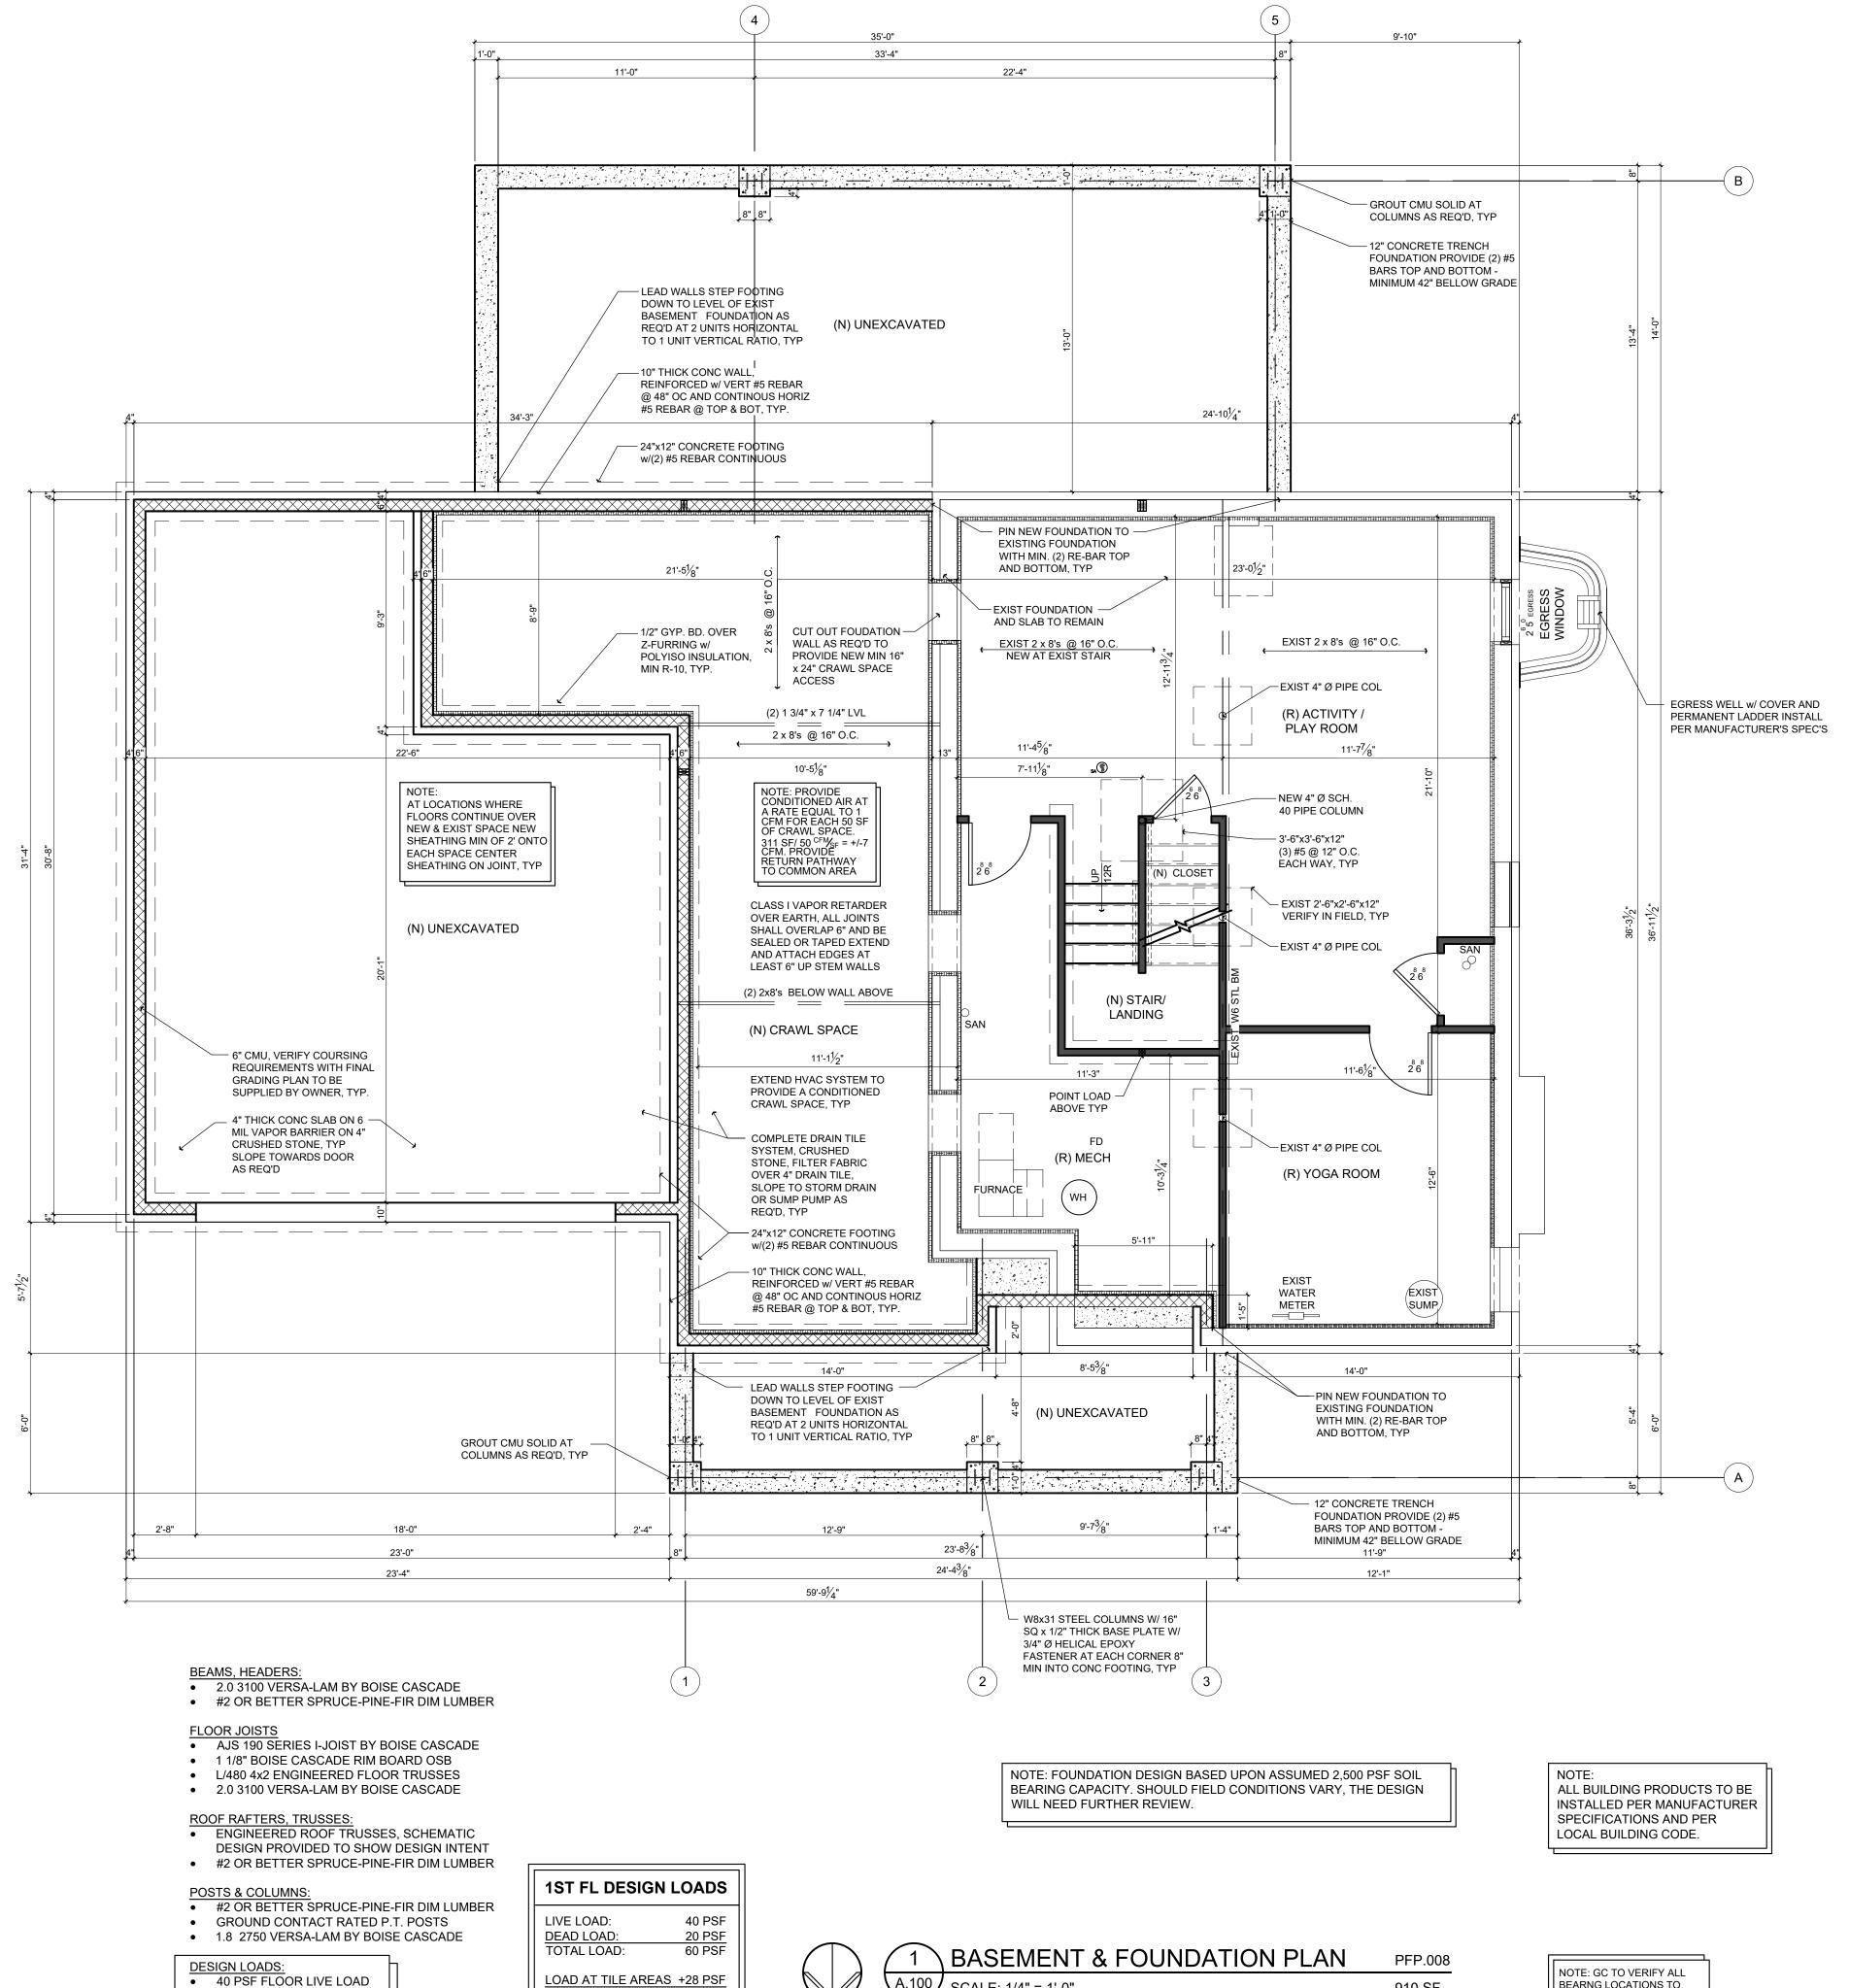

(A.100) SCALE: 1/4" = 1'-0"

LOAD AT TILE AREAS +28 PSF

TOTAL LOAD L/480: 88 PSF

ALL AREAS WITH TILE SHALL

HAVE TOTAL LOAD

DIFFLECTION MAX L/480

15 PSF FLOOR DEAD LOAD

16 PSF ROOF LIVE LOAD

15 PSF ROOF DEAD LOAD

15 PSF WALL DEAD LOAD

25 PSF SNOW LOAD

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February 24, 2021 **ISSUE / REVISION DATE** 

Basement & Foundation


**A.100** 

BEARNG LOCATIONS TO

"STACK" ON STRUCTURE

DESIGNATED (TRANSFER)

BELOW, EXCCEPT AS

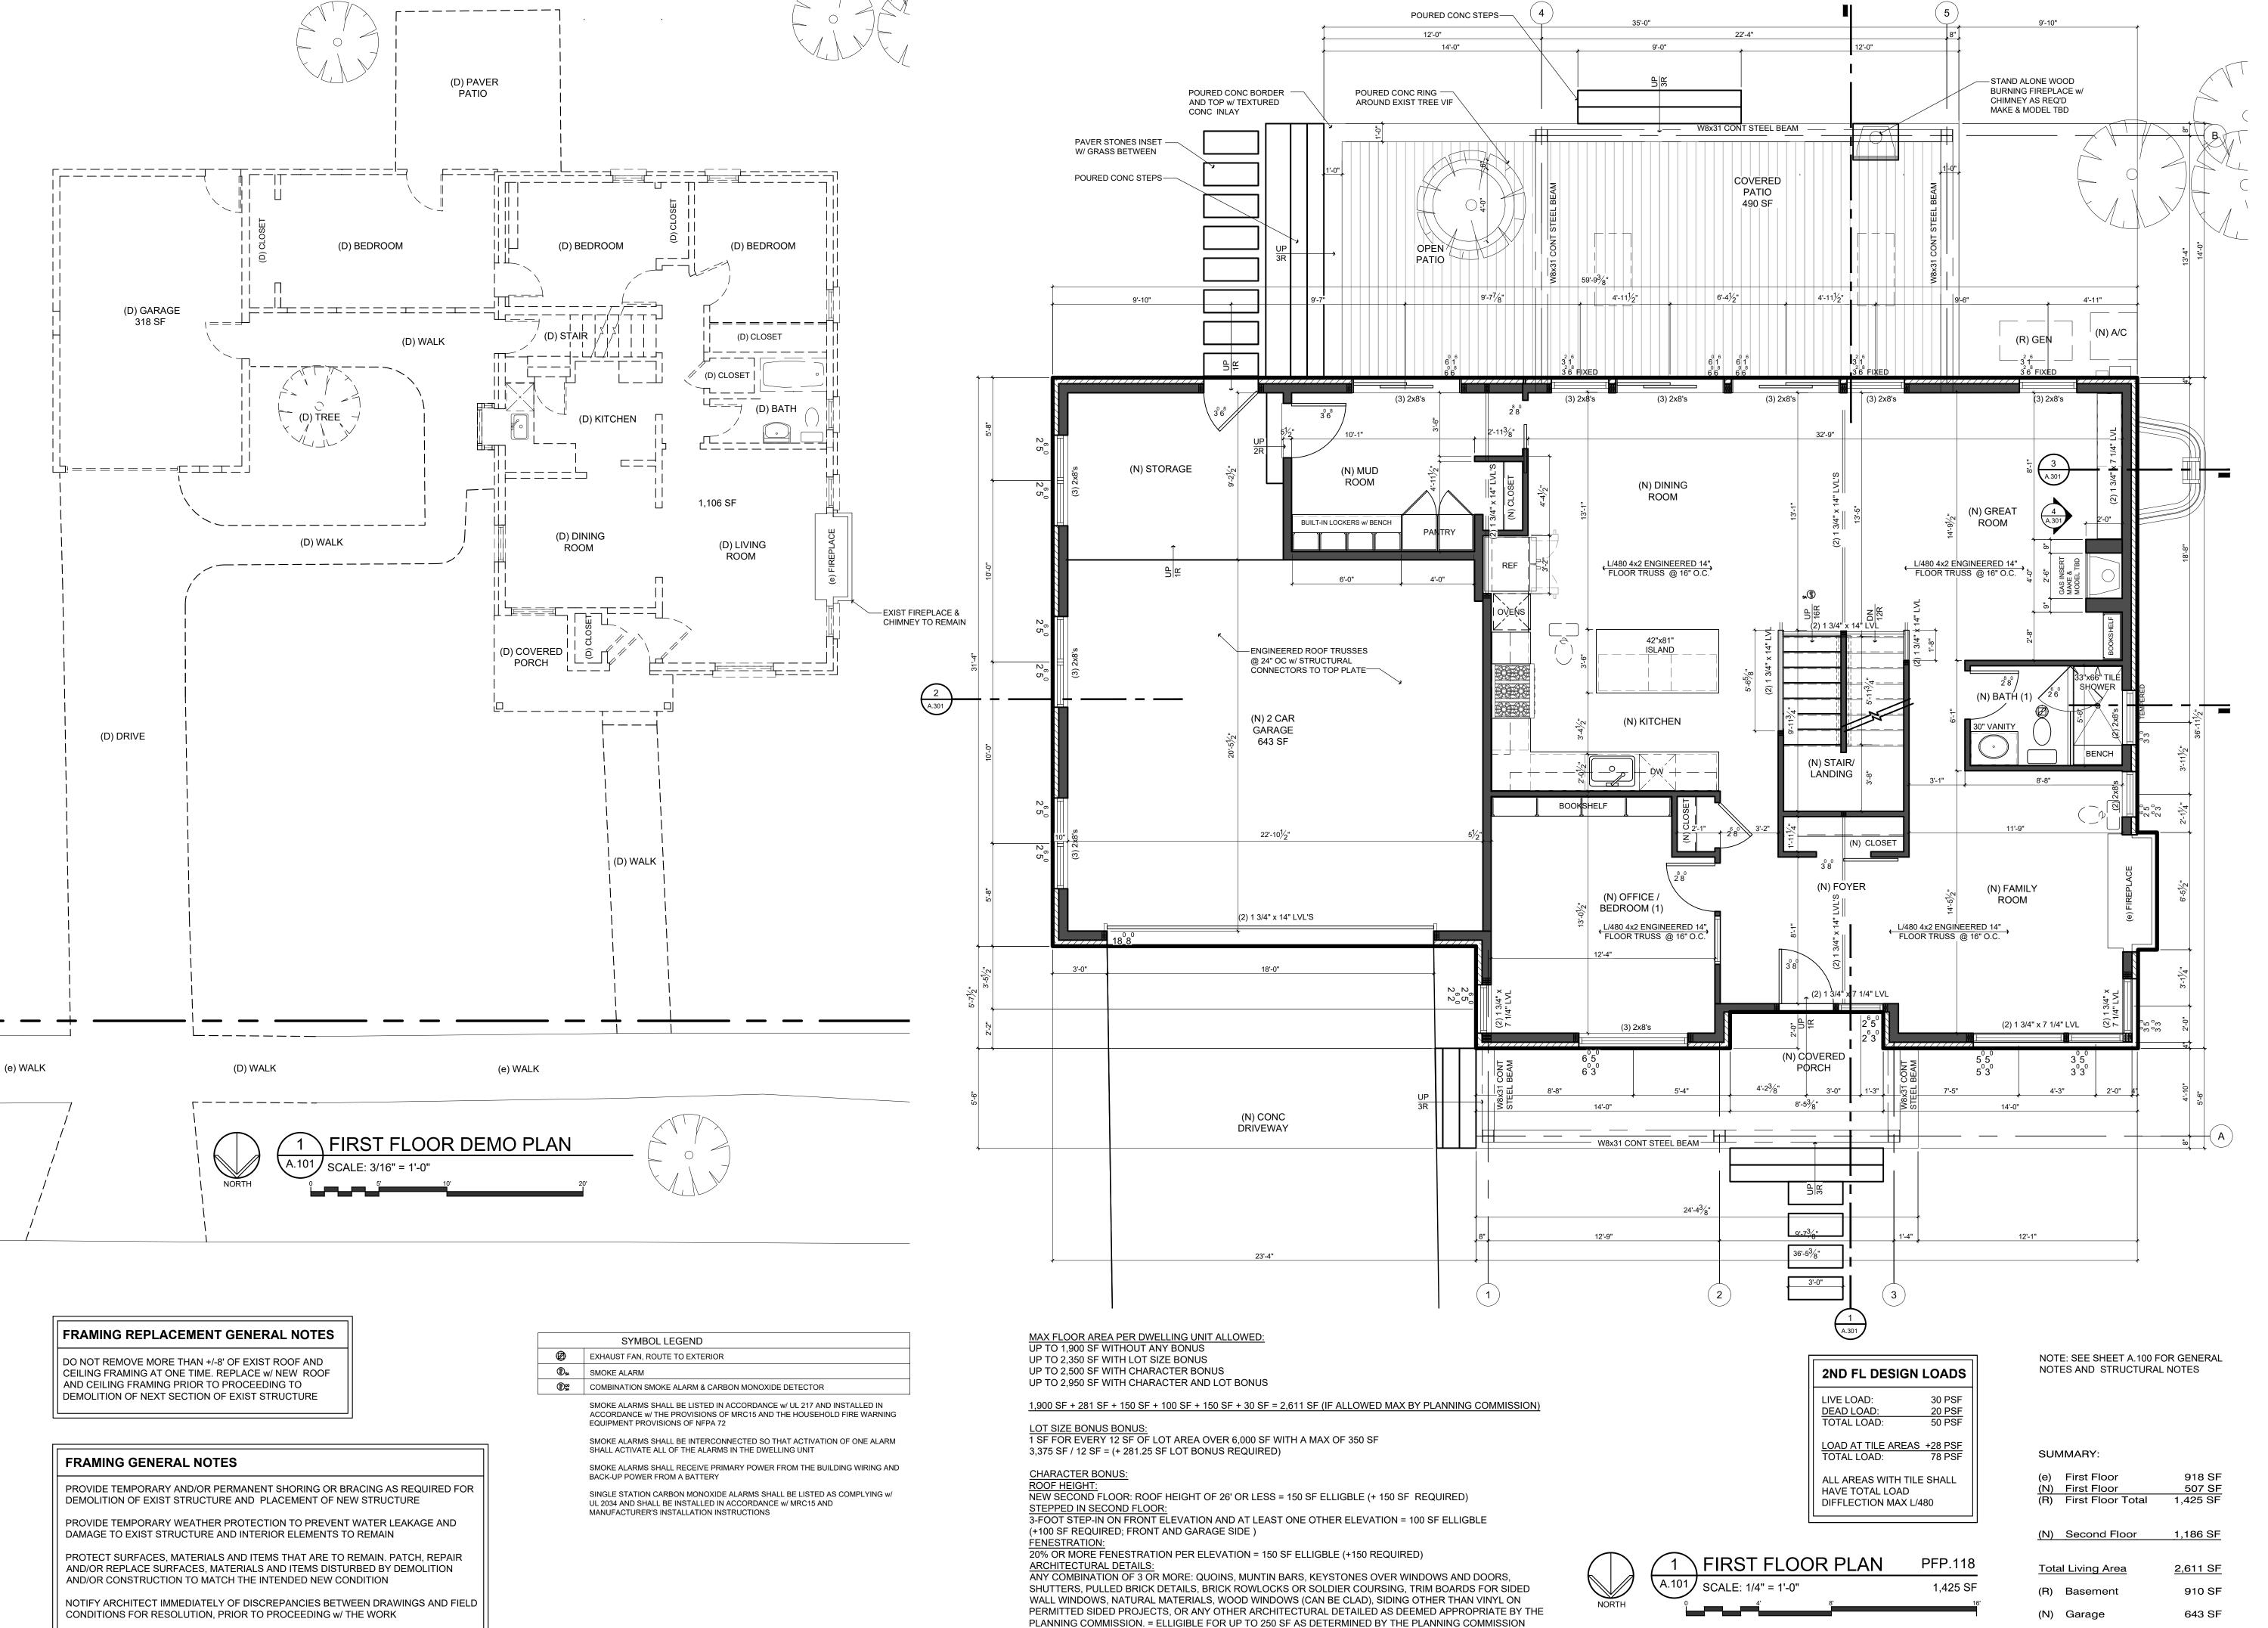

(+ 250 ALLOWED / + 30 REQUIRED)

PRESSIVE

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10825 Talbot Ave
Huntington Woods. MI

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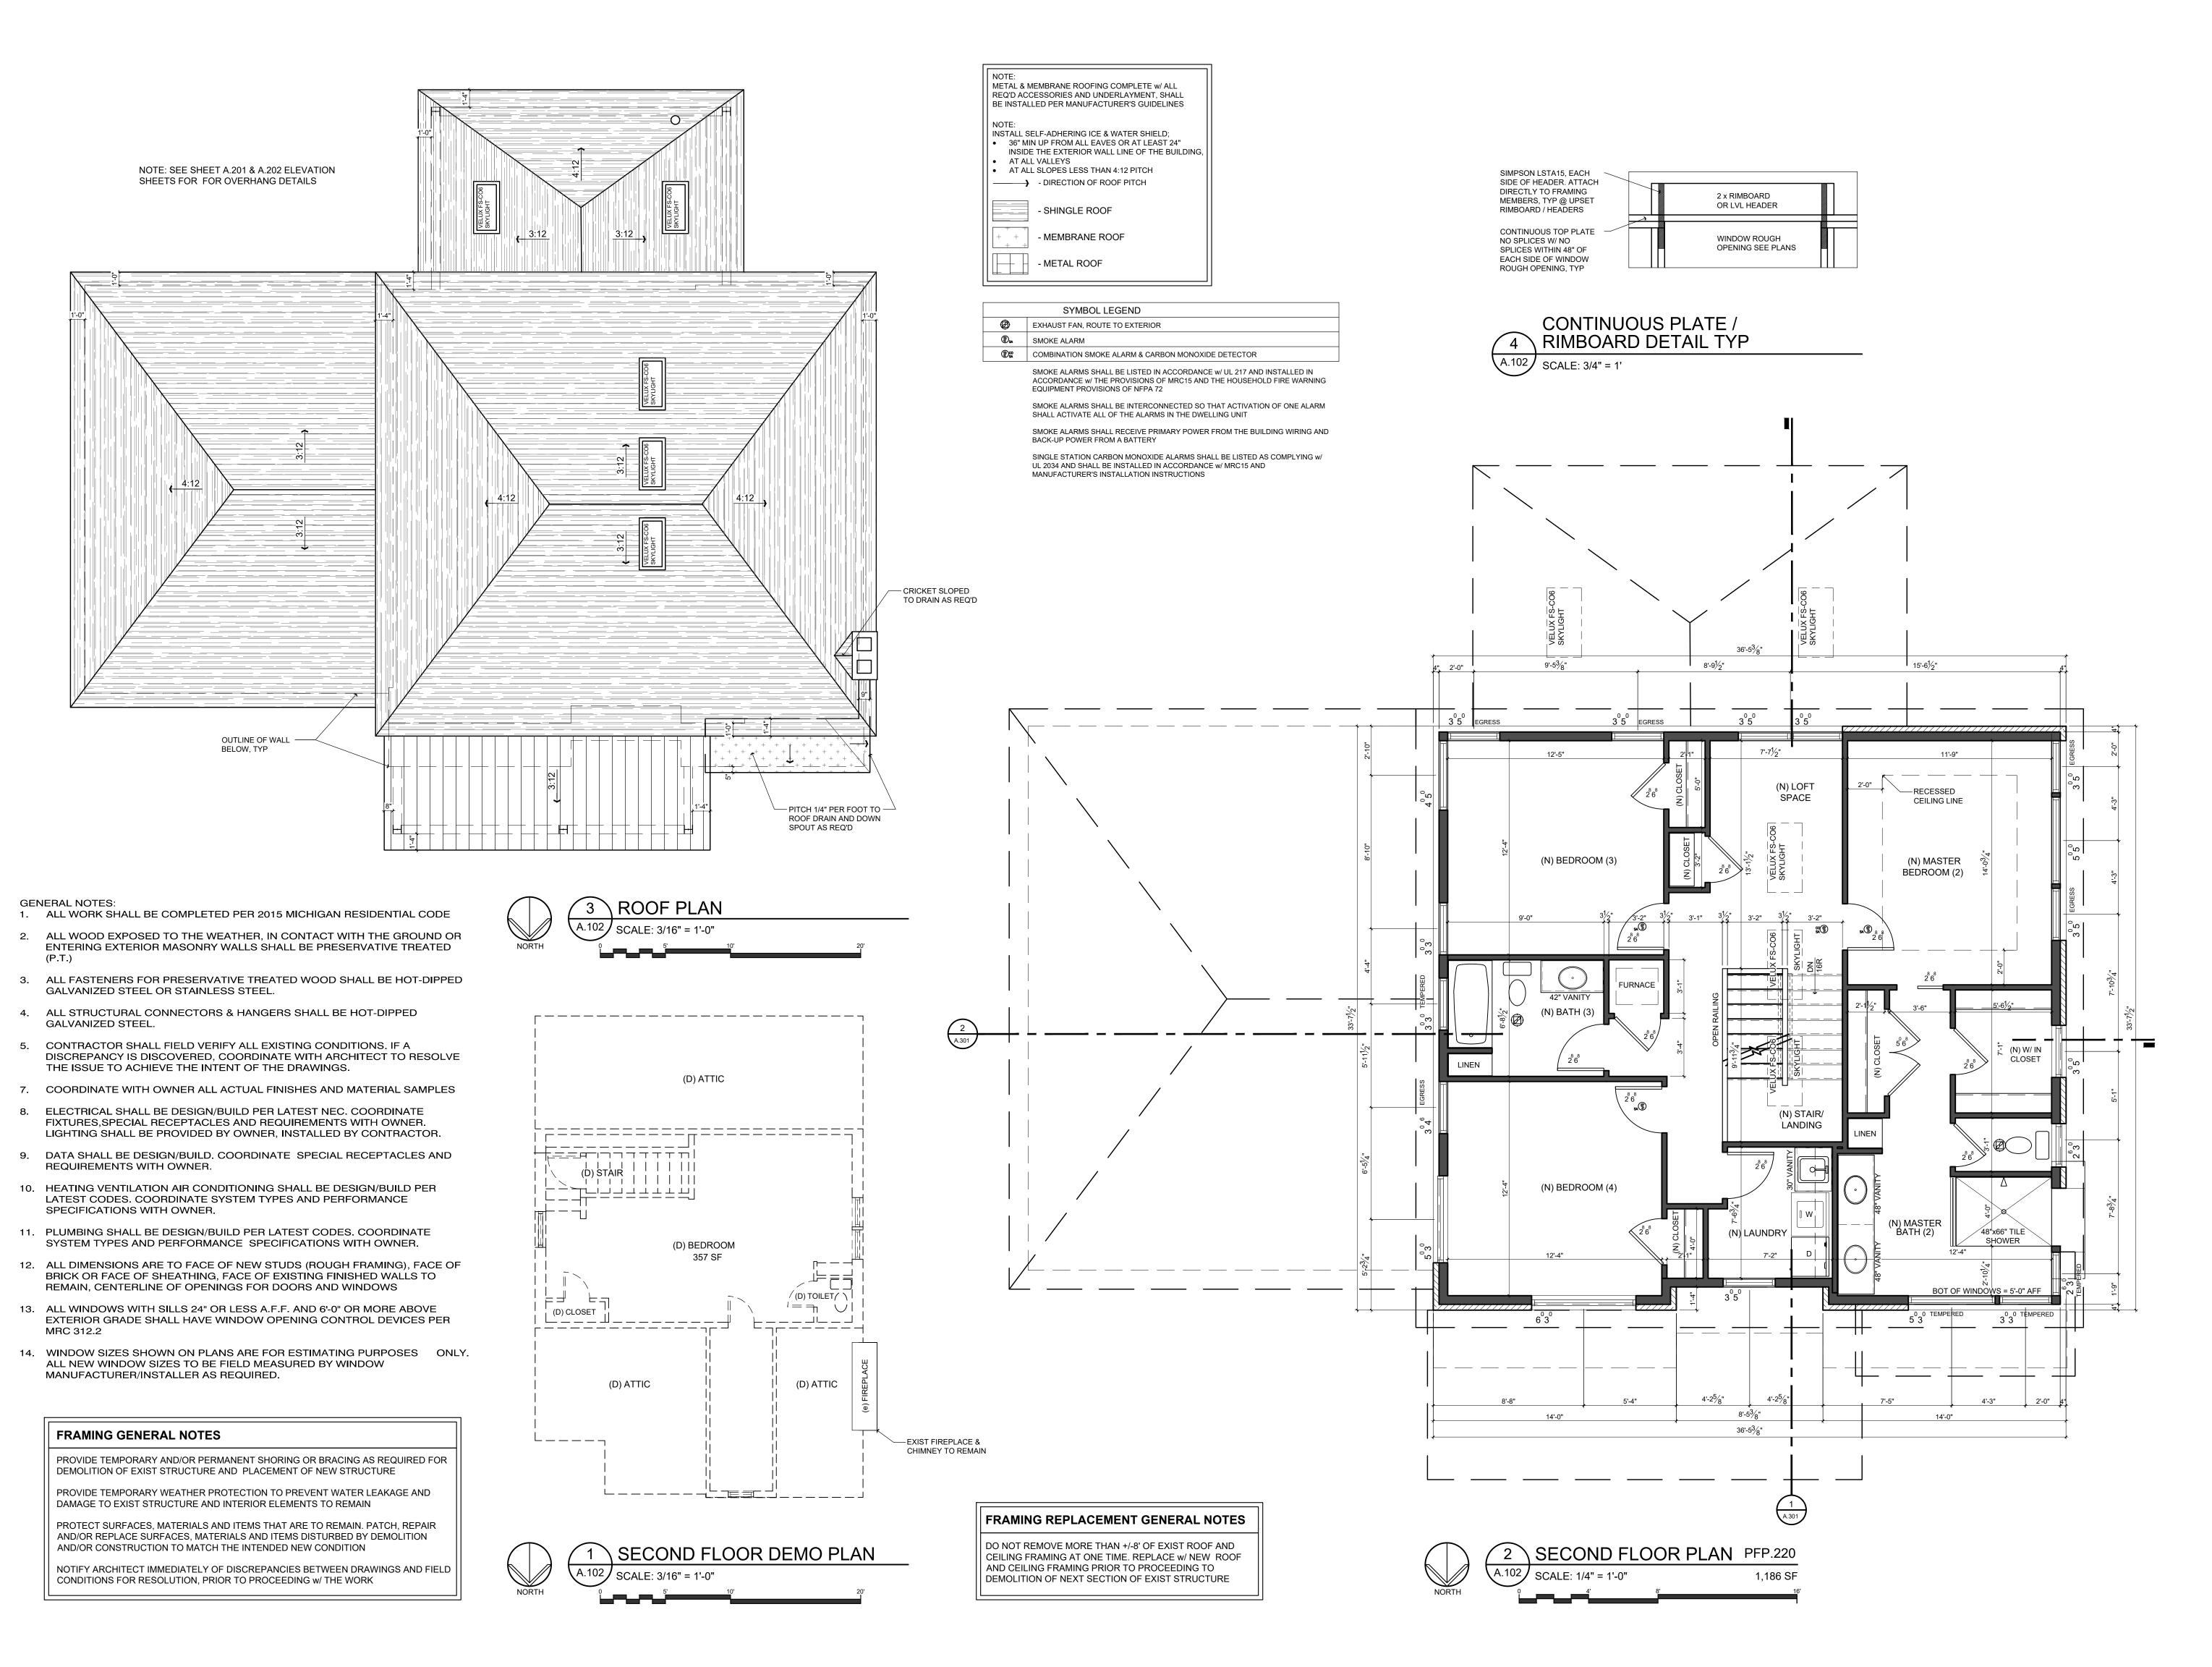
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February 24, 2021

ISSUE / REVISION DATE

E / REVISION DATE

First Floor Plan & Demolition





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Second Floor Plan & Demo



2 REAR (SOUTH) ELEVATION

SCALE: 1/4" = 1'-0"

16'

— 4" POURED CONCRETE SLOPED TO DRAIN, TYP

POURED CONCRETE —RISERS AND FOOTING

SLOPED TO DRAIN, TYP

STEEL COLUMNS AND BEAM PAINTED "BLACK", TYP - SEE

PRESSIVE

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TOP OF PLATE: 119'-9" (776.01')


Alteration of and Addition to
10825 Talbot Ave
Huntington Woods, MI

eA Project # 19.016

SITE PLAN REVIEW March 31, 2021 OWNER REVIEW March 11, 2021

OWNER REVIEW February 24, 2021 ISSUE / REVISION DATE

> Exterior Elevations

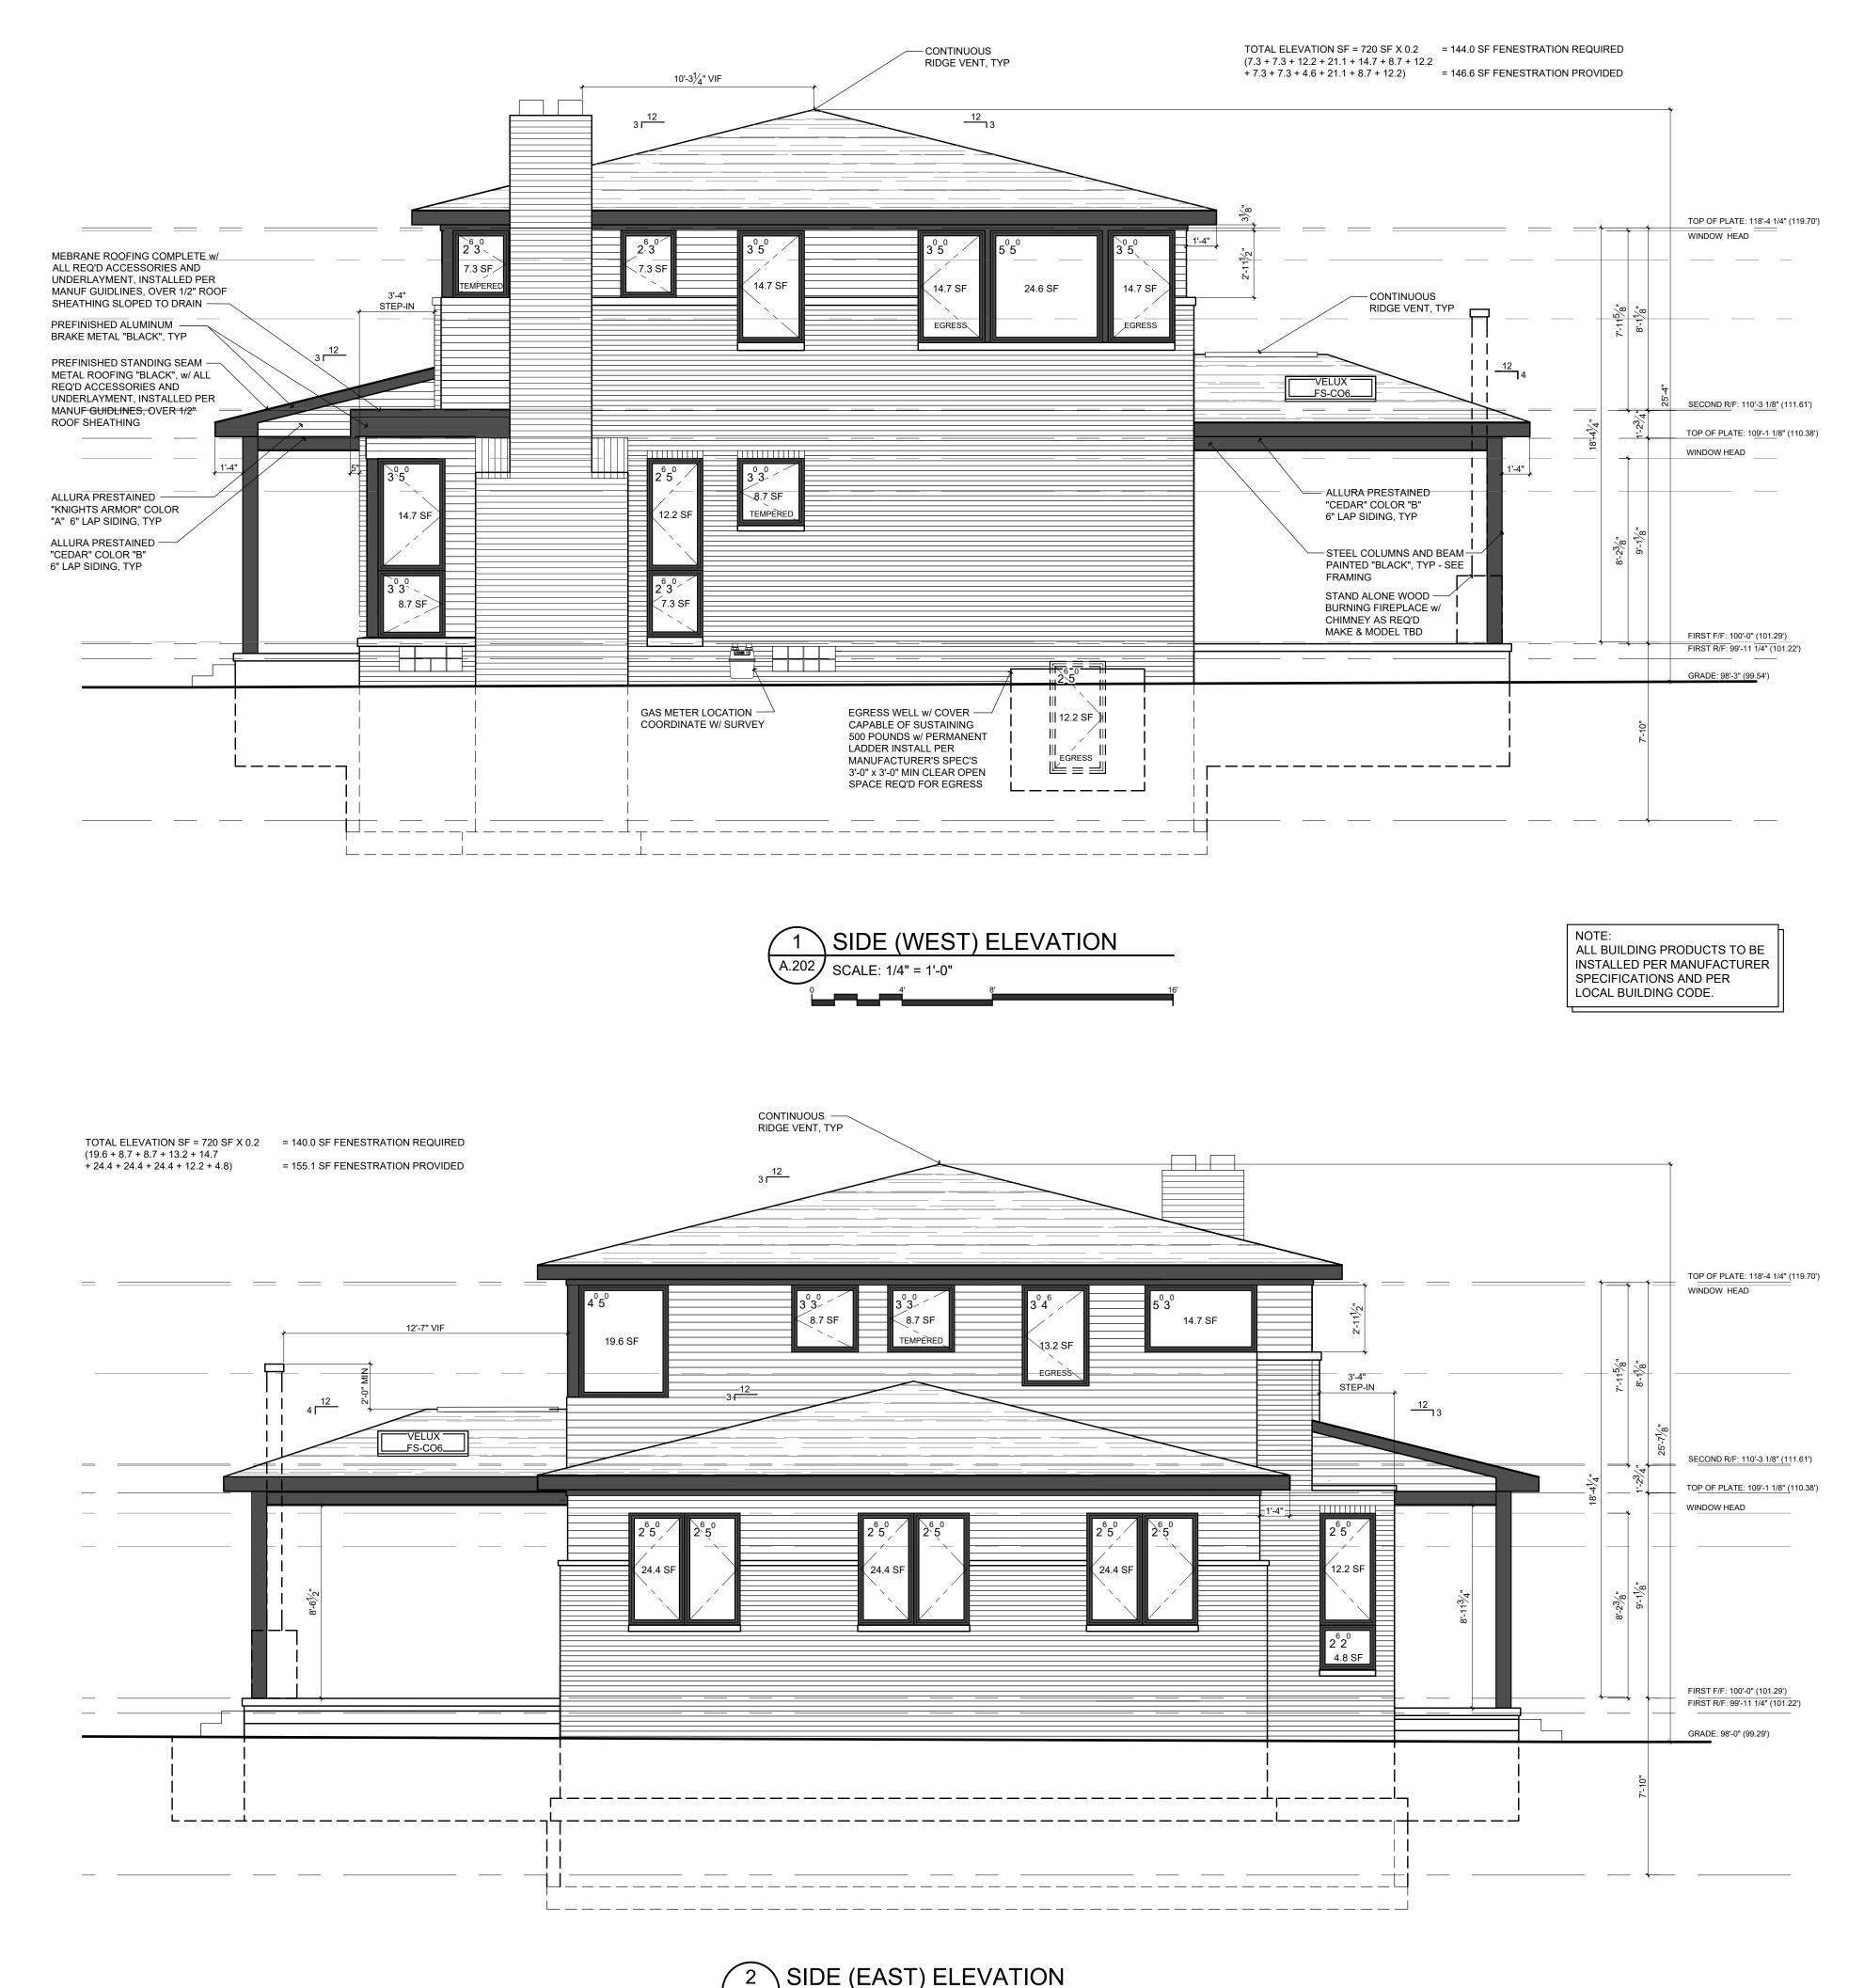



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TOP OF PLATE: 119'-9" (776.01')

WINDOW HEAD

5 Talbot Ave ton Woods. MI

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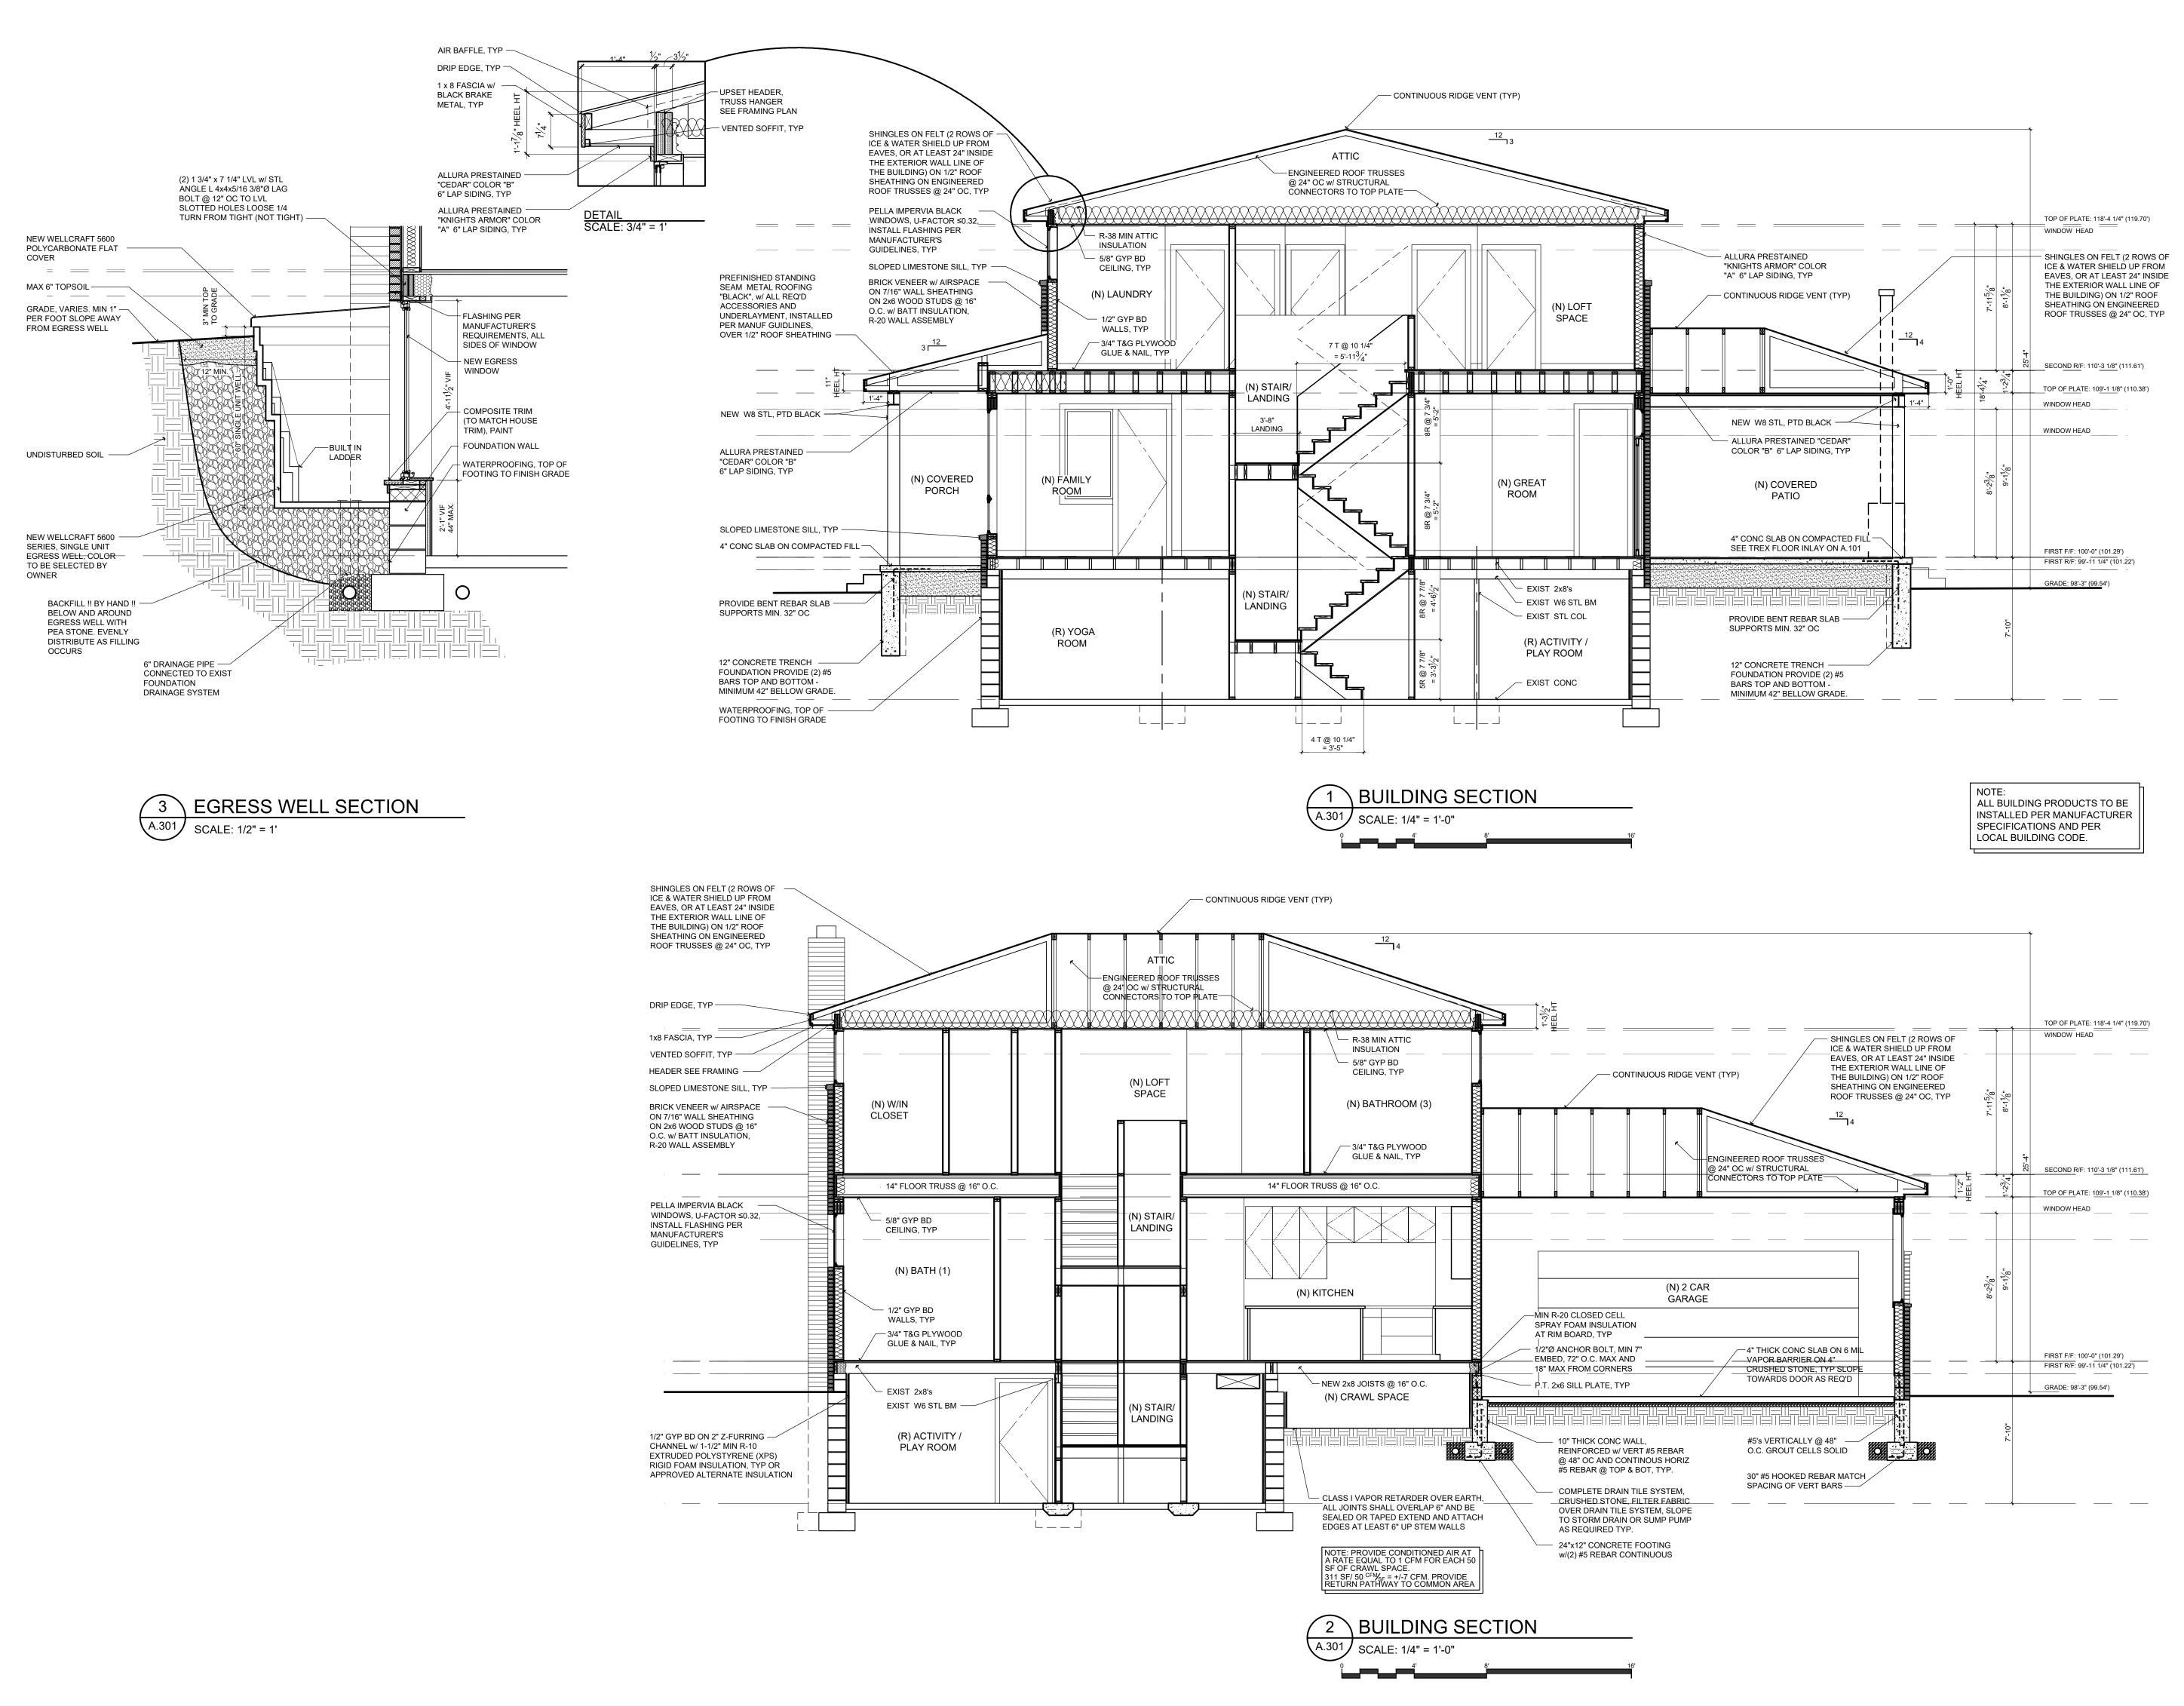
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Exterior Elevations



PRESSIVE ARCHITECTURE

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JGRIFFIS@ expressivearchitecture.com TOP OF PLATE: 119'-9" (776.01') WINDOW HEAD

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Building Sections




#### **SURVEYORS NOTES**

1- MATCH EXISTING GRADES ALONG PROPERTY LINES.


2- ALL EROSION AND SEDIMENT CONTROL WORK SHALL CONFORM TO THE STANDARDS AND SPECIFICATIONS OF THE CITY OF HUNTINGTON WOODS AND OAKLAND COUNTY.


3-ALL HOUSE DIMENSIONS SHOWN HEREON ARE OUTSIDE WALLS DIMENSIONS. CLIENT MUST VERIFY ALL DIMENSIONS PRIOR TO CONSTRUCTION.

4-COORDINATE WITH UTILITY COMPANIES THE RE-LOCATING OF ELECTRIC AND GAS METERS.

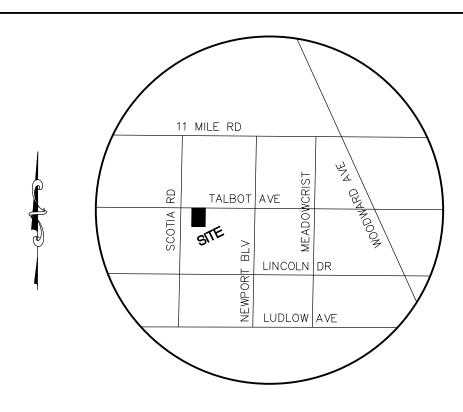

**LOCATION MAP** NOT TO SCALE

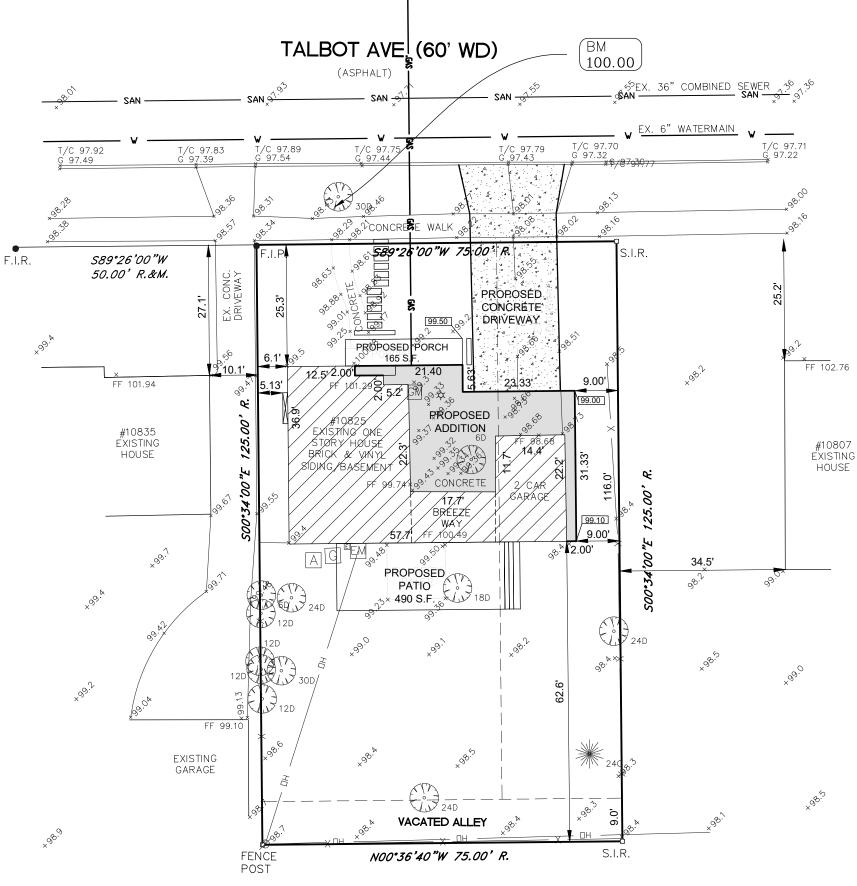

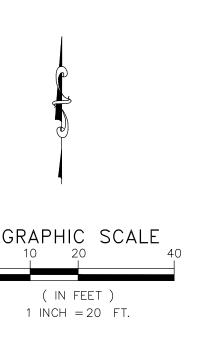

### BENCH MARK

BM: SET PK NAIL IN WEST FACE OF 30" TREE WEST SIDE OF TALBOT AVE. IN-FRONT OF PROPERTY. ASSUMED ELEVATION 100.00

## LEGAL DESCRIPTION

1/2 LOT 516 AND ALL OF LOT 517 AND VACATED ALLEY IN THE BRONX SUBDIVISION, CITY OF HUNTINGTON WOODS, OAKLAND COUNTY, MI

#### **BOUNDARY CERTIFICATION**

I hereby certifies that I surveyed the above described property, for the purpose of establishing outline boundaries, and that the boundaries and corners of said property are as indicated herein.

A CURRENT TITLE POLICY HAS NOT BEEN FURNISHED AT TIME OF SURVEY. THEREFORE EASEMENTS AND/OR ENCUMBRANCES AFFECTING SUBJECT PARCEL MAY NOT BE SHOWN.

#### **LEGEND**

R. —— RECORD M. — MEASURED F.I.P. — FOUND IRON PIPE F.I.R. — FOUND MONUMENT F.P. — FENCE POST ---- UTILITY POLE 12D ——— 12" DECIDUAS TREE 24C —— 24" CONIFER TREE EM — ELEC. METER ---- LIGHT POST GM G ---- GAS METER ---- GENERATOR ---- ELECTRIC BOX ---- AIR CONDITION 99.<sup>3</sup> — EX. GRADE X — FENCE LINE --- EX WATERMAIN

— EX SEWER

EX OVERHEAD LINES

- EX GAS LINES

**UTILITY NOTE:** ALL WATER MAIN, STORM SEWER, SANITARY
SEWER AND PUBLIC LIGHTING UTILITIES AS
SHOWN HEREON ARE TAKEN FROM THE BEST
AVAILABLE RECORDS AS DISCLOSED BY THE
VARIOUS UTILITY COMPANIES AND/OR
MUNICIPALITIES. NO GUARANTEE CAN BE GIVEN
BY US AS TO THE ACCURACY OR
COMPLETENESS THEREOE COMPLETENESS THEREOF.

#### SITE CRITERIA

• ADDRESS: 10825 TALBOT AVE. • PARCEL ID NO.: 25-20-251-005

• ZONING: R-1D (ONE FAMILY DISTRICT)

AREA OF PARCEL: 9375 S.F.
AREA OF EXISTING HOUSE AND BREEZE WAY = 1093 S.F.

• AREA OF EXISTING GARAGE = 324 S.F.

• AREA OF PROPOSED ADDITION = 332 S.F

• AREA OF PROPOSED GARAGE ADDITION= 319 S.F. • TOTAL COVERAGE AREA = 2068 S.F. = 22%

TOTAL SIDE: 14.0 FEET


• MAX LOT COVERAGE = 30% • MAXIMUM BUILDING HEIGHT = 30.0 FEET

• MINIMUM SETBACKS: FRONT: 25.0 FEET REAR: 30.0 FEET SIDE: 5.0 FEET

# **PLOT PLAN**

10825 TALBOT HUNTINGTON WOODS, MI 48070

DATE:	BY	REVISIONS	ORDER NO.	19-038	LAND SPECIALISTS SHT. NO.
			FIELD BOOK	45/22	21418 EWING DR. LAND SURVEYORS
			SURVEY BY	A.T	MACOMB, MI. 48044 PH(586)703-1794 www.landspecialists.us 1 0 F 1
			DRAWN BY	А.Т.	SCALE 1"=20'   FOR CHARLES GARLING   DATE 3-30-2021

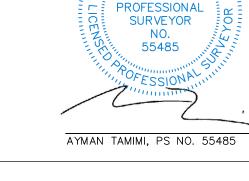

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