### DOCUMENT 009113 - ADDENDUM #3

### 1.1 PROJECT INFORMATION

A. Project Name: Downtown Greenville Technology Upgrades

B. Owner: City of Greenville

C. Designer: AE Tech Design

D. Designer Project Number: GREN2202-0200

E. Date of Addendum: 2023-01-31

### 1.2 NOTICE TO BIDDERS

- A. This Addendum is issued to all registered plan holders pursuant to the Instructions to Bidders and Conditions of the Contract. This Addendum serves to clarify, revise, and supersede information in the Project Manual, Drawings, and previously issued Addenda. Portions of the Addendum affecting the Contract Documents will be incorporated into the Contract by enumeration of the Addendum in the Owner/Contractor Agreement.
- B. The Bidder shall acknowledge receipt of this Addendum in the appropriate space on the Bid Form.
- C. The date for receipt of bids is unchanged by this Addendum, at the same time and location.

### 1.3 ATTACHMENTS

- A. This Addendum includes the following attached Sheets:
  - 1. All previously released technology sheets have been reissued for ease of viewing.

### 1.4 QUESTIONS AND ANSWERS

- A. Q: What licensing length should be provided for the Verkada cameras?
  - 1. Include 1-year licenses for the base bid price, but voluntary alternates for the additional costs needed to reach the 3, 5, and 10-year licenses are highly encouraged.

### 1.5 REVISIONS TO DRAWING SHEETS

- A. Sheet T302 Structured Cabling Enlarged Tech Closet Plan
  - 1. In detail 3 "TR-A Rack Elevation," a dimension was added for the minimum space between the rack and the wall. The rack type was also corrected in the list of equipment for detail 3.
- B. Sheet T303 Structured Cabling Pole Details

- 1. In detail 1 "Electronics Enclosure (TYP.) Detail Riser," the DC power supply model was changed, and the DC power converter was moved from the base of the light pole to the electronics enclosure.
- 2. In detail 3 "Electronics Enclosure Details," the DC power converter was added to the electronics enclosure.

END OF DOCUMENT 009113

# Downtown Greenville Technology Upgrades

City of Greenville 411 S. Lafayette St, Greenville, MI 48838

Project Number: GREN2202-0200

City of Greenville

Downtown Greenville Technology Upgrades
411 S. Lafayette St, Greenville, MI 48838

ISSUE / DATE 2023-01-11 BIDS 2023-01-12 ADDENDUM 1 2023-01-18 ADDENDUM 2 2023-01-31 ADDENDUM 3

DRAWN BY
CDB
PROJECT NO.
GREN2202-0200

SHEET NO.

CABLING AND JACK LEGEND									
DUDDOCE	PREMISE CABLING					JA	CKS		
PURPOSE	COLOR	RATING	MANUFACTURER	MODEL	TR COLOR	WA COLOR	MANUFACTURER	MODEL	
COPPER BACKBONE					RED	RED		CJ688TGRD	
VIRELESS ACCESS POINTS					YELLOW	YELLOW		CJ688TGYL	
AGING					GREEN	GREEN		CJ688TGGR	
SURVEILLANCE CAMERAS	BLUE	PLENUM	GENERAL CABLE	GENSPEED 6000	VIOLET	VIOLET	PANDUIT	CJ688TGVL	
RESERVED					BLACK	BLACK		CJ688TGBL	
OTS LINES					GRAY	GRAY		CJ688TGIG	
ENERAL PURPOSE					WHITE	WHITE		CJ688TGWH	

FIBER LEGEND									
PURPOSE	TYPE	RATING	MANUFACTURER	MODEL					
NDOOR/OUTDOOR	12 STRAND SINGLE-MODE (O2) 1 STRAND SINGLE-MODE (O2)	N/A	CORNING	ALTOS LITE LOOSE TUBE, GEL FREE, SINGLE-JACKET CABLE					
PATCH CORD		N/A	UBIQUITI	UF-SM-PATCH-UPC-APC, UF-SM-PATCH-APC-APC					

COPPER PATCH CORD LEGEND							
PURPOSE	COLOR						
GENERAL DATA	WHITE						
WIRELESS ACCESS POINTS	YELLOW						
SURVEILLANCE CAMERAS	VIOLET						
PAGING	GREEN						

	RISER LEGEND						
	SYMBOL	DESCRIPTION					
		ZONE OR AREA					
		BY OTHERS OR EXISTING					
		NEW					
	[]]	OPTIONAL					
		PLUG INTO 120V RECEPTACLE					
	III	CONNECT TO GROUND					
		WIFI CONNECTION					
	((p))	GENERIC RF CONNECTION					
	***************************************	BLUETOOTH CONNCETION					
		CELLULAR CONNECTION					
	8	8P8C (RJ45) NETWORK					
1	8K	KEYED 8P8C (RJ45)					
	88	SHIELDED 8P8C (RJ45)					
	СМ	COMPONENT VIDEO					
	CS	COMPOSITE VIDEO					
	S	SVIDEO					
	V	HD15 (VGA) VIDEO					
	D	DVI VIDEO					
	Н	HDMI VIDEO					
	LR	RED & WHITE RCA AUDIO					
	35	3.5MM STEREO AUDIO					
	14	1/4" STEREO AUDIO					
	X	XLR MICROPHONE					
	F	COAX TYPE "F"					
	N	NEUTRIK NL4MP					
	U	USB					

COMPUTER PRINTED SELF-LAMINATED CABLE WRAP LABEL WITHIN 6 INCHES OF

JACK; SEE LEGEND FOR COLOR

CABLE END

HORIZONTAL CROSS-CONNECT  INTERMEDIATE CROSS-CONNECT  MAIN CROSS-CONNECT  NOT IN CONTRACT  ON CENTER
MAIN CROSS-CONNECT  NOT IN CONTRACT
NOT IN CONTRACT
ON CENTER
OII OLIVILIX
OUTSIDE PLANT
PRIMARY BONDING BUSBAR
POKE-THROUGH
RACK BONDING CONDUCTOR
SECONDARY BONDING BUSBAR
STRUCTURED CABLING
STRUCTURED CABLING CONTRACTOR
TELECOMMUNICATIONS BONDING BACKBONE
TELECOMMUNICATIONS ENCLOSURE
TELECOMMUNICATIONS EQUIPMENT BONDING CONDUCTOR
TELECOMMUNICATIONS OUTLET
TELECOMMUNICATIONS ROOM
TYPICAL
UNLESS NOTED OTHERWISE
UNINTERRUPTIBLE POWER SUPPLY
WORK AREA

**ABBREVIATIONS** 

ACCESS CONTROL

AUDIO / VIDEO

BACKERBOARD

CAST IN PLACE

CONSOLIDATION POINT

ENTRANCE FACILITY

EQUIVALENT

EXISTING

EQUIPMENT ROOM

ELECTRICAL CONTRACTOR

ELECTRICAL METALLIC TUBING

GROUND FAULT CIRCUIT INTERRUPTER

ABOVE FINISH FLOOR

AUTOMATIC TRANSFER SWITCH

BUILDING AUTOMATION SYSTEM

**TERMINOLOGY** 


ABBREVIATION


AV OR A/V

	LIST OF DRAWINGS						
NUME	BER	TITLE					
TGO	)1	Title Sheet					
TGC	)2	Technology General Information					
TSC	)1	Technology Site Plan - Composite					
TSC	)2	Technology Site Plan - Surveillance					
TSC	)3	Technology Site Plan - Paging					
TSO	14	Technology Site Plan - Network					
TSO	15	Technology Site Plan Details					
Т30	11	Structured Cabling General Information					
Т30	2	Structured Cabling Enlarged Tech Closet Plan					
Т30	3	Structured Cabling Light Pole Details					
Т30	4	Structured Cabling Support Information					
Т30	5	Structured Cabling Network Diagram					
T40	11	Security Systems General Information					
T50	)1	Distributed Systems General Information					

# **GENERAL NOTES**

- FOR DROPS INSTALLED ABOVE ACCESSIBLE CEILING, PROVIDE MAINTENANCE LOOP AS INDICATED ON TECHNOLOGY SYMBOL LEGEND. CABLE SHALL BE NEATLY COILED IN AN "S" LOOP AND SECURED TO BUILDING STRUCTURE AT DROP LOCATION FOR EASY RELOCATION.
- LOAD THE LATEST AVAILABLE STABLE FIRMWARE FOR ALL DEVICES WHEN THEY ARE SUPPLIED FOR THIS PROJECT.

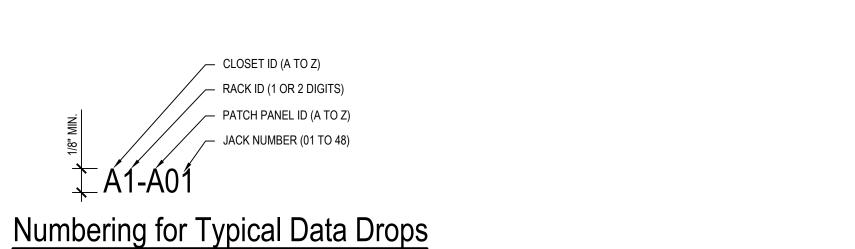

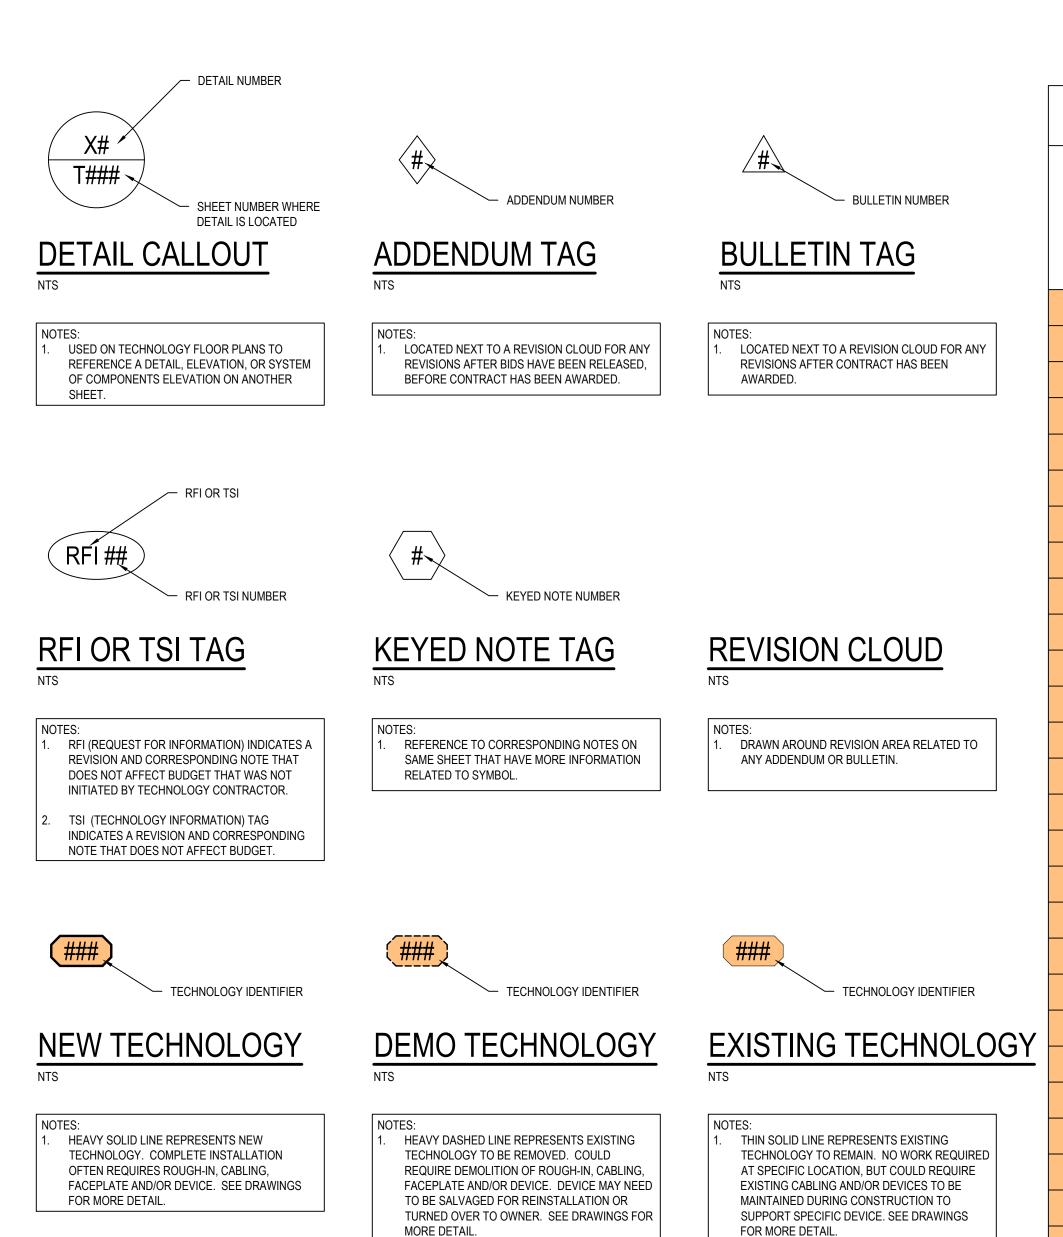

- CLOSET ID (A TO Z)

BACKBOARD ZONE (A TO Z)

POSITION NUMBER (01 TO 24)

110 BLOCK ID (A TO Z)

Numbering for 110-Block Term. Drops

WORK SCOPE LEGEND						
DEFINITION OF WORK	OSP FIBER	STRUCT. CABLING	CAMERA	PAGING	NETWORK	OWNER
DEMO EXISTING STRUCTURED CABLING EQUIPMENT (RETURN TO OWNER)		Х				
DEMO EXISTING STRUCTURED CABLING BACKBONE AND PREMISE CABLING		Х				
PROVIDE STRUCTURED CABLING ROUGH-INS (BOXES, CONDUITS, RACEWAY, PATHWAY)	Х	Х				
PROVIDE ADAPTERS FOR RACEWAY, FLOORBOXES, ETC., TO ACCOMMODATE STANDARD FACEPLATES AND JACKS		Х				
PROVIDE BACKBONE PATHWAY (LARGE CABLE TRAY AND CONDUITS)	Х	Х				
PROVIDE INCIDENTAL STRUCTURED CABLING PATHWAY		Х				
PROVIDE STRUCTURED CABLING BACKBONE CABLING (AND TERMINATION)		Х				
PROVIDE STRUCTURED CABLING PREMISE CABLING (AND TERMINATION)		Х				
PROVIDE STRUCTURED CABLING FACEPLATES		Х				
PROVIDE STRUCTURED CABLING COPPER PATCH CORDS		Х				
PROVIDE STRUCTURED CABLING FIBER PATCH CORDS	Х					
PROVIDE STRUCTURED CABLING RACKS		Х				
SUPPLY NETWORK ELECTRONICS					Х	
CONFIGURE NETWORK ELECTRONICS					Х	
INSTALL NETWORK ELECTRONICS					Х	
PROVIDE GROUNDING BUSBARS IN TELECOMMUNICATION ROOMS		Х				
CONNECT TECH EQUIPMENT TO GROUNDING BUSBARS		Х				
PROVIDE BACKERBOARD IN TELECOMMUNICATION ROOMS		Х				
PROVIDE ELECTRICAL IN TELECOMMUICATION ROOMS						Х
SUPPLY UPSES					Х	
INSTALL UPSES		Х				
CONNECT HARD-WIRED UPSES TO POWER						Х
SUPPLY ACCESS POINTS					Х	
PROVIDE IP ADDRESS RANGE FOR ACCESS POINTS					Х	
CONFIGURE ACCESS POINTS					Х	
INSTALL ACCESS POINTS					Х	
PERFORM DIRECTIONAL BORING FOR CABLE PATHWAY	Х					
PERFORM CORING IN TO EXISTING MANHOLES	Х					
PERFORM MILLING OF EXISTING PARKING LOT SURFACES						Х
PERFORM SAW CUTTING OF EXISTING SURFACES	Х					

		ABLING				
DEFINITION OF WORK	OSP FIBER	STRUCT. CABLING	CAMERA	PAGING	NETWORK	OWNER
DEMO EXISTING CAMERAS (RETURN TO OWNER)			Х			
PROVIDE CAMERA PATHWAY (STRUCTURED CABLING BACKBONE PATHWAY)		Х				
PROVIDE PREMISE CABLING & TERMINATION FOR CAMERA EQUIPMENT	Х	Х				
SUPPLY CAMERA SERVER (SOFTWARE, AND HARDWARE IF NOT VIRTUAL)			Х			
PROVIDE IP ADDRESS FOR CAMERA SERVER					Х	
CONFIGURE CAMERA SERVER			Х			
INSTALL CAMERA SERVER (IF NOT VIRTUAL)			Х			
SUPPLY CAMERA PATCH CORDS		Х				
INSTALL CAMERA PATCH CORDS			Х			
SUPPLY EXISTING CAMERAS						Х
SUPPLY NEW CAMERAS			Х			
PROVIDE IP ADDRESS RANGE FOR CAMERAS					Х	
CONFIGURE CAMERAS			Х			
VERIFY FINAL PLACEMENT OF CAMERAS PRIOR TO INSTALLATION			Х			Х
INSTALL CAMERAS			Х			
CORE EXTERIOR WALLS FOR EXTERIOR CAMERAS (COORDINATE FINAL LOCATION)			Х			
DEMO EXISTING PUBLIC ADDRESS EQUIPMENT				Х		
DEMO EXISTING PUBLIC ADDRESS CABLING				Х		
SUPPLY PAGING HEADEND EQUIPMENT (ANALOG AND/OR IP)				Х		
PROVIDE IP ADDRESS RANGE FOR HEADEND (IF IP)					Х	
PROVIDE PAGING CABLING				Х		
PROVIDE PREMISE CABLING & TERMINATION FOR PAGING EQUIPMENT		Х				
PROVIDE PAGING DEVICES (ANALOG AND IP)				Х		
PROVIDE IP ADDRESS RANGE FOR IP PAGING DEVICES					Х	
SUPPLY PAGING SPECIALTY ROUGH-INS				Х		
SUPPLY PAGING GENERAL ROUGH-INS				Х		
INSTALL PAGING ROUGH-INS				Х		
SUPPLY PAGING PATCH CORDS FOR NETWORK CONNECTED DEVICES		Х				

# WORK SCOPE LEGEND NOTES

OSP FIBER CONTRACTOR IS RESPONSIBLE FOR ALL FIBER UNTIL THE POINT OF DEMARCATION, FOR THIS PROJECT THE DEMARCATION POINT IS THE FIBER ENTERING THE BUILDING FROM LIGHT POLES AND BEING TERMINATED INTO THE OSP FIBER CONTRACTOR PROVIDED FIBER PATCH PANEL. EVERYTHING PAST THAT IS THE RESPONSIBILITY OF THE STRUCTURED CABLING CONTRACTOR.

> Upgrades Technology I City of Greenville
>
> Downtown Greenville 7
> 411 S. Lafayette St, Greenville, MI 48

Technology General Information ISSUE / DATE 2023-01-11 BIDS 2023-01-12 ADDENDUM 1 2023-01-18 ADDENDUM 2 2023-01-31 ADDENDUM 3

DRAWN BY CDB PROJECT NO.

GREN2202-0200 SHEET NO.

### SITE GENERAL NOTES

- DEMO ANY EXISTING LOW VOLTAGE EQUIPMENT, CABLING, ACCESSORIES, AND MOUNTING HARDWARE ON STREET LIGHT POLES.
- 2. EQUIPMENT BELONGING TO, OR ASSOCIATED WITH MICHIGAN DEPARTMENT OF TRANSPORTATION (MDOT) SHALL NOT BE TOUCHED OR MANIPULATED WITHOUT EXPRESS CONSENT FROM MDOT.
  - 3. LIGHT POLES THAT DO NOT HAVE PATHWAY SHOWN HAVE EXISTING USABLE PATHWAY. ONLY NEW PATHWAY SHOWN. FINAL FIBER ROUTE TO BE DETERMINED IN

# SITE KEYED NOTES

- PATHWAY FOR LOW VOLTAGE CABLING TO BE PLOWED.
- 24"X36" HANDHOLE.
- 3 (1) 1" INNERDUCT.
- 4 MOUNT LOW VOLTAGE EQUIPMENT TO EXISTING POLE IN PARKING LOT.
- CORE IN TO EXISTING MANHOLE OR LIGHT POLE BASE FOR NEW CONDUIT ENTRY.
- PATHWAY FOR LOW VOLTAGE CABLING TO BE DIRECTIONALLY BORED.
- FIBER DISTRIBUTION AND SPLICE POINT. SEE T303 FOR DETAILS.
- 8 FIBER CONSOLIDATION POINT. SEE T303 FOR DETAILS.
- 9 COORDINATE FINAL MOUNTING HEIGHT AND LOCATION WITH OWNER.

SYMBOL LEGEND						
SYMBOL	DESCRIPTION					
	NEW PATHWAY					
	EXISTING MANHOLE					
	NEW HANDHOLE					
⋫	LIGHT POLE					
AP	WIRELESS ACCESS POINT - SEE T301 FOR DETAILS					
CM	CAMERA - SEE T401 FOR DETAILS					
S1	SPEAKER - SEE T501 FOR DETAILS					

Intown Greenville Technology Upgrades Lafayette St, Greenville, MI 48838

City of Greenvi

City of Greenvi

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411 S. Lafayette St

2023-01-12 ADDENDUM 1 2023-01-18 ADDENDUM 2 2023-01-31 ADDENDUM 3

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PROJECT NO.
GREN2202-0200

SHEET NO.

CITY

POLICE DEPT.

HALL

### SITE GENERAL NOTES

- DEMO ANY EXISTING LOW VOLTAGE EQUIPMENT, CABLING, ACCESSORIES, AND MOUNTING HARDWARE ON STREET LIGHT POLES.
- 2. EQUIPMENT BELONGING TO, OR ASSOCIATED WITH MICHIGAN DEPARTMENT OF TRANSPORTATION (MDOT) SHALL NOT BE TOUCHED OR MANIPULATED WITHOUT EXPRESS CONSENT FROM MDOT.
  - 3. LIGHT POLES THAT DO NOT HAVE PATHWAY SHOWN HAVE EXISTING USABLE PATHWAY. ONLY NEW PATHWAY SHOWN. FINAL FIBER ROUTE TO BE DETERMINED IN

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- FIBER CONSOLIDATION POINT. SEE T303 FOR DETAILS.

(9)	>	COORDINATE FINAL MOUNTING HEIGHT AND LOCATION WITH OWN
-----	---	--------------------------------------------------------

SYMBOL LEGEND							
SYMBOL	SYMBOL DESCRIPTION						
	NEW PATHWAY						
EXISTING MANHOLE							
	NEW HANDHOLE						
*	LIGHT POLE						
AP	WIRELESS ACCESS POINT - SEE T301 FOR DETAILS						
СМ	CAMERA - SEE T401 FOR DETAILS						
S1	SPEAKER - SEE T501 FOR DETAILS						

า Greenville Technology Upgrades st, Greenville, MI 48838

City of Greenville

Downtown Greenville Techr
411 S. Lafayette St, Greenville, MI 48838

ISSUE / DATE
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GREN2202-0200 SHEET NO.

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- Surveillance TS02

POLICE DEPT.

### SITE GENERAL NOTES

- DEMO ANY EXISTING LOW VOLTAGE EQUIPMENT, CABLING, ACCESSORIES, AND MOUNTING HARDWARE ON STREET LIGHT POLES.
- EQUIPMENT BELONGING TO, OR ASSOCIATED WITH MICHIGAN DEPARTMENT OF TRANSPORTATION (MDOT) SHALL NOT BE TOUCHED OR MANIPULATED WITHOUT EXPRESS CONSENT FROM MDOT.
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# SITE KEYED NOTES

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- 24"X36" HANDHOLE.
- 3 > (1) 1" INNERDUCT.
- 4 MOUNT LOW VOLTAGE EQUIPMENT TO EXISTING POLE IN PARKING LOT.
- CORE IN TO EXISTING MANHOLE OR LIGHT POLE BASE FOR NEW CONDUIT ENTRY.
- PATHWAY FOR LOW VOLTAGE CABLING TO BE DIRECTIONALLY BORED.
- FIBER DISTRIBUTION AND SPLICE POINT. SEE T303 FOR DETAILS. 8 FIBER CONSOLIDATION POINT. SEE T303 FOR DETAILS.
- 9 COORDINATE FINAL MOUNTING HEIGHT AND LOCATION WITH OWNER.

SVI	<b>MBOL</b>	IF	CEI	ЛГ
<b>311</b>	VIDUL	. L⊏'	JEI	ИL

OTTO DOLLEGE TO						
SYMBOL	DESCRIPTION					
	NEW PATHWAY					
	EXISTING MANHOLE					
	NEW HANDHOLE					
*	LIGHT POLE					
AP	WIRELESS ACCESS POINT - SEE T301 FOR DETAILS					
CM	CAMERA - SEE T401 FOR DETAILS					
S1	SPEAKER - SEE T501 FOR DETAILS					

City of Gr Downto

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### SITE GENERAL NOTES

- DEMO ANY EXISTING LOW VOLTAGE EQUIPMENT, CABLING, ACCESSORIES, AND MOUNTING HARDWARE ON STREET LIGHT POLES.
- EQUIPMENT BELONGING TO, OR ASSOCIATED WITH MICHIGAN DEPARTMENT OF
  - TRANSPORTATION (MDOT) SHALL NOT BE TOUCHED OR MANIPULATED WITHOUT EXPRESS CONSENT FROM MDOT.
  - LIGHT POLES THAT DO NOT HAVE PATHWAY SHOWN HAVE EXISTING USABLE PATHWAY. ONLY NEW PATHWAY SHOWN. FINAL FIBER ROUTE TO BE DETERMINED IN

# SITE KEYED NOTES

- PATHWAY FOR LOW VOLTAGE CABLING TO BE PLOWED.
- 24"X36" HANDHOLE.
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- CORE IN TO EXISTING MANHOLE OR LIGHT POLE BASE FOR NEW CONDUIT ENTRY.
- PATHWAY FOR LOW VOLTAGE CABLING TO BE DIRECTIONALLY BORED. FIBER DISTRIBUTION AND SPLICE POINT. SEE T303 FOR DETAILS.
- 8 FIBER CONSOLIDATION POINT. SEE T303 FOR DETAILS.
- COORDINATE FINAL MOUNTING HEIGHT AND LOCATION WITH OWNER.

	S	YMBOL LEGEND	
IBOI		DESCRIPTION	

SYMBOL	DESCRIPTION				
	NEW PATHWAY				
	EXISTING MANHOLE				
	NEW HANDHOLE				
*	LIGHT POLE				
AP	WIRELESS ACCESS POINT - SEE T301 FOR DETAILS				
CM	CAMERA - SEE T401 FOR DETAILS				
S1	SPEAKER - SEE T501 FOR DETAILS				


City of Gr Downto 411 S. Lafay

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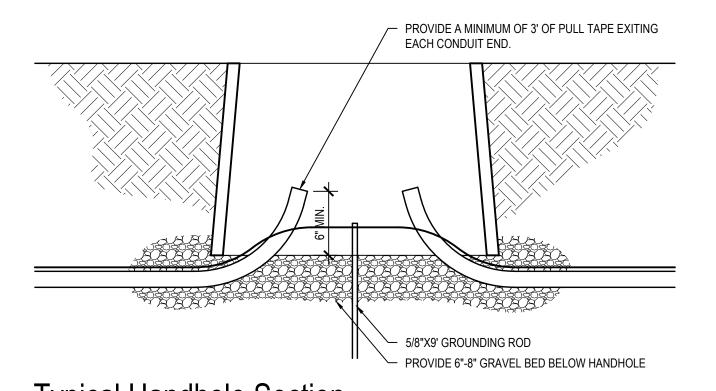
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- CABLE TRAY. SEE DETAILS ON T302 & T304




Typical Ae

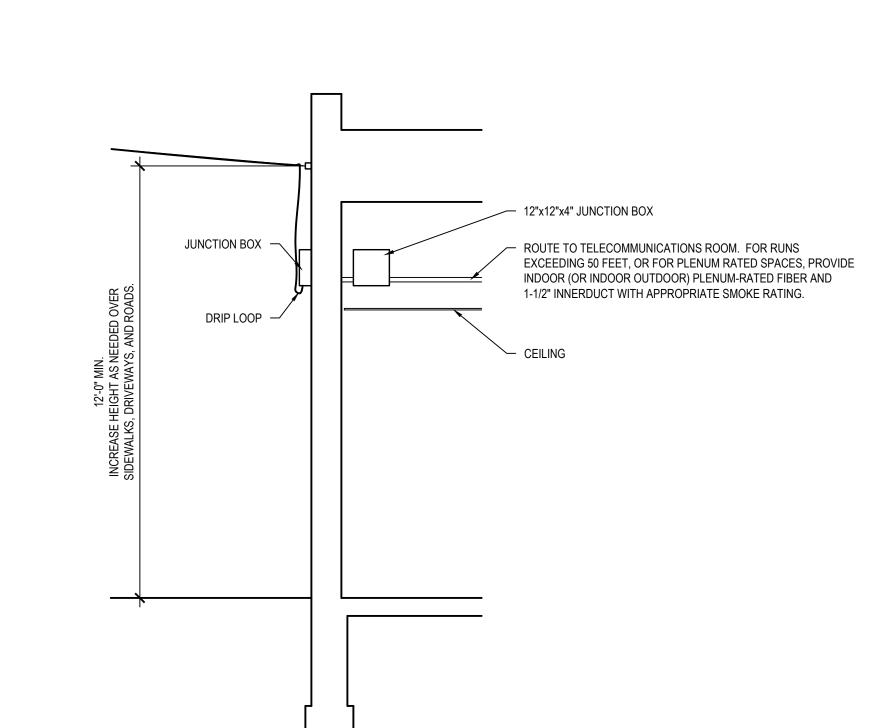

Typical Handhole Section

1"=1'-0"

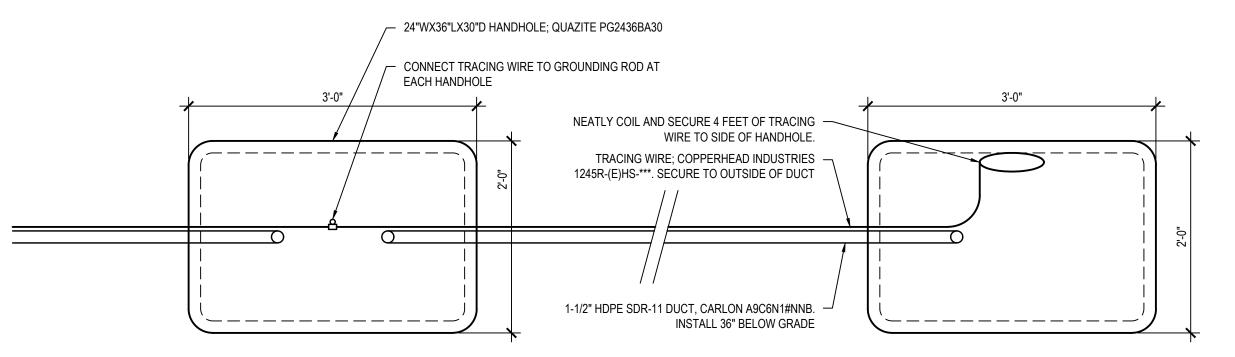

Typical Underground Fiber Details

1"=1"-0"

Aerial to Underground Fiber Transition

6

Aerial to Underground Fiber Transition

SPECIAL LB FOR FIBER - MADISON ELECTRIC SMART LB KBLB25\*

90° SWEEP ─

1-1/2" INNERDUCT

Typical Underground Fiber Entrance

ORANGE 3" WIDE WARNING TAPE PRINTED "CAUTION FIBER OPTIC CABLE BURIED BELOW"

TRACING WIRE; COPPERHEAD INDUSTRIES – 1245R-(E)HS-\*\*\*. SECURE TO OUTSIDE OF DUCT


1-1/2" HDPE SDR-11 DUCT, CARLON A9C6N1#NNB -

Typical Fiber Installation Detail

2" EMT CONDUIT

### FIBER GENERAL NOTES

- INSTALL ALL HANDHOLES AND DUCTS WITHIN PUBLIC ROAD RIGHT-OF-WAY OR ON OWNER'S PRIVATE PROPERTY.
- 2. ALL DUCTS RUNNING BETWEEN HANDHOLES ARE TO BE CONTINUOUS WITHOUT SPLICES OR COUPLERS.
- 3. ALL HANDHOLES TO HAVE POLYMER CONCRETE LIDS INSCRIBED WITH THE WORD "COMMUNICATIONS"

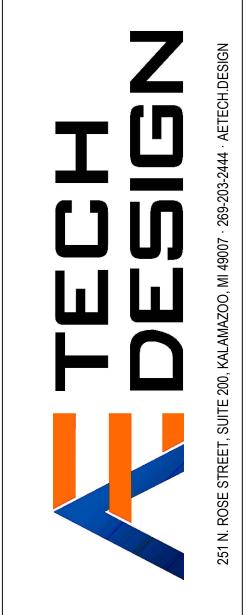

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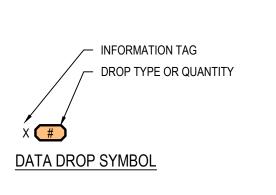
Technology Site Plan Details

Technology Site Plan Details

DRAWN BY
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PROJECT NO.
GREN2202-0200

SHEET NO.

DATA LEGEND									
SYMBOL	DESCRIPTION	HEIGHT	DATA DROPS	NEW WORK		SURFACE MOUNT		NOTES	
NEW	DESCRIPTION			ROUGH-IN	FACEPLATE	ROUGH-IN	FACEPLATE	ELECTRICAL	LOW VOLTAGE
AP	WIRELESS ACCESS POINT	SEE NOTES	1	N/A	12/T302	N/A	12/T302		1,2




DATA COUNT LEGEND							
SYMBOL	DESCRIPTION	DATA DROPS					
CM1	CAMERA - DOME	1					
CM2	CAMERA - MULTIVIEW	1					
CM3	CAMERA - BULLET	1					
S1	SPEAKER - POLE MOUNTED	0					

CVMDOL	DECCRIPTION	NC	TES			
SYMBOL	DESCRIPTION	ELECTRICAL	LOW VOLTAGE			
=======================================	1-1/2" EMT SLEEVE W/ BUSHINGS					
=======================================	1-1/2" EMT SLEEVE W/ BUSHINGS; SEAL ENDS W/ FIRE-PROOF PUTTY					
	1-1/2" EMT SLEEVE W/ BUSHINGS (UP)					
•	1-1/2" EMT SLEEVE W/ BUSHINGS (DOWN)					
	4" EMT SLEEVE W/ BUSHINGS					
	STI EZ-PATH SERIES 44 OR APPROVED EQUIVALENT					
	4" EMT SLEEVE W/ BUSHINGS (UP)					
	4" EMT SLEEVE W/ BUSHINGS (DOWN)					

### DATA LEGEND NOTES

PROVIDE 20 FEET OF MAINTENANCE LOOP FOR CABLE.

POLE MOUNTED ON STREET LIGHT POLE. SEE 2/T303 FOR DETAILS.

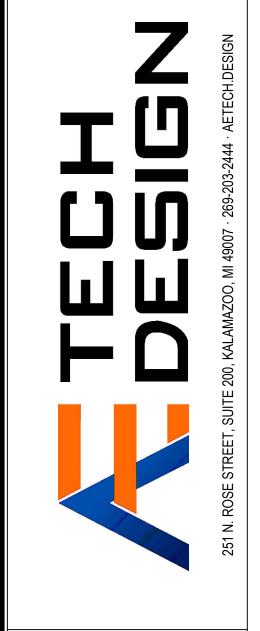

# STRUCTURED CABLING NOTES


- FOR ALL ALPHABETIC IDENTIFIERS THE LETTERS "O" AND "I" ARE NOT USED, TO PREVENT POSSIBLE CONFUSION WITH THE NUMBERS ZERO AND ONE.
- ALL ANALOG PHONE DROPS ARE TO BE TERMINATED IN TECH CLOSETS ON 110 PUNCH-DOWN BLOCKS MOUNTED ON BACKBOARD.


### CABLING DISTRIBUTION NOTES

- PROVIDE 10 FEET OF MAINTENANCE LOOP AT TECHNOLOGY ROOM AND 1 FOOT OF MAINTENANCE LOOP AT WORK AREA FOR ALL CABLING UNLESS NOTED OTHERWISE.
- FOR EACH RUN OF BACKBONE FIBER BETWEEN TECHNOLOGY ROOMS, TERMINATE 2 STRANDS. TEST ALL STRANDS.
- SEE PATCH CORD LEGEND AND CABLING AND JACK LEGEND ON TG02 FOR MORE INFORMATION REGARDING APPROPRIATE COLORS REQUIRED.
- 4. CABLING THAT ENTERS AND EXITS THE POLE-MOUNTED ENCLOSURE SHALL BE ENCLOSED IN LIQUIDTIGHT ELECTRIC TUBING AND SEALED PROPERLY AT EACH END.


# **GROUNDING NOTES**

- ELECTRONICS ENCLOSURE, AND ELECTRONICS LOCATED IN ENCLOSURE ON LIGHT POLES, SHALL BE GROUNDED ACCORDING TO CURRENT CODES AND STANDARDS.
   REFER TO SPECIFICATION SECTION 270526 FOR GROUNDING AND BONDING REQUIREMENTS.
- 2. GROUNDING BUSBARS IN EVERY TECH CLOSET SHALL BE CONNECTED TO AVAILABLE BUILDING STEEL AND ELECTRICAL PANELS (TYP.).

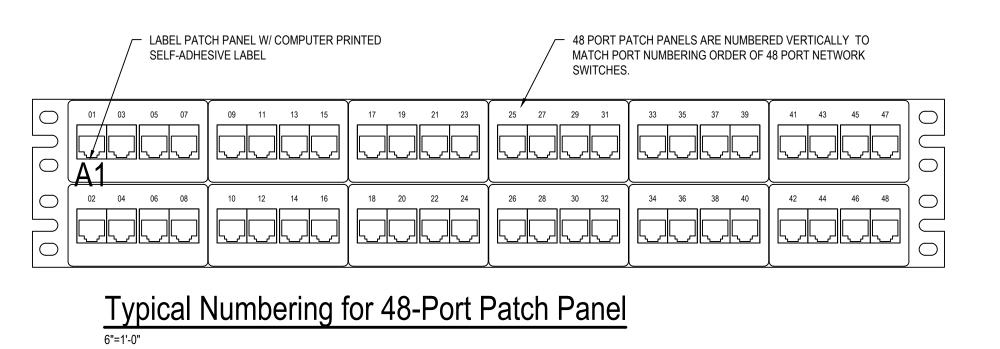

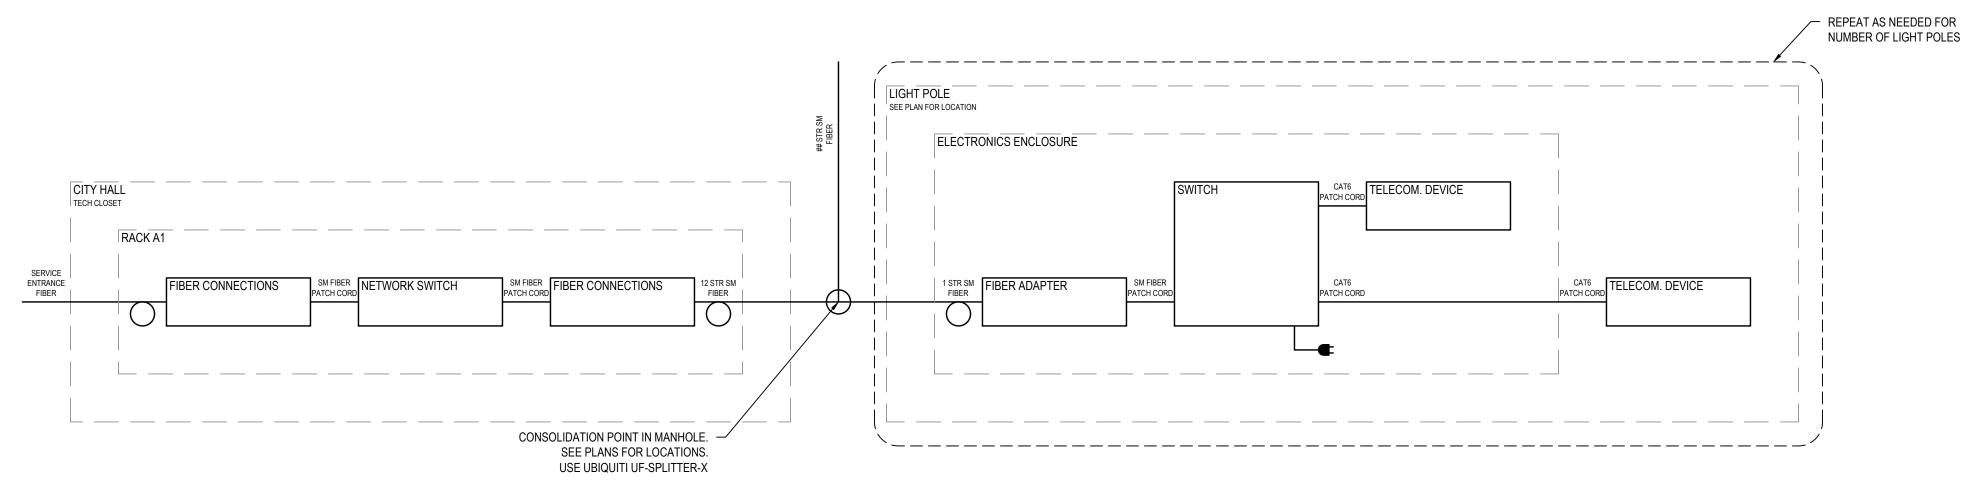

Cabling Distribution Riser (TYP.)

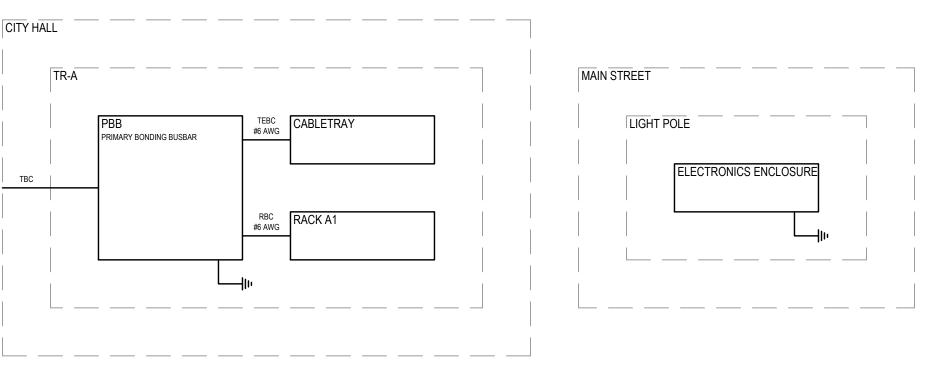

Telecommunications Grounding Riser


# City of Greenville Downtown Greenville Technology Upgrade 411 S. Lafayette St, Greenville, MI 48838

Cabling General Information

CDB
PROJECT NO.
GREN2202-0200

SHEET NO. **T301** 

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Lacing Bar Detail

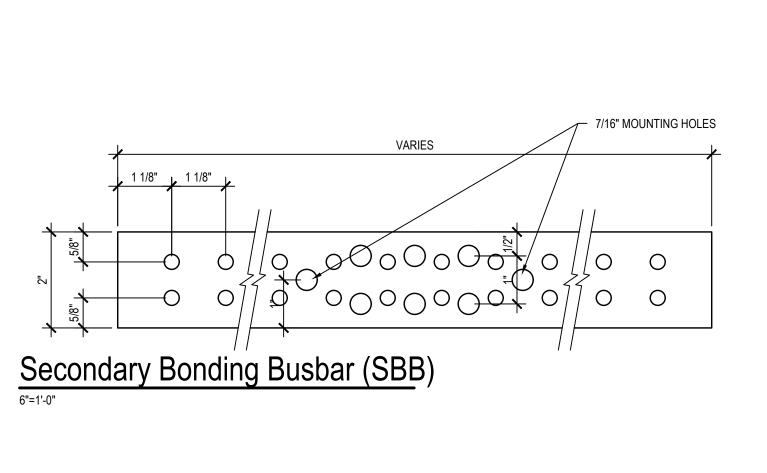USE LACING BAR AT REAR OF RACK TO KEEP ALL CABLES WITHIN THE 2U SPACE OF THE PATCH PANEL TO ALLOW FOR INSTALLATION

ISOMETRIC VIEW

SIDE VIEW

- RELAY RACK RAILS

- 2U 48 PORT PATCH PANEL

OF THE SWITCHES ABOVE AND BELOW THE PATCH PANELS.
ALL CABLES FROM TOP ROW OF PATCH PANEL SHALL BE
ATTACHED TO TOP OF LACING BAR. LIKEWISE ALL CABLES FROM
BOTTOM ROW OF PATCH PANEL SHALL BE ATTACHED TO THE

BOTTOM OF THE LACING BAR.

MAP LBP-2A LACING BAR

SWITCHES; KEEP THESE

AREAS FREE OF CABLES

VARIES

7/16" MOUNTING HOLES

VARIES

7/16" MOUNTING HOLES

Primary Bonding Busbar (PBB)

RACKS AND EQUIPMENT SHALL BE:
(1) FREE-STANDING SLIDING RACK - MIDDLE AT

(1) FREE-STANDING SLIDING RACK - MIDDLE ATLANTIC WR-24-32
(1) PLEXTRACK DOOR - MIDDLE ATLANTIC WRPFD-24
(2) RACKMOUNT PDU - MIDDLE ATLANTIC PD-915R-PL
(1) RACKMOUNT UPS W/ NETWORK MONITORING CARD - LIEBERT GXT5-1500LVRT2UXLN
(1) 4U RACK SHELF - MIDDLE ATLANTIC - U4V (DEEPEST AVAILABLE)

FIBER TERMINATIONS SHALL BE:

RACK-MOUNT FIBER TRAY - CORNING CTXCPP12-6C-2RH000
FIBER TRAY HOUSING - CORNING CTX-S1U

ALL PATCH PANELS SHALL BE:
PROVIDE QUANTITY AS REQUIRED TO TERMINATE ALL CABLES IN CLOSET

PROVIDE QUANTITY AS REQUIRED TO TERMINATE ALL CABLES IN CLOSET

48-PORT PATCH PANEL - PANDUIT CPPL48WBLY (PREMISE CABLING)
24-PORT PATCH PANEL - PANDUIT CPPL24WBLY (BACKBONE)
STRAIN RELIEF BAR - PANDUIT SRB19D5BL

NETWORK ELECTRONICS SHALL BE:
(1) ROUTER - UBIQUITI ER-8-XG

NETWORK ELECTRONICS SHALL BE:

(1) ROUTER - UBIQUITI ER-8-XG

(1) FIBER SWITCH - UBIQUITI ES-16-XG

(1) SWITCH - UBIQUITI USW-24-POE

(1) AUDIO MIXER - YAMAHA TF1 (SEE T501 FOR DETAILS)


(1) PAGING SERVER - ATLASIED IPS-VPS (MOUNTED ON BACKERBOARD)


(1) FIBER OPTICAL LINE TERMINAL - UBIQUITI UF-OLT
(1) MEDIA SERVER - YAMAHA WXC-50DS (MOUNTED ON BACKERBOARD. SEE T501 FOR DETAILS.)


OWNER PROVIDED EQUIPMENT SHALL BE: (1) MINI PC

TR-A Rack Elevation

1-1/2" = 1'-0"

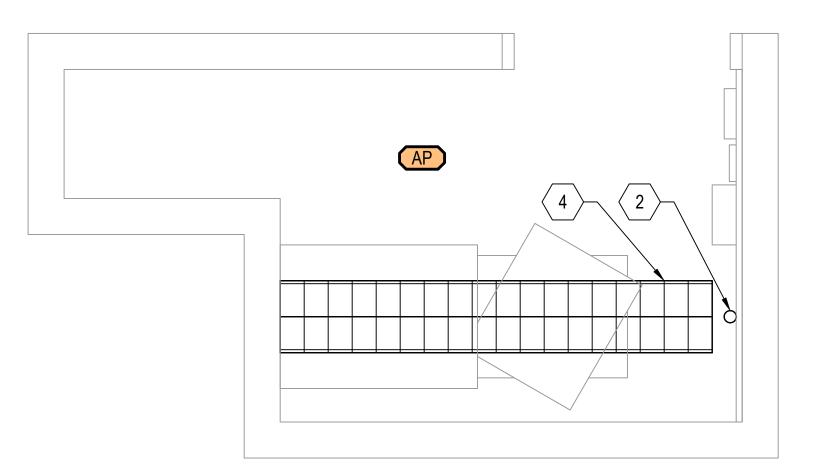

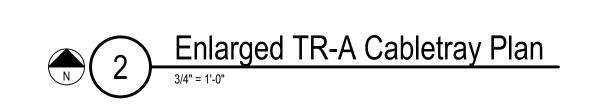

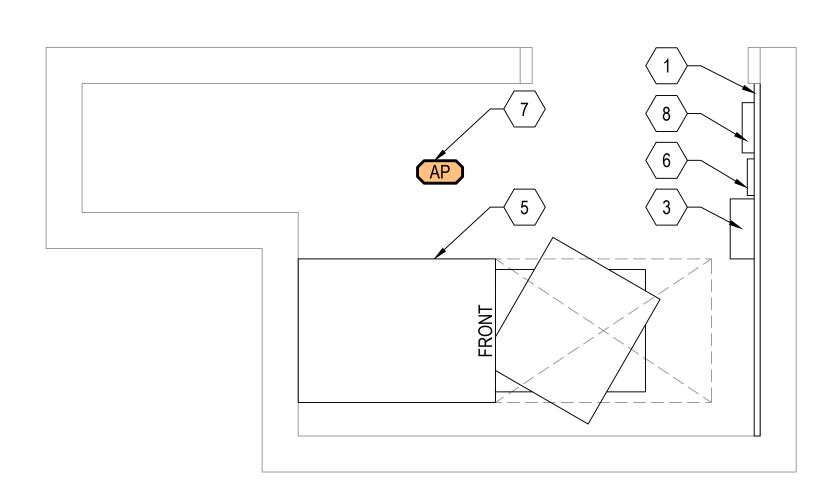

Enlarged TR-A Equipment Plan

3/4" = 1'-0"

### TECH CLOSET GENERAL NOTES

1. TECHNOLOGY CLOSETS SHALL BE NON-SPRINKLER SPACES.

POWERED CIRCUITS.

- 2. GENERAL BUILDING HVAC SHALL NOT BE INSTALLED IN ANY TECHNOLOGY CLOSET. IF ACTIVE COOLING IS REQUIRED, DEDICATED LOCAL SYSTEMS SHOULD BE INSTALLED
- IN EACH TECH CLOSET.

  3. ALL NEW OUTLETS IN THE TECHNOLOGY CLOSETS SHOULD BE ON GENERATOR
- EQUIPMENT MOUNTED ON BACKERBOARDS SHALL MAINTAIN PROPER CLEARANCES FOR OPERATION AND BE COORDINATED WITH OTHER DISCIPLINES IF THERE IS A CONFLICT OF PLACEMENT.
- PROVIDE A POWER STRIP FOR EQUIPMENT MOUNTED ON BACKERBOARD.

### TECH CLOSET KEYED NOTES

- 48"X96" A/C GRADE PLYWOOD BACKER-BOARD; PAINT W/ GRAY FIRE-RETARDANT PAINT, MOUNT @ 36"AFF. CUT TO FIT DESIGNATED WALL IF NEEDED.
- 2 (1) 2" EMT CONDUIT. SEE 5/TS05 FOR FIBER PATHWAY DETAILS.
- 3 4"X10" PRIMARY BONDING BUS BAR (PBB).
- 2"X12" CABLE TRAY @86"AFF; SUPPORT ALL TRAY W/ 3/8" THREADED ROD AND CENTER HANGERS @ 5'-0"OC, OR WALL BRACKETS WHEN ADJACENT TO WALLS. TIE ALL TRAY ENDS TO WALLS W/ WALL BRACKETS (TYP.).
- 5 ENCLOSED SERVER RACK.
- 6 PAGING SERVER. SEE 1/T501.
- 7 WIRELESS ACCESS POINT (UBIQUITI U6-LR-US).
- 8 MEDIA SERVER.



Structured Cabling Enlarged Tech Closet Plan

City of Greenville


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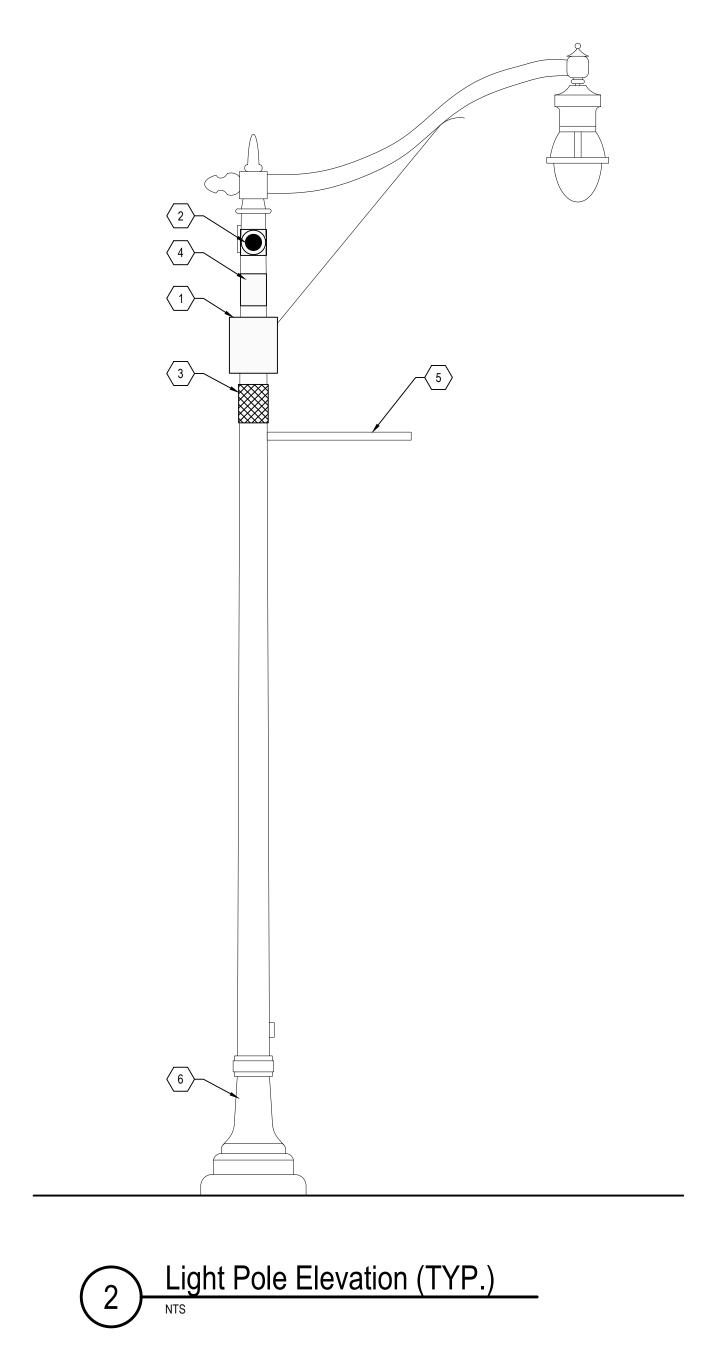
ISSUE / DATE 2023-01-11 BIDS 2023-01-12 ADDENDUM 1 2023-01-18 ADDENDUM 2 2023-01-31 ADDENDUM 3


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GREN2202-0200 SHEET NO.

T302





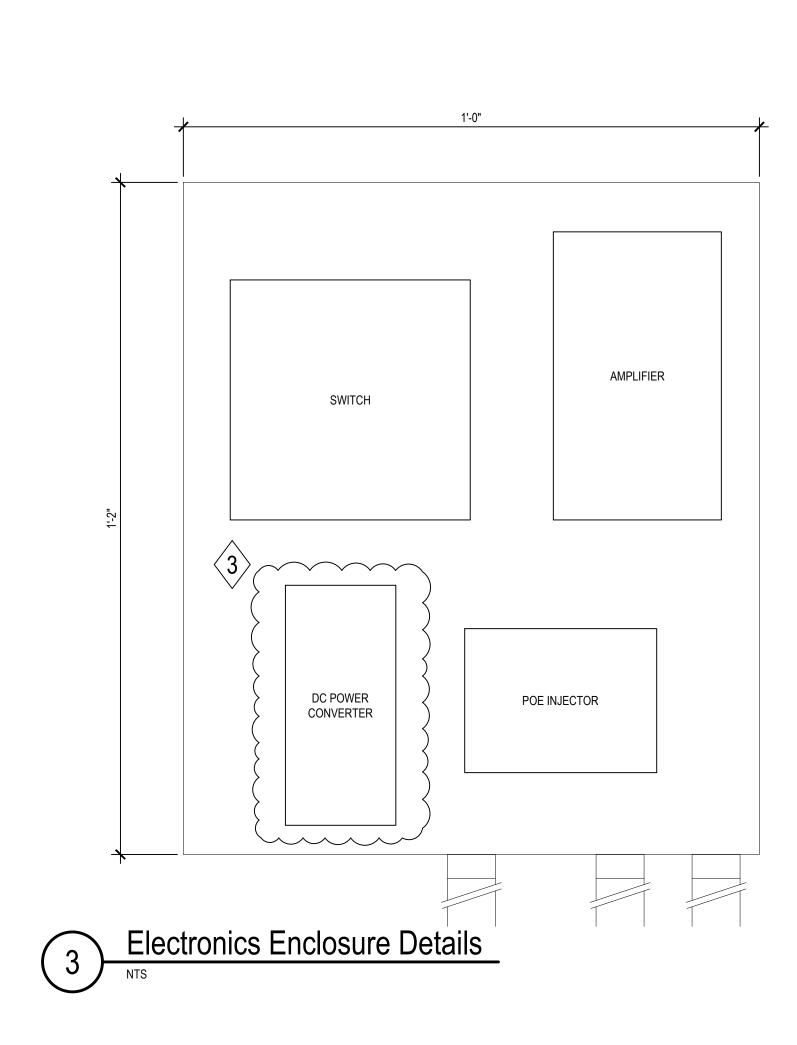

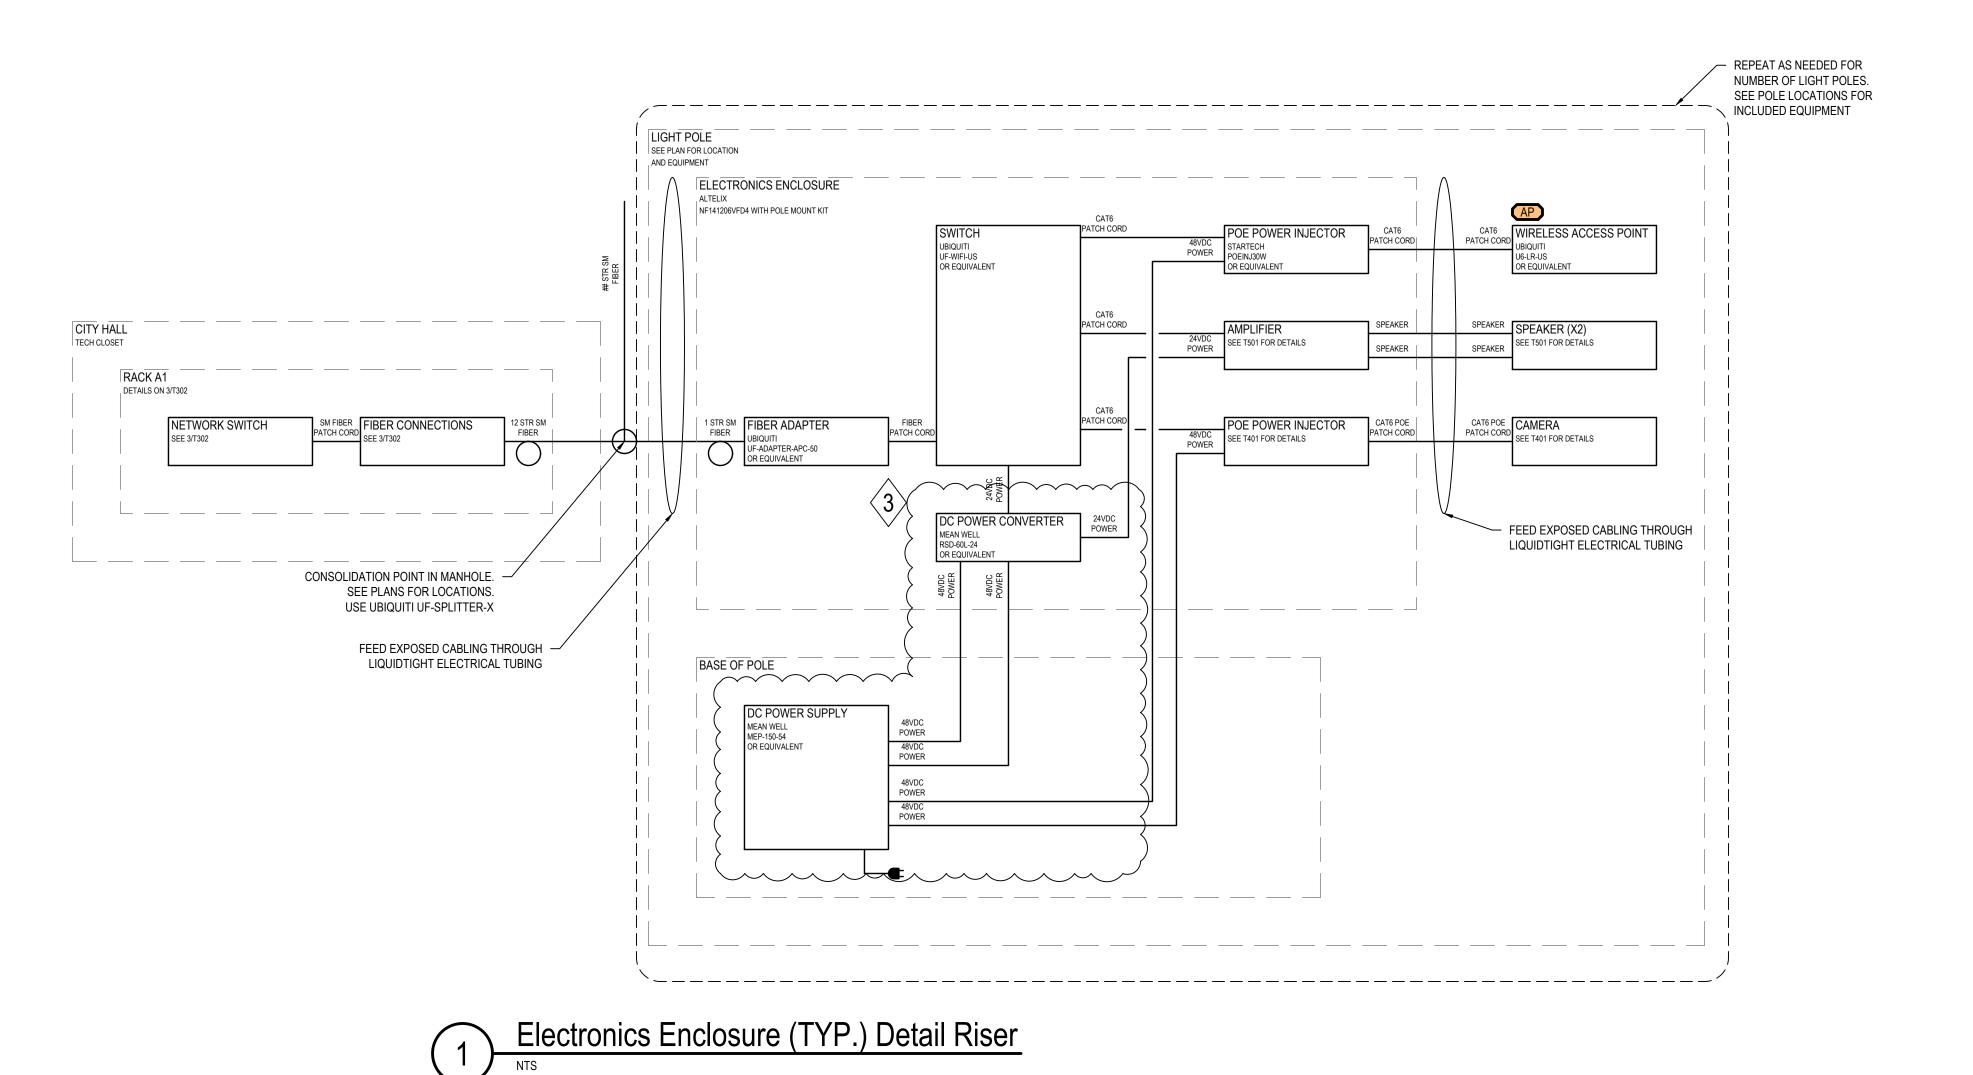LIGHT POLE GENERAL NOTES

1. MOUNT EQUIPMENT AS TO ALLOW PROPER EQUIPMENT CLEARANCES AND AVOID EXISTING LIGHT POLE FEATURES.

CABLING THAT ENTERS AND EXITS THE POLE-MOUNTED ENCLOSURE SHALL BE ENCLOSED IN LIQUIDTIGHT ELECTRIC TUBING AND SEALED PROPERLY AT EACH END.

ELECTRONICS RESIDING IN ENCLOSURE SHALL BE MOUNTED ON A BACK-PLATE AND PROPERLY SPACED FOR HEAT DISSIPATION AND CABLING PRIOR TO FINAL INSTALLATION IN ENCLOSURE.

ACTUAL EQUIPMENT INSTALLED IN EACH ENCLOSURE WILL VARY BY POLE. REFER TO PLANS FOR POLE SPECIFIC EQUIPMENT.

MANUFACTURERS LISTED ON DRAWINGS ARE USED AS THE BASIS OF DESIGN FOR THE VARIOUS TECHNOLOGY SYSTEMS. MANUFACTURERS OF SIMILAR QUALITY AND FEATURE SET MAY BE SUBMITTED AT TIME OF BID.

# LIGHT POLE KEYED NOTES

EXTERIOR ELECTRONICS ENCLOSURE. SEE DETAILS 3/T303. COORDINATE FINAL COLOR WITH OWNER.

SURVEILLANCE CAMERA (TYP.). REFER TO PLANS FOR SPECIFIC MODEL LOCATION AND VIEWS. MOUNTING HEIGHT AND STYLE MAY VARY. SEE DETAILS ON T401.

3 LOUDSPEAKER. SEE DETAILS ON T501.

4 WIRELESS ACCESS POINT.

5 EXISTING POLE BANNER ARM. INSTALL ALL EQUIPMENT ABOVE THIS ARM ON

6 DC POWER SUPPLY LOCATED IN BASE OF LIGHT POLE.

251 N. ROSE STREET, SUITE 200, KALAMAZOO, MI 49007 · 269-203-2444 · AETECH.DESIGN

ayette St, Greenville, MI 48838

Cabling Light Pole Details

ISSUE / DATE
2023-01-11 BIDS
2023-01-12 ADDENDUM 1
2023-01-18 ADDENDUM 2

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Structured Cabling Support Information

City of Greenville

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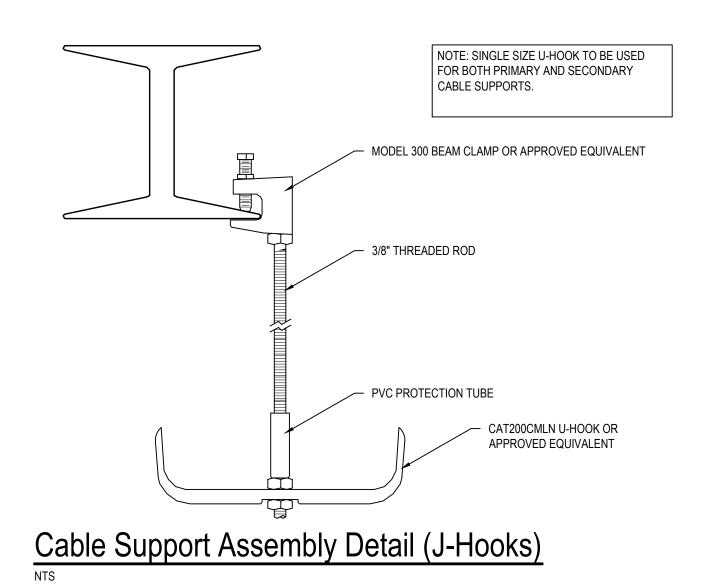
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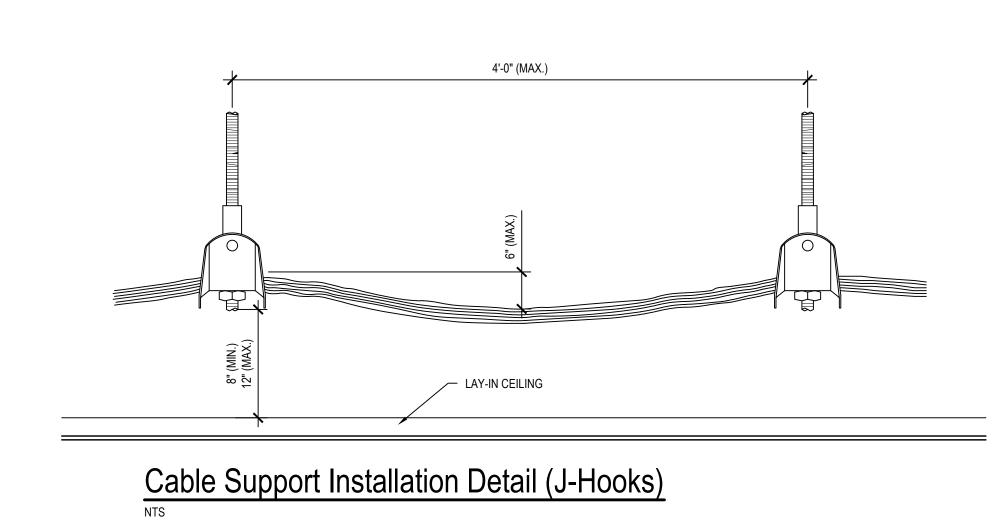
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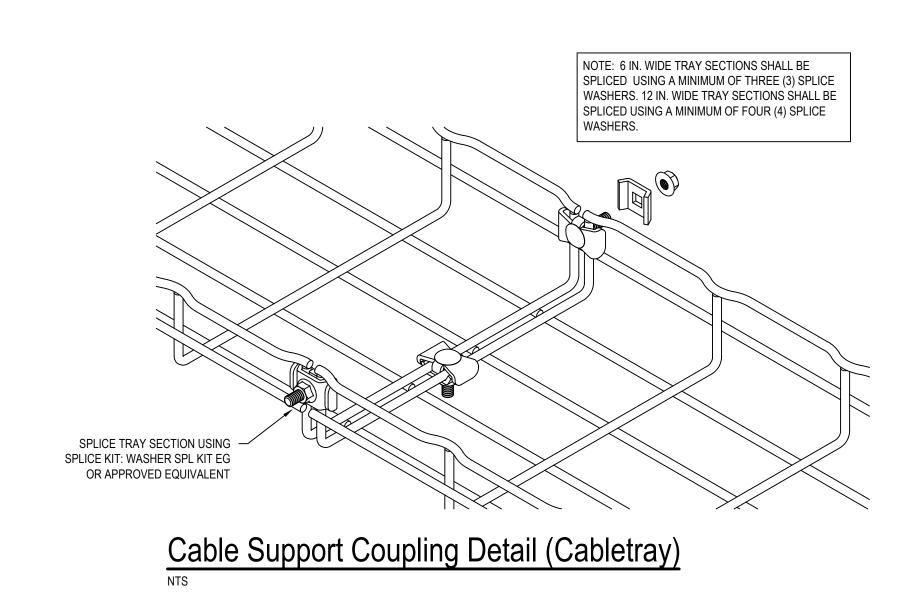
PROJECT NO. GREN2202-0200


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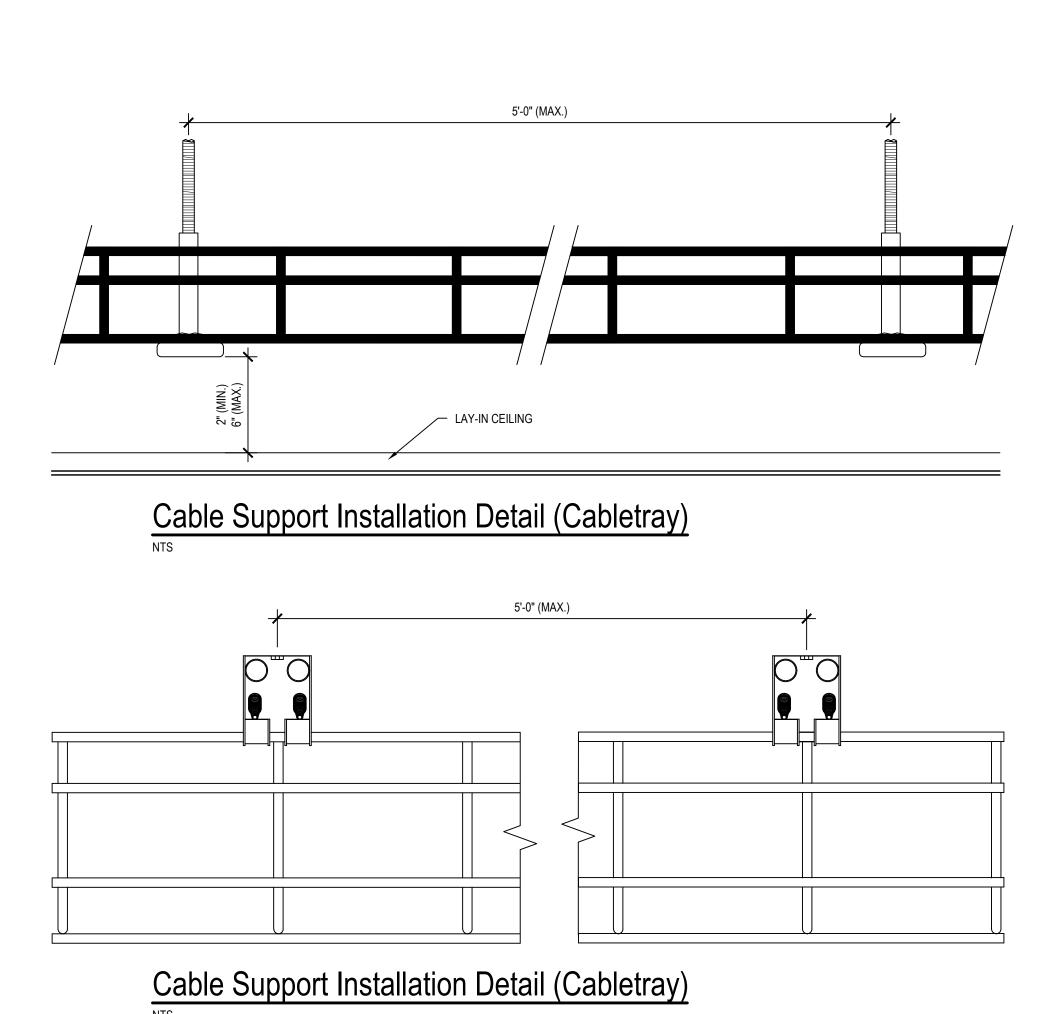
T304











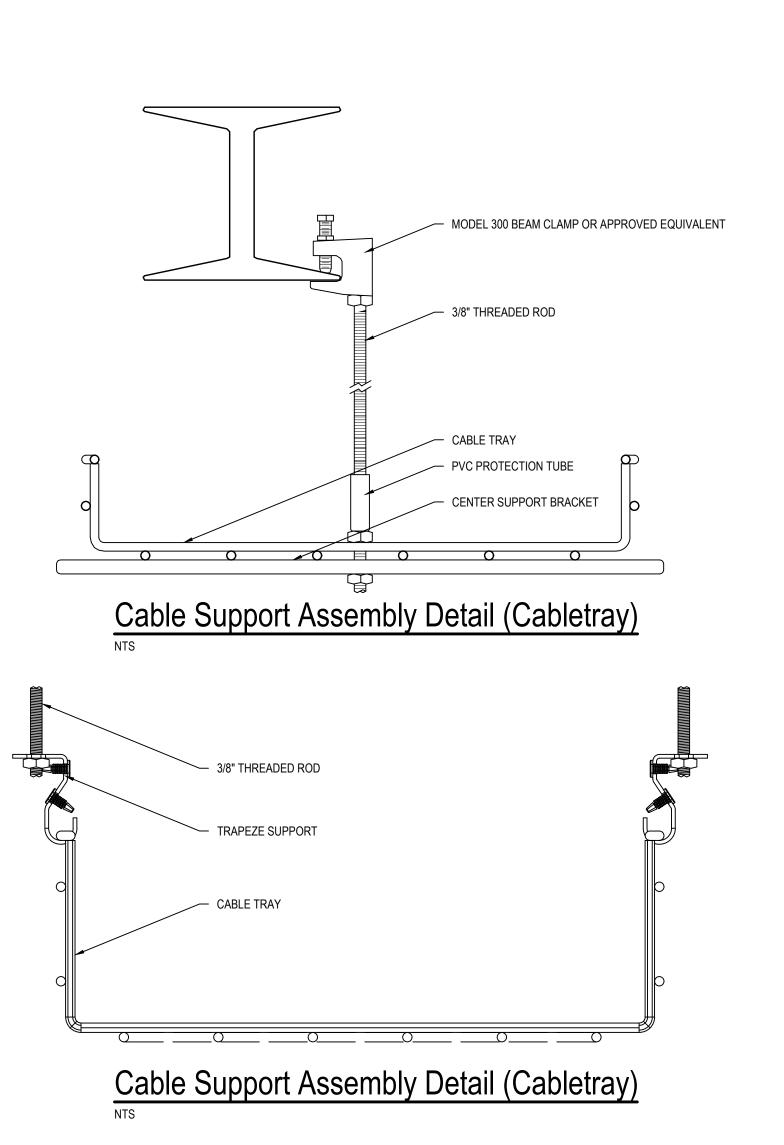

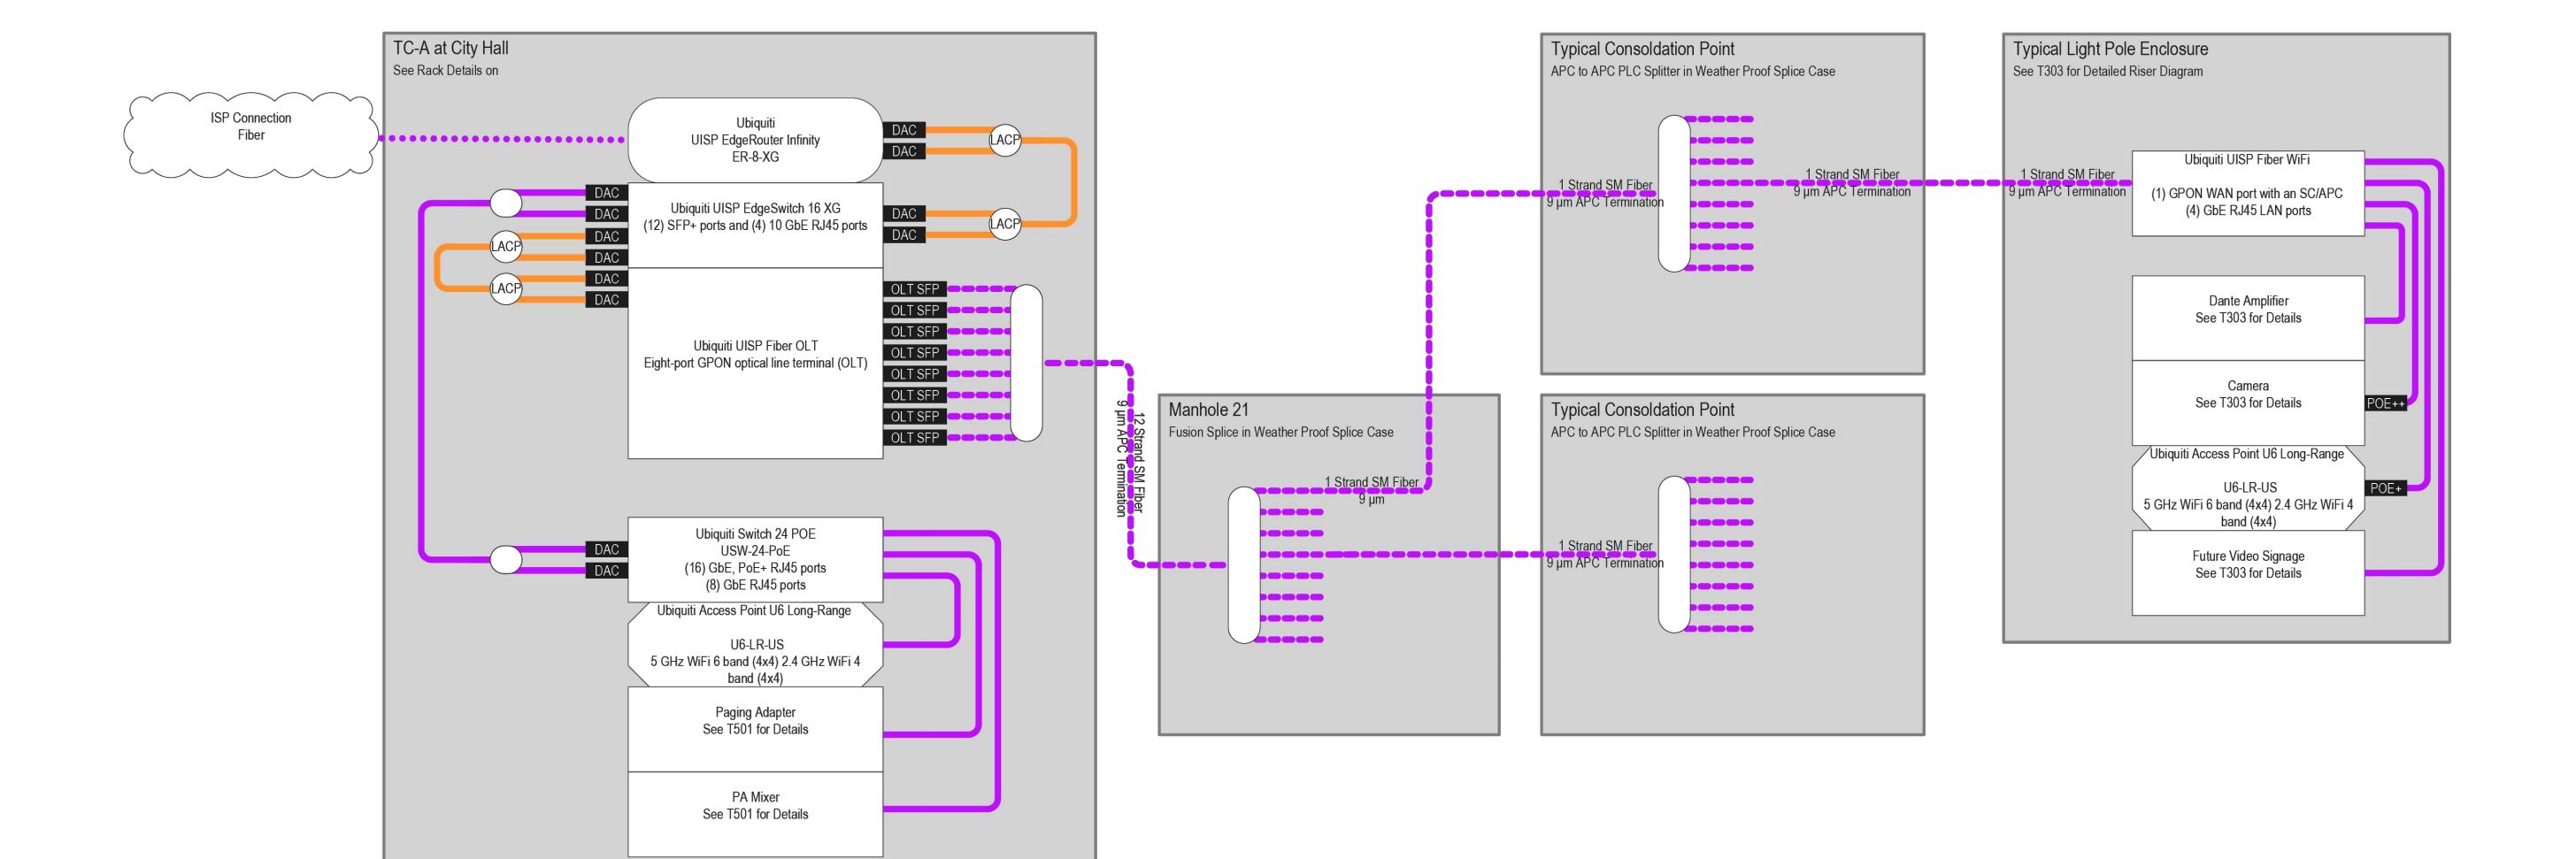

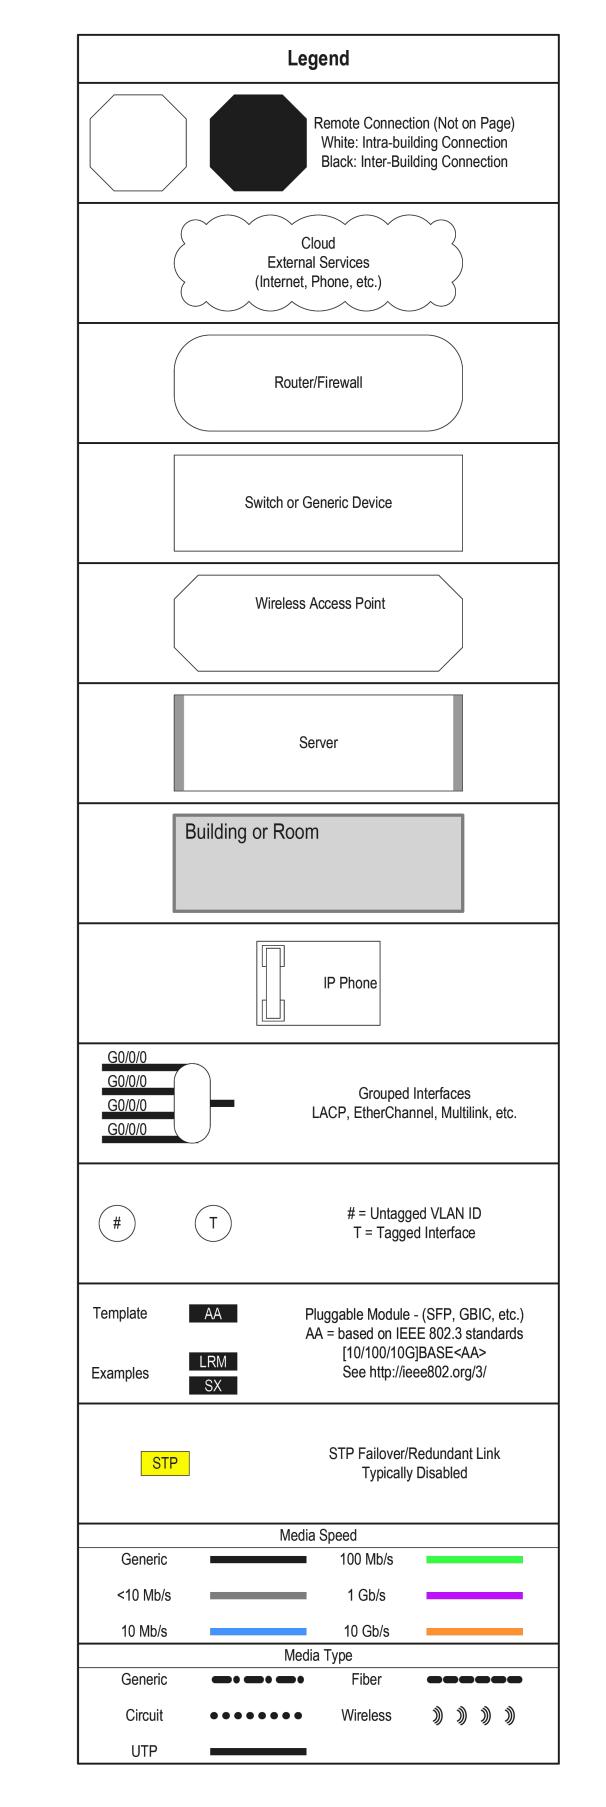

City of Greenville

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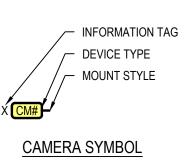
Cabling Network Diagram


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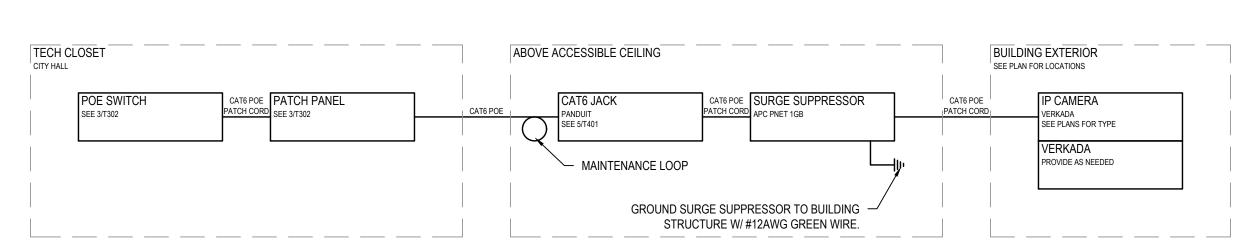
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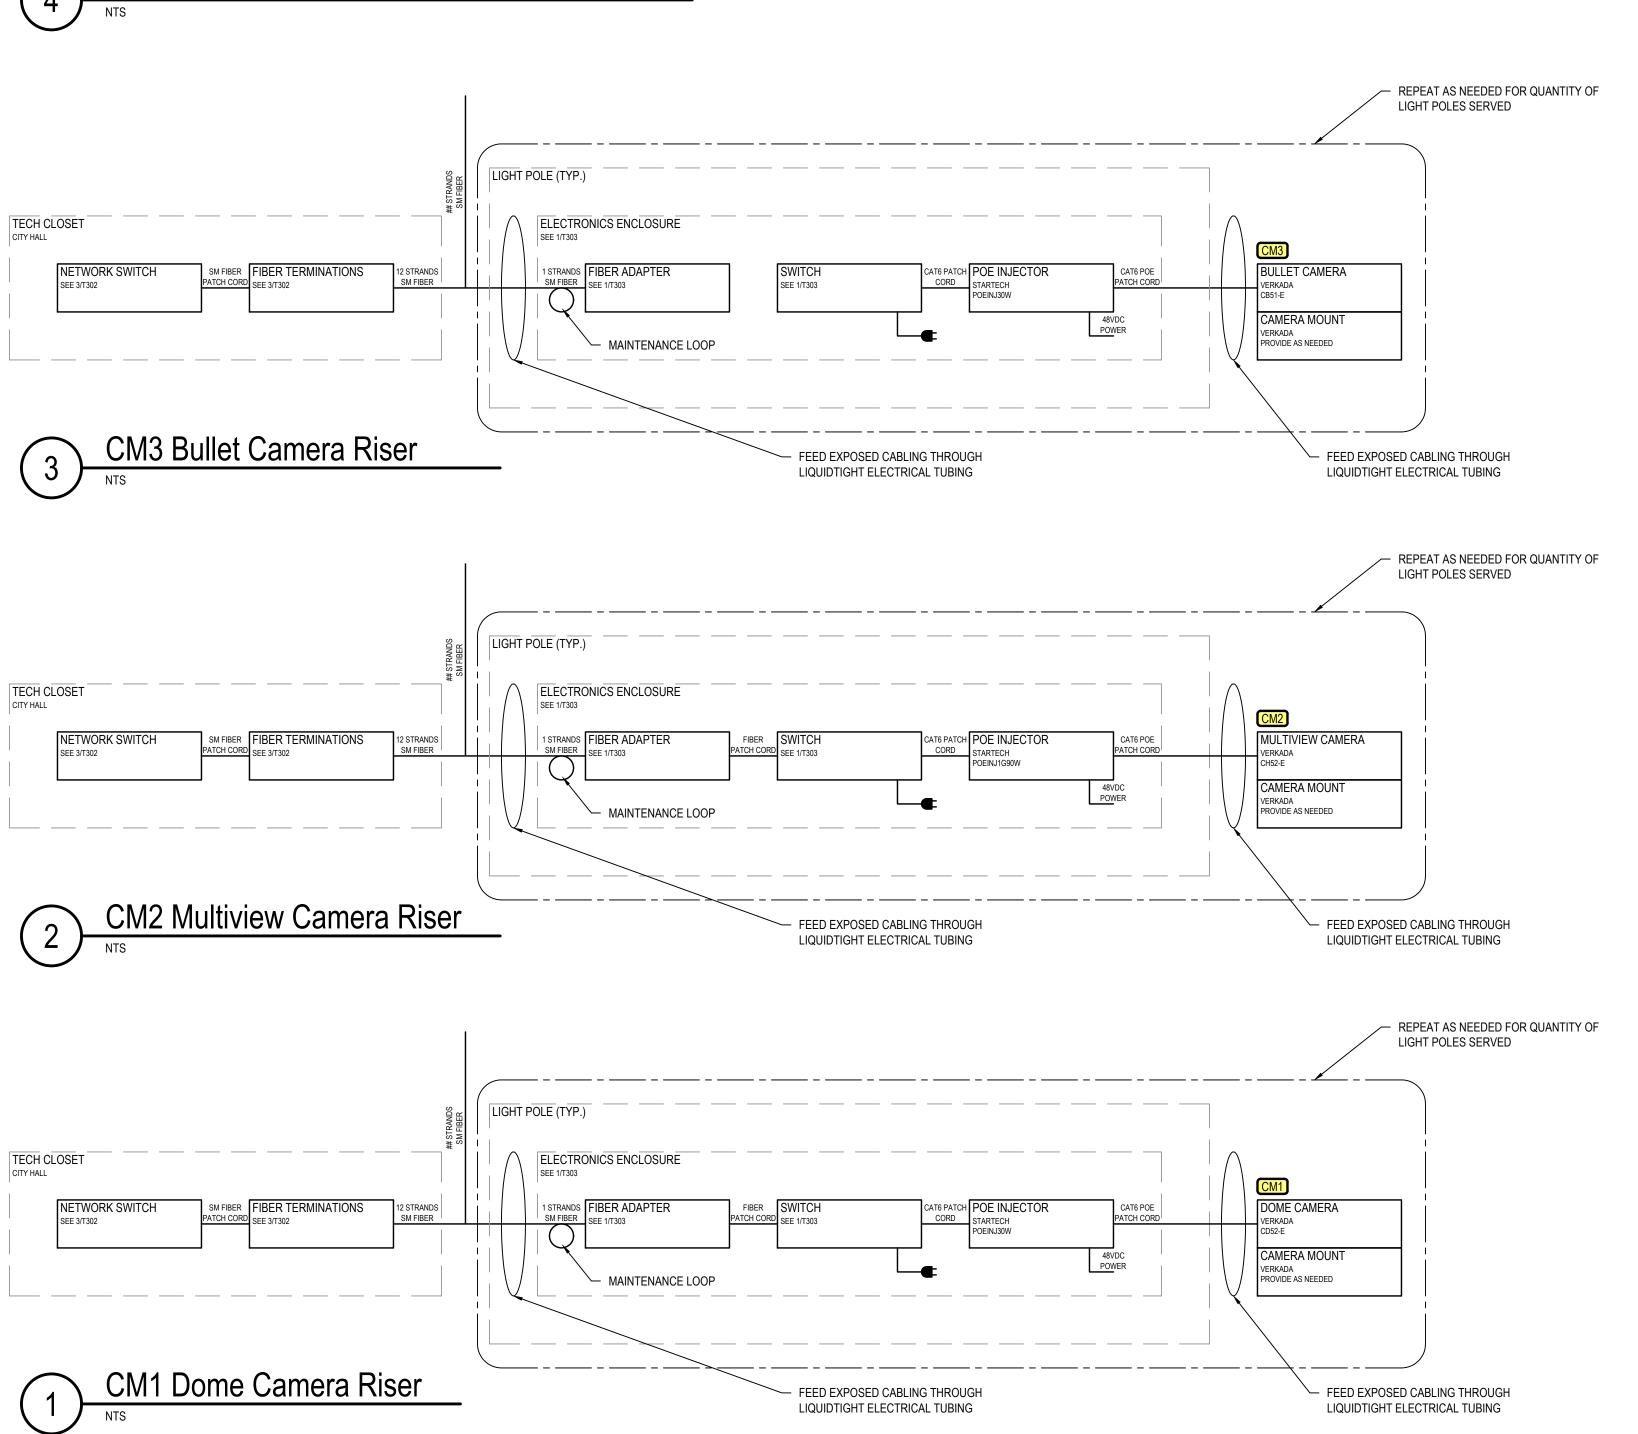
CAMERA LEGEND									
YMBOL DESCRIPTION		LIFICUT	DATA DDODG	NEW WORK		SURFACE MOUNT		NOTES	
TIVIDUL	DESCRIPTION	HEIGHT	DATA DROPS	ROUGH-IN	FACEPLATE	ROUGH-IN	FACEPLATE	ELECTRICAL	LOW VOLTAGE
CM1	DOME CAMERA	SEE NOTES	SEE T301	N/A	5/T401	N/A	5/T401		1,2
CM2	MULTIVIEW CAMERA	SEE NOTES	SEE T301	N/A	5/T401	N/A	5/T401		1,2
СМЗ	BULLET CAMERA	SEE NOTES	SEE T301	N/A	5/T401	N/A	5/T401		1,2







Exterior Building Mounted Camera Riser (TYP.)

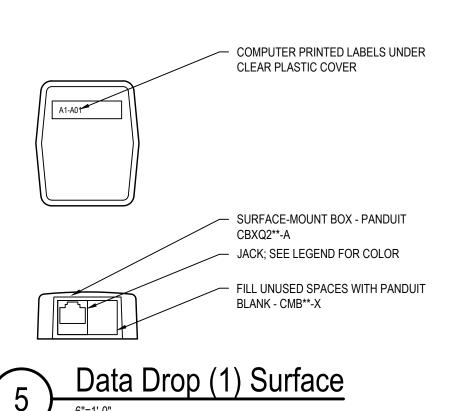


### CAMERA LEGEND NOTES

- 1. CAMERA MOUNTED ON LIGHT POLE UNLESS SHOWN OTHERWISE ON PLANS. REFER TO 2/T303 FOR POLE MOUNT APPLICATIONS.
- REFER TO CORRECT RISER BASED ON CAMERA INSTALL LOCATION. USE 4/T401 FOR BUILDING MOUNTED CAMERAS.

### CAMERA NOTES

- INSTALL AND CONFIGURE SERVER LICENSING AS NEEDED. PROVIDE ONE CAMERA LICENSE AND ONE SUPPORT LICENSE FOR EACH CAMERA INSTALLED. CONFIGURE SOFTWARE PER SPECIFICATION TO SUPPORT ALL CAMERAS.
- RELOCATE CAMERA DATA DROP AS REQUIRED FOR OPTIMAL CAMERA POSITION.
  NEATLY COIL AND SECURE ANY REMAINING MAINTENANCE LOOP TO BUILDING
- SECURE EXTERIOR CAMERAS TO BUILDING AT MINIMUM OF 144"AFF, UNLESS NOTED OTHERWISE.
- CAMERA CONTRACTOR IS RESPONSIBLE FOR DRILLING ANY HOLES THAT ARE REQUIRED TO PROVIDE PATHWAY FOR CAMERA PATCH CORDS. SEAL ALL PENETRATIONS APPROPRIATELY (REMOVABLE WATERPROOF CAULK FOR EXTERIOR WALLS, AND FIRE-PROOF PUTTY FOR FIRE-RATED WALLS).
- . CAMERA CONTRACTOR TO PROVIDE MOUNTING HARDWARE AS NEEDED BASED ON CAMERA TYPE AND MOUNTING LOCATION.
- IMPORT BUILDING FLOOR PLANS AND PLACE CAMERA ICONS TO ALLOW VIEWING SELECTION OF A GIVEN CAMERA FROM THE SOFTWARE INTERFACE.
- ASSIST THE OWNER IN LOADING AND USAGE OF VIEWING SOFTWARE ON UP TO FIVE (5) COMPUTERS AND PROVIDE ABILITY TO VIEW CAMERAS FROM A MOBILE DEVICE TO THE EXTENT POSSIBLE WITH THE SYSTEM.
- CABLING THAT ENTERS AND EXITS THE POLE-MOUNTED ENCLOSURE SHALL BE ENCLOSED IN LIQUIDTIGHT ELECTRIC TUBING AND SEALED PROPERLY AT EACH END.
- MANUFACTURERS LISTED ON DRAWINGS ARE USED AS THE BASIS OF DESIGN FOR THE VARIOUS TECHNOLOGY SYSTEMS. MANUFACTURERS OF SIMILAR QUALITY AND FEATURE SET MAY BE SUBMITTED AT TIME OF BID.

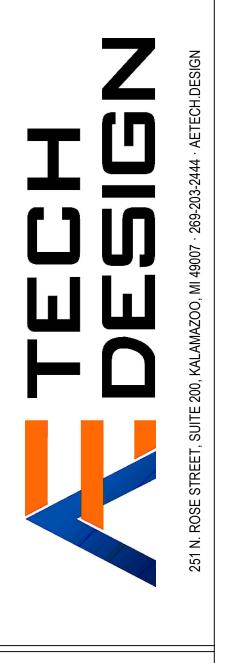

City of Greenville Downtown Greenville Technology Upgrades 411 S. Lafayette St, Greenville, MI 48838

General Information

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GREN2202-0200

SHEET NO.

PAGING LEGEND									
OVADOL DECODIDEION	LIFICUIT	DATA DDODO	NEW WORK		SURFACE MOUNT		NOTES		
SYMBOL	DESCRIPTION	HEIGHT	DATA DROPS	ROUGH-IN	FACEPLATE	ROUGH-IN	FACEPLATE	ELECTRICAL	LOW VOLTAGE
S1	SPEAKER	SEE NOTES	SEE T301	SEE ELEC. NOTES	N/A	N/A	N/A		1
/ INFORMATION TAG									

S1	SPEAKER
	FORMATION TAG


PAGING SYMBOL

# PAGING LEGEND NOTES

POLE MOUNTED. SEE DETAILS ON 2/T303.

### DISTRIBUTED SYSTEMS NOTES

- CABLING THAT ENTERS AND EXITS THE POLE-MOUNTED ENCLOSURE SHALL BE ENCLOSED IN LIQUIDTIGHT ELECTRIC TUBING AND SEALED PROPERLY AT EACH END.
- AUDINATE DANTE CONTROLLER SOFTWARE SHALL BE DOWNLOADED AND INSTALLED ON THE MINI PC IN THE TECH CLOSET.
- MANUFACTURERS LISTED ON DRAWINGS ARE USED AS THE BASIS OF DESIGN FOR THE VARIOUS TECHNOLOGY SYSTEMS. MANUFACTURERS OF SIMILAR QUALITY AND FEATURE SET MAY BE SUBMITTED AT TIME OF BID.

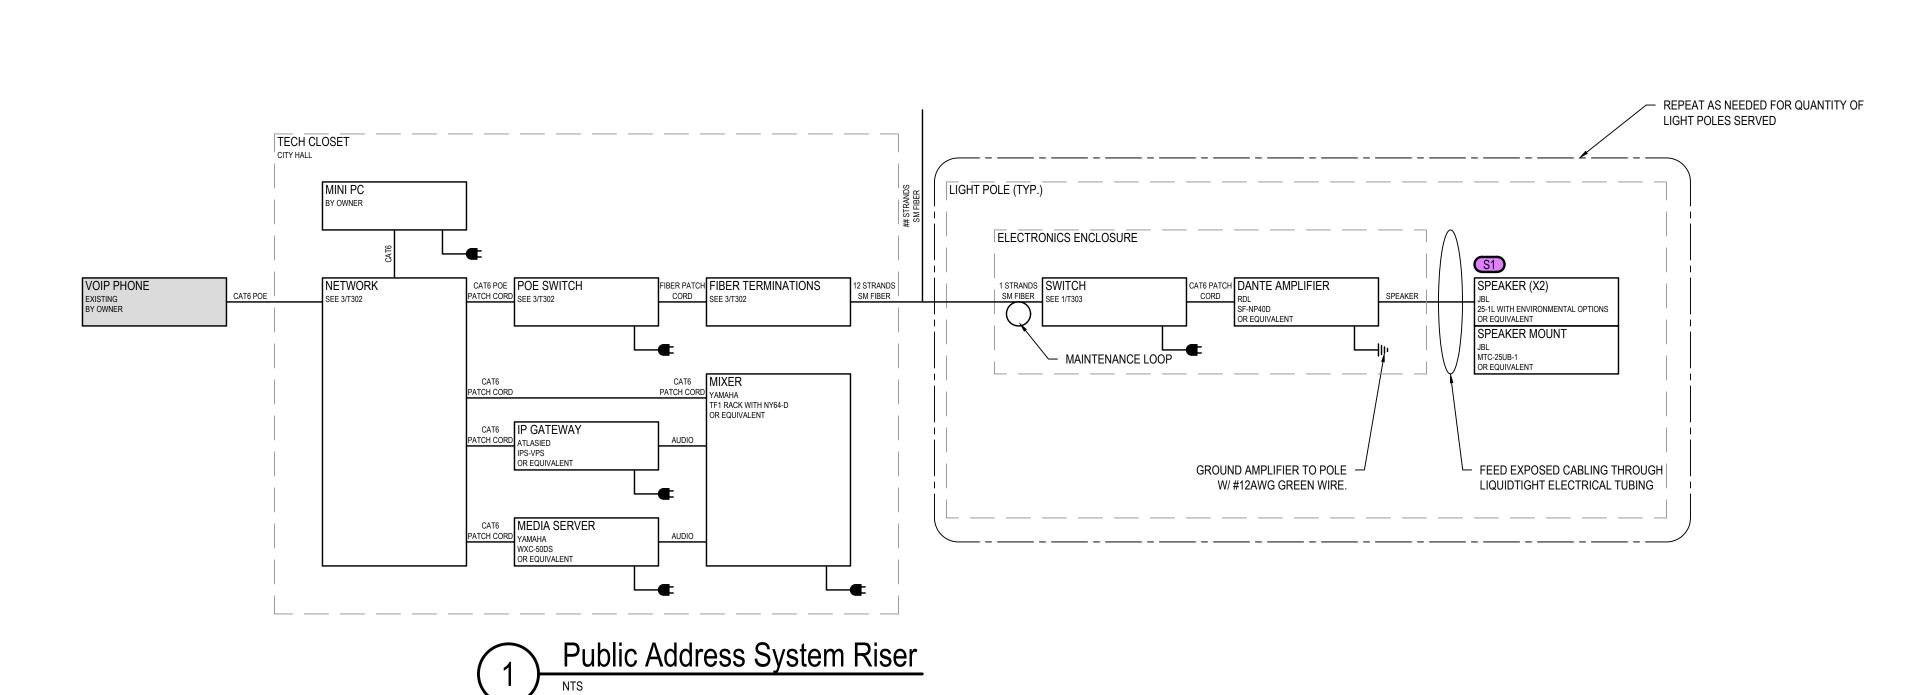

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Distributed Systems General Information ISSUE / DATE 2023-01-11 BIDS 2023-01-12 ADDENDUM 1 2023-01-18 ADDENDUM 2 2023-01-31 ADDENDUM 3

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