

# PRESIDENT AND BOARD OF TRUSTEES

Regular Meeting Monday, July 15, 2024 6:00 PM

East Dundee Police Station, 2<sup>nd</sup> Floor Meeting Room 115 E. 3<sup>rd</sup> Street, East Dundee, IL 60118

- 1. Call to Order
- 2. Roll Call Trustee Mahony
- 3. Pledge of Allegiance
- 4. Public Comment

Please keep comments to 5 minutes or less

- 5. Public Hearings:
  - a. A Request for a Variance from Section 156.04(C)(1)(a) Regarding the Maximum Number of Wall Signs for Each Business, and a Request for a Variance from Section 156.04(C)(1)(B) Regarding the Maximum Square Feet Allowed for a Business Establishment Identification Wall Sign, for the Property Located at 107 Water St., East Dundee, IL, 60118 PIN 03-23-318-007, Located in the B-1 Downtown Business District
- 6. Consent Agenda
  - a. Motion to Approve Committee of the Whole Meeting Minutes Dated June 3, 2024
  - b. Motion to Accept Warrants Lists in the Amounts of \$200,011.15 and \$630,850.56
  - c. Motion To Approve an Ordinance Authorizing Execution of a Contract for Sale of Vacant Land and Purchase of Real Property (106 S. River St.)
- 7. Other Agenda Items
  - a. Motion to Approve Findings of Fact Granting Variations from Section 156.04(C)(1) Regarding the Number of Wall Signs Allowed for Each Business and the Maximum Square Feet Allowed for a Business Establishment Identification Wall Sign Located at 107 Water Street, East Dundee, IL, 60118 PIN 03-23-318-007, Located in the B-1 Downtown Business District
  - b. Motion to Approve an Ordinance Granting Variations from Section 156.04(C)(1) Regarding the Number of Wall Signs Allowed for Each Business and the Maximum Square Feet Allowed for a Business Establishment Identification Wall Sign Located at 107 Water Street, East Dundee, IL, 60118 PIN 03-23-318-007, Located in the B-1 Downtown Business District

- c. Motion to Approve a Resolution Approving the Final Design and the Design-Build
  Amendment to the Contract Previously Executed between James McHugh Construction Co.
  and the Village of East Dundee for Design-Build Services of a Two-Level Parking Structure
  Located in the Downtown District of the Village of East Dundee
- d. Motion to Approve an Ordinance Approving and Authorizing Execution and Recording of Easement Agreements for Permanent Public Utility and Drainage Easements and Temporary Construction Easement Agreements (107 N. Van Buren Street, 308 Hill Street, 311 Jackson Street, 102 N. River Street, 104-106 N. River Street)
- e. <u>Motion to Approve an Ordinance Amending the Employee Personnel Manual Regarding</u> Holidays
- f. Motion to Advise and Consent of the Village President's Appointment of Scott Cox to the Board of Police Commissioners
- g. Motion to Advise and Consent of the Village President's Appointment of Kim Brunner to the Depot Council
- h. Motion to Advise and Consent of the Village President's Appointment of Peggy Scarpelli to the Depot Council
- 8. Village President and Board Reports
- 9. Staff Reports
- 10. Executive Session

Closed to the public and media under the provisions of the Illinois Open Meetings Act, 5ILCS, 120/2, (c)(21) Discussion of Minutes, (c)(11) Pending Litigation, (c)(1) Personnel and Legal Counsel, (c)(5) Acquisition of Property, (c)(6) Sale of Property, (c)(3) Appointments and (c)(2) Collective Negotiating Matters.

11. Adjournment

State of Illinois	)	
Counties of Cook and Kane	)	SS
Village of Fast Dundee	)	

### **NOTICE OF PUBLIC HEARING**

Notice is hereby given that the Village Board of Trustees of the Village of East Dundee will hold a public hearing on July 15, 2024, at 6:00 P.M. at the East Dundee Police Station 2<sup>nd</sup> Floor Meeting Room, 115 E. 3<sup>rd</sup> Street, East Dundee, Illinois, to consider the following request:

A request for a variance from Section 156.04(C)(1)(a) regarding the maximum number of wall signs for each business, and a request for a variance from Section 156.04(C)(1)(b) regarding the maximum square feet allowed for a business establishment identification wall sign, for the property located at 107 Water St., East Dundee, IL, 60118 PIN 03-23-318-007, located in the B-1 Downtown Business District.

PIN: 03-23-318-007

<u>Legal Description:</u> LOT 2 (EXCEPT THE SOURTHERLY 66.67 FEET THEREOF), THE SOUTHERLY 63 FEET OF LOT 3, AS MEASURED ALONG WEST LINE OF WATER STREET, OF HAERTEL'S SUBDIVISION, IN THE VILLAGE OF EAST DUNDEE, KANE COUNTY, ILLLINOIS.

All interested persons will be given an opportunity to be heard. Any questions regarding this public hearing process may be directed to Franco Bottalico, 120 Barrington Avenue, East Dundee, Illinois, 60118 via email at *FBottalico@eastdundee.net*, or by phone at (847) 815-0472.

Committee of the Whole Meeting Village of East Dundee Cook and Kane Counties, Illinois June 3, 2024

#### 1

### **CALL TO ORDER**

President Lynam calls to order the Village of East Dundee Committee of the Whole Meeting at 6:00 p.m.

### **ROLL CALL:**

Trustees Mahony, Kunze, Brittin, Treiber, Sauder, and President Lynam. Trustee Saviano was absent.

Also in attendance are Director of Public Works Phil Cotter, Assistant to the Administrator Franco Bottalico, Village Engineer Joe Heinz, Attorney Kelley Gandurski and Clerk Katherine Diehl.

**PUBLIC COMMENT: None** 

#### **AGENDA ITEMS:**

## a. Continued Discussion Regarding Regulating Food Trucks

President Lynam stated that DC Cobb's owner, Dan Hart, advised that Woodstock holds a food truck festival, and this type of event may be a workable compromise. He stated that he agrees with the idea of hosting a food truck festival in East Dundee once or twice a year. Trustee Sauder said that he likes the idea of hosting events that feature food trucks, particularly Motor Monday Cruise Night. He feels it will attract people to the village. He suggested that local businesses host food trucks that offer different foods than East Dundee restaurants do so it is noncompeting. Trustee Treiber stated that he does not see a need for food trucks as he feels there are plenty of dining opportunities with current restaurants. Trustee Kunze stated that he is fine with the pilot program plan to host food trucks for Motor Monday events and see how that goes. Trustee Mahony agrees with slowly testing food trucks in town. She added that hosting food trucks does not negate the need for an ordinance, but rather a policy. Trustee Brittin feels that a reasonable compromise this year is to host food trucks at Motor Monday and at a food truck festival.

Joe Zeller of The Distance Social addressed the Board stating that he feels food trucks will bring new visitors to the village, however, does not feel the need for food trucks on a regular basis. Colin Hagerty of Tequila Val's suggested implementing a clause that any food truck is to be stationed a minimum of 150 feet from the closest restaurant. Lucy DeLap, Motor Monday Organizer on behalf of the Village, stated that there are two types of people that attend the Motor Monday event. One group type wants to grab food and sit at a picnic table with other attendees. The other group type will park their show car and go sit down and eat at an establishment. Currently there is a hot dog/pretzel vendor and a Kona Ice truck at the event, and she feels these are great vendors for this particular event. AJ Singh of Aliano's Ristorante would like financial data to be collected from this pilot program. Julius White of DC Cobb's stated that they partner heavily with Black & Gray Brewing and are a very big part of each other's businesses. He said with all the new restaurants over the past 5 years, Black & Gray no longer feels that food trucks would be an asset to them. Marc Quattrocchi of the East Dundee Fire Department stated that the fire department's main concern is for safety. He advised that there are unregulated food trucks already operating outside of the downtown district every weekend that he alone attempts to enforce. He added that he cannot regulate a food truck that he does not know about. He stated that he just wanted to make the Board aware that they are already here in town.

## b. Discussion with Baxter & Woodman Regarding Lead Service Line Replacement

Public Works Director Cotter advised that since June of last year, with the assistance of Baxter & Woodman, the Village has completed and submitted its material service line inventory to the IEPA, with the exception of approximately 100 homes still to complete the survey. Cotter also advised that a lead service line replacement plan has also since been developed and submitted. He stated that the next objective is to develop a program for replacing lead services in the community as there are currently funds included in this fiscal year budget to do this. Next, a representative from Baxter & Woodman gave a slideshow presentation for

Committee of the Whole Meeting Village of East Dundee Cook and Kane Counties, Illinois June 3, 2024

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funding lead service line replacements.	
Motion to adjourn the Regular Village Board med Meeting Adjourns by unanimous consent.	eting at 7:28 p.m. by Brittin/Kunze.
Respectfully submitted,	
Katherine Diehl	
	By: Village President, Jeffrey Lynam
Attest:	vinage Fresident, verificy Lynam
Village Clerk, Katherine Diehl	_

						04.1.20, 202.1 11.0174
Invoice Number	Description	Invoice Date	Net Invoice Amount	Voided	GL Account Number	
ADVANCED AUT	OMATION & CONTROLS INC					
24-4512	WWTP SCADA SYSTEM	06/12/2024	303.17		60-33-5291	
Total ADVA	NCED AUTOMATION & CONTROL	S INC:	303.17			
AFLAC						
550654	AFLAC	06/26/2024	759.68		27-01-2215	
Total AFLA	C:		759.68			
ALBRECHT ENT	ERPRISES, INC.					
5317	ASBESTOS INSP	06/12/2024	750.00		32-32-5950	
5317	ASBESTOS INSP	06/12/2024	750.00		39-01-5957	
5517	ASBEST OS INSP	00/12/2024	750.00		39-01-3937	
Total ALBRI	ECHT ENTERPRISES, INC.:		1,500.00			
ALLEGRA PRINT						
70164	ANNUAL REPORT	06/21/2024	510.00	-	01-21-5340	
Total ALLEC	GRA PRINT & IMAGING:		510.00			
ARENDS HOGAN	N WALKER LLC					
11901678	MOWER REPAIR	05/24/2024	1,019.59		01-31-5130	
Total AREN	DS HOGAN WALKER LLC:		1,019.59			
AT&T						
061324	ATT W/S	06/13/2024	838.46		60-33-5320	
Total AT&T:			838.46	=		
B&F CONSTRUC	TION CODE SERVICES INC					
19385	INSPECTIONS	06/17/2024	45.00		01-25-5290	
64943	INSPECTIONS	06/13/2024	200.00		01-25-5290	
Total B&F C	CONSTRUCTION CODE SERVICE	S INC:	245.00	=		
DAYTED AND ME	OODMAN CONCULTING ENGINE	-DC				
061724	OODMAN CONSULTING ENGINE  MS4 SERVICES 260513	06/17/2024	780.00		01-31-5220	
061724	WATER SYSTEM STUDY	06/17/2024	1,696.25		60-33-5220	
	IEPA PROJECT PLAN 260510	06/17/2024	1,085.00			
061724			,		60-33-5220	
061724	WS RATE 255457/459/260511	06/17/2024	3,514.37		60-33-5220	
061724	WS RATE STUDY	06/17/2024	3,514.38		60-33-5221	
061724	GIS 260512	06/17/2024	865.00		60-33-5290	
061724	CONF RPT 260514	06/17/2024	1,200.00		60-33-5290	
061724	LEAD SERVICE 260504	06/17/2024	3,566.25		60-33-5946	
061724	LEAD SERVICE 260509	06/17/2024	1,862.50	-	60-33-5946	
Total BAXT	ER AND WOODMAN CONSULTIN	G ENGINEERS:				
			18,083.75	-		
BEVERLY MATE	RIALS INC.					
306275	STONE - MAXWELTON	06/22/2024	54.18		01-31-5140	
Total BEVE	RLY MATERIALS INC.:		54.18			
				-		

			rtoport datos: 17 17	202	72021	0411 20, 2021 11:077 11
Invoice Number	Description	Invoice Date	Net Invoice Amount	Voided	GL Account Number	
BMI LICENSING	DEPT				·	
53806404	ANNUAL LICENSE	06/02/2024	435.00		01-37-5410	
Total BMI L	ICENSING DEPT:		435.00			
BRY-AIR INC						
78067	HVAC FILTERS - WTP	06/21/2024	1,555.83		60-33-5110	
Total BRY-A	AIR INC:		1,555.83			
Buy Sell Busines	ss Brokers			•		
061324	BDD SALES TAX REBATE	06/13/2024	23,818.37		34-01-5876	
061324	311 BARRINGTON TIF REIMB #3	06/13/2024	36,237.82		39-01-5876	
Total Buy S	sell Business Brokers:		60,056.19	•		
CINTAS FIRST A	ID & SAFETY					
4196322403	FLOOR MATS - VH	06/19/2024	53.57		01-12-5110	
4196322396	MATS PD	06/19/2024	50.77		01-21-5121	
Total CINTA	AS FIRST AID & SAFETY:		104.34	•		
OLADIZ IIII I DI	•			-		
CLARK HILL PLO		00/00/0004	240.00		04 40 5000	
1451568	LEGAL SERV ADMIN	06/26/2024	310.00		01-12-5230	
1451568	LEGAL SERV PD	06/26/2024	532.50		01-21-5230	
1451568	BAIMA PENSION	06/26/2024	461.50		01-21-5230	
1451568 1451568	LEGAL SERV PW LEGAL SERV PW	06/26/2024 06/26/2024	852.00 852.00		01-31-5230 60-33-5230	
Total CLAR	K HILL PLC:		3,008.00	•		
				=		
COM ED	COMEDIAL	06/14/2024	20.60		04 24 5540	
061424	COM ED CTREETS	06/14/2024	39.60		01-31-5510	
061424	COM ED STREETS	06/14/2024	104.98	-	28-01-5510	
Total COM	ED:		144.58			
COMED						
061324	STREET LIGHTS	06/13/2024	2,002.31	-	28-01-5510	
Total COME	ED:		2,002.31			
DAVEY TREE EX	(PERT COMPANY					
918628563	MULCH	06/17/2024	169.20		01-31-5150	
918603802	TREE PRUNING	06/10/2024	780.00		01-31-5190	
Total DAVE	Y TREE EXPERT COMPANY:		949.20			
DIRECT ENERG	Y					
	STREET LIGHTS	06/01/2084	229.25		01-31-5510	
	W & WW UTILITIES	06/01/2084	9,871.01		60-33-5510	
Total DIRE	CT ENERGY:		10,100.26	-		
DUNDEE MARAT	THON			•		
5100507	PLANNING MTG ICE	06/26/2024	5.00		01-12-5630	
5100507	WDW ICE	06/12/2024	10.00		01-37-5631	
3100007		00/12/2024	10.00		5. 57 5551	

Description	Invoice Date	Net Invoice Amount	Voided	GL Account Number	
DEE MARATHON:		15.00			
AUTO DADTO					
CAP FOR TRAILER	06/14/2024	19.45		01-31-5120	
DEE NADA AUTO DARTS:		10.45			
DEL NAFA AUTO FANTS.		19.43			
UND (EAST DUNDEE) LLC	06/22/2024	A 166 67		33_01_5876	
BBB BONBEL GATETAN	00/22/2021			00 01 0010	
SERVANT FUND (EAST DUNDEE) L	LC:	4,166.67			
AN LLP					
PROF LEGAL SERV	05/31/2024	16,758.00		01-12-5230	
TIF 3 DOWNTOWN	05/31/2024	5,139.73		39-01-5230	
DD FRIEDMAN LLP:		21,897.73			
PLIES INC					
OPER SUPPLIES	06/19/2024	219.28		60-33-5630	
MRO SUPPLIES, INC:		219.28			
HOLDINGS, LLC					
UNIFORM ALLOW KM	10/10/2022	5.37		01-21-5080	
UNIFORM ALLOW KM	06/14/2024	63.96		01-21-5080	
UNIFORM ALLOW KM	06/24/2024	109.00		01-21-5080	
S PARENT HOLDINGS, LLC:		178.33			
).					
STAGE TARP	06/25/2024	180.69		01-31-5630	
HVAC FILTERS	06/13/2024	43.20		60-33-5110	
NGER, INC.:		223.89			
ICATOR INC					
VOED B&Z COINTER	06/17/2024	500.00		32-15-5948	
NITE FABRICATOR INC:		500.00			
CO.					
STREET LIGHT POLE/FIXTURE	05/23/2024	422.23		15-01-5950	
ELECTRIC CO.:		422.23			
WATER CHEMICALS	06/15/2024	160 00		60-33-5650	
W CHEMICALS	06/21/2024	3,608.82		60-33-5650	
KINS, INC.:		3,778.82			
IT					
IT SERVICES	06/12/2024	181.25		01-12-5286	
	DEE MARATHON:  AUTO PARTS CAP FOR TRAILER  DEE NAPA AUTO PARTS:  UND (EAST DUNDEE) LLC BDD DUNDEE GATEWA  SERVANT FUND (EAST DUNDEE) L  AN LLP PROF LEGAL SERV TIF 3 DOWNTOWN  DD FRIEDMAN LLP:  PLIES, INC OPER SUPPLIES  MRO SUPPLIES, INC:  HOLDINGS, LLC UNIFORM ALLOW KM UNIFORM ALLOW KM UNIFORM ALLOW KM S PARENT HOLDINGS, LLC:  STAGE TARP HVAC FILTERS  NGER, INC.:  ICATOR INC VOED B&Z COINTER  NITE FABRICATOR INC:  CO. STREET LIGHT POLE/FIXTURE  ELECTRIC CO.:  WATER CHEMICALS WATER CHEMICALS W CHEMICALS W CHEMICALS KINS, INC.:	DEE MARATHON:  AUTO PARTS CAP FOR TRAILER  DEE NAPA AUTO PARTS:  UND (EAST DUNDEE) LLC BDD DUNDEE GATEWA  DEERVANT FUND (EAST DUNDEE) LLC:  AN LLP PROF LEGAL SERV TIF 3 DOWNTOWN  DETAILS, INC DETAILS, INC DETAILS, INC:  HOLDINGS, LLC UNIFORM ALLOW KM DEFAILS, INC:  STAGE TARP HVAC FILTERS  DEATH HOLDINGS, LLC:  STAGE TARP HVAC FILTERS  DEATH HOLDINGS, LLC:  CO. STREET LIGHT POLE/FIXTURE  WATER CHEMICALS WATE	Invoice Amount	DEE MARATHON: 15.00  AUTO PARTS  CAP FOR TRAILER 06/14/2024 19.45  DEE NAPA AUTO PARTS: 19.45  UND (EAST DUNDEE) LLC  BDD DUNDEE GATEWA 06/22/2024 4,166.67  SERVANT FUND (EAST DUNDEE) LLC: 4,166.67  AN LLP  PROF LEGAL SERV 05/31/2024 16,758.00  TIF 3 DOWNTOWN 05/31/2024 5,139.73  DD FRIEDMAN LLP: 21,897.73  PLIES, INC  OPER SUPPLIES 06/19/2024 219.28  MRO SUPPLIES, INC: 219.28  MRO SUPPLIES, INC: 219.28  HOLDINGS, LLC  UNIFORM ALLOW KM 06/14/2024 63.96  UNIFORM ALLOW KM 06/14/2024 109.00  S PARENT HOLDINGS, LLC: 178.33  STAGE TARP 06/25/2024 180.69  HVAC FILTERS 06/13/2024 43.20  NGER, INC: 223.89  ICATOR INC  VOED B&Z COINTER 06/17/2024 500.00  NITE FABRICATOR INC: 500.00  CO.  STREET LIGHT POLE/FIXTURE 05/23/2024 422.23  ELECTRIC CO: 422.23  WATER CHEMICALS 06/15/2024 160.00  W CHEMICALS	DEE MARATHON: 15.00  AUTO PARTS  CAP FOR TRAILER 06/14/2024 19.45 01-31-5120  DEE NAPA AUTO PARTS: 19.45  UND (EAST DUNDEE) LLC  BDD DUNDEE GATEWA 06/22/2024 4,166.67 33-01-5876  SERVANT FUND (EAST DUNDEE) LLC: 4,166.67  AN LLP  PROF LEGAL SERV 05/31/2024 16,758.00 01-12-5230  TIF 3 DOWNTOWN 05/31/2024 5,139.73 39-01-5230  DD FRIEDMAN LLP: 21,897.73  PPLIES, INC: 219.28  HOLDINGS, LLC  UNIFORM ALLOW, - KM 10/10/2022 5.37 01-21-5080  UNIFORM ALLOW, - KM 06/14/2024 109.00 01-21-5080  UNIFORM ALLOW, - KM 06/14/2024 109.00 01-21-5080  UNIFORM ALLOW, - KM 06/14/2024 109.00 01-21-5080  S PARENT HOLDINGS, LLC: 176.33  S TAGE TARP 08/25/2024 180.69 01-31-5630  NGER, INC: 223.89  UCATOR INC  VOED BAZ COINTER 06/13/2024 43.20 60-33-5110  NGER, INC: 223.89  UCATOR INC  VOED BAZ COINTER 06/17/2024 500.00 32-15-5948  NITE FABRICATOR INC: 500.00  STREET LIGHT POLE/FIXTURE 05/23/2024 422.23 15-01-5950  ELECTRIC CO: 422.23  WATER CHEMICALS 06/15/2024 100.00 60-33-5650  WATER CHEMICALS 06/15/2024 3.608.82 60-33-5650

Invoice Number	Description	Invoice Date	Net	Voided	GL Account Number
			Invoice Amount		
04.40400	T 05D 4050	00/05/0004	70.50		04.40.5000
24-46198	IT SERVICES	06/25/2024	72.50		01-12-5286
Total HELP	ING HAND IT:		416.25		
HIGHSTAR TRAF	FIC				
5902	PED CROSSING SIGNS - RIVER	06/13/2024	842.00		01-31-5150
6128	SIGN REFLECTORS	06/25/2024	210.00		01-31-5150
6129	STREET SIGNS	06/25/2024	156.00		01-31-5150
Total HIGHS	STAR TRAFFIC:		1,208.00		
HOME DEPOT				•	
061324	CONCRETE WORK	06/13/2024	126.91		01-31-5630
061324	VILLAGE HALL	06/13/2024	30.54		32-15-5948
061324	WW CAMERAS	06/13/2024	399.98		60-33-5111
061324	WASTEWATER OPER SUPPLIE	06/13/2024	145.61		60-33-5630
Total HOME	E DEPOT:		703.04		
TOTAL TIONIE	DEI OI.		703.04	:	
ILLINOIS GOVER	RNMENT FINANCE OFFICERS				
20752	COA REV FY2023	06/26/2024	460.00		01-14-5410
3154076	IGFOA TRAINING	06/17/2024	315.00		01-14-5430
Total ILLING	DIS GOVERNMENT FINANCE OFFI	CERS:	775.00		
				•	
ILLINOIS MUNIC		00/04/0000	205.00		04.44.5400
062624	IML TIF SEMINAR	06/24/2026	225.00		01-14-5430
Total ILLING	DIS MUNICIPAL LEAGUE:		225.00		
ILLINOIS PUBLIC		00/40/0004	742.00		04 40 5500
91511	W/C ADMIN W/C FIN	06/13/2024 06/13/2024	743.90		01-12-5520
91511	W/C PIN W/C PD		374.45		01-14-5520
91511 91511	W/C PD W/C BLDG	06/13/2024 06/13/2024	4,343.62 374.45		01-21-5520 01-25-5520
91511	W/C BLDG W/C W/S	06/13/2024	748.90		01-31-5520
	W/C W/S	06/13/2024			60-33-5520
91511	VV/C FVV	00/13/2024	898.68		00-33-3320
Total ILLING	DIS PUBLIC RISK FUND:		7,484.00		
J.G. UNIFORMS,	INC				
132343	UNIFORM	06/21/2024	750.65		01-21-5080
43353	UNIFORM	06/21/2024	85.00		01-21-5080
				•	
Total J.G. U	INIFORMS, INC:		835.65		
JOHNSON RESE	ARCH GROUP				
2183	TIF ANALYSIS	06/18/2024	5,062.50		38-01-5290
Total JOHN	SON RESEARCH GROUP:		5,062.50		
KANE COUNTY	CHIEFIC OF BOLLOF ACCOUNTS			•	
1672	TASK FORCE ANNUAL	06/14/2024	750.00		01-21-5410
1012	IAGN I ONGE ANNUAL	00/14/2024	750.00		0 1-2 1-0 <del>4</del> 10
Total KANE	COUNTY CHIEF'S OF POLICE ASS	SOCIATIO:	750.00		
			-	•	

Invoice Number	Description		Invoice Date	Net Invoice Amount	Voided	GL Account Number	
M.E. SIMPSON C	COMPANY INC						
42580	VALVE EXERCISING PROC	GRAM	06/26/2024	10,560.00		60-33-5140	
Total M.E. S	SIMPSON COMPANY INC:			10,560.00			
MIDWEST SALT							
474905	COARSE SALT		06/20/2024	3,300.96		60-33-5650	
Total MIDW	/EST SALT:			3,300.96			
NORTH EAST M	ULTI-REGIONAL TRAINING						
356712	TRAINING RS		06/18/2024	325.00		01-21-5430	
Total NOR1	TH EAST MULTI-REGIONAL T	TRAININ	IG:	325.00			
NORTHWESTER	RN MEDICINE OCCUPATION	AL HEAI	LT				
053124	5514767 552100		05/31/2024	248.00		01-21-5240	
053124	552374551467 552100		05/31/2024	344.00		01-31-5240	
053124	5514767 552100		05/31/2024	130.00		60-33-5240	
Total NOR1	THWESTERN MEDICINE OC	CUPATIO	ONAL HEALT:				
				722.00			
ORANGE CRUSI	н						
109797	ASPHALT	DISPO	05/31/2024	50.00		01-31-5570	
109823	ASPHALT	DISPO	05/31/2024	50.00		01-31-5570	
Total ORAN	NGE CRUSH:			100.00			
PADDOCK PUBL	LICATIONS, INC						
293914	PUBLIC HEARING NOTICE	Ξ	06/23/2024	66.70		01-25-5330	
Total PADD	OOCK PUBLICATIONS, INC:			66.70			
RALPH HELM, IN	NC						
396529	CHAIN SAW		06/18/2024	32.28		01-31-5130	
396530	CHAIN SAWS		06/18/2024	47.98		01-31-5130	
Total RALP	PH HELM, INC:			80.26			
RAY O'HERRON	CO. INC						
2348303	AMMUNITION		06/11/2024	804.00		01-21-5430	
2350515	SUPPLIES		06/22/2024	1,390.00		01-21-5430	
Total RAY (	O'HERRON CO. INC:			2,194.00			
RC CUSTOM PA	INTING						
1385	DEPOT PAINTING		06/19/2024	1,550.00		34-01-5945	
Total RC C	USTOM PAINTING:			1,550.00			
REVIZE LLC							
	WEBSITE HOSTING & MA	INTEN	06/12/2024	1,900.00		01-12-5615	
18585	WEDSITE HOSTING & WA		00/12/2021				
18585 Total REVIZ			00/12/2021	1,900.00			

			rtoport datoo. 17 17	2021771	72021	0411 20, 2021 11.077 W
Invoice Number	Description	Invoice Date	Net Invoice Amount	Voided	GL Account Number	
BURGO						
RUSSO						
20039028	BLOWER REPAIR	06/19/2024	369.03		01-31-5130	
20741436	MOWER OIL	06/19/2024	15.98		01-31-5130	
Total RUSS	SO:		385.01			
STAPLES ADVA	NTAGE					
7000740216	OFFICE SUPP,LIES	05/25/2024	128.22		01-21-5610	
Total STAP	LES ADVANTAGE:		128.22			
SUMMIT SQUAR	RE ASSOCIATION					
062524	ASSOCIATION DUES	06/25/2024	1 010 27		01-12-5410	
002324	ASSOCIATION DUES	00/23/2024	1,910.27		01-12-3410	
Total SUMN	MIT SQUARE ASSOCIATION:		1,910.27			
THOMPSON ELE	EVATOR SERVICE					
24-1223	ELEV INSP	06/17/2024	50.00		01-01-1112	
Total THON	IPSON ELEVATOR SERVICE:		50.00			
III INE						
<b>ULINE</b> 179589563	VH SUPPLIES	06/19/2024	713.06		01-12-5630	
Total ULINE	≣:		713.06			
VERIZON WIREL	FSS					
9966252640	VERIZON ADMIN	06/10/2024	95.50		01-12-5320	
9966252640	VERIZON FIN	06/10/2024	95.27		01-14-5320	
9966252640	VERIZON B&Z	06/10/2024	59.27		01-25-5320	
9966252640	VERIZON SWR/WTR	06/10/2024	324.86		01-31-5320	
9966252640	VERIZON PW	06/10/2024	151.74		60-33-5320	
9966616425	W/WW DIALER MODEMS	06/14/2024	37.16		60-33-5320	
Total VERIZ	ZON WIRELESS:		763.80			
WEX INC						
070124	FUEL CHARGES PD	07/01/2024	2,714.60		01-21-5620	
070124	B&Z FUEL	07/01/2024	58.46		01-25-5620	
070124	FUEL CHARGES PW	07/01/2024	1,686.72		01-31-5620	
070124	FUEL CHARGES WS	07/01/2024	1,739.71		60-33-5620	
Total WEX	INC:		6,199.49			
WILSON NURSE		06/04/0004	440.00		04 24 5400	
448786	PARKWAY TREE	06/24/2024	412.00		01-31-5190	
Total WILS	ON NURSERIES INC:		412.00			
ZELLER CREATI	VE GROUP					
24117	BANNERS	06/12/2024	6,600.00		34-01-5954	
Total ZELLI	ER CREATIVE GROUP:		6,600.00			
ZINGRONE ARC	HTECTS. PLLC					
1033	110 RAILROAD SITE PLAN	06/11/2024	11,500.00		39-01-5290	

VILLAGE OF EAST DU				July 1, 20 2024-7/1		Page: 7 Jun 28, 2024 11:57AM
Invoice Number	Description	Invoice Date	Net Invoice Amount	Voided	GL Account Number	
Total ZINGRONE	ARCHTECTS, PLLC:		11,500.00			
Grand Totals:			200,011.15			

### Report Criteria:

Detail report.

Invoices with totals above \$0.00 included.

Paid and unpaid invoices included.

			•			
Invoice Number	Description	Invoice Date	Net Invoice Amount	Voided	GL Account Number	
ACE HARDWAR	<b>E</b>					
063024	BOLTS & TWINE	06/30/2024	24.53		01-31-5630	
063024	HVAC FILTERS	06/30/2024	15.96		60-33-5110	
063024	OPER SUPPLIES	06/30/2024	5.48		60-33-5630	
063024	TAPE MEASURE	06/30/2024	44.99		60-33-5640	
003024	TAPE MEASONE	00/30/2024	44.99		00-33-3040	
Total ACE I	HARDWARE:		90.96			
	TOMATION & CONTROLS INC					
24-4536	WWTP SCADA SYSTEM	06/27/2024	240.00		60-33-5291	
Total ADVA	NCED AUTOMATION & CONTROLS	INC:	240.00			
ALGONQUIN WE	ELDING LLC					
339	WELD STREET LIGHT POLE	06/27/2024	350.00		01-31-5150	
Total ALGC	DNQUIN WELDING LLC:		350.00			
AMAI GAMATED	BANK OF CHICAGO			•		
1856161009 07		07/01/2024	475.00		39-01-5810	
Total AMAL	GAMATED BANK OF CHICAGO:		475.00			
AMERICAN I EG	AL PUBLISHING CORPORATION					
34845	CODE UP-DATE	06/30/2024	50.00		01-12-5260	
34951	CODES & ORDINANCE UPDATE	06/30/2024	3,128.63		01-12-5260	
Total AMEF	RICAN LEGAL PUBLISHING CORPO	RATION:	3,178.63	•		
BATEMAN LAW	OFFICES LTD			•		
070924	EDPD AA HEARING	07/09/2024	285.00		01-21-5230	
070924	AA BUILDING	07/09/2024	142.50		01-25-5230	
070324	AA BOILDING	01103/2024	142.50		01-20-0200	
Total BATE	MAN LAW OFFICES, LTD:		427.50			
BEVERLY MATE	RIALS INC.					
307009	IL 25 - WATER MAIN BREAK	07/06/2024	653.32		60-33-5140	
Total BEVE	ERLY MATERIALS INC.:		653.32			
BLUE CROSS B	LUE SHIELD					
070124	BCBS ADMIN	07/01/2024	3,882.28		01-12-5060	
070124	BCBS FIN	07/01/2024	1,000.57		01-14-5060	
070124	BCBS PD	07/01/2024	28,925.50		01-21-5060	
070124	BCBS BLDG	07/01/2024	1,809.35		01-25-5060	
070124	BCBS PW	07/01/2024	6,507.24		01-31-5060	
070124	BCBS EMP CONTRIB	07/01/2024	5,138.68		27-01-2207	
070124	BCBS RETIREES	07/01/2024	6,021.27		27-01-2210	
070124	BCBS WTR/SWR	07/01/2024	8,144.85		60-33-5060	
Total BLUE	CROSS BLUE SHIELD:		61,429.74			
CASSIDY TIRE 8	& SERVICE					
<b>CASSIDY TIRE 8</b> 922023179	SERVICE SKID STEER TIRES	06/26/2024	839.50		01-31-5120	

		Г	report dates. 1/15/	/2024-//1	5/2024	Jul 11, 2024	10.32AW
Invoice Number	r Description	Invoice Date	Net Invoice Amount	Voided	GL Account Number		
Total CAS	SIDY TIRE & SERVICE:		1,679.00	-			
				-			
CINTAS FIRST		05/00/0004	52.57		04 40 5440		
4192058076 4197666552	FLOOR MATS - VH MATS - VH	05/08/2024 07/02/2024	53.57 53.57		01-12-5110 01-12-5110		
4197666565	MATS PD	07/02/2024	50.77		01-21-5121		
Total CINT	AS FIRST AID & SAFETY:		157.91	-			
CIVIC SYSTEMS	S			-			
25002	FINANCE/UB SOFTWARE SUPP	06/27/2024	3,597.50		01-14-5286		
25002	NEW FINANCE/UB SO	06/27/2024	3,597.50	-	60-33-5286		
Total CIVIO	C SYSTEMS:		7,195.00	_			
COMED							
062924	STREET LIGHTS	06/29/2024	1,281.22	-	28-01-5510		
Total COM	IED:		1,281.22				
COVERALL NO	RTH AMERICA DBA						
1010730995	CLEANING VH	07/01/2024	329.00		01-12-5110		
1010730995	CLEANING POLICE	07/01/2024	1,410.00		01-21-5121		
1010730995	CLEANING PW 446 ELGIN AVE	07/01/2024	95.00		01-31-5110		
1010730995	CLEANING DEPOT	07/01/2024	95.00		01-31-5196		
1010730995	CLEANING PW PRAIRIIE LAKE	07/01/2024	236.00		60-33-5110		
1010730995	CLEANING PW 401 ELGIN AVE	07/01/2024	236.00	_	60-33-5111		
Total COV	ERALL NORTH AMERICA DBA:		2,401.00	_			
CREATIVE PRO	MOTIONAL APPAREL						
18974	PW LOGO ON ITEMS	07/09/2024	56.88		01-31-5080		
18974	PW LOGO ON ITEMS	07/09/2024	56.87		60-33-5080		
Total CRE	ATIVE PROMOTIONAL APPAREL:		113.75	_			
CURRENT TEC	HNOLOGIES						
734731	SUPPORT	06/28/2024	123.75	-	01-21-5286		
Total CUR	RENT TECHNOLOGIES:		123.75	-			
DAVEY TREE E	XPERT COMPANY						
918673051	PARKWAY TREE REMOVALS	06/28/2024	3,900.00		01-31-5190		
Total DAVI	EY TREE EXPERT COMPANY:		3,900.00	_			
DUNDEE LAND	SCAPE CONSTRUCTION						
7178	LANDSCAPE MAINT	06/26/2024	800.00		01-31-5110		
Total DUN	DEE LANDSCAPE CONSTRUCTION:	:	800.00	-			
DUNDEE NAPA	AUTO PARTS						
480688	TRUCK WASH SOAP	06/27/2024	10.23	-	01-31-5630		
Total DUN	DEE NAPA AUTO PARTS:		10.23				
				-			

		11	eport dates. 1/13/	2024-1/1	3/2024	Jul 11, 2024 10.	.52
Invoice Number	Description	Invoice Date	Net Invoice Amount	Voided	GL Account Number		
FAST DUNDEF I	POLICE PENSION FUND						
71024	1ST POLICE PENSION PAYMEN	07/10/2024	386,260.87		01-21-5055		
Total EAST	T DUNDEE POLICE PENSION FUND:		386,260.87	•			
ELGIN KEY & LO	OCK CO INC						
240967	KEY FOR BRANDISS OFFICE	06/27/2024	3.30		01-12-5110		
Total ELGII	N KEY & LOCK CO. INC.:		3.30	•			
ELWIRA REICHV	WEIN		-	-			
1745000	CLOSED ACCT PAYMENT	07/10/2024	62.70		99-00-1005		
Total ELWI	IRA REICHWEIN:		62.70	•			
EMPLOYEE BEN	NEFITS CORP			•			
4468449	FLEX PLAN	05/05/2024	60.00		01-12-5060		
4506549	FLEX PLAN	06/15/2024	60.00		01-12-5060		
Total EMPL	LOYEE BENEFITS CORP:		120.00				
ENTERPRISE FI	M TRUST						
060524	PD MAINT ON LEASE	07/08/2024	210.96		01-21-5120		
070324	PD MAINT ON LEASE	07/08/2024	200.00		01-21-5120		
060524	PD MAINT MGMT ON LEASE	07/08/2024	6,280.35		01-21-5280		
060524	NEW PD VEHICLES TO LEASE	07/08/2024	22,015.01		01-21-5280		
070324	PD LEASE VEH	07/08/2024	5,265.17		01-21-5280		
Total ENTE	ERPRISE FM TRUST:		33,971.49				
FASTSIGNS							
97-65765	DEPOT MARKET SIGN	07/08/2024	427.00		01-37-5340		
97-65775	BOIL ORDER SIGNS	07/03/2024	195.00		60-33-5630		
Total FAST	TSIGNS:		622.00				
FEHR GRAHAM							
123956	IDOT FOLLOW UP	06/28/2024	77.00	-	38-01-5220		
Total FEHF	R GRAHAM:		77.00				
GALLS PARENT	THOLDINGS, LLC						
28396021	UNIFORM ALLOW	07/02/2024	158.50		01-21-5080		
Total GALL	LS PARENT HOLDINGS, LLC:		158.50	•			
GOLD SHIELD F	DETECTIVE AGENCY, INC		_				
2247	BG CHECK	04/19/2024	1,161.80		01-21-5290		
Total GOLE	D SHIELD DETECTIVE AGENCY, INC	:	1,161.80				
		:	1,161.80				
	D SHIELD DETECTIVE AGENCY, INC:  CH COMPANY, INC  COPIER SERVICE -PD		1,161.80		01-21-5340		
GORDON FLES	CH COMPANY, INC	07/12/2024 07/12/2024			01-21-5340 60-33-5340		

Total GOVERNMENT   FINANCE OFFICES ASSOCIATION   1900   1914   1900				<u>'</u>			,
COVERNMENT FINANCE OFFICES ASSOCIATION 20752 CAR REV FEE 08:2800:24 480.00 01-14-5210 315-0076 BUDGET TRAINING 08-17/2024 315.00 01-14-5210 20562 CAR REV FEE 08:2800-2004 315.00 01-14-5210 20562 CAR REV FEE 08:2800-2004 315.00 01-14-5430 20562 CAR REV FEE 08:2800-2004 315.00 01-14-5430 20562 CAR REV FEE 08:2800-2004 315.00 01-14-5430 20562 CAR REV FEE 08:2800-2004 275.00	Invoice Number	Description	Invoice Date		Voided	GL Account Number	
COVERNMENT FINANCE OFFICES ASSOCIATION 20752 CAR REV FEE 08:2800:24 480.00 01-14-5210 315-0076 BUDGET TRAINING 08-17/2024 315.00 01-14-5210 20562 CAR REV FEE 08:2800-2004 315.00 01-14-5210 20562 CAR REV FEE 08:2800-2004 315.00 01-14-5430 20562 CAR REV FEE 08:2800-2004 315.00 01-14-5430 20562 CAR REV FEE 08:2800-2004 315.00 01-14-5430 20562 CAR REV FEE 08:2800-2004 275.00	Total GORF	DON FI ESCH COMPANY INC		600.71	-		
2017-52	Total Cort	TOTAL ELECTRIC COMM 7 MAIL, MAG.			-		
Total GOVERNMENT FINANCE OFFICES ASSOCIATION:   775.00							
Total GOVERNMENT FINANCE OFFICES ASSOCIATION: 775.00							
Company   Comp	3154076	BUDGET TRAINING	06/17/2024	315.00	-	01-14-5430	
December   Total GRIFFIN WILLIAMS MCMAHON & WALSH LLP:   750.00	Total GOVE	ERNMENT FINANCE OFFICES ASSO	OCIATION:	775.00			
Total GRIFFIN WILLIAMS MCMAHON & WALSH LLP: 750.00  HABH ELECTRIC CO.  438966 STREET LIGHT TROUBLESHOO 02/01/2124 1,797.61 01-31-6150  Total H&H ELECTRIC CO: 4,280.84  HEINZ, GERALD & ASSOC.  121279 MISC ENGINEERING 07/05/2024 2,541.00 01-12-5220  121273 VH PARKING LOT 07/05/2024 162.00 01-12-5220  121279 BEVERLY UTIL EXT 07/05/2024 160.00 01-12-5220  121279 DAY THE RETINGATION AVE 07/05/2024 160.00 01-12-5220  121270 FAU STP BARRINGTON AVE 07/05/2024 160.00 01-12-5220  121271 20/4 STREET PROGRAM 07/05/2024 161.00 01-12-5220  121272 PENNY BOIRT 88 07/05/2024 160.00 85-01-2031  121272 PENNY BOIRT 88 07/05/2024 160.00 85-01-2395  121271 SOP HEALY 07/05/2024 120.00 85-01-2395  121276 DAVEY TREE 07/05/2024 120.00 85-01-2403  121277 DOI HEINZ, GERALD & ASSOC: 7,968.00  HELPING HAND IT  24-46215 IT SERVICES 07/01/2024 36.25 01-12-5286  Total HEINZ, GERALD & ASSOC: 35-91  Total HEINZ, GERALD & CONSCILLATER 07/06/2024 42.99 01-12-5286  Total HELPING HAND IT: 3.591.83  HINCKLEY SPRINGS  22907757 07/06 VH WATER 07/06/2024 42.99 01-12-5530  Total HINCKLEY SPRINGS: 236-49  HOUSE OF DOORS: 452.64  HULLIOUS ENVIRONMENTAL PROTECTION AGENCY 400329 A M54 PERMIT 06/18/2024 17.500.00 01-31-5591  LEICH ON A M54 PERMIT 1 END PROMETER 06/18/2024 17.500.00 01-31-5591  LEICH ON A M54 PERMIT 1 END PROMETER 06/18/2024 17.500.00 01-31-5591	GRIFFIN WILLIA	MS MCMAHON & WALSH LLP					
HABELECTRIC CO.  43866 STREET LIGHT TROUBLESHOO 02/01/2124 1,797.61 01-31-5150 01-31-510 01-31	20369	LOCAL PROSECUTIONS	07/01/2024	750.00		01-21-5230	
4886 STREET LIGHT TROUBLESHOO 02/01/21/24 1,797.61 01:31-5150  TOTAL HAM ELECTRIC CO: 4.280.84  HENZ, GERALD & ASSOC. 21269 MISC ENGINEERING 07/05/2024 2,541.00 01:12-5220 21273 VH PARKING LOT 07/05/2024 2,541.00 01:12-5220 21279 BEVERLY UTILEXT 07/05/2024 16:2.00 01:31-5520 21277 PARKING LOT 07/05/2024 16:2.00 01:31-5220 21277 2024 STREET PROGRAM 07/05/2024 16:2.00 01:31-5220 21277 2024 STREET PROGRAM 07/05/2024 81:0.00 32:31-6090 21272 PENNY RDIRTES 07/05/2024 81:0.00 85-01-2378 21272 PENNY RDIRTES 07/05/2024 81:0.0 85-01-2378 21272 PENNY RDIRTES 07/05/2024 16:2.00 85-01-2378 21272 DAMEY TREE 07/05/2024 16:2.00 85-01-2378 21272 DAMEY TREE 07/05/2024 16:2.00 85-01-2403 21272 DAMEY TREE 07/05/2024 16:2.00 85-01-2403 21273 OC LAB 07/05/2024 16:2.00 85-01-2403 21274 SQ HEALD SASSOC: 7,968.00 85-01-2403 21275 DAMEY TREE 07/05/2024 25:3.00 85-01-2403 21276 DAMEY TREE 07/05/2024 25:3.00 85-01-2403 21277 TOTAL HEINS HADD IT: 3,591.63  TOTAL HELPING HAND IT: 3,591.63  HINCKLEY SPRINGS: 236.49  HINCKLEY SPRINGS: 236.49  HOUSE OF DOORS: 425.64  HOUSE OF DOORS: 452.64  HULLINOIS ENVIRONMENTAL PROTECTION AGENCY 400329 A M54 PERMIT FEES 06/18/2024 1,000.0 01-31-5591 100029 A M54 PERMIT 06/18/2024 1,000.0 01-31-5591 100029 A M54 PERMIT 06/18/2024 1,000.0 01-31-5591 100029 A M54 PERMIT 06/18/2024 1,000.0 01-31-5591	Total GRIFF	FIN WILLIAMS MCMAHON & WALSH	HLLP:	750.00	_		
4886 STREET LIGHT TROUBLESHOO 02/01/21/24 1,797.61 01:31-5150  TOTAL HAM ELECTRIC CO: 4.280.84  HENZ, GERALD & ASSOC. 21269 MISC ENGINEERING 07/05/2024 2,541.00 01:12-5220 21273 VH PARKING LOT 07/05/2024 2,541.00 01:12-5220 21279 BEVERLY UTILEXT 07/05/2024 16:2.00 01:31-5520 21277 PARKING LOT 07/05/2024 16:2.00 01:31-5220 21277 2024 STREET PROGRAM 07/05/2024 16:2.00 01:31-5220 21277 2024 STREET PROGRAM 07/05/2024 81:0.00 32:31-6090 21272 PENNY RDIRTES 07/05/2024 81:0.00 85-01-2378 21272 PENNY RDIRTES 07/05/2024 81:0.0 85-01-2378 21272 PENNY RDIRTES 07/05/2024 16:2.00 85-01-2378 21272 DAMEY TREE 07/05/2024 16:2.00 85-01-2378 21272 DAMEY TREE 07/05/2024 16:2.00 85-01-2403 21272 DAMEY TREE 07/05/2024 16:2.00 85-01-2403 21273 OC LAB 07/05/2024 16:2.00 85-01-2403 21274 SQ HEALD SASSOC: 7,968.00 85-01-2403 21275 DAMEY TREE 07/05/2024 25:3.00 85-01-2403 21276 DAMEY TREE 07/05/2024 25:3.00 85-01-2403 21277 TOTAL HEINS HADD IT: 3,591.63  TOTAL HELPING HAND IT: 3,591.63  HINCKLEY SPRINGS: 236.49  HINCKLEY SPRINGS: 236.49  HOUSE OF DOORS: 425.64  HOUSE OF DOORS: 452.64  HULLINOIS ENVIRONMENTAL PROTECTION AGENCY 400329 A M54 PERMIT FEES 06/18/2024 1,000.0 01-31-5591 100029 A M54 PERMIT 06/18/2024 1,000.0 01-31-5591 100029 A M54 PERMIT 06/18/2024 1,000.0 01-31-5591 100029 A M54 PERMIT 06/18/2024 1,000.0 01-31-5591	H&H ELECTRIC	CO.					
### A SASOC			02/01/2124	1,797.61		01-31-5150	
HEINZ, GERALD & ASSOC.  21269 MISC ENGINEERING 07/05/2024 1,762.00 01-12-5220 21273 VH PARKING LOT 07/05/2024 2,541.00 01-25-5220 21270 FAU STP BARRINGTON AVE 07/05/2024 180.00 01-25-5220 21270 FAU STP BARRINGTON AVE 07/05/2024 180.00 01-25-5220 21277 2024 STREET PROGRAM 07/05/2024 180.00 32-31-6090 21277 2034 STREET PROGRAM 07/05/2024 810.00 32-31-6090 21277 590 HEALY 07/05/2024 180.00 85-01-2031 21272 PENNY RD/RT 68 07/05/2024 180.00 85-01-2318 21271 590 HEALY 07/05/2024 180.00 85-01-2318 21278 OC LAB 07/05/2024 1296.00 85-01-2395 21278 OC LAB 07/05/2024 1,296.00 85-01-2403 21278 Total HEINZ, GERALD & ASSOC: 7,968.00  HELPING HAND IT 24-46215 IT SERVICES 06/27/2024 253.75 01-12-5286 24-46399 IT SERVICES 07/10/2024 253.75 01-12-5286 24-46399 IT SERVICES 07/10/2024 33.01.63 01-12-5286 24-46409 IT SERVICES 07/05/2024 12.96.00  HINCKLEY SPRINGS 239407575 7070 VH WATER 07/06/2024 42.59 01-12-5286 23940544 0706 PD WATER 07/06/2024 158.04 01-21-6630 23840544 0706 PD WATER 07/06/2024 35.86 01-31-5630 Total HINCKLEY SPRINGS: 236.49  HOUSE OF DOORS 22206 SPECIAL EVENTS GARAGE 05/31/2024 452.64  Total HOUSE OF DOORS: 452.64  HILINOIS ENVIRONMENTAL PROTECTION AGENCY 400329 A MS4 PERMIT EES 06/18/2024 17,500.00 01-31-5591 10-31-5591 1							
HEINZ, GERALD & ASSOC.  21269 MISC ENGINEERING 07/05/2024 1,762.00 01-12-5220 21273 VH PARKING LOT 07/05/2024 2,541.00 01-25-5220 21270 FAU STP BARRINGTON AVE 07/05/2024 180.00 01-25-5220 21270 FAU STP BARRINGTON AVE 07/05/2024 180.00 01-25-5220 21277 2024 STREET PROGRAM 07/05/2024 180.00 32-31-6090 21277 2034 STREET PROGRAM 07/05/2024 810.00 32-31-6090 21277 590 HEALY 07/05/2024 180.00 85-01-2031 21272 PENNY RD/RT 68 07/05/2024 180.00 85-01-2318 21271 590 HEALY 07/05/2024 180.00 85-01-2318 21278 OC LAB 07/05/2024 1296.00 85-01-2395 21278 OC LAB 07/05/2024 1,296.00 85-01-2403 21278 Total HEINZ, GERALD & ASSOC: 7,968.00  HELPING HAND IT 24-46215 IT SERVICES 06/27/2024 253.75 01-12-5286 24-46399 IT SERVICES 07/10/2024 253.75 01-12-5286 24-46399 IT SERVICES 07/10/2024 33.01.63 01-12-5286 24-46409 IT SERVICES 07/05/2024 12.96.00  HINCKLEY SPRINGS 239407575 7070 VH WATER 07/06/2024 42.59 01-12-5286 23940544 0706 PD WATER 07/06/2024 158.04 01-21-6630 23840544 0706 PD WATER 07/06/2024 35.86 01-31-5630 Total HINCKLEY SPRINGS: 236.49  HOUSE OF DOORS 22206 SPECIAL EVENTS GARAGE 05/31/2024 452.64  Total HOUSE OF DOORS: 452.64  HILINOIS ENVIRONMENTAL PROTECTION AGENCY 400329 A MS4 PERMIT EES 06/18/2024 17,500.00 01-31-5591 10-31-5591 1	Total   1911	TI FOTDIO CO :		4 200 04	-		
1.782	iotai H&H t	ELECTRIC CO.:		4,280.84	-		
21273 VH PARKING LOT 07/05/2024 2,541.00 01-12-5220 21279 BEVERLY UTILEXT 07/05/2024 181.00 01-25-5220 21270 FAU STP BARRINGTON AVE 07/05/2024 181.00 32-31-6900 21275 23 MICHIGAN 07/05/2024 81.00 85-01-2031 21272 PENNY RORT 68 07/05/2024 81.00 85-01-2378 21271 590 HEALY 07/05/2024 162.00 85-01-2395 21276 DAVEY TREE 07/05/2024 162.00 85-01-2395 21277 0C LAB 07/05/2024 162.00 85-01-2395 21278 OC LAB 07/05/2024 12/96.00 85-01-2404  Total HEINZ, GERALD & ASSOC: 7/968.00  HELPING HAND IT  24-46215 IT SERVICES 06/27/2024 33.03 85-01-2404  Total HELPING HAND IT: 3,591.63  Total HELPING HAND IT: 3,591.63  HINCKLEY SPRINGS: 7/06/2024 42.59 01-12-5286 23840544 07/6 P WATER 07/06/2024 42.59 01-12-5286 23840544 07/6 P WATER 07/06/2024 42.59 01-12-5280 23840544 07/6 P WATER 07/06/2024 42.59 01-12-5630 23840544 07/6 P WATER 07/06/2024 35.86 01-31-5630  Total HINCKLEY SPRINGS: 236.49  HOUSE OF DOORS: 452.64  Total HOUSE OF DOORS: 452.64  VASSE PREMIT 68 06/18/2024 1,000.0 01-31-5591 28541 A 16PA PERMIT FEES 06/18/2024 1,000.0 01-31-5591 28541 A 16PA PERMIT FEES 06/18/2024 1,000.0 01-31-5591	HEINZ, GERALD	& ASSOC.					
21279 BEVERLY UTIL EXT 07/05/2024 81.0.0 01-25-5220 21270 FAU STP BARRINGTON AVE 07/05/2024 162.00 01-31-5220 21275 23 MICHIGAN 07/05/2024 81.0.0 85-01-2031 21272 PENNY RDIRT 68 07/05/2024 81.0.0 85-01-2378 21272 PENNY RDIRT 68 07/05/2024 81.0.0 85-01-2378 21273 DAVEY TREE 07/05/2024 162.00 85-01-2395 21276 DAVEY TREE 07/05/2024 12.99.00 85-01-2395 21277 OC LAB 07/05/2024 1.299.00 85-01-2404  Total HEINZ, GERALD & ASSOC.: 7,968.00  HELPING HAND IT: 3,591.63  HELPING HAND IT: 3,591.63  HINCKLEY SPRINGS 07/06/2024 253.75  Total HELPING HAND IT: 3,591.63  HINCKLEY SPRINGS 23840554 0706 PD WATER 07/06/2024 158.04 01-21-5630 23840554 0706 PD WATER 07/06/2024 158.04 01-21-5630 23840554 0706 PD WATER 07/06/2024 35.86 01-31-5630  Total HINCKLEY SPRINGS: 236.49  HOUSE OF DOORS: 452.64  LILINOIS ENVIRNMENTAL PROTECTION AGENCY 4400329 A MS4 PERMIT 6ES 06/18/2024 1,000.00 01-31-5591 28541 A IEPA PERMIT FEES 06/18/2024 1,000.00 01-31-5591 28541 A IEPA PERMIT FEES 06/18/2024 17,500.00 60-33-5531						01-12-5220	
21270 FAU STP BARRINGTON AVE 07/05/2024 162.00 01.31-5220  21277 2024 STRECT FROGRAM 07/05/2024 810.00 32.31-6090  212172 29 MICHIGAN 07/05/2024 81.00 85-01-2376  212172 PENNY RD/RT 68 07/05/2024 162.00 85-01-2376  212175 590 HEALY 07/05/2024 162.00 85-01-2395  212176 DA/EY TREE 07/05/2024 12.00 85-01-2395  212178 OC LAB 07/05/2024 1.296.00 85-01-2403  212178 OC LAB 07/05/2024 1.296.00 85-01-2404   **Total HEINZ GERALD & ASSOC:: 7,968.00   **HELPING HAND IT: 24-46215 IT SERVICES 07/01/2024 3.301.63 01-12-5286  24-46215 IT SERVICES 07/01/2024 253.75 01-12-5286  24-46409 IT SERVICES 07/02/2024 253.75 01-12-5286   **Total HELPING HAND IT: 3,591.63   **HINCKLEY SPRINGS: 42.59 01-12-5630				,			
21277 2024 STREET PROGRAM 07/05/2024 81.00 85-01-2031 21275 23 MCHIGAN 07/05/2024 81.00 85-01-20378 21271 590 HEALY 07/05/2024 162.00 85-01-2378 21276 DAVEY TREE 07/05/2024 243.00 85-01-2395 21278 OC LAB 07/05/2024 1296.00 85-01-2403  Total HEINZ, GERALD & ASSOC.: 7,968.00  HELPING HAND IT 24-46215 IT SERVICES 06/27/2024 35.05 01-12-5286 24-46309 IT SERVICES 07/01/2024 253.75 01-12-5286 24-46409 IT SERVICES 07/02/2024 253.75 01-12-5286  HINDKLEY SPRINGS 23907757 0706 VH WATER 07/06/2024 158.04 01-21-5630 23840544 0706 PD WATER 07/06/2024 35.86 01-31-5630 23840544 0706 PD WATER 07/06/2024 35.86 01-31-5630 23840544 0706 PD WATER 07/06/2024 35.86 01-31-5630 23840545 0706 VH WATER 07/06/2024 35.86 01-31-5630 23840545 0706 VH WATER 07/06/2024 35.86 01-31-5630 23840545 0706 PD WATER 07/06/2024 35.86 01-31-5630							
21275 23 MICHIGAN 07/05/2024 81.00 85-01-2031 21272 PENNY RDIRT 68 07/05/2024 81.00 85-01-2378 21271 590 HEALY 07/05/2024 162.00 85-01-2395 21276 DAVEY TREE 07/05/2024 243.00 85-01-2403 21278 OC LAB 07/05/2024 1,296.00 85-01-2404  Total HEINZ, GERALD & ASSOC.: 7,968.00  HELPING HAND IT  24-46215 IT SERVICES 06/27/2024 36.25 01-12-5286 24-46215 IT SERVICES 07/01/2024 33.01.63 01-12-5286 24-46219 IT SERVICES 07/01/2024 253.75 01-12-5286  Total HELPING HAND IT: 3,591.63  HINCKLEY SPRINGS  23907757 0706 VH WATER 07/06/2024 42.59 01-12-5286 23840544 0706 PW WATER 07/06/2024 42.59 01-12-5630 23840544 0706 PW WATER 07/06/2024 35.86 01-31-5630  Total HINCKLEY SPRINGS: 236.49  HOUSE OF DOORS: 452.64  HOUSE OF DOORS: 452.64  ILLINOIS ENVIRONMENTAL PROTECTION AGENCY 400329 A MS4 PERMIT 06/18/2024 1,000.00 01-31-5591 28541 A IEPA PERMIT FEES 06/18/2024 17,500.00 60-33-5531							
21272 PENNY RD/RT 68 07/05/2024 81.00 85-01-2378 21271 590 HEALY 07/05/2024 162.00 85-01-2395 21276 DAVEY TREE 07/05/2024 243.00 85-01-2403 21278 OC LAB 07/05/2024 1,296.00 85-01-2403 21278 OC LAB 07/05/2024 1,296.00 85-01-2404 243.00 85-01-2404 243.00 85-01-2404 243.00 85-01-2404 243.00 85-01-2404 243.00 85-01-2404 243.00 85-01-2404 243.00 85-01-2404 243.00 85-01-2404 243.00 85-01-2404 243.00 85-01-2404 243.00 85-01-2404 243.00 85-01-2404 243.00 85-01-2404 243.00 85-01-2404 2446215 IT SERVICES 07/01/2024 36.25 01-12-5286 24-46339 IT SERVICES 07/01/2024 253.75 01-12-5286 24-46409 IT SERVICES 07/02/2024 35.86 01-12-5630 23840544 0706 PD WATER 07/06/2024 158.04 01-21-5630 23840544 0706 PD WATER 07/06/2024 35.86 01-31-5630 23840544 0706 PD WATER 07/06/2024 35.86 01-31-5630 23840544 0706 PD WATER 07/06/2024 452.64 01-31-5630 236-49 23840544 0706 PD WATER 07/06/2024 452.64 01-31-5630 236-49 2							
21271 590 HEALY 07/05/2024 162.00 85-01-2395 21276 DAVEY TREE 07/05/2024 243.00 85-01-2403 21278 OC LAB 07/05/2024 1,296.00 85-01-2404  Total HEINZ, GERALD & ASSOC.: 7,968.00  HELPING HAND IT  24-46215 IT SERVICES 06/27/2024 36.25 01-12-5286 24-46399 IT SERVICES 07/01/2024 3,301.63 01-12-5286 24-46409 IT SERVICES 07/02/2024 253.75 01-12-5286  Total HELPING HAND IT: 3,591.63  HINCKLEY SPRINGS  23990757 0706 VH WATER 07/06/2024 42.59 01-12-6530 23840544 0706 PD WATER 07/06/2024 158.04 01-21-5630 23840544 0706 PW WATER 07/06/2024 35.86 01-31-5630  Total HINCKLEY SPRINGS: 236.49  HOUSE OF DOORS: 452.64  LILLINOIS ENVIRONMENTAL PROTECTION AGENCY 40329 A M S4 PERMIT FEES 06/18/2024 17,500.00 01-31-5591 28541 A IEPA PERMIT FEES 06/18/2024 17,500.00 01-31-5591 28541 A IEPA PERMIT FEES 06/18/2024 17,500.00 01-31-5591 28541 A IEPA PERMIT FEES 06/18/2024 17,500.00 01-31-5591							
21276 DAVEY TREE O7/05/2024 243.00 85-01-2403 21278 OC LAB 07/05/2024 1.296.00 85-01-2404  Total HEINZ, GERALD & ASSOC.: 7,968.00  HELPING HAND IT  24-46215 IT SERVICES 06/27/2024 36.25 01-12-5286 24-46339 IT SERVICES 07/01/2024 3.3.01.63 01-12-5286 24-46409 IT SERVICES 07/02/2024 253.75 01-12-5286  Total HELPING HAND IT: 3,591.63  HINCKLEY SPRINGS  23907757 0706 VH WATER 07/06/2024 42.59 01-12-5630 23840544 0706 PD WATER 07/06/2024 158.04 01-21-5630 23840544 0706 PW WATER 07/06/2024 35.86 01-31-5630  Total HINCKLEY SPRINGS: 236.49  HOUSE OF DOORS: 452.64  ILLINOIS ENVIRONMENTAL PROTECTION AGENCY  400329 A M54 PERMIT 06/18/2024 1,000.00 01-31-5591 28541 A IEPA PERMIT FEES 06/18/2024 17,500.00 60-33-5531							
21278   OC LAB   07/05/2024   1,296.00   85-01-2404							
Total HEINZ, GERALD & ASSOC::  ### ASSOC::  7,968.00  ### ASSOC::  101-12-5286  101-12-5630  101-12-5630  101-12-5630  101-12-5630  101-12-5630  101-12-5630							
HELPING HAND IT  24-46215 IT SERVICES 06/27/2024 36.25 01-12-5286 24-46309 IT SERVICES 07/01/2024 253.75 01-12-5286  24-46409 IT SERVICES 07/02/2024 253.75 01-12-5286  Total HELPING HAND IT: 3,591.63  HINCKLEY SPRINGS  23907757 0706 VH WATER 07/06/2024 42.59 01-12-5630 23840544 0706 PD WATER 07/06/2024 158.04 01-21-5630 23840544 0706 PW WATER 07/06/2024 35.86 01-31-5630  Total HINCKLEY SPRINGS: 236.49  HOUSE OF DOORS  22206 SPECIAL EVENTS GARAGE 05/31/2024 452.64 01-31-5110  Total HOUSE OF DOORS: 452.64  IILLINOIS ENVIRONMENTAL PROTECTION AGENCY 400329 A MS4 PERMIT 06/18/2024 1,000.00 01-31-5591 28541 A IEPA PERMIT FEES 06/18/2024 17,500.00 60-33-5531	21278	OC LAB	07/05/2024	1,296.00	-	85-01-2404	
24-46215 IT SERVICES 06/27/2024 36.25 01-12-5286 24-46339 IT SERVICES 07/01/2024 3,301.63 01-12-5286 24-46409 IT SERVICES 07/02/2024 253.75 01-12-5286  Total HELPING HAND IT: 3,591.63  HINCKLEY SPRINGS  23907757 0706 VH WATER 07/06/2024 42.59 01-12-5630 23840544 0706 PD WATER 07/06/2024 158.04 01-21-5630 23840544 0706 PW WATER 07/06/2024 35.86 01-31-5630  Total HINCKLEY SPRINGS: 236.49  HOUSE OF DOORS  22206 SPECIAL EVENTS GARAGE 05/31/2024 452.64 01-31-5110  Total HOUSE OF DOORS: 452.64  ILLINOIS ENVIRONMENTAL PROTECTION AGENCY  400329 A MS4 PERMIT 06/18/2024 1,000.00 01-31-5591 28541 A IEPA PERMIT FEES 06/18/2024 17,500.00 60-33-5531	Total HEINZ	Z, GERALD & ASSOC.:		7,968.00	_		
24-46215 IT SERVICES 06/27/2024 36.25 01-12-5286 24-46339 IT SERVICES 07/01/2024 3,301.63 01-12-5286 24-46409 IT SERVICES 07/02/2024 253.75 01-12-5286  Total HELPING HAND IT: 3,591.63  HINCKLEY SPRINGS  23907757 0706 VH WATER 07/06/2024 42.59 01-12-5630 23840544 0706 PD WATER 07/06/2024 158.04 01-21-5630 23840544 0706 PW WATER 07/06/2024 35.86 01-31-5630  Total HINCKLEY SPRINGS: 236.49  HOUSE OF DOORS  22206 SPECIAL EVENTS GARAGE 05/31/2024 452.64 01-31-5110  Total HOUSE OF DOORS: 452.64  ILLINOIS ENVIRONMENTAL PROTECTION AGENCY  400329 A MS4 PERMIT 06/18/2024 1,000.00 01-31-5591 28541 A IEPA PERMIT FEES 06/18/2024 17,500.00 60-33-5531	HELPING HAND	IT					
24-46339 IT SERVICES 07/01/2024 3,301.63 01-12-5286 24-46409 IT SERVICES 07/02/2024 253.75 01-12-5286  Total HELPING HAND IT: 3,591.63  HINCKLEY SPRINGS  23907757 0706 VH WATER 07/06/2024 42.59 01-12-5630 23840544 0706 PD WATER 07/06/2024 158.04 01-21-5630 23840544 0706 PW WATER 07/06/2024 35.86 01-31-5630  Total HINCKLEY SPRINGS: 236.49  HOUSE OF DOORS  22206 SPECIAL EVENTS GARAGE 05/31/2024 452.64 01-31-5110  Total HOUSE OF DOORS: 452.64  IILLINOIS ENVIRONMENTAL PROTECTION AGENCY  400329 A MS4 PERMIT 06/18/2024 17,500.00 01-31-5591 28541 A IEPA PERMIT FEES 06/18/2024 17,500.00 60-33-5531			06/27/2024	36.25		01-12-5286	
24-46409 IT SERVICES 07/02/2024 253.75 01-12-5286  Total HELPING HAND IT: 3,591.63  HINCKLEY SPRINGS  23907757 0706 VH WATER 07/06/2024 42.59 01-12-5630 23840544 0706 PD WATER 07/06/2024 158.04 01-21-5630 23840544 0706 PW WATER 07/06/2024 35.86 01-31-5630  Total HINCKLEY SPRINGS: 236.49  HOUSE OF DOORS  22206 SPECIAL EVENTS GARAGE 05/31/2024 452.64  Total HOUSE OF DOORS: 452.64  ILLINOIS ENVIRONMENTAL PROTECTION AGENCY 400329 A MS4 PERMIT 06/18/2024 1,000.00 01-31-5591 28541 A IEPA PERMIT FEES 06/18/2024 17,500.00 60-33-5531	24-46339	IT SERVICES		3,301.63		01-12-5286	
HINCKLEY SPRINGS  23907757 0706 VH WATER 07/06/2024 42.59 01-12-5630  23840544 0706 PD WATER 07/06/2024 158.04 01-21-5630  23840544 0706 PW WATER 07/06/2024 35.86 01-31-5630  Total HINCKLEY SPRINGS: 236.49  HOUSE OF DOORS  22206 SPECIAL EVENTS GARAGE 05/31/2024 452.64 01-31-5110  Total HOUSE OF DOORS: 452.64  ILLINOIS ENVIRONMENTAL PROTECTION AGENCY  400329 A MS4 PERMIT 06/18/2024 1,000.00 01-31-5591 28541 A IEPA PERMIT FEES 06/18/2024 17,500.00 60-33-5531	24-46409	IT SERVICES	07/02/2024			01-12-5286	
23907757 0706 VH WATER 07/06/2024 42.59 01-12-5630 23840544 0706 PD WATER 07/06/2024 158.04 01-21-5630 23840544 0706 PW WATER 07/06/2024 35.86 01-31-5630  Total HINCKLEY SPRINGS: 236.49  HOUSE OF DOORS  22206 SPECIAL EVENTS GARAGE 05/31/2024 452.64 01-31-5110  Total HOUSE OF DOORS: 452.64  ILLINOIS ENVIRONMENTAL PROTECTION AGENCY 400329 A MS4 PERMIT 06/18/2024 1,000.00 01-31-5591 28541 A IEPA PERMIT FEES 06/18/2024 17,500.00 60-33-5531	Total HELP	ING HAND IT:		3,591.63			
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23840544 0706 PW WATER 07/06/2024 35.86 01-31-5630  Total HINCKLEY SPRINGS: 236.49  HOUSE OF DOORS  22206 SPECIAL EVENTS GARAGE 05/31/2024 452.64 01-31-5110  Total HOUSE OF DOORS: 452.64  ILLINOIS ENVIRONMENTAL PROTECTION AGENCY  400329 A MS4 PERMIT 06/18/2024 1,000.00 01-31-5591 28541 A IEPA PERMIT FEES 06/18/2024 17,500.00 60-33-5531							
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22206 SPECIAL EVENTS GARAGE 05/31/2024 452.64 01-31-5110  Total HOUSE OF DOORS: 452.64  ILLINOIS ENVIRONMENTAL PROTECTION AGENCY  400329 A MS4 PERMIT 06/18/2024 1,000.00 01-31-5591 28541 A IEPA PERMIT FEES 06/18/2024 17,500.00 60-33-5531	Total HINC	KLEY SPRINGS:		236.49	-		
22206 SPECIAL EVENTS GARAGE 05/31/2024 452.64 01-31-5110  Total HOUSE OF DOORS: 452.64  ILLINOIS ENVIRONMENTAL PROTECTION AGENCY  400329 A MS4 PERMIT 06/18/2024 1,000.00 01-31-5591 28541 A IEPA PERMIT FEES 06/18/2024 17,500.00 60-33-5531	HOUSE OF BOO	De			-		
Total HOUSE OF DOORS: 452.64  ILLINOIS ENVIRONMENTAL PROTECTION AGENCY  400329 A MS4 PERMIT 06/18/2024 1,000.00 01-31-5591  28541 A IEPA PERMIT FEES 06/18/2024 17,500.00 60-33-5531			05/31/2024	452.64		01-31-5110	
ILLINOIS ENVIRONMENTAL PROTECTION AGENCY 400329 A MS4 PERMIT 06/18/2024 1,000.00 01-31-5591 28541 A IEPA PERMIT FEES 06/18/2024 17,500.00 60-33-5531	Total HOUS	SE OF DOORS:		452.64	-		
400329 A       MS4 PERMIT       06/18/2024       1,000.00       01-31-5591         28541 A       IEPA PERMIT FEES       06/18/2024       17,500.00       60-33-5531					-		
28541 A IEPA PERMIT FEES 06/18/2024 17,500.00 60-33-5531				4 000 00		04 04 5504	
04-00 A IINDUSTRIAL PERMIT 00/18/2024 500.00 60-33-5531							
	0400 A	IINDUSTRIAL PERMIT	00/18/2024	00.006		00-33-3531	

			<u> </u>			
Invoice Number	Description	Invoice Date	Net Invoice Amount	Voided	GL Account Number	
Total ILLING	DIS ENVIRONMENTAL PROTECTIO	N AGENCY:	19,000.00	-		
				-		
JM CONSTRUCT 240308	CASH BOND REIMB	07/10/2024	5,000.00		01-09-4205	
				=		
Total JM CC	ONSTRUCTIONS PROS:		5,000.00	-		
MIDWEST SALT						
474412	COARSE SALT	05/17/2024	3,497.52		60-33-5650	
475113	COARSE SALT	07/05/2024	3,525.60		60-33-5650	
Total MIDW	EST SALT		7,023.12	-		
TOTAL WILDW	EST GAET.		7,020.12	-		
NICOR GAS						
062624	NICOR VH	07/08/2024	183.67		01-31-5510	
062624	NICOR S/W	07/08/2024	2,341.61	_	60-33-5510	
Total NICOF	R GAS:		2,525.28	_		
NORTHERNICON	ITDACTING INC					
197	REPLACE FENCE SURROUNDI	07/04/2024	6,739.87	-	60-33-5111	
Total NORT	HERN CONTRACTING, INC:		6,739.87	_		
NORTHSTOCK, I	NC					
45332	PURCHASE UNIT HEATER FOR	06/22/2024	7,421.92	-	60-33-5111	
Total NORT	HSTOCK, INC:		7,421.92	-		
ORANGE CRUSH	I					
110040	SURFACE - TON	06/30/2024	745.80		01-31-5150	
110051	SURFACE - TON	06/30/2024	279.18		01-31-5150	
110051	ASPHALT DISPO	06/30/2024	25.00		01-31-5570	
110073	ASPHALT DISPO	06/30/2024	50.00		01-31-5570	
Total ORAN	GE CRUSH:		1,099.98	-		
10.01 010 11	or order.			-		
OTTO ENGINEER	RING					
1170592	UNIFORM	07/03/2024	40.80		01-21-5080	
1170601	UNIFORM	07/02/2024	355.81	_	01-21-5080	
Total OTTO	ENGINEERING:		396.61	_		
P.F. PETTIBONE						
185814	UNIFORM	04/19/2024	448.00	_	01-21-5080	
Total P.F. P	ETTIBONE:		448.00	_		
PACE ANALYTIC	AL SERVICES, LLC					
247208612	WATER TESTING	06/28/2024	200.00		60-33-5290	
247208613	WW TESTING	06/28/2024	3,406.90		60-33-5291	
				-		
iotai PACE	ANALYTICAL SERVICES, LLC:		3,606.90	-		
PAUL SWEIGER		07/04/0004	75.00		04.40.5000	
416	WATER TOWN DRONE PICS	07/01/2024	75.00		01-12-5290	

<b>QUAD COM 9-1-1</b> 24-EDPD-07		Invoice Date	Net Invoice Amount	Voided	GL Account Number	
<b>QUAD COM 9-1-1</b> 24-EDPD-07	r					
<b>QUAD COM 9-1-1</b> 24-EDPD-07	r			-		
24-EDPD-07			75.00	-		
Total QUAD	DISPATCH SERV	07/01/2024	16,760.09	=	01-21-5360	
	COM 9-1-1:		16,760.09			
RAY O'HERRON	CO. INC					
2351936	UNIFORM	07/01/2024	1,602.98		01-21-5080	
2351938	UNIFORM	07/01/2024	1,572.98		01-21-5080	
2351945	UNIFORM	07/01/2024	1,572.98		01-21-5080	
Total RAY C	HERRON CO. INC:		4,748.94	=		
SHINE & DETAIL	CLEANING CORP					
062824	PD CLEANING	06/28/2024	2,751.17	-	01-21-5121	
Total SHINE	& DETAIL CLEANING CORP:		2,751.17			
STANARD & ASS	OCIATES INC					
58446	ENTRY LEVEL EVALU	06/27/2024	990.00		01-12-5290	
Total STAN/	ARD & ASSOCIATES INC.:		990.00	=		
STANDARD INS (	20. DW					
070124	ADMIN DEN	07/01/2024	245.08		01-12-5060	
070124 070124 V	ADVIN VIS	07/01/2024	10.24		01-12-5060	
070124	FIN DEN	07/01/2024	56.07		01-14-5060	
070124 V	FIN VIS	07/01/2024	4.70		01-14-5060	
070124	PD DEN	07/01/2024	1,436.63		01-21-5060	
070124 V	PD VIS	07/01/2024	69.34		01-21-5060	
070124	BLDG DEN	07/01/2024	98.79		01-25-5060	
070124 V	BLD VIS	07/01/2024	6.83		01-25-5060	
070124	PW DEN	07/01/2024	356.52		01-31-5060	
070124 V	PW VIS	07/01/2024	24.17		01-31-5060	
070124	EMPL DEN	07/01/2024	368.09		27-01-2208	
070124 V	EMP VIS	07/01/2024	342.65		27-01-2208	
070124	WTS SRW DEN	07/01/2024	442.24		60-33-5060	
070124 V	W'S VIS	07/01/2024	28.27		60-33-5060	
Total STANI	DARD INS CO - D/V:		3,489.62			
STANDARD INS	CO - LIFE					
070124	ADMIN	07/01/2024	64.35		01-12-5060	
070124	FINANCE	07/01/2024	36.09		01-14-5060	
070124	POLICE	07/01/2024	351.46		01-21-5060	
070124	BUILDING	07/01/2024	30.65		01-25-5060	
070124	PW	07/01/2024	95.52		01-31-5060	
070124	EMPLOYEE	07/01/2024	250.18		27-01-2208	
070124	W/S	07/01/2024	137.93	-	60-33-5060	
Total STANI	DARD INS CO - LIFE:		966.18			
STEWART SPREA	ADING					
3851	BIOSOLIDS TRANS AND LAND A	07/03/2024	3,000.00		60-33-5287	

		•	oport datos. 17 16/			0di 11, 2021 10.027 tivi
Invoice Number	Description	Invoice Date	Net Invoice Amount	Voided	GL Account Number	
Total STEW	VART SPREADING:		3,000.00			
SUBURBAN ELE	EVATOR					
8106620866	QUATERLY PREVENTIVE MAINT	07/01/2024	611.58		01-21-5121	
Total SUBL	JRBAN ELEVATOR:		611.58			
THE FUNKY BRI	JSH AND PALETTE, LLC					
071024	WDW 7/10/24	07/10/2024	315.00		01-37-5290	
Total THE F	FUNKY BRUSH AND PALETTE, LLC:		315.00			
THOMAS DZUBI	N					
1679000	WATER BILL FINAL OVERPAY	07/10/2024	4.44		99-00-1005	
Total THON	MAS DZUBIN:		4.44			
TLO LLC						
259283-20240	MEMBERSHIP	06/30/2024	75.00		01-21-5410	
Total TLO L	LC:		75.00			
T MODULE						
<b>T-MOBILE</b> 062124	CHIEF, DC & SERGEANT'S CEL	06/21/2024	125.85		01-21-5320	
Total T-MO	BILE:		125.85			
TOP BOARD-UP 21420	BOARD UP HAEGER	06/24/2024	3,150.00		39-01-5955	
Total TOP F	BOARD-UP LLC:		3,150.00			
	50741.5 67 226.					
TRACY'S FUN FA		07/40/2024	240.00		04 27 5200	
071024	BALLOON ARTIST	07/10/2024	210.00		01-37-5290	
Total TRAC	Y'S FUN FACE PAINTING:		210.00			
UGSI CHEMICAL	_ FEED					
34191	POLYMER FEED SYSTEM	07/05/2024	1,352.65		60-33-5131	
Total UGSI	CHEMICAL FEED:		1,352.65			
ULINE						
179998343	GARBAGE CAN LINERS	06/28/2024	478.76		01-31-5630	
Total ULINE	≣:		478.76			
US BANK						
5221 062524 B	COMCAST	06/25/2024	31.47		01-12-5286	
1680 062524 K		06/25/2024	80.00		01-12-5410	
1680 062524 K	SIRIUS	06/25/2024	17.83		01-12-5410	
5221 062524 B	ADOBE	06/25/2024	383.84		01-12-5410	
6309 062524 E		06/25/2024	101.00		01-12-5410	
6309 062524 E		06/25/2024	513.98		01-12-5420	
	TRAINNING MEALS	06/25/2024	118.50		01-12-5420	
1680 062524 K	SUPPLIES	06/25/2024	63.31		01-12-5610	

Invoice Number	Description	Invoice Date	Net Invoice Amount	Voided	GL Account Number
6309 062524 E	BLIG TRAPS	06/25/2024	18.90		01-12-5610
	NESTING TABLES	06/25/2024	137.49		01-12-5630
	SHREDDER	06/25/2024	579.00		01-12-5630
	LABELS/BEV COMP PLAN	06/25/2024	60.81		01-12-5630
	SHIRTS	06/25/2024	383.10		01-12-5630
	ICE	06/25/2024	8.51		01-12-5630
	SANDWICHES COMP PLAN	06/25/2024	87.59		01-12-5630
	GIFT BASKETS	06/25/2024	111.14		01-12-6005
	PHONE CHARGER	06/25/2024	8.98		01-14-5320
	GUN BELT	06/25/2024	88.09		01-21-5080
	MEMERSHIP	07/08/2024	14.99		01-21-5410
5738 062524 J	TRAINING LODGINE	06/25/2024	266.63		01-21-5420
	TRAINING	06/25/2024	755.00		01-21-5430
2107 062524 J	COPY PAPER	07/08/2024	40.84		01-21-5610
2107 062524 J	COFFEE	07/08/2024	68.76		01-21-5610
2107 062524 J	PLASTIC SPOONS	07/08/2024	30.71		01-21-5610
2107 062524 J	FANS	07/08/2024	169.79		01-21-5610
2107 062524 J	COFFEE CREAMER	07/08/2024	12.99		01-21-5610
2107 062524 J	AC ADAPTER	07/08/2024	29.51		01-21-5611
40798 062524	HDMI	06/25/2024	7.99		01-21-5611
1500 062524 A	SUPPLIES	06/25/2024	81.57		01-21-5630
1500 062524 A	PD CAR WASH	06/25/2024	119.90		01-21-5630
806 062524 C	PUBLIC HEARING SIGN	06/25/2024	147.92		01-25-5331
5824 062524 G	FLOWERS - DT	06/25/2024	399.90		01-31-5110
	ICLOUD STORAGE	06/25/2024	.99		01-31-5320
	BEVERAGES	06/25/2024	77.73		01-37-5630
	HAND WASHING SUPPLIES	06/25/2024	997.55		01-37-5630
5824 062524 G		06/25/2024	153.80		01-37-5630
	ABS PIPE RETURN	06/25/2024	153.80-		01-37-5630
	EXT CORDS	06/25/2024	269.91		01-37-5631
	PAPER/SHEET PROT	06/25/2024	42.44		01-37-5631
	DEPOT REMODEL SUPPLES	06/25/2024	105.56		34-01-5945
	IPHONE STORAGE	06/25/2024	.99		60-33-5320
		06/25/2024			
5824 062524 G		00/23/2024	40.00		60-33-5420
Total US BAN	NK:		6,475.21		
JSA BLUEBOOK					
414229	BBOX LID	07/08/2024	27.95		60-33-5140
409919	W LAB SUPPLIES	07/01/2024	739.75		60-33-5630
Total USA BL	LUEBOOK:		767.70		
WASTE MANAGE	MENT OF ILLINOIS				
	DISPOSAL OF MISC MATERIAL	07/01/2024	1,704.26		01-31-5570
Total WASTE	E MANAGEMENT OF ILLINOIS:		1,704.26		
WILSON LANDSC		07/04/555			04.04.5450
432512	GRASS SEED	07/01/2024	134.25		01-31-5150
Total WILSO	N LANDSCAPE SUPPLY INC:		134.25		
WILSON NURSER	IES INC				
449381	TREE	07/01/2024	1,372.00		01-31-5190

VILLAGE OF EAST DUNDEE	Warrant Report July 15, 2024	Page: 9
	Report dates: 7/15/2024-7/15/2024	Jul 11, 2024 10:52AM

Invoice Number	Description	Invoice Date	Net Invoice Amount	Voided	GL Account Number
Total WILS	ON NURSERIES INC:		1,372.00		
WRAP GUYZ					
2022-712	SQUAD CARS	07/02/2024	1,155.60		01-21-5280
2022-713	SQUAD CARS	07/02/2024	1,155.60		01-21-5280
Total WRAP GUYZ:			2,311.20		
XTREME FIRE F	PROTECTION LLC				
32453	FIRE EX RECHARGE	06/30/2024	120.00		01-21-5130
Total XTRE	Total XTREME FIRE PROTECTION LLC:		120.00		
Grand Tota	Grand Totals:		630,850.56		

### Report Criteria:

Detail report.

Invoices with totals above \$0.00 included.

Paid and unpaid invoices included.

## Memorandum

**To:** Village President and Board of Trustees

**From:** Erika Storlie, Village Administrator

**Subject:** Purchase of Real Property in Downtown TIF #4 (106 S. River St. Vacant Land)

**Date:** July 15, 2024

## **Action Requested:**

Staff recommends Village Board approval of an ordinance authorizing the purchase of 106 S. River St. (PIN: 03-23-359-004-0000), East Dundee, IL 60118 in the Downtown Tax Increment Financing District for the purchase price of \$80,000.

## **Funding Source:**

Downtown TIF #4 - Fund 39

#### **Summary:**

At the March 18, 2024, Village Board meeting, the Board passed Resolution #14-24 which adopted the East Dundee Riverfront Master Plan ("Plan"). The Plan is a visioning document that summarizes the process, findings and recommendations for the Riverfront gleaned from extensive public input. As part of that strategic, long-term vision, the Plan recommends that when properties that are contiguous to the River near the Haeger site become available, the Village should attempt to acquire them. These properties in the long-term can be reimagined into open park spaces, or whatever the desire of the Village is at that time that aligns with the adopted Riverfront Master Plan and community desires.

Staff was approached by Century 21 who represents the seller of the property that this vacant strip of land located in the flood plain was on the public market with a list price of \$80,000. The price reflects fair market value and if approved, the property will be transferred to the Village in the next 30 days.

## Attachment:

Aerial Photo Ordinance Contract



<b>ORDI</b>	NANCE	NO.	

## AN ORDINANCE AUTHORIZING EXECUTION OF A CONTRACT FOR SALE OF VACANT LAND AND PURCHASE OF REAL PROPERTY (106 S. RIVER, EAST DUNDEE, ILLINOIS)

**NOW, THEREFORE, BE IT ORDAINED**, by the President and Board of Trustees of the Village of East Dundee, Kane and Cook Counties, Illinois, as follows:

**SECTION 1:** The President and Board of Trustees of the Village find as follows:

- A. The Village of East Dundee (the "*Village*") is a home rule municipality pursuant to Section 7 of Article VII of the Constitution of the State of Illinois.
- B. The State of Illinois has adopted tax increment financing pursuant to the Tax Increment Allocation Redevelopment Act, 65 ILCS 5/11-74.4-1, et seq., as amended from time to time (the "TIF Act").
- C. Pursuant to its powers and in accordance with the TIF Act, and pursuant to Ordinance Nos. 08-34, 08-35 and 08-36, adopted June 16, 2008, and as amended by Ordinance Number 18-28 on September 10, 2018, the Downtown Tax Increment Financing District (the "*TIF District*") was formed as a TIF district, for a twenty-three (23) year period. Ordinance Nos. 08-34, 08-35, 08-36 and 18-28 are incorporated herein by reference.
- D. Pursuant to and in accordance with the TIF Act and the Ordinances establishing the TIF District, the Corporate Authorities of the Village are empowered under Sections 4(c) and 3(q)(2) of the TIF Act, 65 ILCS 5/11-74.4-4(c) and 3(q)(2), to purchase real property within the TIF district, using TIF District funds, in furtherance of the Redevelopment Plan and Project for the TIF District, including for the acquisition of the "Subject Property," as defined in Section I.E. below.
- E. Luz Mery Cardenas, Trustee of the Luz Mery Cardenas Living Trust dated May 10, 2007 (the "**Seller**"), is the owner of the real estate and appurtenances attached thereto for the property commonly known as 106 S. River, East Dundee, Illinois, with Parcel Identification Numbers 03-23-359-004-0000 (the "**Subject Property**").
- F. The Village desires to acquire the Subject Property in furtherance of the Redevelopment Plan and Project for the TIF District.
- G. It is the desire of the Seller to convey the Subject Property to the Village on the terms set forth in the "Contract for the Sale of Vacant Land," and its accompanying Exhibits and Rider, attached hereto as **EXHIBIT A** and made a part hereof (the "**Agreement**").
- H. It is in the best interest of the Village to acquire the Subject Property, to ensure that redevelopment within the TIF District continues.

**SECTION 2**: Based upon the foregoing, the Village President, Village Clerk and Village Administrator be and are hereby authorized and directed to purchase the Subject Property pursuant to the terms and conditions set forth in the Agreement, and in such other form as may

be approved by the Village Administrator and Village Counsel and the Village President, Village Clerk and Village Administrator are further authorized and directed to execute and deliver such other instruments, including the Agreement, as may be necessary or convenient to consummate such purchase.

**SECTION 3:** This Ordinance shall be in full force and effect from and after its passage, approval and publication in pamphlet form as provided by law.

<b>ADOPTED</b> this day of July, 202	24, pursuant to a roll call vote a	s follows:
AYES:		<u> </u>
		<u> </u>
ABSENT:		<u> </u>
APPROVED this day of July, 2 Dundee, and attested by the Village Clerk,		of the Village of East
	Village Preside	ent
APPROVED and FILED in my offi in pamphlet form in the Village of East Du		
ATTEST:		
Village Clerk		

# **EXHIBIT A**

# **AGREEMENT**

(attached)







## CONTRACT FOR THE SALE OF VACANT LAND

2	1.	THE PARTIES: Buyer	and Seller are herei	nafter referred to	as the "Parties	o" <b>.</b>		
3		Buyer(s) [Please Print]	VILLAGE OF EAST	DUNDEE				
5		Seller(s) [Please Print]	7	LUZ MERY CA	RDENAS IN LIV	ING TRUST MAY	10, 2007	
9		If Dual Agency applie	s, complete Optional	Paragraph 27.				
8 9 10	2.	THE REAL ESTATE: convey to Buyer or to B					nents thereon. Seller agrees to acreage of	
11			commonly know	wn as:				
12 13		106 S RIVER		Address or	r Legal Description	on		
14		100 S RIVER						
15 16		EAST DUNDEE	KANE	il	60118	03-23-359-00		
16 17		City	County	State	Zip	Permanent Ind	ex Number(s) of Real Estate	
18 19 20	3.	PURCHASE PRICE: F below, the balance of t					t of Earnest Money as provided Good Funds" as defined by law.	
21 22 23 24 25	4.	Seller's Broker;  \$ 15,000.00  Money of \$	Buyer's Broker; shall be tendered to	X As otherwise Escrowee on or b	e agreed by the pefore <b>5</b> d	Parties as "Escro ay(s) after Date of	heck one] wee". Initial Earnest Money of Acceptance. Additional Earnest	
26 27 28 29	5.		arty, the following sh	all be deemed in	corporated: "and	d Earnest Money r	void or if this Contract may be efunded upon the joint written on."	
30 31 33 33 33 33 33 33 33 34 44 44 44 44 44	6.	Contract and if Escrow proceed as follows:  a) Escrowee shall give of intended disburs any written object the Earnest Money order of a court of Escrowee may file between Seller and to reimburse Escremount held in escand severally inde  CLOSING AND POSS mutually agreed upon to nearest the Real Estate of closing unless others.  MORTGAGE CONTIN:  34 [EITHER a) OR b)]  This Contract is continent other required, with an intere over not less than	In the event either Party has declared the Contract null and void or the transaction has failed to close as provided for in this Contract and if Escrowee has not received joint written direction by the Parties or such court order, the Escrowee may elect to proceed as follows:  a) Escrowee shall give written Notice to the Parties as provided for in this Contract at least fourteen (14) days prior to the date of intended disbursement of Earnest Money indicating the manner in which Escrowee intends to disburse in the absence of any written objection. If no written objection is received by the date indicated in the Notice then Escrowee shall distribute the Earnest Money as indicated in the written Notice to the Parties. If Party objects in writing to the intended disbursement of Earnest Money then Earnest Money shall be held until receipt of joint written direction for all Parties or until receipt of an order of a court of competent jurisdiction.  b) Escrowee may file Suit for Interpleader and deposit any funds held into the Court of distribution after resolution of dispute between Seller and Buyer by the Court. Escrowee may retain from the funds deposited with Court other amount necessary to reimburse Escrowee for court costs and reasonable attorney's fees incurred due to the filing of the Interpleader. If the amount held in escrow is inadequate to reimburse Escrowee for the costs and attorney's fees, Buyer and Seller shall jointly and severally indemnify Escrowee for additional costs and fees incurred in filing the Interpleader action.  CLOSING AND POSSESSION: Closing or escrow pay shall be on					
56 57 58 59 60		(Complete Paragraph : after the Date of Acce	34 if closing cost cred ptance and shall caus to Date of Acceptance for the loan specified Buyer Initial	lits apply). Buyer se an appraisal o e; failure to do above [complete	shall make writt of Real Estate to either shall con both a) and b)]:	ten loan application be ordered by the	sing costs charged by lender. within five (5) Business Days lender no later than ten (10) Default under this Contract.  Seller Initial	
	Cor	ntract for the Sale of Vac	ant Land REALTOR©	Association of the	Fox Valley, Inc.		Page <b>1</b> of <b>7</b>	

61 62		a) is unable to provide written evidence that the loan application has been submitted for underwriting approval by Buyer's lender on or before, 20, (if not date is inserted, the date shall be thirty (30) days after the Date
63		of Acceptance) either Buyer or Seller shall have the option of declaring this Contract terminated by giving Notice to the
64		other Party not later than two (2) Business Days after the date specified herein or any extension date agreed to by the
65		Parties in writing.
66 67		b) is unable to obtain a written "Clear to Close" from Buyer's lender on or before, 20, (if not date
68		is inserted, the date shall be forty-five (45) days after the Date of Acceptance) either Buyer or Seller shall have the option of declaring this Contract terminated by giving Notice to the other Party not later than two (2) Business Days after the date
69		specified herein or any extension date agreed to by the Parties in writing.
70		A Party causing delay in the loan approval process shall not have the right to terminate under either of the
71		preceding paragraphs. In the event neither Party elects to declare this Contract null and void as of the latter of the
72		dates specified above (as may be amended from time to time), then this Contract shall continue in full force and
73		effect without any loan contingencies.
74 75		Unless otherwise provided in Paragraph 28, this Contract shall not be contingent upon the sale and/or closing of
75 76		Buyer's existing real estate. Buyer shall be deemed to have satisfied the financing conditions of this paragraph if Buyer
77		obtains a loan commitment in accordance with the terms of this paragraph even though the loan is conditioned on the sale and/or closing of Buyer's existing real estate.
78		diffully distance of buyers existing real estate.
79	8.	PRORATIONS: Proratable items shall include, without limitation, rents and deposits (if any) from tenants, water and sewer.
80		Seller agrees to pay prior to or at Closing any special assessments (governmental or association) confirmed prior to Date of
81		Acceptance. The general Real Estate taxes shall be prorated as of the date of Closing based on% of the most recent
82		ascertainable full year tax bill. All prorations shall be final as of Closing.
83 84	9.	BUYER'S RIGHT TO DETERMINE: Buyer shall have until, 20 to determine the suitability of the Real Estate
85	0.	for Buyer's intended use as  Buyer shall have the right to inspect, examine, and/or
86		for Buyer's intended use as Buyer shall have the right to inspect, examine, and/or test all aspects of the Real Estate, including by way of example and not limitation, such matters pertaining to the Real Estate
87		as: (a) availability of utility services; (b) existing leases; if any (c) legal description; size and configuration; (d) access to public
88		rights of way; (e) soil boring and percolation tests; (f) flood plain or wetlands; (g) hazardous substances or other contamination;
89 90		(h) verification of, or the absence of, underground storage tanks; (i) zoning; (j) the availability of building permits; (k) whether Buyer will be required to make any public improvement or contributions of cash for schools, parks, or the like as a condition to
91		the improvement of the Real Estate; (I) current plat of survey; (m) easements, restrictions, and covenants of record; (n)
92		homeowners associations by-laws; and (o) other matters relating to the Real Estate is suitable for construction of Buyer's
93		intended improvements and a septic system thereon in accordance with the applicable governmental ordinances. Seller shall
94		allow Buyer and Buyer's agents reasonable access to the Real estate during normal business hours upon reasonable advance
95 06		notice to Seller for the purpose of making or conducting such tests or other inspections of the Real Estate as the Buyer may
96 97		deem appropriate and Buyer shall immediately restore the acts or negligence of Buyer or any person performing any inspection(s). In the event Buyer determines the Real Estate is not suitable for Buyer's intended use and give written
98		notice thereof to Seller within the time specified, this Contract shall be null and void and earnest money refunded
99		to Buyer upon written direction of the Parties to Escrowee. If written Notice is not served within the time specified,
100		Buyer shall be deemed to have waived this contingency, and this Contract shall remain in full force and effect. If
101		the Buyer terminates this Contract pursuant to this provision Buyer shall provide Sellers with copies of all tests and inspections.
102 103	10	ATTORNEY REVIEW: Within five (5) Business Days after Date of Acceptance, the attorneys for the respective Parties, by
104	10.	Notice, may:
105		a) Approve this Contract; or
106		b) Disapprove this Contract, which disapproval shall not be based solely upon the Purchase Price; or
107		c) Propose modifications except for the Purchase Price. If within ten (10) Business Days after the date of Acceptance
108		written agreement is not reached by the Parties with respect to resolution of the proposed modifications, then either
109		Party may terminate this Contract by serving Notice, whereupon this Contract shall be null and void; or
110 111		d) Propose suggested changes to this Contract. If such suggestions are not agreed upon, neither Party may declare this Contract null and void and this Contract shall remain in full force and effect.
112		Contract hull and void and this Contract shall remain in full force and effect.
113		Unless otherwise specified, all Notices shall be deemed made pursuant to Paragraph 10 c. If Notice is not served
114		within the time specified herein, the provisions of this paragraph shall be deemed waived by the Parties and this
115		Contract shall remain in full force and effect.
116	4.4	DIATOR CUDVEV. Not less they five (E) havings done mine to the compation of Daniel to Determine College half of
117 118	11	<b>PLAT OF SURVEY:</b> Not less than five (5) business days prior to the expiration of Buyer's Right to Determine, Seller shall at Seller's expense, furnish to Buyer or Buyer's attorney a Plat of Survey that conforms to the current Minimum Standard of Practice
119		for boundary surveys, is dated not more than six (6) months prior to the date of Closing, and is prepared by a professional land
120		surveyor licensed to practice land surveying under the laws of the State of Illinois. The Plat of Survey shall show visible evidence
121		of improvements, right of way, easements, use and measurements of all parcel lines. The land surveyor shall set monuments
122		or witness corners at all accessible corners of the land. All such corners shall also be visibly staked or flagged. The Plat of Survey
123 124		shall include the following statement placed near the professional land surveyor's seal and signature: "This professional service conforms to the current Illinois Minimum Standards for boundary survey." A Mortgage Inspection, as defined, is not a boundary
125		survey and is not acceptable.
126	<u></u>	
		rer Initial Buyer Initial Seller Initial Seller Initial
		lress 106 S RIVER, EAST DUNDEE, il 60118
	Con	tract for the Sale of Vacant Land REALTOR© Association of the Fox Valley, Inc. Page 2 of 7

- 12. **THE DEED:** Seller shall convey or cause to be conveyed to Buyer, or Buyer's designated grantee good and merchantable title to the Real Estate by recordable general Warranty Deed, (or the appropriate deed if title is in trust or in an estate), and with real estate transfer stamps to be paid by Sellers (unless otherwise designated by local ordinance). Title when conveyed will be good and merchantable, subject only to: general real estate taxes not due and payable at the time of closing, covenants, conditions, and restrictions of record, building lines and easements, if any, so long as they do not interfere with the current use, the proposed use and enjoyment of the Real Estate.
- 13. DAMAGE TO REAL ESTATE OR CONDEMNATION PRIOR TO CLOSING: If prior to delivery of the deed the Real Estate shall be destroyed or materially damaged by fire or other casualty, or the Real Estate is taken by condemnation, then Buyer shall have the option of either terminating this Contract (and receiving a refund of earnest money) or accepting the Real Estate as damaged or destroyed, together with the proceeds of the condemnation award or any insurance payable as a result of the destruction or damage, which gross proceeds Seller agrees to assign to Buyer and deliver to Buyer at Closing. Seller shall not be obligated to repair or replace damaged improvements. The provisions of Uniform Vendor and Purchaser Risk Act of the State of Illinois shall be applicable to this Contract, except as modified by this paragraph.
- 14. **CONDITION OF REAL ESTATE AND INSPECTION:** All refuse and personal property that is not to be conveyed to Buyer shall be removed from the Real Estate at Seller's expense prior to delivery of Possession. Buyer shall have the right to inspect the Real Estate, prior to Possession to verify that the Real Estate is in substantially the same condition as of the Date of Acceptance, normal wear and tear excepted.
- 15. **NOTICE:** Except as provided in Paragraph 28 c) 2) regarding the manner of service for "kick-out" Notices, all Notices shall be in writing and shall be served by one Party or attorney to the other Party or attorney. Notice to any one of a multiple person Party shall be sufficient notice to all. Notice shall be given in the following manner:
  - a) By personal delivery; or

- b) By mailing to the addresses recited herein by regular mail and by certified mail, return receipt requested. Except as otherwise provided herein, Notice served by certified mail, shall be effective on the date of mailing; or
- c) By sending facsimile transmission. Notice shall be effective as of date and time of the transmission, provided that the Notice transmitted shall be sent on Business Days during Business Hours. In the event the Notice is transmitted during non-business hours, the effective date and time of Notice is the first hour of the first Business Day after transmission; or
- d) By e-mail transmission if e-mail has been furnished by the recipient Party or the recipient Party's attorney to the sending Party or is shown in this Contract. Notice shall be effective as of date and time of e-mail transmission, provided that, in the event e-mail Notice is transmitted during non-business ours, the effective date and time of Notice is the first hour of the next Business Day after transmission. An attorney or Party may opt out of future e-mail Notice by any form of Notice provided by this Contract; or
- e) By commercial overnight delivery (e.g., FedEx). Such Notice shall be effective on the next Business Day following deposit with the overnight delivery company.
- 16. TITLE: At Seller's expense, Seller will deliver or cause to be delivered to Buyer or Buyer's attorney within customary time limitations and sufficiently in advance of Closing, as evidence of title in Seller or Grantor, a title commitment for an ATLA title insurance policy in the amount of the Purchase Price with extended coverage by a title company licensed to operate in the State of Illinois, issue on or subsequent to the Date of Acceptance, subject only to items listed in Paragraph 12. The requirement to provide extended coverage shall not apply if the Real Estate is vacant land. The commitment for title insurance furnished by Seller will be presumptive evidence of good and merchantable title as therein shown, subject only to the exceptions therein stated. If the title commitment discloses any unpermitted exceptions or if the Plat of Survey shows any encroachments or other survey matters that are not acceptable to Buyer, then Seller shall have said exceptions, survey matters or encroachments removed, or have the title insurer commit to either insure against loss or damage that may result from such exceptions or survey matters or insure against any court-ordered removal of the encroachments. If Seller fails to have such exceptions waived or insured over prior to Closing, Buyer may elect to take title as it then is with the right to deduct from the Purchase Price prior encumbrances of a definite or ascertainable amount. Seller shall furnish Buyer at Closing an Affidavit of Title covering the date of Closing, and shall sign any other customary forms required for issuance of an ALTA Insurance Policy.
- 17. **PERFORMANCE:** Time is of the essence of this Contract. In the event of default by Seller or Buyer, the Parties are free to pursue any legal remedies at law or in equity. The prevailing Party in litigation shall be entitled to collect reasonable attorney fees and costs from the losing Party as ordered by court of competent jurisdiction. There shall be no disbursement of earnest money unless Escrowee has been provided written agreement from Seller and Buyer. Absent an agreement relative to the disbursement of earnest money within a reasonable period of time, Escrowee may deposit funds with the Clerk of the Circuit Court by the filing of an action in the nature of interpleader. Escrowee shall be reimbursed from the earnest money for all costs, including reasonable attorney's fees, related to the filing of the interpleader action. Seller and Buyer shall indemnify and hold Escrowee harmless from any and all conflicting claims and demands arising under this paragraph.
- 18. **SELLER'S REPRESENTATIONS**: Seller represents that to the best of Seller's knowledge, the Real Estate and its existing uses comply with, and Seller is not now in violation of any of the following: the Resource Conservation and Recovery Act of 1976 ("RCRA"), the Comprehensive Environmental Response, Compensation and Liability Act of 1980 ("CERCLA"), the Toxic Substances Control Act, the Illinois Environmental Protection Act and any of these statutes or any regulations promulgated

		,	<u> </u>	
Buyer Initial	Buyer Initial	Seller Initial	Seller Initial	
Address 106 S RIVER	R, EAST DUNDEE, il 60118			
Contract for the Sale	Page 3	3 of 7		

pursuant to the statutes. Seller represents that he has not received written notice from any Governmental body or Homeowner's Association of (a) zoning, building, fire or health code violations that have not been corrected; (b) any pending rezoning; or (c) a proposed or confirmed special assessments and/or special service area affecting the Real Estate. Seller further represents that Seller has no knowledge of boundary line disputes or easements or claims of easement not shown by the public record or of any hazardous waste on the Real Estate or any improvements for which the required permits were not obtained.

19. CONDITION OF REAL ESTATE AND INSPECTION: Seller agrees to leave the Real Estate in broom clean condition. All refuse and personal property that is not to be conveyed to the Buyer shall be removed from the Real Estate at the Seller's expense

- 19. **CONDITION OF REAL ESTATE AND INSPECTION:** Seller agrees to leave the Real Estate in broom clean condition. All refuse and personal property that is not to be conveyed to the Buyer shall be removed from the Real Estate at the Seller's expense before possession. Buyer shall have the right to inspect the Real Estate prior to closing to verify that the Real Estate is in substantially the same condition as the Date of Acceptance of this Contract, normal wear and tear excepted.
- 20 GOVERNMENTAL COMPLIANCE/1031 EXCHANGE: Parties agree to comply with the reporting requirements of the applicable sections of the Internal Revenue Code, Illinois Income Tax Act and the Real Estate Settlement Procedures Act of 1974, as amended. If Buyer or Seller hereunder desires to exchange other property of the like kind and qualifying use within the meaning of Section 1031 of the Internal Revenue Code of 1986, as amended, and the regulations promulgated thereunder, the parties shall cooperate in effectuating such a transaction provided, however, that said transactions not subject the non-exchanging party to additional cost or legal liability and does not extend any time periods set forth herein.
- 21. **ESCROW CLOSING:** At the election of either Party, not less than five (5) business days prior to the closing, this sale shall be closed through an escrow with the lending institution or the title company in accordance with the provisions of the usual from of Deed and Money Escrow Agreement as agreed upon between the Parties, with provisions inserted in the Escrow Agreement as may be required to conform with this Contract. The cost of the escrow shall be paid by the Party requesting the escrow.
- 22. FLOOD INSURANCE: Buyer shall obtain flood insurance if required by Buyer's lender.

- 23. FACSIMILE OR DIGITAL SIGNATURES: Facsimile or digital signatures shall be sufficient for purposes of executing, negotiating, and finalizing this Contract, and delivery thereof by one of the following methods shall be deemed delivery of this Contract containing his or her original signature. An acceptable facsimile signature may be produced by scanning an original, hand-signed document and transmitting same by facsimile. An acceptable digital signature may be produced by use of a qualified, established electronic security procedure mutually agreed upon by the Parties. Transmissions of digitally signed copy hereof shall be by an established, mutually acceptable electronic method, such as creating a PDF ("Portable Document Format") document incorporating the digital signature and sending same by electronic mail.
- 24. **BUSINESS DAY/HOURS:** Business Day are defined as Monday through Friday, excluding Federal Holidays. Business Hours are defined as 8:00 A.M. to 6:00 P.M. Chicago Time.
- 25. CHOICE OF LAW AND GOOD FAITH: All terms and provisions of this Contract including but not limited to the Attorney Review and Professional Inspection paragraphs shall be governed by the laws of the State of Illinois and are subject to the covenant of good faith and fair dealing implied in all Illinois contracts.

OTHER PROVISIONS: This Contract is also subject those OPTIONAL PROVISIONS selected for use and initialed by the Parties which are contained on the succeeding page and the following attachments, if any:						
OPTIONAL PROVISIONS (Applicable ONLY if initialed by all Parties)						

[Initials] \_\_\_\_\_\_\_\_27. CONFIRMATION OF DUAL AGENCY: The Parties confirm that they have previously consented to \_\_\_\_\_\_Patrick West - Patrick West Team \_\_\_\_\_\_(Licensee) acting as a Dual Agent in providing brokerage services on their behalf and specifically consent to Licensee acting as a Dual Agent with regard to the transaction referred to in this Contract.

#### 28. SALE OF BUYER'S REAL ESTATE:

REPRESENTATIONS ABOUT BUYER'S REAL ESTATE: Buyer represents to Seller as follows:
 Buyer owns real estate (hereinafter referred to as "Buyer's real estate") with the address of:

Address

City State Zip

Buyer [check one] has has not entered into a contract to sell Buyer's Real Estate.

2)	Buyer [ci	песк опеј	nas	has not entered into a contract to sell Buyer's Real Estate
	If Bu	uyer has entei	ed into a	contract to sell Buyer's real estate, that contract:
	a)	[check one]	is	is not subject to a mortgage contingency.
	b)	[check one]	is	is not subject to a real estate sale contingency.
	c)	[check one]	is	is not subject to a real estate closing contingency.

- Buyer [check one] has has not listed Buyer's real estate for sale with a licensed real estate broker and in a local multiple listing service.
- 4) If Buyer's real estate is not listed for sale with a licensed real estate broker and in a local multiple listing service, Buyer [check one]:

Buyer Initial Buyer Initial	Seller Initial	Seller Initial
Address 106 S RIVER, EAST DUNDEE, il 60118		
Contract for the Sale of Vacant Land REALTOR® Association of the Fo	x Valley, Inc.	Page 4 of <b>7</b>
Produced with Lone Wolf Transactions (zinForm Edition) 717 N Hangood S	t Suite 2200 Dallas TX 75201 www.lwolf.com	106 S RIVER

	Buyer Initial Address 106	Buyer Initial Seller Initial S S RIVER, EAST DUNDEE, il 60118	Seller Initial
	Buver Initial		aener ininar
		Puvor Initial Sallar Initial	Coller Initial
321 322 .	Attorne	ey Review and Professional Inspections provisions of this Contract have exp	ireu, been satistied or walved.
320		e null and void. Seller's notice to the purchaser under the prior contra	
319		, 20 In the event the prior contract is not cancelled wit	
318	a prior	real estate contract, this Contract shall be subject to written cancelation	
317		29. CANCELLATION OF PRIOR REAL ESTATE CONTRACT:	-
316		20 CANOLI ATION OF BRIOD REAL FOTATE CONTRACT	In the event either Destribute antique of the
315	Ра	ragraph 28 at any time, and Buyer agrees to cooperate in providing relevant inforr	nation.
314		JYER COOPERATION REQUIRED: Buyer authorizes Seller or Seller's agent	
313		all be null and void.	to confer and the second second
		· · · · · · · · · · · · · · · · · · ·	semed menective and this Contract
312		ditional earnest money within the time specified, the waiver shall be de	
311	of S		
310		b) when Buyer has delivered written waiver and deposited with the Escrowee	
309	d) WA	AIVER OF PARAGRAPH 28 CONTINGENCIES: Buyer shall be deemed to have v	vaived the contingencies in Paragraph
308		representative.	me paragraph by delicits attorney of
307		6) Buyer waives any ethical objection to the delivery of Notice under t	his paragraph by Seller's attorney or
306		of this Contract.	
305		5) Except as provided in Paragraph 28 c) above, all Notices shall be made in	the manner provided by Paragraph 15
304		Contract shall be null and void.	
303		4) If the contingencies set forth in Paragraph 28 d) are NOT waived in writing	g, within said time period by Buyer, this
302		3) If Buyer complies with the provisions of Paragraph 28 d) then this Contract	
301		first occurs.	
300		Chicago time on the next delivery day following deposit with the	overnight delivery company, whichever
		c) By commercial delivery overnight (e.g. FedEx). Notice shall be	
290 299		effective at 10:00 A.M. on the morning of the second day follows	
297 298		b) By mailing to the address recited herein for Buyer by regular m	
297			·
296		a) By personal delivery effective at the time and date of personal de	
295		purpose of this subparagraph only shall be served upon Buyer in the follow	
294		Notice invalid. Notice to any one of a multiple-person Buyer shall be suffice	
293		to Buyer's attorney and Buyer's real estate agent, if known. Failure to provi	
292		Buyer, not Buyer's attorney or Buyer's real estate agent. Courtesy copies	of such 'kick-out' Notice should be sent
291		2) Seller's Notice to Buyer (commonly referred to as a 'kick-out' Notice) sha	
290		gives such Notice to waive the contingencies set forth in Paragraph	
289		28 b) are in effect, Seller shall notify Buyer in writing of same. Buyer shall	
		1) If Seller accepts another bona fide offer to purchase the Real Estate while	
288	ine	e right to continue to show the Real Estate and offer it for sale subject to the follow	•
287			
286	c) SE	ELLER'S RIGHT TO CONTINUE TO OFFER REAL ESTATE FOR SALE: During	
285		the time specified, Buyer shall be in default under the terms of this Co	
284		null and void as of this date of Notice. If Notice as required by thi	
283		waives all contingencies in Paragraph 28 and complies with Para	graph 28 d), this Contract shall be
282		(3) Business Days of such termination, notify Seller of said termination.	
281		28 b) 1) (or after the date of this Contract if no date is set forth in Parag	
		3) If the contract for the sale of Buyer's real estate is terminated for any reas	
280			on often the date set fauth in Dana
279		and this Contract shall remain in full force and effect.	Johnson III und Palayrapii 20,
278		sentence, this contract shall be full and void. If Notice is not se sentence, Buyer shall have deemed to have waived all contingence	
277		sentence, this Contract shall be null and void. If Notice is not se	
276		is served before the close of business on the next Business Day aft	
275		or before, 20 If Notice that Buyer has not	
274		to the execution of this Contract, this Contract is contingent upon Buyer of	•
273		1) and that contract is in full force and effect, or has entered into a contract	
272		<ol><li>In the event Buyer has entered into a contract for the sale of Buyer's rea</li></ol>	I estate as set forth in Paragraph 28 b)
271		completed.)	
		shall remain in full force and effect. (If this paragraph is used, the	ien the following paragraph must be
270		<del>_</del>	<b>.</b> .
269		shall be deemed to have waived all contingencies contained in the	
268		estate is not served on or before the close of business on the date	
267		shall be null and void. If Notice that Buyer has not procured a	
266		subparagraph that Buyer has not procured a contract for the sale	•
265		than the Closing Date set forth in this Contract. If Notice is served or	
264		full force and effect as of, 20 Such contract s	
		, 3 (,,,	
263	۵, ۵		the cale of Ruyor's roal actate that is in
262	h) CC	DNTINGENCIES BASED UPON SALE AND/OR CLOSING OF REAL ESTATE:	
261		b) Does not intend to list said real estate for sale.	
260		[For information only] Broker:	noc.
259		listing service within five (5) Business Days after Date of Accepta	
258		a) Shall list real estate for sale with a licensed real estate broke	er who will place it in a local multiple

323	30. INTEREST BEARING ACCOUNT: Earnest money (with a completed W-9 and other required forms),
324 325	shall be held in a federally insured interest bearing account at a financial institution designated by Escrowee. All interest earned on the earnest money shall accrue to the benefit of and be aid to Buyer. Buyer shall be responsible for any administrative
326 327	fee (not to exceed \$100) charged for setting up the account. In anticipation of Closing, the Parties direct Escrowee to close the account no sooner than ten (10) Business Days prior to the anticipated Closing date.
328 329	
330	31. MISCELLANEOUS PROVISIONS: Buyer's and Seller's obligations are contingent upon the Parties entering into a separate written agreement consistent with the terms and conditions set forth herein, and with such additional
331	terms as ether Party may deem necessary, providing for one or more of the following [check applicable boxes]
332 333	Articles of Agreement for Deed Assumption of Seller's Mortgage Commercial/Investment
334	Or Purchase Money Mortgage Tax-Deferred Exchange New Construction
335 336	Short Sale
337	32. SPECIFIED PARTY APPROVAL: This Contract is contingent upon the approval of the Real Estate
338	byBuyer's Specified
339 340	Party, within five (5) Business Days after the Date of Acceptance. In the event Buyer's Specified Party does not approve of the
341 342	Real estate and notice is given within the time specified, this Contract shall be null and void. If Notice is not served within the time specified, this provision shall be deemed waived by the Parties and this Contract shall remain in full force and effect.
343	33. CREDIT AT CLOSING: Provided Buyer's lender permits such credit to show on the HUD-1 Settlement
344 345	Statement or Closing Disclosure, and if not, such lesser amount as the lender permits, Seller agrees to credit \$ to Buyer at Closing to be applied to prepaid expenses, closing costs or both.
346	
347 348	34. TRANSACTIONS NOT CONTINGENT ON FINANCING: IF EITHER OF THE FOLLOWING ALTERNATIVE OPTIONS IS SELECTED, THE PROVISIONS OF THE MORTGAGE CONTINGENCY PARAGRAPH HEREIN
349	SHALL NOT APPLY [CHOOSE ONLY ONE]:
350 351	a)Transaction With No Mortgage (All Cash): If this selection is made, Buyer will pay at closing, in the form of "Good Funds" the difference (plus or minus prorations) between the Purchase Price and the amount of Earnest
352	Money deposited pursuant to Paragraph 4 above. Buyer represents to Seller, as of the Date of Offer, that Buyer has sufficient
353 354	funds available to satisfy the provisions of this paragraph. Buyer agrees to verify the above representation upon the reasonable request of the Seller and to authorize the disclosure of such financial information to Seller, Seller's attorney or
355	Seller's broker that may be reasonably necessary to provide the availability of sufficient finds to close. Buyer understand
356	and agrees that, so long as Seller has fully complied with Seller's obligations under this Contract, any act or omission
357 358	outside of the control of Seller, whether intentional or not, that prevents Buyer from satisfying the balance due from Buyer at closing, shall constitute a material breach of this Contract by Buyer. The Parties shall share the title company escrow
359	closing fee equally. Unless otherwise provided in Paragraph 28, this Contract shall not be contingent upon the
360 361	sale and/or closing of Buyer's existing real estate. b) Transaction, Mortgage Allowed: If this selection is made, Buyer will pay at closing, in the form
362	of "Good Funds" the difference (plus or minus prorations) between the Purchase Price and the amount of Earnest Money
363	deposited pursuant to Paragraph 4 above. Buyer represents to Seller, as of the Date of Offer, that Buyer has sufficient
364 365	funds available to satisfy the provisions of this paragraph. Buyer agrees to verify the above representation upon the reasonable request of Seller and to authorize the disclosure of such financial information to Seller, Seller's attorney or
366	Seller's broker that may be reasonably necessary to prove the availability of sufficient funds to close. Notwithstanding such
367	representation, Seller agrees to reasonably and promptly cooperate with Buyer so that Buyer may apply for and obtain a
368 369	mortgage loan or loans including but not limited to providing access to the Real Estate to satisfy Buyer's obligations to pay the balance due (plus or minus prorations) to close this transaction. Such cooperation shall include the performance in
370	timely manner of all Seller's pre-closing obligations under this Contract. This Contract shall NOT be contingent upon
371 372	Buyer obtaining a commitment for financing. Buyer understands and agrees that, so long as Seller has fully complied with Seller's obligations under this Contract, any act or omission outside of the control of Seller, whether intentional or not,
373	that prevents Buyer from satisfying the balance due from Buyer at Closing shall constitute a material breach of this Contract
374	by Buyer. Buyer shall pay the title company escrow closing fee. Unless otherwise provided in Paragraph 28, this
375 376	Contract shall not be contingent upon the sale and/or closing of Buyer's existing real estate.
377	[LINES 377-388 LEFT INTENTIONALLY BLANK]
378 379	
380	
381 382	
383	
384 385	
386	
387	
388 [	Buyer Initial Seller Initial Seller Initial
	Address 106 S RIVER, EAST DUNDEE it 60118

OFFICIAL REALTOR®	ASSOCIATIO	N OF THE FOX VALLE	FORM HAS NOT BEEN Y, INC. CONTRACT FOR	THE SALE OF	ACANT LAND.	ML,
		, 20			, 20	)
Date of Offer			Date of Acceptance		,	
Buyer Signature			Seller Signature			
Buyer Signature			Seller Signature			
VILLAGE OF EAST DUN	DEE		LUZ MERY CARDENAS			
Print Buyer(s) Name(s)			Print Seller(s) Name(	s)		
Address			Address			
City		State Zip	City		State Zi	ip
						•
Phone Number(s)	ax	Email	Phone Number(s)	Fax	Email	
		FOR INFO	DRMATION ONLY			
Century 21 New Heritage-	Vest		Century 21 New Herita	ge-West		
Selling Office	MLS#		Listing Office	MLS#		
Patrick West Selling Agent	MLS#	patrickwestc21@g Email	HEIDI EVINGER Listing Agent	MLS#	heidievinger@ Email	<u>@gr</u>
322 N River St, East Du Address, City, State, Zip	ndee, IL 601	18	322 N RIVER ST, East Address, City, State, 2		118	
(847) 809-8734			(874)354-0704			
Phone	Fax		Phone	Fax		
KELLEY GANDURSKI Buyer's Attorney		Email	Seller's Attorney		Email	
Dayer 37 Moniey		Lillan	Seller's Attorney		Lillaii	
325 N LASALLE	CHICAGO	60654	A.1.1. O'1. O'1.	<b>-</b> *		
Address, City, State, Zip			Address, City, State, 2	zip		
(312)528-5199						
Phone	Fax		Phone	Fax		
Mortgage Company	1	Phone	Homeowner's/Condo	Assoc. (if any)	Phone	-
Loan Officer		Phone/Fax	Management Co./Oth	er Contact	Phone	
Loan Officer E-mail			Management Co./Oth	er Contact Email		
This offer was presente	ed to Seller by	,	•	at		Πr
		Agent	···			F
THIS OFFER IS REJEC	red	Seller Initials	on	at	am/ [	] pr
		Ochor miliais				

Contract for the Sale of Vacant Land REALTOR® Association of the Fox Valley, Inc.

### RIDER #1

## TO CONTRACT FOR THE SALE OF VACANT LAND

1. The following replaces Section 4 of the Contract:

Within 5 days after the end of the Attorney Review (as hereinafter defined), Buyer will deposit \$15,000.00 ("*Earnest Money*") with the Chicago Title Insurance Company (the "*Title Company*"), pursuant to mutually acceptable strict joint order escrow instructions. The Earnest Money will be applied to the Purchase Price on the Closing Date, if the Closing occurs. The Earnest Money will be returned to Buyer if the Closing does not occur.

2. The following replaces the first sentence of Section 9 of the Contract:

Buyer shall have until the date which is 10 days after Buyer receives the Plat of Survey, title commitment, and copies of all underlying title documents to determine the suitability of the Real Estate for Buyer's intended use.

3. The following replaces the first sentence of Section 11 of the Contract:

This Contract will become effective on the date it is fully executed ("*Effective Date*"). Within 10 days of the Effective Date, Seller shall at Seller's expense, furnish to Buyer or Buyer's attorney a Plat of Survey of the Real Estate that confirms to the current Minimum Standard of Practice for boundary surveys, is dated not more than 6 months prior the date of Closing, and is prepared by a professional land surveyor licensed to practice land surveying under the laws of the State of Illinois.

4. The following replaces Section 16 of the Contract:

Within 10 days of the Effective Date, Seller, at Seller's expense, will obtain and deliver to Buyer a title commitment issued by the Title Company, in the amount of the Purchase Price ("Title Commitment"), together with copies of all underlying title documents listed in the Title Commitment, subject only to those matters described in Section 12. If the Title Commitment or the Plat of Survey disclose exceptions to title, which are not acceptable to Buyer ("Unpermitted Exceptions"), Buyer will have 10 days from the later of the delivery of the Title Commitment and the Plat of Survey to object to the Unpermitted Exceptions. Buyer will provide Seller with an objection letter ("Buyer's Objection Letter") listing the Unpermitted Exceptions, which are not acceptable to Buyer. Seller will have until the Closing ("Seller's Cure Period") to have the Unpermitted Exceptions removed from the Title Commitment or to cure such Unpermitted Exceptions or to have the Title Company commit to insure against loss or damage that may be occasioned by such Unpermitted Exceptions. If Seller fails to have the Unpermitted Exceptions removed or, in the alternative, to obtain a Title Commitment insuring the Unpermitted Exceptions within the specified time, Buyer may elect to either (i) terminate this Contract and this Contract will become null and void without further action of the parties, or (ii) upon notice to Seller before the Closing, take title as it then is with the right to deduct from the Purchase Price any liens or encumbrances of a definite or ascertainable amount which are listed in the Title Commitment. Seller shall furnish Buyer at Closing an Affidavit of Title covering the date of Closing, and sign any other customary forms required by Title Company for issuance of an owner's title insurance policy.

## 5. The following replaces the second sentence of Section 17:

In the event of a default by Seller, Buyer may, at its option: (i) elect to enforce the terms hereof by action for specific performance, (ii) terminate this Contract and receive a refund of the Earnest Money, or (iii) proceed to Closing notwithstanding such breach or nonperformance. In all events, Buyer's rights and remedies under this Contract will always be non-exclusive and cumulative and the exercise of one remedy will not be exclusive of or constitute the waiver of any other, including all rights and remedies available to it at law or in equity. In the event of a default by Buyer, Seller's sole and exclusive right and remedy will be to terminate this Contract. Notwithstanding the foregoing, the parties agree that no default of or by either party will be deemed to have occurred unless and until notice of any failure by the non-defaulting party has been sent to the defaulting party and the defaulting party has been given a period of five business days from receipt of the notice to cure the default.

## 6. The following replaces Section 21:

The sale shall be closed through an escrow with the Title Company in accordance with the provision of the usual form of Deed and Money Escrow Agreement as agreed upon by the Parties, with provisions inserted in the Escrow Agreement as may be required to conform with this Contract. The parties need not physically attend the Closing. Seller will pay the costs charged by the Title Company for the title policy, the cost of the Plat of Survey, and half of the escrow costs. Buyer will pay the costs charged by the Title Company for any title endorsements requested by Buyer, costs of recording the Deed, half of the escrow costs. Buyer and Seller will each pay their respective attorney's fees.

If cash transaction

If Buyer is 100% cash purcasher

7. The following is added to the end of the Contract:

Notwithstanding anything in the Contract to the contrary, Buyer and Seller acknowledge and agree that Buyer is a municipal entity and this Contract is subject to the approval of, and is not enforceable unless approved at an open meeting by, the President and Board of Trustees of Buyer. Said approval and closing to take place on or before August 30, 2024. The Parties shall mutually agree on the date and time of closing.

### Agreed and accepted by:

**-**

Village of East Dundee	Seller: Luz Mery Cardenas Living Trust dated May 10, 2007
By:	Ву:
	Luz Mery Cardenas, Trustee

### Memorandum

**To:** Village President and Board of Trustees

From: Franco Bottalico, Assistant to the Village Administrator

**Subject:** 107 Water St. – Warner and Troost Monument Company Sign Variance

**Date:** July 15, 2024

## **Action Requested**

Staff recommends a motion for approval of the Findings of Fact regarding a variation from Section 156.04(C)(1)(a) regarding the maximum number of wall signs for each business, and a request for a variance from Section 156.04(C)(1)(b) regarding the maximum square feet allowed for a business establishment identification wall sign, for the property located at 107 Water St., East Dundee, IL, 60118 PIN 03-23-318-007, located in the B-1 Downtown Business District.

## **Attachments**

Findings of Fact



#### **Village Board of Trustees Meeting**

#### Findings of Fact – Variance

**Property Location**: 107 Water St. – Warner and Troost Monument Company Sign Variance

Pin: 03-23-318-007

Hearing Date: July 15, 2024

**Variance** 

**Requested**: A variation from Section 156.04(C)(1)(a) regarding the maximum number of wall signs

for each business, and a request for a variance from Section 156.04(C)(1)(b) regarding the maximum square feet allowed for a business establishment identification wall

sign.

Staff has determined the below findings of fact for the Village Board's consideration and review:

1. The property in question cannot yield a reasonable return if permitted to be used only under the conditions allowed by the regulations in that zoning district; Yes/No/Not Applicable (N.A.):

No

2. The plight of the owner is due to unique circumstances; Yes/No/N.A.

3. The variation, if granted, will not alter the essential character of the locality; Yes/No/N.A.

4. The particular physical surroundings, shape or topographical conditions of the specific property involved would bring a particular hardship upon the owner as distinguished from a mere inconvenience if the regulations were strictly enforced; Yes/No/N.A.
No

5. The conditions upon which the petition for variation is based would not be applicable generally to other property within the same zoning classification; Yes/No/N.A.
No

6. The purpose of the variation is not based exclusively upon a desire to make more money out of the property; Yes/No/N.A.

No

7. The alleged difficulty or hardship has not been created by any person presently having an interest in the property; Yes/No/N.A.

No

- 8. The granting of the variation will not be detrimental to the public welfare or injurious to other property or improvements in the neighborhood in which the property is located; Yes/No/N.A. Yes
- 9. The proposed variation will not impair an adequate supply of light and air to adjacent property or substantially increase the danger of fire or otherwise endanger the public safety or substantially diminish or impair property values within the neighborhood; Yes/No/N.A. Yes

Due to the usual nature of the operation of special uses that may give rise to unique problems with respect to their impact upon neighboring property or public facilities, the Village may stipulate conditions and restrictions upon the establishment, location, construction, maintenance, and operation of the use as deemed necessary for the protection of the public interest. In addition, the Board may require such conditions and restrictions by a variation(s) as may be necessary to comply with the standards set forth in the Village Code or reduce or minimize the injurious effect of the variation(s) upon the other property in the neighborhood.

Based on the information contained in the application and the testimony and evidence presented at the public hearing, the Village Board of Trustees voted on these findings of fact and the requested variance resulting in the following vote:

ayes	nays absent abstain	
Date:		
Signature:		
	Village President	

#### Memorandum

**To:** Village President and Board of Trustees

**From:** Franco Bottalico, Assistant to the Village Administrator

**Subject:** 107 Water St. – Warner and Troost Monument Company Sign Variance Request

**Date:** July 15, 2024

#### **Action Requested**

A motion for approval or denial of an ordinance granting variations from Section 156.04(C)(1) regarding the number of wall signs allowed for each business and the maximum square feet allowed for a business establishment identification wall sign located at 107 Water St., East Dundee, IL, 60118 (PIN 03-23-318-007) located in the B-1 Downtown Business District.

#### **Summary**

Staff received an application from Lisa Troost Sottrel and Jason Solarz of Warner and Troost Monument Company ("Applicant") who desire to repair an existing sign on the west side of their building located at 107 Water St. ("Property") in the Historic District. However, this property is unique as it is a legal non-conforming use, as monuments are not permitted in the B-1 Downtown Business District.

Because the Property already has three existing signs, and needs to replace one of them, a sign variance would be requested in order to modify the sign located on the Property's west-facing wall. Section 156.04(C)(1)(a) states the following:

There shall be a maximum of one such wall sign for each business establishment; provided, however, that a maximum of two signs shall be permitted when the business establishment to which the sign refers is located on a corner lot.

Additionally, if approved, their proposed sign is larger than what is permitted, coming in at approximately 17% sq. ft., which requires a variance. Building Official, Chris Ranieri, states the wall area is 450 sq. ft. and the new proposed sign will be 79 sq. ft., which exceeds the 10% sq. ft. area. Section 156.04(C)(1)(b), which states the following:

The maximum size of any business identification wall sign shall not exceed 10% of the front building facade area to a maximum of 100 square feet.



Lastly, a Certificate of Appropriateness was not heard by the PZHC because the Property is within the Historic District, and Section 153.17(E) states the following:

The Village President, Village Administrator and the Building Inspector shall evaluate the effects of any applications for a sign permit within the District, pursuant to appropriate provisions of <u>Chapter 156</u> of this code of ordinances, considering the purposes of this chapter. A copy of every application submitted to the Building Inspector shall be immediately forwarded by the Building Inspector to the Village President and Village Administrator, which in their discretion, may recommend changes in the design, size or other features of the sign to assure its compatibility with the visual integrity and historic or architectural character of the District. The recommendations shall be considered by the Building Inspector in the normal process of issuing a sign permit.

Attached to this memo is a copy of the application with illustrations for review.

Staff recommends a neutral position on these variance requests.

#### **Attachments**

Ordinance with Findings of Fact Exhibit
Daily Herald Certificate of Publication
Redacted Application
Existing sign photos
Design renderings

#### ORDINANCE NUMBER 24 - \_\_\_

AN ORDINANCE OF THE VILLAGE OF EAST DUNDEE, COOK AND KANE COUNTIES, ILLINOIS GRANTING VARIATIONS FROM SECTION 156.04(C)(1) REGARDING THE NUMBER OF WALL SIGNS ALLOWED FOR EACH BUSINESS AND THE MAXIMUM SQUARE FEET ALLOWED FOR A BUSINESS ESTABLISHMENT IDENTIFICATION WALL SIGN LOCATED AT 107 WATER STREET, EAST DUNDEE, IL 60118 (PIN 03-23-318-007-0000) LOCATED IN THE B-1 BUSINESS DISTRICT

**WHEREAS**, the Village of East Dundee ("*Village*") is a home rule unit of local government pursuant to Section 6 of Article VII of the Constitution of the State of Illinois, and has the authority to exercise any power and perform any function pertaining to its government and affairs; and

**WHEREAS**, Peter Troost Monument Company ("*Owner*") is the owner of the property located at 107 Water Street, East Dundee, Illinois 60118, legally described in Section 2 below ("*Subject Property*"); and

**WHEREAS**, Owner filed an application("*Application*") with the Village seeking: (1) a variation from Section 156.04(C)(1)(a) of the Zoning Chapter of the East Dundee Village Code ("*Zoning Ordinance*") limiting the number of wall signs permitted to one sign for each business; and (2) a variation from Section 156.04(C)(1)(b) of the Zoning Ordinance which limits the maximum size of any business identification wall sign to 10 percent of the front building façade area up to a maximum of 100 square feet; and

**WHEREAS**, pursuant to Section 157.207 of the Zoning Ordinance, and the Village's home rule authority, the President and Board of Trustees of the Village may provide for and allow variances to the requirements of the Zoning Ordinance when there are practical difficulties or a particular hardship with the strict compliance with the Zoning Ordinance; and

**WHEREAS**, pursuant to Section 156.05 of the Village Code, the Village Board may hear requests for variations from the terms of the Village's Sign Code pursuant to the procedure described in Chapter 157 of the Zoning Ordinance; and

**WHEREAS**, the Village Board of Trustees convened and held a public hearing on July 15, 2024 to consider the Application for the requested variances; and

**WHEREAS**, the Village President and Board of Trustees reviewed the standards set forth in Section 157.207 of the Zoning Ordinance for variations and recommended approval of the Application, and related findings of fact; and

**WHEREAS**, the Village President and Board of Trustees find it to be in the best interests of the health, safety, and welfare of its residents to approve the requested variations subject to the conditions contained within Section 3 of this Ordinance;

**NOW, THEREFORE, BE IT ORDAINED** by the Village President and Board of Trustees of the Village of East Dundee, Cook and Kane Counties, Illinois, as follows:

<u>SECTION 1</u>: Incorporation. That each Whereas paragraph above is incorporated by reference into this Section 1 and made a part hereof as material and operative provisions of this Ordinance.

**SECTION 2**: **Variation.** That the Corporate Authorities hereby grant the variations as described below requested in the Application for the Subject Property, legally described as:

PIN 03-23-318-007-0000

LOT 2 (EXCEPT THE SOURTHERLY 66.67 FEET THEREOF), THE SOUTHERLY 63 FEET OF LOT 3, AS MEASURED ALONG WEST LINE OF WATER STREET, OF HAERTEL'S SUBDIVISION, IN THE VILLAGE OF EAST DUNDEE, KANE COUNTY, ILLLINOIS.

#### **Variation**

A variation from 156.04(C)(1)(a) of the Zoning Chapter of the East Dundee Village Code regarding the maximum number of wall signs for each business, and a variation from Section 156.04(C)(1)(b) limiting the maximum size of any business identification wall sign to 10 percent of the front building façade area up to a maximum of 100 square feet, as described in the Application. The variation granted in this Ordinance is specific to the project as proposed in the Application and shall not apply to any other development of the Subject Property.

**SECTION 3**: Conditions of Approval. That the variances granted herein shall be constructed, operated and maintained in accordance with any plans and diagrams submitted as part of the Application, and shall be subject to the following terms and conditions:

- 1. The variances granted by this Ordinance cannot be transferred and shall expire at such time Applicant ceases operations at PIN 03-263-318-007-0000.
- <u>SECTION 4</u>: Severability. That if any Section, paragraph or provision of this Ordinance shall be held to be invalid or unenforceable for any reason, the invalidity or unenforceability of such Section, paragraph or provision shall not affect any of the remaining provisions of this Ordinance.
- **SECTION 5**: **Repeal.** That all ordinances, resolutions, motions or parts thereof in conflict herewith shall be and the same are hereby repealed.
- **SECTION 6**: **Effect.** That this Ordinance shall be in full force and effect forthwith upon its adoption, approval and publication in pamphlet form as provided by law.

[SIGNATURE PAGE FOLLOWS]

**PASSED** this 15<sup>th</sup> day of July 2024 pursuant to a roll call vote as follows:

AYES:	
NAYES:	
APPROVED by me this 1	5 <sup>th</sup> day of July 2024.
	Jeffrey Lynam, Village President
ATTEST:	
Katherine Diehl, Village Clerk	
Published in pamphlet form this President and Board of Trustees	s 15 <sup>th</sup> day of July 2024, under the authority of the Village s.
Recorded in the Village records	on July, 2024.
Date: July, 2024	



#### **Village Board of Trustees Meeting**

#### Findings of Fact – Variance

**Property Location**: 107 Water St. – Warner and Troost Monument Company Sign Variance

Pin: 03-23-318-007

Hearing Date: July 15, 2024

**Variance** 

**Requested**: A variation from Section 156.04(C)(1)(a) regarding the maximum number of wall signs

for each business, and a request for a variance from Section 156.04(C)(1)(b) regarding the maximum square feet allowed for a business establishment identification wall

sign.

Staff has determined the below findings of fact for the Village Board's consideration and review:

1. The property in question cannot yield a reasonable return if permitted to be used only under the conditions allowed by the regulations in that zoning district; Yes/No/Not Applicable (N.A.):

No

2. The plight of the owner is due to unique circumstances; Yes/No/N.A.

110

3. The variation, if granted, will not alter the essential character of the locality; Yes/No/N.A.

4. The particular physical surroundings, shape or topographical conditions of the specific property involved would bring a particular hardship upon the owner as distinguished from a mere inconvenience if the regulations were strictly enforced; Yes/No/N.A.

No

5. The conditions upon which the petition for variation is based would not be applicable generally to other property within the same zoning classification; Yes/No/N.A.

No

6. The purpose of the variation is not based exclusively upon a desire to make more money out of the property; Yes/No/N.A.

No

7. The alleged difficulty or hardship has not been created by any person presently having an interest in the property; Yes/No/N.A.

No

- 8. The granting of the variation will not be detrimental to the public welfare or injurious to other property or improvements in the neighborhood in which the property is located; Yes/No/N.A.

  Yes
- 9. The proposed variation will not impair an adequate supply of light and air to adjacent property or substantially increase the danger of fire or otherwise endanger the public safety or substantially diminish or impair property values within the neighborhood; Yes/No/N.A.
  Yes

Due to the usual nature of the operation of special uses that may give rise to unique problems with respect to their impact upon neighboring property or public facilities, the Village may stipulate conditions and restrictions upon the establishment, location, construction, maintenance, and operation of the use as deemed necessary for the protection of the public interest. In addition, the Board may require such conditions and restrictions by a variation(s) as may be necessary to comply with the standards set forth in the Village Code or reduce or minimize the injurious effect of the variation(s) upon the other property in the neighborhood.

Based on the information contained in the application and the testimony and evidence presented at the public hearing, the Village Board of Trustees voted on these findings of fact and the requested variance resulting in the following vote:

ayes	nays absent abstain
Date:	
Signature:	
	Village President



#### APPLICATION FOR SIGN VARIANCE

This form is to be used for all SIGN VARIANCE applications (except Planned Developments) to be heard by the Village of East Dundee Village Board at a Public Hearing.

Failure to complete this form properly will delay its consideration.

#### PART I. GENERAL INFORMATION

A.	Project Information Project/Owner Name: Warner and Troost Monument Company Sign Replacement		
Project/Owner Name: Warner and Troost Monument Company Sign Replacement     Project Location: 07 Water St East Dundee, IL 60118			
	Brief Project Description:		
	Replacing lettering on back (west side) of building. Old letters spelled MONUMENT were damaged		
	during painting. Replacing with WARNER AND TROOST MONUMENT COMPANY		
	Project Property Legal Description: provide the legal description in a word document.  Lot 2 (except the southerly 66.67 feet thereof) the southerly 63 feet of lot 3, as measured along west		
	line of Water Street, of Haertel's subdivision, in the Village of East Dundee, Kane County, Illinois		
i.	Project Property Size in Acres and Square Feet: see attached		
	Current Zoning Status: 0060-Commercial		
	Current Use Status: Retail office space		
	Surrounding Land Use Zoning:		
0.	Zoning District Being Requested (if applicable):  Parcel Index Numbers of Property: 03-23-318-007		
<b>B.</b>	Owner Information Signature: Are Loose Settle		
	Name: Peter Troost Monument Company		
	Address:		
1.	Phone Number:		
c.	Billing Information (Name and address all bills should be sent to)		
1.	Name/Company: Warner and Troost Monument Company		
2.	Address: 107 Water St. East Dundee, IL 60118		
3.	Phone Number		

## FOR A SIGN VARIANCE COMPLETE THE FOLLOWING:

From which specific standard  Code (C) Business	of the Village Code is a Variance requested (include Code section number)?  Districts (B-1, B-2, B-3, B-4)
For this site, what does the Co  1 Sign per property	
What is proposed?	
	n on west side of building
Repaint West Side V	Ve caused the need for a variance?
Trees removed expo	sing west side wall. Repainted & re Branded signage from Monum
to Warner & Troost	Monument Company
	res will be used to ensure that the essential character of the area will not be altered? (Suitable)
on west side.	litional signage, only repairing and re branding to look better

	he building is visible to the public on 3 sides. We are not looking to add addit
3	ignage where there already is some. We want to replace what had been them
S	o the public is not looking at an unmarked building from across the river.
Spec	rifically, what conditions are present on the property that would not be applicable generally to other property within th
to	e are not looking to oversaturate the front of the building with signage. We wastefully ophened the city of the building with signage.
	tasterdily enhance the view on all sides so when viewed from across the rive
It	is not just of the back of a building.
_	
Other	than financial return, what other purposes is the variance request based on?
	replace signage that was damaged while upkeeping property.
-	
Has th	ne alleged difficulty bear and the
	ne alleged difficulty been created by any person presently having an interest in the property?
Has th	
No	
No	give an explanation for any questions answered YES.
No Please a.	give an explanation for any questions answered YES.  Will the granting of the variation be detrimental to the public welfare? (Circle)
Please a. b.	give an explanation for any questions answered YES.  Will the granting of the variation be detrimental to the public welfare? (Circle)  Injurious to surround properties? (Circle)
Please a. b. c.	give an explanation for any questions answered YES.  Will the granting of the variation be detrimental to the public welfare? (Circle)  Injurious to surround properties? (Circle)  Impair an adequate supply of light and air to adjacent property? (Circle)
Please a. b. c. d.	give an explanation for any questions answered YES.  Will the granting of the variation be detrimental to the public welfare? (Circle)  Injurious to surround properties? (Circle)  Impair an adequate supply of light and air to adjacent property? (Circle)  Endanger public health and safety? (Circle)
Please a. b. c. d.	give an explanation for any questions answered YES.  Will the granting of the variation be detrimental to the public welfare? (Circle)  Injurious to surround properties? (Circle)  Impair an adequate supply of light and air to adjacent property? (Circle)  Endanger public health and safety? (Circle)  Substantially diminish property values within the neighborhood? (Circle)
Please a. b. c. d.	give an explanation for any questions answered YES.  Will the granting of the variation be detrimental to the public welfare? (Circle)  Injurious to surround properties? (Circle)  Impair an adequate supply of light and air to adjacent property? (Circle)  Endanger public health and safety? (Circle)  Substantially diminish property values within the safety of the sa
Please a. b. c. d.	give an explanation for any questions answered YES.  Will the granting of the variation be detrimental to the public welfare? (Circle)  Injurious to surround properties? (Circle)  Impair an adequate supply of light and air to adjacent property? (Circle)  Endanger public health and safety? (Circle)  Substantially diminish property values within the neighborhood? (Circle)  Conformance to the Land Use Plan? (Circle)
Please a. b. c. d.	give an explanation for any questions answered YES.  Will the granting of the variation be detrimental to the public welfare? (Circle)  Injurious to surround properties? (Circle)  Impair an adequate supply of light and air to adjacent property? (Circle)  Endanger public health and safety? (Circle)  Substantially diminish property values within the neighborhood? (Circle)  Conformance to the Land Use Plan? (Circle)
Please a. b. c. d.	give an explanation for any questions answered YES.  Will the granting of the variation be detrimental to the public welfare? (Circle)  Injurious to surround properties? (Circle)  Impair an adequate supply of light and air to adjacent property? (Circle)  Endanger public health and safety? (Circle)  Substantially diminish property values within the neighborhood? (Circle)  Conformance to the Land Use Plan? (Circle)
Please a. b. c. d.	give an explanation for any questions answered YES.  Will the granting of the variation be detrimental to the public welfare? (Circle)  Injurious to surround properties? (Circle)  Impair an adequate supply of light and air to adjacent property? (Circle)  Endanger public health and safety? (Circle)  Substantially diminish property values within the neighborhood? (Circle)  Conformance to the Land Use Plan? (Circle)
Please a. b. c. d.	give an explanation for any questions answered YES.  Will the granting of the variation be detrimental to the public welfare? (Circle)  Injurious to surround properties? (Circle)  Impair an adequate supply of light and air to adjacent property? (Circle)  Endanger public health and safety? (Circle)  Substantially diminish property values within the neighborhood? (Circle)  Conformance to the Land Use Plan? (Circle)
Please a. b. c. d.	give an explanation for any questions answered YES.  Will the granting of the variation be detrimental to the public welfare? (Circle)  Injurious to surround properties? (Circle)  Impair an adequate supply of light and air to adjacent property? (Circle)  Endanger public health and safety? (Circle)  Substantially diminish property values within the neighborhood? (Circle)  Conformance to the Land Use Plan? (Circle)

## THE APPLICANT MUST PROVIDE A MAILING LIST AND ADDRESSED; POSTAGE PAID ENVELOPS FOR ALL PROPERTY OWNERS WITHIN 250 FEET OF THE SUBJECT PROPERTY.

The Dundee Township can provide the list of properties. at info@dundeetownship.org

Application fee.

For business districts (B-1, B-2, B-3, B-4) is \$150.00 plus a \$250.00 deposit to pay for village cost. For other districts (AG-1, OD, M-1, M-2) is \$200.00 plus a \$1,000.00 deposit to pay for village cost.

## APPLICATION AGREEMENT TO PAY COSTS INCURRED AND HOLD THE VILLAGE HARMLESS

The Undersigned applicant acknowledges that the Village of East Dundee may seek advice and counsel from professional sources outside the employee staff of the Village of East Dundee in consideration of the application submitted to the Village of East Dundee by the applicant, including the services as those provided by the Village Staff, Village Attorney, Village Engineer, Planner and Fire Protection District.

The applicant further acknowledges that testimony of all witness at Public Hearings may be recorded before a court reporter and that full transcripts of the proceedings may be prepar4ed and retained by the Village of East Dundee as part of the official record concerning the said applicant and the applicant's costs.

As an express condition in making the said application and the consideration thereof by the Village of East Dundee, the undersigned, both personally and on behalf of the applicant, agrees to hold the Village harmless and agrees to pay forthwith the costs and expenses that may be incurred by the Village of East Dundee for such professional services, including the costs and expenses of recording and transcribing any testimony at Public Hearings in connection with the said application.

The owner hereby authorizes, support and consents to this request for variation, and further authorizes, agrees and consents to allow the temporary installation and display by the Village of East Dundee of Public Notice (signage) upon the subject property.

The applicant, having read this application and fully understanding the purpose thereof, declares that the proceeding statement made are true and that the information provided herein is complete to the best of the applicant's knowledge and belief.

Individually and for the Applicant	518124
Individually and for the Applicant	Data



### Affidavit of Ownership & Control

I (We), LisaT contract purchasers, or application of such.	beneficiary(s) of the title holding to	do herby certify or affirm that I am the owner(s	), ke
Signature:	hour late		
Owner: Lisa T	Troost Sottvel		
Address			
Phone: _			

SUBSCRIBED AND SWORN TO before me this day of Vou , 2024.

(NOTARY SIGNATURE)

OFFICIAL SEAL
MARYBETH REVOIR
NOTARY PUBLIC, STATE OF ILLINOIS
MY COMMISSION EXPIRES: 1/26/2026



### Affidavit & Disclosure Agreement

To cover the Village expenses relating to applications for Variations:

Applications shall deposit the sum required based on the type and extent of the applicant's project. Any bills received by the village and any costs incurred by the Village related to the project will be billed to the applicant. Upon payment of all bills to the Village the applicant will receive their deposit back.

Signature: dise house South

Print Name: LisaTrost Soffred

Project Address: 107 E. water St.


## ALAN J. COULSON, P.C.

PROFESSIONAL LAND SURVEYORS

## Plat of Survey

OF PROPERTY DESCRIBED AS:

Lot 2 (except the Southerly 66.67 feet thereof), the Southerly 63 feet of Lot 3, as measured along West Line of Water Street, of Haertel's Subdivision, in the Village of East Dundee, Kane County, Illinois.

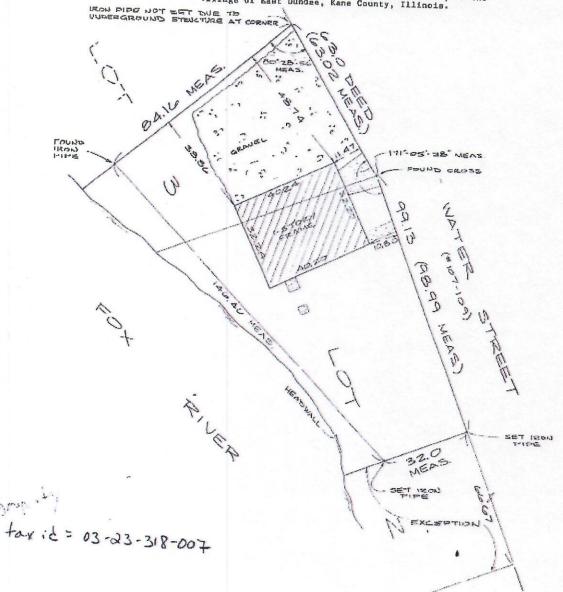

 Scale:
 1" + 2.0"

 Ordered:
 J.Bolz

 Owner:
 Troost

 Page:
 3-23E

 Orawn:
 J.J.

Jab: A48,293SL City: East Dunder STATE OF ILLINOIS IN SEPT. 26, 1995

I hereby certify that the buildings on lot shown are within property lines and that the edipoining improvements do not encreach on says premises.

Any discrepancy in measurements should be promptly reported to surveyor for explanation or correction.

WE OD NOT CERTIFY AS TO LOCATION OF UNDERGROUND IMPROVEMENTS.

THIS SURVEY IS VALID ONLY WITH EMBOSSED SEAL.

I hereby certify that I have surveyed the above deteribed premium according to the official record, and that the above plat correctly represents said survey.

ALAN J. SQUISON, P.C. PROFESSIONAL LAND SURVEYORS ILLINDIS -- WISCONSIN

205 W MAIN 51. W. OLNDEE, IL 60110

PHONE 708 - 428-2911

Compare the description on this plat with deed. Refer to deed for easements and building lines.



## Village of East Dundee

120 Barrington Ave. East Dundee, IL 60118 Phone: 847-426-2822 x2 Email:ghess@eastdundee.net

## Sign Application

Date: 4/02/2024 Permit No:	
Address of Proposed Sign: 107 Water St., East Dundee, IL 60118	
Business Name Warner & Troost Monument Company Owner Phone:	
Owner/Manager Name &Address: Jason Solarz,107 Water St City: E	ast Dundee
State: IL Zip Code: 60118 Parcel No:	
Contractors Name: Signarama	
Address: 58 E Main St., Carpentersville, IL 60110 Phone: 847-783	3-4870
	ama-carpentersville.com
Plat of Survey attached indicating location of sign: Yes No Zoning Classification:	
Front Façade Wall Area 450sqft Height from Grade 8.5 ft.	
Front Façade Wall Area Height from Grade Height from Grade	
<b>Note:</b> A scale, color drawing is required for all signage to determine compliance.	
✓ CHECK ALL BOXES THAT APPLY	
Freestanding Electric Wall Monument	Banner
Window Canopy/Awning Face Change Temporary	Other
251 5" 45 3" 79	<u> </u>
	ft.
Approved:	
Not Approved: Cost of Sign: \$ 2,100	0
Owner or Authorized Agent Print Nan	ma
Owner of Authorized Agent Fillit Nati	
Building Off	ficial
Received by Check# Cash Date: Historical Approval_	

State of Illinois
Counties of Cook and Kane ) SS
Village of East Dundee
MotTice of Public Hearing
Notice is hereby given that the Village Board of Trustees of the Village of East Dundee will hold a public hearing on July 15, 2024, at 6:00 P.M. at the East Dundee Police Station 2nd Floor Meeting Room, 115 E. 3rd Street, East Dundee, Illinois, to consider the following request:
A request for a variance from Section 156.04(C)(1)(a) regarding the maximum number of wall signs for each business, and a request for a variance from Section 156.04(C)(1)(b), regarding the maximum square feet allowed for a business establishment identification wall sign, for the property located at 107 Water St., East Dundee, IL, 60118 PIN 03-23-318-007, located in the B-1 Downtown Business District.
PIN: 03-23-318-007, located in the B-1 Downtown Business District.
PIN: 03-23-318-007, THE SOUTHERLY 66.67 FEET THEREOF, THE SOUTHERLY 66.67 FEET THEREOF, THE SUBDIVISION, IN THE VILLAGE OF EAST DUNDEE, KANE COUNTY, ILLLINOIS. All interested persons will be given an opportunity to be leard. Any questions regarding this public hearing process may be directed to Franco Bottalico, 120 Barrington Avenue, East Dundee, Illinois, 60118 via email at FBottalico@eastdundee.net, or by phone at (847) 815-0472. Published in Dally Herald June 20, 2024 (4616858)

#### CERTIFICATE OF PUBLICATION

Paddock Publications, Inc.

## Fox Valley **Daily Herald**

Corporation organized and existing under and by virtue of the laws of the State of Illinois, DOES HEREBY CERTIFY that it is the publisher of the Fox Valley DAILY HERALD. That said Fox Valley **DAILY HERALD** is a secular newspaper, published in Elgin, Kane County, State of Illinois, and has been in general circulation daily throughout Kane County, continuously for more than 50 weeks prior to the first Publication of the attached notice, and a newspaper as defined by 715 ILCS 5/5.

I further certify that the Fox Valley DAILY HERALD is a newspaper as defined in "an Act to revise the law in relation to notices" as amended in 1992 Illinois Compiled Statutes, Chapter 715, Act 5, Section 1 and 5. That a notice of which the annexed printed slip is a true copy, was published 06/20/2024

in said Fox Valley DAILY HERALD. This notice was also placed on a statewide public notice website as required by 5 ILCS 5/2.1.

Designee of the Publisher of the Daily Herald

Control # 4616858











# Goudy Extra Bold Letters Color: White 15" & 10"

251.52 in

MONUMENT COMPANY

MONUMENT COMPANY

#### Memorandum

**To:** Village President and Board of Trustees

**From:** Erika Storlie, Village Administrator

Franco Bottalico, Assistant to the Village Administrator

**Subject:** Downtown Parking Garage Contract Amendment Approval

**Date:** July 15, 2024

ERST= DUNDEE

#### **Action Requested:**

Staff recommends Village Board approval of a resolution authorizing the Village Administrator to execute a contract amendment with McHugh Construction Co. (1737 S. Michigan Ave., Chicago IL 60616) for the final pricing, design and construction of a parking garage in downtown East Dundee.

#### **Summary:**

At the October 2, 2023, Village Board meeting the Village Board reviewed the responses to the Request for Proposals (RFP) for the design and construction of a parking garage and directed staff to begin contract negotiations with McHugh Construction Co, a responsible bidder for the project. The original contract with McHugh Construction was approved by the Village Board on January 22, 2024, and started the process of designing the 2-story structure. During the process, the Village Board modified the scope of the project to include commercial storefront space that could be sold separately to add value to the downtown and the project.

The construction timeline for the project has a target date of substantial completion of November 2024. The design includes a 2-story parking garage with 131 parking spaces and 6,295 square feet of commercial storefront space.

At the May 20, 2024, Village Board meeting, the Village Board approved the issuance of bonds to fund the remainder of the project that will not be covered by grant funding and cash on hand. The project costs have been bid out by McHugh and the final project cost is \$6,998,247. This final number is slightly higher than what McHugh provided earlier this spring, representing an increase of \$66,306. Their original estimate was \$6,931,941 once the commercial space was included.

The attached contract amendment solidifies the pricing and authorizes the project to move forward.

The recommended funding for this project is as follows:

Funding Source	Amount
Grants (State of IL)	\$950,000
TIF Funding (cash on hand)	\$1,248,247
Bond (borrowing)	\$4,800,000
Total	\$6,998,247

This is the final approval necessary to proceed with the project and once approved, construction will begin.

#### **Attachments:**

Resolution

**Contract Amendment with Exhibits** 

#### RESOLUTION NUMBER \_\_\_-24

# A RESOLUTION APPROVING THE FINAL DESIGN AND THE DESIGN-BUILD AMENDMENT TO THE CONTRACT PREVIOUSLY EXECUTED BETWEEN JAMES MCHUGH CONSTRUCTION CO. AND THE VILLAGE OF EAST DUNDEE FOR DESIGN-BUILD SERVICES OF A TWO-LEVEL PARKING STRUCTURE LOCATED IN THE DOWNTOWN DISTRICT OF THE VILLAGE OF EAST DUNDEE

- **WHEREAS**, the Village of East Dundee ("Village") is a home rule unit of local government pursuant to Section 6 of Article VII of the Constitution of the State of Illinois, and has the authority to exercise any power and perform any function pertaining to its government and affairs; and
- **WHEREAS,** in June of 2023, subject to the direction of the Village Board of Trustees, a Request for Proposals ("*RFP*") was released and published in the <u>Daily Herald</u> on June 21, 2023 requesting proposals for a design-build contract for a two-level parking garage to be located in the Village's downtown district ("**Services**"); and
- **WHEREAS**, three proposals were received following the RFP and scored according to evaluation criteria and percentages noted in the RFP; and
- **WHEREAS,** on October 2, 2023, Village staff presented the responses to the RFP to the Village Board of Trustees; and
- **WHEREAS**, direction was given to Village staff by the Village Board of Trustees to negotiate a contract with James McHugh Construction Co. ("Design-Builder"); and
  - WHEREAS, the Design-Builder was the lowest, responsible bidder to the RFP; and
- **WHEREAS**, pursuant to the RFP, the Village and Design-Builder negotiated a contract for design-build services of a two-story parking structure ("*Parking Garage*") located in the downtown district of the Village (hereinafter "*Contract*"); and
- **WHEREAS**, the Village President and Board of Trustees previously approved the Contract pursuant to Resolution 03-24; and
- WHEREAS, the Village Board now wishes to approve final design elements for the Parking Garage ("Final Design") as set forth in Exhibit A to this Resolution and approve the final amendment to the Contract ("Contract Amendment") which outlines the final costs and build schedule for the construction of the Parking Garage as set forth in Exhibit B; and
- **WHEREAS**, the Contract Amendment sets forth a total cost of construction at \$6,998,247; and
- **WHEREAS**, the Village has previously approved the issuance of general obligation bonds in the amount of \$4,800,000 to finance the costs of the Parking Garage pursuant to Ordinance 24-19; and
- **WHEREAS**, the remainder of the funding for the project will come from grants from the State of Illinois and cash on hand from Tax Increment Financing (TIF) funds.

**WHEREAS**, due to parking congestion in the Village's Downtown District, and in an effort to create accessible parking in order for visitors to frequent downtown businesses, the Village President and Board of Trustees finds that it is in the best interests of the Village to approve the Final Design and Contract Amendment; and

**NOW, THEREFORE, BE IT RESOLVED** by the Village President and Board of Trustees of the Village of East Dundee, Cook and Kane Counties, Illinois, as follows:

<u>Section One.</u> <u>Recitals.</u> The foregoing recitals are hereby incorporated into, and made a part of, this Resolution as the findings of the President and Board of Trustees of the Village of East Dundee.

<u>Section Two</u>. <u>Approval of the Final Design of the Parking Garage</u>. The Village Board of Trustees hereby approves the Final Design of the Parking Garage as set forth in <u>Exhibit A</u>.

<u>Section Three.</u> <u>Approval of Contract Amendment.</u> The Village Board of Trustees hereby approves the Contract Amendment, attached hereto as <u>Exhibit B</u>, and in a final form and substance, including any modifications, to be approved by the Village Administrator and Village Attorney.

<u>Section Four</u>. <u>Authorization</u>. The Village Administrator and Village Clerk are authorized and directed to execute the Contract on behalf of the Village.

<u>Section Five. Effective Date</u>. This Resolution shall be in full force and effect from and after its passage by a vote the Village Board of Trustees and approval in the manner required by law.

[SIGNATURE PAGE TO FOLLOW]

PASSED this _	day of	2024 pursuant	to a roll call vote as follows
AYES:			
,	APPROVED by me t	thisof	2024.
		Jeffrey Lynam, Village Pı	resident
ATTEST:			
Katherine Diehl	, Village Clerk		

#### **EXHIBIT A**

#### **FINAL DESIGN**

## EXHIBIT B

### **CONTACT AMENDMENT**

## DRAFT AIA Document A141 - 2014

#### Exhibit A

#### Design-Build Amendment

This Amendment is incorporated into the accompanying AIA Document A141<sup>TM</sup>–2014, Standard Form of Agreement Between Owner and Design-Builder dated the 22 day of January in the year 2024 (the "Agreement")

(In words, indicate day, month and year.)

#### for the following PROJECT:

(Name and location or address)

Downtown East Dundee Parking Structure

#### THE OWNER:

(Name, legal status and address)

Village of East Dundee 120 Barrington Ave. East Dundee, IL 60188 Attn: Joseph Heinz

#### THE DESIGN-BUILDER:

(Name, legal status and address)

James McHugh Construction Co. 1737 S. Michigan Ave. Chicago IL 60616 Attn. Andrew Totten

The Owner and Design-Builder hereby amend the Agreement as follows.

#### TABLE OF ARTICLES

- A.1 CONTRACT SUM
- A.2 CONTRACT TIME
- A.3 INFORMATION UPON WHICH AMENDMENT IS BASED
- A.4 DESIGN-BUILDER'S PERSONNEL, CONTRACTORS AND SUPPLIERS
- A.5 COST OF THE WORK

#### ARTICLE A.1 CONTRACT SUM

§ A.1.1 The Owner shall pay the Design-Builder the Contract Sum in current funds for the Design-Builder's performance of the Contract after the execution of this Amendment. The Contract Sum shall be one of the following and shall not include compensation the Owner paid the Design-Builder for Work performed prior to execution of this Amendment:

(Check the appropriate box.)

[X] Stipulated Sum, in accordance with Section A.1.2 below

#### ADDITIONS AND DELETIONS:

The author of this document has added information needed for its completion. The author may also have revised the text of the original AIA standard form. An Additions and Deletions Report that notes added information as well as revisions to the standard form text is available from the author and should be reviewed.

This document has important legal consequences. Consultation with an attorney is encouraged with respect to its completion or modification.

Consultation with an attorney is also encouraged with respect to professional licensing requirements in the jurisdiction where the Project is located.



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[ « » ] Cost of the Work plus the Design-Bi	uilder's Fee, in accordance w	71th Section A.1.3 below
[ « » ] Cost of the Work plus the Design-Br with Section A.1.4 below	uilder's Fee with a Guarantee	ed Maximum Price, in accordance
(Based on the selection above, complete Section A.1.2,	, A.1.3 or A.1.4 below.)	
§ A.1.2 Stipulated Sum § A.1.2.1 The Stipulated Sum shall be six million nine dollars and zero cents (\$6,998,247.00), subject to auth Documents.		
§ A.1.2.2 The Stipulated Sum is based upon the follow Documents and are hereby accepted by the Owner: (State the numbers or other identification of accepted subsequent to the execution of this Amendment, attach Stipulated Sum for each and the deadline by which the	alternates. If the Owner is pe a schedule of such other alte	ermitted to accept other alternates ernates showing the change in
See attached Exhibit C dated July 3, 2024 and Exhibit	I dated July 8, 2024.	
§ A.1.2.3 Unit prices, if any: (Identify item, state the unit price, and state any applic	cable quantity limitations.)	
Item N/A	Units and Limitations	Price per Unit (\$0.00)
§ A.1.3 Cost of the Work Plus Design-Builder's Fee § A.1.3.1 The Cost of the Work is as defined in Article		
§ A.1.3.2 The Design-Builder's Fee: (State a lump sum, percentage of Cost of the Work or a the method for adjustment to the Fee for changes in the		ing the Design-Builder's Fee, and
N/A		
§ A.1.4 Cost of the Work Plus Design-Builder's Fee § A.1.4.1 The Cost of the Work is as defined in Article		ım Price
§ A.1.4.2 The Design-Builder's Fee: (State a lump sum, percentage of Cost of the Work or a the method for adjustment to the Fee for changes in the		ing the Design-Builder's Fee and
N/A		
& A 1 4 2 Guaranteed Maximum Price		
§ A.1.4.3 Guaranteed Maximum Price § A.1.4.3.1 The sum of the Cost of the Work and the De exceed N/A (\$N/A), subject to additions and deductions. Documents. Costs that would cause the Guaranteed Max Builder without reimbursement by the Owner. (Insert specific provisions if the Design-Builder is to p	s for changes in the Work as p ximum Price to be exceeded s	provided in the Design-Build

#### § A.1.4.3.2 Itemized Statement of the Guaranteed Maximum Price

Provided below is an itemized statement of the Guaranteed Maximum Price organized by trade categories, allowances, contingencies, alternates, the Design-Builder's Fee, and other items that comprise the Guaranteed Maximum Price.

T A	/ A
	/ /
11 7	

**§ A.1.4.3.3** The Guaranteed Maximum Price is based on the following alternates, if any, which are described in the Design-Build Documents and are hereby accepted by the Owner:

(State the numbers or other identification of accepted alternates. If the Owner is permitted to accept other alternates subsequent to the execution of this Amendment, attach a schedule of such other alternates showing the change in the Cost of the Work and Guaranteed Maximum Price for each and the deadline by which the alternate must be accepted.)

N/A

#### **§ A.1.4.3.4** Unit Prices, if any:

(Identify item, state the unit price, and state any applicable quantity limitations.)

Item Units and Limitations Price per Unit (\$0.00)

§ A.1.4.3.5 Assumptions, if any, on which the Guaranteed Maximum Price is based:

N/A

#### § A.1.5 Payments

#### § A.1.5.1 Progress Payments

§ A.1.5.1.1 Based upon Applications for Payment submitted to the Owner by the Design-Builder, the Owner shall make progress payments on account of the Contract Sum to the Design-Builder as provided below and elsewhere in the Design-Build Documents.

§ A.1.5.1.2 The period covered by each Application for Payment shall be one calendar month ending on the last day of the month, or as follows:

**«** »

§ A.1.5.1.3 Payment shall be made by the Owner in accordance with the Illinois Local Government Prompt Payment Act (50 ILCS 505).

§ A.1.5.1.4 Intentionally omitted.

§ A.1.5.1.5 With each Application for Payment where the Contract Sum is based upon a Stipulated Sum or Cost of the Work with a Guaranteed Maximum Price, the Design-Builder shall submit the most recent schedule of values in accordance with the Design-Build Documents. The schedule of values shall allocate the entire Contract Sum among the various portions of the Work. Compensation for design services, if any, shall be shown separately. Where the Contract Sum is based on the Cost of the Work with a Guaranteed Maximum Price, the Design-Builder's Fee shall be shown separately. The schedule of values shall be prepared in such form and supported by such data to substantiate its accuracy as the Owner may require. This schedule of values, unless objected to by the Owner, shall be used as a basis for reviewing the Design-Builder's Applications for Payment.

§ A.1.5.1.6 In taking action on the Design-Builder's Applications for Payment, the Owner shall be entitled to rely on the accuracy and completeness of the information furnished by the Design-Builder and shall not be deemed to have made a detailed examination, audit or arithmetic verification of the documentation submitted in accordance with Sections A.1.5.1.4 or A.1.5.1.5, or other supporting data; to have made exhaustive or continuous on-site inspections; or to have made examinations to ascertain how or for what purposes the Design-Builder has used amounts previously paid. Such examinations, audits and verifications, if required by the Owner, will be performed by the Owner's auditors acting in the sole interest of the Owner.

**§ A.1.5.1.7** Except with the Owner's prior approval, the Design-Builder shall not make advance payments to suppliers for materials or equipment which have not been delivered and stored at the site.

#### § A.1.5.2 Progress Payments—Stipulated Sum

§ A.1.5.2.1 Applications for Payment where the Contract Sum is based upon a Stipulated Sum shall indicate the percentage of completion of each portion of the Work as of the end of the period covered by the Application for Payment.

§ A.1.5.2.2 Subject to other provisions of the Design-Build Documents, the amount of each progress payment shall be computed as follows:

- .1 Take that portion of the Contract Sum properly allocable to completed Work as determined by multiplying the percentage completion of each portion of the Work by the share of the Contract Sum allocated to that portion of the Work in the schedule of values, less retainage of five percent (5 %) on the Work. Pending final determination of cost to the Owner of Changes in the Work, amounts not in dispute shall be included as provided in Section 6.3.9 of the Agreement;
- Add that portion of the Contract Sum properly allocable to materials and equipment delivered and suitably stored at the site for subsequent incorporation in the completed construction (or, if approved in advance by the Owner, suitably stored off the site at a location agreed upon in writing), less retainage of five percent (5%);
- .3 Subtract the aggregate of previous payments made by the Owner; and
- **.4** Subtract amounts, if any, the Owner has withheld or nullified, as provided in Section 9.5 of the Agreement.

§ A.1.5.2.3 The progress payment amount determined in accordance with Section A.1.5.2.2 shall be further modified under the following circumstances:

- Add, upon Substantial Completion of the Work, a sum sufficient to increase the total payments to the full amount of the Contract Sum, less such amounts as the Owner shall determine for incomplete Work, retainage applicable to such work and unsettled claims; and (Section 9.8.6 of the Agreement discusses release of applicable retainage upon Substantial Completion of Work.)
- Add, if final completion of the Work is thereafter materially delayed through no fault of the Design-Builder, any additional amounts payable in accordance with Section 9.10.3 of the Agreement.

#### § A.1.5.2.4 Reduction or limitation of retainage, if any, shall be as follows:

(If it is intended, prior to Substantial Completion of the entire Work, to reduce or limit the retainage resulting from the percentages inserted in Sections A.1.5.2.2.1 and A.1.5.2.2.2 above, and this is not explained elsewhere in the Design-Build Documents, insert provisions here for such reduction or limitation.)

For amounts owed by Design-Builder to third-parties, such as subcontractors or suppliers, for the first 50% of the that third-party's work on the Project, the retention shall be ten percent (10%). Upon completion of the first 50% of that third-party's work, their retention shall be reduced to five percent (5%). Retention shall be calculated and held on a trade-by-trade basis on the approved Schedule of Values and not on an aggregate basis for the Project absent issues or problems with the Work. Upon Substantial Completion of the Work, any retention shall be reduced to 200% of the value of amount of work outstanding Work listed on the punch list.

## § A.1.5.3 Progress Payments—Cost of the Work Plus a Fee Intentionally omitted.

§ A.1.5.4 Progress Payments—Cost of the Work Plus a Fee with a Guaranteed Maximum Price Intentionally omitted.

#### § A.1.5.5 Final Payment

§ A.1.5.5.1 Final payment, constituting the entire unpaid balance of the Contract Sum, shall be made by the Owner to the Design-Builder not later than 30 days after the Design-Builder has fully performed the Contract and the requirements of Section 9.10 of the Agreement have been satisfied, except for the Design-Builder's responsibility to correct non-conforming Work discovered after final payment or to satisfy other requirements, if any, which extend beyond final payment.

§ A.1.5.5.2 If the Contract Sum is based on the Cost of the Work, the Owner's auditors will review and report in writing on the Design-Builder's final accounting within 30 days after the Design-Builder delivers the final

accounting to the Owner. Based upon the Cost of the Work the Owner's auditors report to be substantiated by the Design-Builder's final accounting, and provided the other conditions of Section 9.10 of the Agreement have been met, the Owner will, within seven days after receipt of the written report of the Owner's auditors, either issue a final Certificate for Payment, or notify the Design-Builder in writing of the reasons for withholding a certificate as provided in Section 9.5.1 of the Agreement.

#### ARTICLE A.2 CONTRACT TIME

§ A.2.1 Contract Time, as defined in the Agreement at Section 1.4.13, is the period of time, including authorized adjustments, for Substantial Completion of the Work.

§ A.2.2 The Design-Builder shall achieve Substantial Completion of the Work not later than May 27, 2025. (Insert number of calendar days. Alternatively, a calendar date may be used when coordinated with the date of commencement. If appropriate, insert requirements for earlier Substantial Completion of certain portions of the

See attached Exhibit D dated July 2, 2024

See attached Exhibit D dated sary	2, 2024.		
Portion of Work N/A		Substantial Completio N/A	n Date
, subject to adjustments of the Con (Insert provisions, if any, for liquid bonus payments for early completi	dated damages relatii	e e	ocuments.  ubstantial Completion on time or for
N/A			4
§ A.3.1 The Contract Sum and Cor § A.3.1.1 The Supplementary and o	other Conditions of th	n this Amendment are ba	
Document N/A	Title	Date	Pages
§ A.3.1.2 The Specifications: (Either list the specifications here) See attached Exhibit F dated July 2 Section	V	attached to this Amendm	ent.)
§ A.3.1.3 The Drawings: (Either list the drawings here or researched Exhibit G dated July)		ched to this Amendment.)	
Number		Title	Date
§ A.3.1.4 The Sustainability Plan, i	f anv:		

(If the Owner identified a Sustainable Objective in the Owner's Criteria, identify the document or documents that comprise the Sustainability Plan by title, date and number of pages, and include other identifying information. The Sustainability Plan identifies and describes the Sustainable Objective; the targeted Sustainable Measures; implementation strategies selected to achieve the Sustainable Measures; the Owner's and Design-Builder's roles and responsibilities associated with achieving the Sustainable Measures; the specific details about design reviews, testing or metrics to verify achievement of each Sustainable Measure; and the Sustainability Documentation required for the Project, as those terms are defined in Exhibit C to the Agreement.)

Title	Date	Pages
N/A		

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N/A § A.3.1.5 Allowances and Contingencies: (Identify any agreed upon allowances and contingencies, including a statement of their basis.) Allowances See attached Exhibit H dated July 3, 2024. Contingencies See attached Exhibit H dated July 3, 2024. § A.3.1.6 Design-Builder's assumptions and clarifications: See attached Exhibit E dated July 8, 2024. § A.3.1.7 Deviations from the Owner's Criteria as adjusted by a Modification: N/A § A.3.1.8 To the extent the Design-Builder shall be required to submit any additional Submittals to the Owner for review, indicate any such submissions below: See attached Exhibit J dated July 8, 2024. ARTICLE A.4 DESIGN-BUILDER'S PERSONNEL, CONTRACTORS AND SUPPLIERS § A.4.1 The Design-Builder's key personnel are identified below: (Identify name, title and contact information.) .1 Superintendent Tom Kruszewski .2 Project Manager Jason Balamut Others Project Executive: David Steffenhagen § A.4.2 The Design-Builder shall retain the following Consultants, Contractors and suppliers, identified below: (List name, discipline, address and other information.)

#### ARTICLE A.5 COST OF THE WORK

§ A.5.1 Cost To Be Reimbursed as Part of the Contract

Desman Design Management, 20 North Clark Street, #400, Chicago Illinois 60602

§ A.5.1.1 Labor Costs

**§ A.5.1.1.1** Wages of construction workers directly employed by the Design-Builder to perform the construction of the Work at the site as set forth in the attached Exhibit C dated July 3, 2024.

§ A.5.1.1.2 With the Owner's prior approval, wages or salaries of the Design-Builder's supervisory and administrative personnel when stationed at the site.

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(If it is intended that the wages or salaries of certain personnel stationed at the Design-Builder's principal or other offices shall be included in the Cost of the Work, identify below the personnel to be included, whether for all or only part of their time, and the rates at which their time will be charged to the Work.)

Person Included Status (full-time/part-time) Rate (\$0.00) Rate (unit of time) § A.5.1.1.3 Wages and salaries of the Design-Builder's supervisory or administrative personnel engaged at factories, workshops or on the road, in expediting the production or transportation of materials or equipment required for the Work, but only for that portion of their time required for the Work. § A.5.1.1.4 Costs paid or incurred by the Design-Builder for taxes, insurance, contributions, assessments and benefits required by law or collective bargaining agreements and, for personnel not covered by such agreements, customary benefits such as sick leave, medical and health benefits, holidays, vacations and pensions, provided such costs are based on wages and salaries included in the Cost of the Work under Section A.5.1.1. § A.5.1.1.5 Bonuses, profit sharing, incentive compensation and any other discretionary payments paid to anyone hired by the Design-Builder or paid to the Architect or any Consultant, Contractor or supplier, with the Owner's prior approval. § A.5.1.2 Contract Costs. Payments made by the Design-Builder to the Architect, Consultants, Contractors and suppliers in accordance with the requirements of their subcontracts. § A.5.1.3 Costs of Materials and Equipment Incorporated in the Completed Construction § A.5.1.3.1 Costs, including transportation and storage, of materials and equipment incorporated or to be incorporated in the completed construction. § A.5.1.3.2 Costs of materials described in the preceding Section A.5.1.3.1 in excess of those actually installed to allow for reasonable waste and spoilage. Unused excess materials, if any, shall become the Owner's property at the completion of the Work or, at the Owner's option, shall be sold by the Design-Builder. Any amounts realized from such sales shall be credited to the Owner as a deduction from the Cost of the Work. § A.5.1.4 Costs of Other Materials and Equipment, Temporary Facilities and Related Items § A.5.1.4.1 Costs of transportation, storage, installation, maintenance, dismantling and removal of materials, supplies, temporary facilities, machinery, equipment and hand tools not customarily owned by construction workers that are provided by the Design-Builder at the site and fully consumed in the performance of the Work. Costs of materials, supplies, temporary facilities, machinery, equipment and tools that are not fully consumed shall be based on the cost or value of the item at the time it is first used on the Project site less the value of the item when it is no longer used at the Project site. Costs for items not fully consumed by the Design-Builder shall mean fair market value. § A.5.1.4.2 Rental charges for temporary facilities, machinery, equipment and hand tools not customarily owned by construction workers that are provided by the Design-Builder at the site and costs of transportation, installation, minor repairs, dismantling and removal. The total rental cost of any Design-Builder-owned item may not exceed the purchase price of any comparable item. Rates of Design-Builder-owned equipment and quantities of equipment shall be subject to the Owner's prior approval.

§ A.5.1.4.4 Costs of document reproductions, electronic communications, postage and parcel delivery charges, dedicated data and communications services, teleconferences, Project websites, extranets and reasonable petty cash expenses of the site office.

§ A.5.1.4.3 Costs of removal of debris from the site of the Work and its proper and legal disposal.

**§ A.5.1.4.5** Costs of materials and equipment suitably stored off the site at a mutually acceptable location, with the Owner's prior approval.

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#### § A.5.1.5 Miscellaneous Costs

- § A.5.1.5.1 Premiums for that portion of insurance and bonds required by the Design-Build Documents that can be directly attributed to the Contract. With the Owner's prior approval self-insurance for either full or partial amounts of the coverages required by the Design-Build Documents.
- § A.5.1.5.2 Sales, use or similar taxes imposed by a governmental authority that are related to the Work and for which the Design-Builder is liable. Sales tax on materials is not currently included in price (see Exhibit E).
- § A.5.1.5.3 Fees and assessments for the building permit and for other permits, licenses and inspections for which the Design-Builder is required by the Design-Build Documents to pay.
- § A.5.1.5.4 Fees of laboratories for tests required by the Design-Build Documents, except those related to defective or nonconforming Work for which reimbursement is excluded by Section 15.5.3 of the Agreement or by other provisions of the Design-Build Documents, and which do not fall within the scope of Section A.5.1.6.3.
- § A.5.1.5.5 Royalties and license fees paid for the use of a particular design, process or product required by the Design-Build Documents; the cost of defending suits or claims for infringement of patent rights arising from such requirement of the Design-Build Documents; and payments made in accordance with legal judgments against the Design-Builder resulting from such suits or claims and payments of settlements made with the Owner's consent. However, such costs of legal defenses, judgments and settlements shall not be included in the calculation of the Design-Builder's Fee or subject to the Guaranteed Maximum Price. If such royalties, fees and costs are excluded by the second to last sentence of Section 3.1.13.2 of the Agreement or other provisions of the Design-Build Documents, then they shall not be included in the Cost of the Work.
- § A.5.1.5.6 With the Owner's prior approval, costs for electronic equipment and software directly related to the Work.
- § A.5.1.5.7 Deposits lost for causes other than the Design-Builder's negligence or failure to fulfill a specific responsibility in the Design-Build Documents.
- § A.5.1.5.8 With the Owner's prior approval, which shall not be unreasonably withheld, legal, mediation and arbitration costs, including attorneys' fees, other than those arising from disputes between the Owner and Design-Builder, reasonably incurred by the Design-Builder after the execution of the Agreement and in the performance of the Work.
- § A.5.1.5.9 Intentionally omitted.
- § A.5.1.5.10. Intentionally omitted.

#### § A.5.1.6 Other Costs and Emergencies

- § A.5.1.6.1 Other costs incurred in the performance of the Work if, and to the extent, approved in advance in writing by the Owner.
- § A.5.1.6.2 Costs incurred in taking action to prevent threatened damage, injury or loss in case of an emergency affecting the safety of persons and property.
- § A.5.1.6.3 Costs of repairing or correcting damaged or nonconforming Work executed by the Design-Builder, Contractors or suppliers, provided that such damaged or nonconforming Work was not caused by negligence or failure to fulfill a specific responsibility of the Design-Builder and only to the extent that the cost of repair or correction is not recovered by the Design-Builder from insurance, sureties, Contractors, suppliers, or others.

#### § A.5.1.7 Related Party Transactions

§ A.5.1.7.1 For purposes of Section A.5.1.7, the term "related party" shall mean a parent, subsidiary, affiliate or other entity having common ownership or management with the Design-Builder; any entity in which any stockholder in, or management employee of, the Design-Builder owns any interest in excess of ten percent in the aggregate; or any person or entity which has the right to control the business or affairs of the Design-Builder. The term "related party" includes any member of the immediate family of any person identified above.

Notes: (1348035666)

§ A.5.1.7.2 If any of the costs to be reimbursed arise from a transaction between the Design-Builder and a related party, the Design-Builder shall notify the Owner of the specific nature of the contemplated transaction, including the identity of the related party and the anticipated cost to be incurred, before any such transaction is consummated or cost incurred. If the Owner, after such notification, authorizes the proposed transaction, then the cost incurred shall be included as a cost to be reimbursed, and the Design-Builder shall procure the Work, equipment, goods or service from the related party, as a Contractor, according to the terms of Section A.5.4. If the Owner fails to authorize the transaction, the Design-Builder shall procure the Work, equipment, goods or service from some person or entity other than a related party according to the terms of Section A.5.4.

#### § A.5.2 Costs Not to Be Reimbursed as Part of this Contract

The Cost of the Work shall not include the items listed below:

- 1 Salaries and other compensation of the Design-Builder's personnel stationed at the Design-Builder's principal office or offices other than the site office, except as specifically provided in Section A.5.1.1;
- .2 Expenses of the Design-Builder's principal office and offices other than the site office;
- .3 Overhead and general expenses, except as may be expressly included in Section A.5.1;
- .4 The Design-Builder's capital expenses, including interest on the Design-Builder's capital employed for the Work:
- .5 Except as provided in Section A.5.1.6.3 of this Agreement, costs due to the negligence or failure of the Design-Builder, Contractors and suppliers or anyone directly or indirectly employed by any of them or for whose acts any of them may be liable to fulfill a specific responsibility of the Contract;
- .6 Any cost not specifically and expressly described in Section A.5.1; and
- .7 Costs, other than costs included in Change Orders approved by the Owner, that would cause the Guaranteed Maximum Price to be exceeded.

#### § A.5.3 Discounts, Rebates, and Refunds

§ A.5.3.1 Cash discounts obtained on payments made by the Design-Builder shall accrue to the Owner if (1) before making the payment, the Design-Builder included them in an Application for Payment and received payment from the Owner, or (2) the Owner has deposited funds with the Design-Builder with which to make payments; otherwise, cash discounts shall accrue to the Design-Builder. Trade discounts, rebates, refunds and amounts received from sales of surplus materials and equipment shall accrue to the Owner, and the Design-Builder shall make provisions so that they can be obtained.

**§ A.5.3.2** Amounts that accrue to the Owner in accordance with Section A.5.3.1 shall be credited to the Owner as a deduction from the Cost of the Work.

#### § A.5.4 Other Agreements

§ A.5.4.1 When the Design-Builder has provided a Guaranteed Maximum Price, and a specific bidder (1) is recommended to the Owner by the Design-Builder; (2) is qualified to perform that portion of the Work; and (3) has submitted a bid that conforms to the requirements of the Design-Build Documents without reservations or exceptions, but the Owner requires that another bid be accepted, then the Design-Builder may require that a Change Order be issued to adjust the Guaranteed Maximum Price by the difference between the bid of the person or entity recommended to the Owner by the Design-Builder and the amount of the subcontract or other agreement actually signed with the person or entity designated by the Owner.

§ A.5.4.2 Agreements between the Design-Builder and Contractors shall conform to the applicable payment provisions of the Design-Build Documents, and shall not be awarded on the basis of cost plus a fee without the prior consent of the Owner. If an agreement between the Design Builder and a Contractor is awarded on a cost plus a fee basis, the Design-Builder shall provide in the agreement for the Owner to receive the same audit rights with regard to the Cost of the Work performed by the Contractor as the Owner receives with regard to the Design-Builder in Section A.5.5, below.

§ A.5.4.3 The agreements between the Design-Builder and Architect and other Consultants identified in the Agreement shall be in writing. These agreements shall be promptly provided to the Owner upon the Owner's written request.

#### § A.5.5 Accounting Records

The Design-Builder shall keep full and detailed records and accounts related to the cost of the Work and exercise such controls as may be necessary for proper financial management under the Contract and to substantiate all costs

incurred. The accounting and control systems shall be satisfactory to the Owner. The Owner and the Owner's auditors shall, during regular business hours and upon reasonable notice, be afforded access to, and shall be permitted to audit and copy, the Design-Builder's records and accounts, including complete documentation supporting accounting entries, books, correspondence, instructions, drawings, receipts, subcontracts, Contractor's proposals, purchase orders, vouchers, memoranda and other data relating to the Contract. The Design-Builder shall preserve these records for a period of three years after final payment, or for such longer period as may be required by law.

# § A.5.6 Relationship of the Parties The Design-Builder accepts the relationship of trust and confidence established by this Agreement and covenants with the Owner to exercise the Design-Builder's skill and judgment in furthering the interests of the Owner; to furnish efficient construction administration, management services and supervision; to furnish at all times an adequate supply of workers and materials; and to perform the Work in an expeditious and economical manner consistent with the Owner's interests. This Amendment to the Agreement entered into as of the day and year first written above. **DESIGN-BUILDER** (Signature) **OWNER** (Signature) Andrew Totten, Vice President « »« » (Printed name and title) (Printed name and title)

(1348035666)

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#### **Exhibit B – Bond and Insurance Requirements**

#### **Bonds**

Unless otherwise agreed to by the parties, the Design-Build Team shall secure with a responsible corporate surety or corporate sureties, satisfactory bonds conditioned upon faithful performance by the Design-Build Team of all requirements under the contract and upon the payment of claims of material, men, and laborers thereunder. The Performance Bond shall be in the sum of not less than one hundred and fifteen percent (115%) of the estimated aggregate amount of the payments to be made under the contract computed on the basis of the prices stated in the proposal. The Performance Bond shall convert to a Maintenance Bond in in the amount of twenty-five percent (25%) of the amount of the contract price plus all change orders and shall cover warranty of the work and materials for a period of two years after the recordation of the Notice of Completion. At the time of submitting the Performance Bond the surety shall submit to the Village of East Dundee the following:

- (a) The original bond; and
- (b) The original, or certified copy of the unrevoked appointment, power of attorney, bylaws, or other instrument entitling or authorizing the person who executed the bond.

All bonds must be issued by a surety company with an A.M. Best's rating of A-VII or better, be on the Treasure Department of approved sureties and be licensed to conduct surety business in the State of Illinois.

#### **Insurance**

All insurance issued in compliance with this section shall be issued in the form, and by an insurer or insurers, satisfactory to and first approved by the Village of East Dundee in writing. Certificates of insurance in the amounts required shall be furnished by the Design-Build Team to the Village of East Dundee prior to the commencement of work.

The Design-Build Team shall maintain adequate workers' compensation insurance including \$1,000,000 Employer's Liability insurance under the laws of the State of Illinois for all labor employed by Design-Build Team or by any Subcontractor under Design-Build Team who may come within the protection of such workers' compensation insurance laws.

The Design-Build Team shall maintain during the life of this Contract general liability insurance on an occurrence basis on a ISO GL 00 01 04/13 or equivalent form including bodily injury, property damage, personal injury & advertising, primary and non-contributory and products & completed operations coverage in which the Village of East Dundee shall be named as an additional insured.

Products & Completed Operations coverage should be maintained for a minimum of five (5)

years or the statute of repose in the state of Illinois after completion of the contract.

The Design-Build Team shall maintain an Automobile Liability policy with a \$5,000,000 combined single limit per accident for bodily injury and property damage including hired and non-owned liability. The Village of East Dundee should be named as an additional insured.

The Design-Build Team shall maintain a Professional Liability E&O policy with a \$10,000,000 limit for the length of the contract and a minimum of five (5) years after completion of the project. The retroactive date of the policy must be on or before the effective date of the contract.

The Village of East Dundee and its elected or appointed officials, directors, officers, agents, employees, professional consultants, or volunteers shall be named as "Additional Insureds" under general, automobile and umbrella liability policies.

All insurance policies must be underwritten by a company with an AM. Best's rating of A-VII or better and be licensed to conduct insurance business in the state of Illinois.

The insurance requirements are further outlined below:

Workers' C	ompensation
Coverage Workers' Compensation Employer's Liability	Minimum Limits Statutory coverage per the State of Illinois \$1,000,000
General	Liability
Coverage General Liability (Including Bodily Injury, Property Damage and Personal & Advertising Injury) Products-Completed Operations Liability  Occurrence ISO GL 00 01 04 13 or its equivalent including Products & Completed operations	Minimum Limits \$25,000,000 per occurrence/aggregate \$25,000,000 per occurrence/aggregate
Automobile Lia	ability Insurance
Coverage Automobile Liability (Including owned, non-owned and hired automobiles, trucks and trailers)	Limits \$5,000,000 minimum single limit
Professional Li	ability Insurance
Coverage Professional Liability	<b>Limits</b> \$10,000,000

# Coverage may be written with a primary General Liability and Automobile Liability policy and additional limits via an Umbrella policy.

#### **General Requirements**

**Additional Insured** - Village of East Dundee (VOED), its elected or appointed officials, directors, officers, agents, employees, professional consultants, volunteers or contractors shall be named as an additional insured under the General Liability, Automobile Liability, and Umbrella policies.

**Proof of Coverage** - Design-Build Team shall provide VOED with a certificate of insurance annually including additional insured endorsements as required.

**Financial Strength** - Such insurance and surety bonds shall be placed with one or more companies with an AM Best rating of A- or better, and financial size rating of VII or better.

**Waiver of Subrogation** - Policies should include a Waiver of Subrogation in favor of VOED.

Cancellation Requirements - All policies shall contain a provision that the coverage may not be cancelled or materially changed without first giving VOED not less than thirty (30) days prior written notice.

The Design-Build Team shall require all subcontractors retained by the Design-Build Team to provide the appropriate insurance coverages to cover claims which may arise out of the work they are performing for the Design-Build Team and shall further require those subcontractor to name the Village of East Dundee and its elected or appointed officials, directors, officers, agents, employees, professional consultants, or volunteers as "Additional Insureds" under general, automobile and umbrella liability policies.

### **Exhibit C - Contract Amount**



East Dundee Parking Structure		
Design-Build Proposal - JULY 03, 2024	S	UMMARY
DIVISION 01 - GENERAL REQUIREMENTS	\$	102,673
DIVISION 02 - EXISTING CONDITIONS	\$	55,000
DIVISION 03 - CONCRETE	\$	2,489,400
DIVISION 04 - MASONRY	\$	464,700
DIVISION 05 - METALS	\$	157,100
DIVISION 06 - WOOD, PLASTICS AND COMPOSITES	\$	41,176
DIVISION 07 - THERMAL AND MOISTURE PROTECTION	\$	477,600
DIVISION 08 - OPENINGS	\$	157,122
DIVISION 09 - FINISHES	\$	112,902
DIVISION 10 - SPECIALTIES	\$	-
DIVISION 11 - EQUIPMENT	\$	-
DIVISION 12 - FURNISHINGS	\$	8,040
DIVISION 13 - SPECIAL CONSTRUCTION	\$	
DIVISION 14 - CONVEYING EQUIPMENT	\$	99,000
DIVISION 21 - FIRE SUPPRESSION	\$	104,800
DIVISION 22 - PLUMBING	\$	120,930
DIVISION 23 - HEATING, VENITLATING, AND AIR CONDITIONING (HVAC)	\$	22,000
DIVISION 26 - ELECTRICAL	\$	256,050
DIVISION 27 - COMMUNICATIONS	\$	-
DIVISION 28 - ELECTRONIC SAFETY AND SECURITY	\$	79,716
DIVISION 31 - EARTHWORK	\$	485,000
DIVISION 32 - EXTERIOR IMPROVEMENTS	\$	125,292
DIVISION 33 - UTILITIES	\$	200,000
DESIGN FEES	\$	215,000
BUILDING PERMITS / THIRD PARTY INSPECTION FEES	\$	45,000
COMED SERVICE ENGINEERING AND INSTALLATION	\$	96,993
GENERAL CONDITIONS	\$	249,271
INSURANCE AND COST OF RISK	\$	88,369
PERFORMANCE AND PAYMENT BOND	\$	50,159
WARRANTY BOND	\$	2,031
SUBCONTRACTOR DEFAULT INSURANCE (SDI)	\$	37,481
CONTRACTOR CONTINGENCY	\$	167,335
FEE	\$	488,108
		•
TOTAL	\$	6,998,247

ALLOWANCE INCLUDED IN PROPOSAL TOTAL ABOVE	
Concealed conditions allowance for removal of unforeseen obstructions on	
site.	\$ 20,000
Dewatering - allowance	\$ 5,000
Caststone / metal panels, non-insulated cornice / coping @ northeast stairs	
and northwest stairs towers + west and partial south - supply & install	
allowance	\$ 124,000
Decorative overhang corbels @ northwest stairs towers + west - supply &	
install allowance	\$ 55,500
Interior & exterior signage allowance	\$ 10,000
ComEd underground relocation - allowance	\$ 96,993
TOTAL	\$ 311.493

ALTERNATE PRICING	
ADD Northside column brick veneer (5EA)	\$ 18,656
ADD for two electric vehicle charging stations (infrastructure for two	
charging stations included in base bid)	\$ 20,000

'ID	Activity Name		Original	Start	Finish	2	024		2025			2026			2027
			Duration			Q2		4 Q1	Q2 Q	3 Q4	Q1	Q2 Q3	3 Q4	Q1 C	Q2 Q3
East Dundee East	t Dundee Schedule Rev. 0		266	15-Apr-24 A	27-May-25	: :			27-1	May-25, I	ast Dur	ndee Eas	t Dundee	Schedule	Rev. 0
East Dundee.Pro	ject Southbank Building C - Proposal	Schedule Rev. 3 - 2024.02	266	15-Apr-24 A	27-May-25	-			27-1	May-25, I	East Dur	ndee Proje	ect South	bank Buil	ding C -
	ect.Contract Time Level of Effort Durations (Meas		228	15-Jun-24 A	27-May-25	1		1 1 1 1	27-1	Иау-25, Г	∷ : East Dur	ndee.Proje	ect Contra	ct Time L	_evel of
42342	Office Estimating (Preconstruction)		19	15-Jun-24 A	15-Jul-24		Office E	1 1 1 1		1 7 1 1					
42343	Mobilization (Preconstruction)		5	22-Jul-24	26-Jul-24	1 1	■ Mobiliz	ation (Pr	constructi	on)		1 1 1 1 1 1 1 1 1 1 1 1			1 1 1
00058	Construction Mobilization to Certificate of Ocup	ancy	156	16-Jul-24	28-Feb-25	1:::			Constructi		zation to	Certificat	te of Ocur	ancy	
42344	Closeout		20	29-Apr-25	27-May-25	1			Clos	seout					
42345	Substantial Completion		0		27-May-25				♦ Sub	stantial (	Completi	on			
East Dundee.Proje	ect.2 Preconstruction		6	16-Jul-24	23-Jul-24		<b>▼</b> 23-Jul-	24, East	Dundee.P	roject 2 l	Preconst	ruction			1 1 1
00055	Notice to Proceed for Site Prep		0	16-Jul-24*	16-Jul-24		I Notice	o Procee	d for Site	Prep					1 1 1
00008	Notice to Proceed for Early Release Procureme	ent	0	16-Jul-24*	16-Jul-24		I Notice	o Procee	d for Early	Release	Procure	ement	i - i - i - i		
00026	Fully Executed GMP Contract Agreement		0	16-Jul-24*	16-Jul-24		I Fully Ex	ecuted C	MP Contr	act Agree	ement				
00088	Notice to Proceed for Procurement		0	16-Jul-24	16-Jul-24		I Notice	o Procee	d for Proc	urement					
00046	Owner Insurance & Builder's Risk Insurance		5	16-Jul-24*	22-Jul-24	7	Owner	Insuranc	e & Builde	r's Risk Ir	nsurance				
00087	Building Permit Issued		0		23-Jul-24	1	◆ Buildin	g Permit	ssued						
East Dundee.Proje	ect.6 Weather Days		10	14-Feb-25	28-Feb-25				28-Feb-25	, East Dι	ındee.Pı	roject.6 V	Veather D	ays	
03216	Weather Days		10	14-Feb-25	28-Feb-25				Weather D	Days					
East Dundee.Proje	ect.3 Major Milestones		0	28-Feb-25	28-Feb-25				28-Feb-25	, East Dι	ındee.Pı	roject.3 M	/lajor Mile	stones	
03218	Project Completion: Garage and Retail		0		28-Feb-25			•	Project Co	mpletion	: Garage	e and Ret	ail		
East Dundee.Proje	ect.Major Milestones Construction Milestones		72	16-Jul-24	25-Oct-24		<b>V</b>	25-Oct-2	I, East Du	ndee Pro	ject.Maj	or Milesto	nes Con	struction N	<b>Vilestor</b>
00052	Construction Mobilization		5	16-Jul-24	22-Jul-24		Constr	uction Mo	bilization						
03222	Finish Foundations		0		12-Sep-24	7	<b>♦</b> Fin	ish Found	dations						
01836	Structure Top-Out		0		21-Oct-24	71 1	•	Structure	Top-Out						
03224	Weather tight Elevator Machine Roof/Shaft		0		25-Oct-24		•	Weather	tight Eleva	tor Mach	nine Roo	f/Shaft			
East Dundee.Proje	ect.13 Construction Key Dates		9	07-Nov-24	21-Nov-24		<b>T</b>	21-Nov	-24, East I	Dundee.l	Project.1	3 Constr	uction Ke	y Dates	
00502	Permanent Power On		0		07-Nov-24		•	Perman	ent Power	On			1 1 1 1 1	7-7-7-7	
02631	HVAC Commissioned		0		21-Nov-24	: :	<b>│</b>	HVAC	Commissio	oned		1 1 1 1			1 1 1
East Dundee.Proje	ect.4 City Approval		52	21-Jun-24 A	23-Jul-24	1 1	23-Jul-	1 1 1 1				1 1 1 1			
East Dundee.Pro	ject.4.9 Permits		52	21-Jun-24 A	23-Jul-24	i'	23-Jul-	24, East	Dundee.P	roject 4.9	Permit	s			
00025	Full Building Permit - Application Submittal			21-Jun-24 A				 							
00094	Water & Sewer Permit		10	01-Jul-24	15-Jul-24		☐ Water8					1 1 1 1			
00045	Full Building Permit - Review		10	21-Jun-24 A	15-Jul-24	: :	🔲 🛮 Full Bui	lding Per	mit - Revie	w :	1 1 1 1	1 1 1 1			1 1 1

East D	oundee Exhibit D Schedu	ıle	James McHuç	gh C	onstruct	tion													
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			1	Duration			Q2	Q3	Q4	Q1	Q2	Q3	Q4	Q1	Q2	Q3 Q4	Q1	Q2	Q3 Q4
	00047	Full Building Permit - Processing		5	16-Jul-24	22-Jul-24		0 F	ıll Buildi	ng Perr	mit - P	rocess	sing				1 1 1		
	00051	Full Building Permit - Received		1	23-Jul-24	23-Jul-24		I F	ılı Buildi	ng Perr	mit - R	eceive	ed					: :	
	East Dundee.Project.8 A	rchitectural Design		52	15-Apr-24 A	08-Jul-24	: :	<b>7</b> 08	Jul-24,	East Di	undee	.Proje	ct.8 Ar	chitect	ural Desi	gn		: :	
	East Dundee.Project.8.1	Design Development		52	15-Apr-24 A	08-Jul-24		<b>7</b> 08	Jul-24,	East Di	undee	.Proje	ct.8.1	Desigr	n Develop	ment			
	00002	City Approval of Concept Drawings		0	15-Apr-24 A		City	Арр	oval of	Concep	ot Drav	wings							
	00001	Schematic Design: 100% SD		10	15-Apr-24 A	24-Apr-24 A	Sc	hem	tic Desi	gn: 100	)% SD								
	00004	MEP Permit Set		10	24-Apr-24 A	10-Jun-24 A		MEF	Permit	Set									
	00005	ComEd Load Letter		5	01-Jul-24	08-Jul-24		C	mEd Lo	ad Lett	ter								
	00003	Planning and Zoning Approval - Owner		5	01-Jul-24	08-Jul-24		] Pla	inning a	nd Zon	ning Ap	prova	l - Own	er			1 1 1 1		
	East Dundee.Project.8.2	Construction Documents		40	15-Jun-24 A	01-Jul-24 A	•	7 01	Jul-24 A	, East [	Dunde	e.Proj	ject.8.2	Cons	struction [	Document	s. i	: :	
	00007	Construction Documents: 50% CD - GMP Set		23	15-Jun-24 A	15-Jun-24 A	1	Con	struction	Docur	ments:	50%	CD - C	MP S	et			1 1	
	00006	Construction Documents: 100% CD - GMP Se	t	19	01-Jul-24 A	01-Jul-24 A		Co	nstructio	n Docu	ument	s: 100	% CD	- GMP	Set				
_	East Dundee.Project.14	MEP Coordination		96	16-May-24 A	07-Jun-24 A	₩	07-J	ın-24 A,	East D	Ounde	e.Proje	ect.14	MEP (	Coordinat	ion			
	00015	MEP Coordination (50%)		10	16-May-24 A	30-May-24 A		MEP	Coordin	ation (5	50%)	 					1-1-1-		
	00022	MEP Coordination (100%)		10	31-May-24 A	03-Jun-24 A		MEP	Coordin	ation (	(100%)	)							
	00036	MEP Coordination (100%) Shop Drawing Coo	dination	15	03-Jun-24 A	07-Jun-24 A		MEP	Coordin	nation (	(100%)	) Shop	Drawi	ng Co	ordination				
	East Dundee.Project.10	Budget		0	31-May-24 A	31-May-24 A	▼	31-M	ay-24 A,	East D	Ounde	e.Proje	ect.10	Budge	t			: :	
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	East Dundee.Project.9 P	rocurement-1		209	16-Jul-24	27-May-25		V.			<del></del>	27-Ma	y-25, E	ast Dı	ındee Pro	ject 9 Pro	ocureme	nt-1	::::: :
	East Dundee.Project.9.5	Buyout		5	16-Jul-24	22-Jul-24		₩ 2	2-Jul-24,	East D	Dunde	e.Proj	ect.9.5	Buyo	ut				
	00018	Award Subcontractors - Elevators		0	16-Jul-24	16-Jul-24		I. A	vard Sul	ocontra	ctors -	Eleva	tors						
	00017	Award Subcontractors - Plumbing		0	16-Jul-24	16-Jul-24		I A	vard Sul	ocontra	ctors -	Plum	bing						
	00033	Award Subcontractors - Window System		5	16-Jul-24	22-Jul-24		[ A	ward Su	bcontra	actors	- Wind	low Sys	stem					
	00016	Award Subcontractors - Concrete		5	16-Jul-24	22-Jul-24		[ A	ward Su	bcontra	actors	- Cond	crete		7-7-5-	<del></del>	1-1-1-		  -  -  -  -  -  -  -
	00010	Award Subcontractors - Sitework		5	16-Jul-24	22-Jul-24		[ A	ward Su	bcontra	actors	- Sitev	vork					: :	
	00009	Award Subcontractors - Mechanical		5	16-Jul-24	22-Jul-24		1 A	ward Su	bcontra	actors	- Mecl	nanical		1 1 1 1			: :	
	00011	Award Subcontractors - Electrical		5	16-Jul-24	22-Jul-24		I A	ward Su	bcontra	actors	- Elect	rical					: :	: : : : : : : : : : : : : : : : : : :
	00012	Award Subcontractors - Fire Protection		5	16-Jul-24	22-Jul-24		[ A	ward Su	bcontra	actors	- Fire I	Protect	ion				1 1	
	East Dundee.Project.9.1	Procure: Concrete Shell		221	23-Jul-24	27-May-25		<b>V</b>			<del></del>	27-Ma	y-25, E	ast Du	ındee Pro	oject,9.1 F	Procure:	Conc	ete Shell
		9.1.1 Procure: Concrete Rebar & Post Tension	ning	221	23-Jul-24	27-May-25		<u> </u>			1 1 1	1 1 1		1 1 1	1 1 1 1			1 1	crete Reba
	00027	Submittals / Shop Drawings - Concrete Rebar		15	23-Jul-24	12-Aug-24			Submitta	als / Sh	op Dr	awings	s - Con	crete F	Rebar				
	00049	Submittal Architect Review - Concrete Rebar		10	13-Aug-24	26-Aug-24			Submit	tal Arch	nitect F	Review	v - Con	crete F	Rebar				
	Remaining Level of Effort	Remaining Work	Pag	ge 2 of 1	0			-	TASK fil	ter: All	Activi	ities							
	Actual Work	Critical Remaining Work															© O	acle (	Corporation

East Dun	dee Exhibit D Sch	edule	James McHu	gh Constru	ction		
ctivity ID		Activity Name		Original Start Duration	Finish	2024 Q2 (	2025   2026   2027   Q3   Q4   Q1   Q2   Q3   Q4   Q1   Q2   Q3   Q4   Q1   Q2   Q3
	00061	Concrete Rebar Material Procurement		0 27-Aug-24	27-Aug-24		I. Concrete Rebar Material Procurement
	00067	Supply Chain Uncertainty		5 27-Aug-24			I Sụpply Chain Ųncertainty
	00074	Concrete Rebar: Required On Job (R.O.J.)		1 27-May-25	5 27-May-25		Concrete Rebar: Required On Job (R.O.J.)
	East Dundee.Projec	t.9.4 Procure: Elevators		56 16-Jul-24	07-Oct-24	<b>-</b>	07-Oct-24, East Dundee Project 9.4 Procure: Elevators
	East Dundee.Pro	ject.9.4.5 Procure: Elevators Pits		25 16-Jul-24	19-Aug-24	<b>-</b>	■ 19-Aug-24, East Dundee Project 9.4.5 Procure: Elevators Pits
	00039	Submittals / Shop Drawings - Elevator Pits		15 16-Jul-24*	05-Aug-24	_	Submittals:/ Shop Drawings:- Elevator Pits
	00066	Submittal Architect Review - Elevator Pits		10 06-Aug-24	19-Aug-24		Submittal Architect Review - Elevator Pits
	East Dundee.Pro	ject.9.4.1 Procure: Elevator		56 16-Jul-24	07-Oct-24		07-Oct-24, East Dundee.Project.9.4.1 Procure: Elevator
	00044	Submittals - Elevators		15 16-Jul-24*	30-Jul-24		Submittals - Elevators
	00081	Manufacturing & Delivery - Elevator		60 31-Jul-24	28-Sep-24		Manufacturing & Delivery - Elevator
	00144	Mobilization - Elevator		5 30-Sep-24	04-Oct-24		□ Mobilization - Elevator
	00844	Installation Start - Elevator		0 07-Oct-24	07-Oct-24		I Installation Start - Elevator
	East Dundee.Projec	t.9.19 Procure: Plumbing		133 16-Jul-24	16-Jan-25	■ ▼	16-Jan-25, East Dundee Project 9.19 Procure: Plumbing
	East Dundee.Pro	ject.9.19.3 Procure: Fire Pump		128 23-Jul-24	16-Jan-25	▼	16-Jan-25, East Dundee Project 9.19.3 Procure: Fire Pump
	00098	Submittals - Fire Pump		15 23-Jul-24	12-Aug-24		Submittals - Fire Pump
	00123	Submittal Architect Review - Fire Pump		10 13-Aug-24	26-Aug-24		Submittal Architect Review Fire Pump
	00129	Material Procurement - Fire Pump		70 27-Aug-24	02-Dec-24		Material Procurement - Fire Pump
	00188	Required on Job (ROJ): Fire Pump		1 16-Jan-25	16-Jan-25		I Required on Job (ROJ): Fire Pump
	East Dundee.Pro	ject.9.19.01 Procure: Domestic Water Pump		95 16-Jul-24	25-Nov-24	<b>-</b>	25-Nov-24, East Dundee Project 9.19.01 Procure: Domestic Water Put
	00104	Submittals - Domestic Water Pump		15 16-Jul-24	05-Aug-24		Submittals - Domestic Water Pump
	00133	Submittal Architect Review - Domestic Water P	ump	10 06-Aug-24	19-Aug-24		☐ Submittal Architect Review - Domestic Water Pump
	00143	Material Procurement - Domestic Water Pump		70 20-Aug-24	25-Nov-24		Material Procurement - Domestic Water Pump
	01989	Required on Job (ROJ): Domestic Water Pump	)	1 25-Nov-24	25-Nov-24		l Required on Job (ROJ): Domestic Water Pump
	East Dundee.Pro	ject.9.19.2 Procure: Grease Interceptors		38 16-Jul-24	05-Sep-24		05-Sep-24, East Dundee Project 9:19.2 Procure: Grease Interceptors
	00109	Submittals - Grease Interceptors		15 16-Jul-24	05-Aug-24		Submittals - Grease Interceptors
	00134	Submittal Architect Review - Grease Interceptor	rs	10 06-Aug-24	19-Aug-24		☐ Submittal Architect Review - Grease Interceptors
	00142	Material Procurement - Grease Interceptors		5 20-Aug-24	26-Aug-24		Material Procurement - Grease Interceptors
	00205	Required on Job (ROJ): Grease Interceptors		1 05-Sep-24	05-Sep-24		1 Required on Job (ROJ): Grease Interceptors
	East Dundee.Projec	t.9.2 Procure: Electrical		204 23-Jul-24	27-May-25	<b>T</b>	27-May-25, East Dundee Project 9.2 Procure: Electrical
	East Dundee.Pro	ject.9.2.5 Procure: Electrical Long Lead Items		204 23-Jul-24	27-May-25		27-May-25, East Dundee Project 9.2.5 Procure: Electrical
	40371	Submittals - Electrical Long Lead Items		15 23-Jul-24	12-Aug-24		Submittals -: Electrical Long Lead Items
	40372	Submittal Architect Review - Electrical Long Lea	ad Items	10 13-Aug-24	26-Aug-24		Submittal Architect Review - Electrical Long Lead Items
R	Remaining Level of Eff	_	Pa	ge 3 of 10			TASK filter: All Activities
A	Actual Work	Critical Remaining Work					© Oracle Corpo

ast Dundee Exhibit [	D Schedule	James McHı	ıgh C	onstruc	tion			
ty ID	Activity Name		Original		Finish			2027
			Duration			Q2		2 Q3
40373	Material Procurement - Panel Board		90	27-Aug-24	24-Nov-24		Material Procurement - Panel Board	
40376	Material Procurement - Meters		90	27-Aug-24	24-Nov-24	_ : :	Material Procurement - Meters	
40378	Material Procurement - Transformers			27-Aug-24	24-Nov-24		Material Procurement - Transformers	
40374	Required on Job (ROJ): Electrical Long Lead I	tems	1	27-May-25	27-May-25	1 1	l Required on Job (ROJ): Electrical Long Lead Item	<b>s</b>
East Dund	lee.Project.9.2.1 Procure: Electrical		57	23-Jul-24	09-Oct-24	1 1	09-Oct-24, East Dundee Project 9:2.1 Procure: Electrical	
00070	Submittals - Electrical		15	23-Jul-24	12-Aug-24		Submittals - Electrical	
00082	Submittal Architect Review - Electrical		10	13-Aug-24	26-Aug-24	1 1	Submittal Architect Review - Electrical	
00100	Material Procurement - Electrical		20	27-Aug-24	23-Sep-24		Material Procurement - Electrical	
00130	Required on Job (ROJ): Electrical		1	09-Oct-24	09-Oct-24	: :	I Required on Job (ROJ); Electrical	
East Dund	dee.Project.9.2.2 Procure: Electrical Switchgear		204	23-Jul-24	27-May-25	1 1	▼ 27-May-25, East Dundee Project 9.2.2 Procure: E	lectrical S
00071	Submittals - Electrical Switchgear		15	23-Jul-24	12-Aug-24		Submittals - Electrical Switchgear	
00083	Submittal Architect Review - Electrical Switchge	ear	10	13-Aug-24	26-Aug-24		Submittal Architect Review - Electrical Switchgear	
00113	Material Procurement - Electrical Switchgear		90	27-Aug-24	24-Nov-24		Material Procurement - Electrical Switchgear	
00288	Required on Job (ROJ): Electrical Switchgear		1	27-May-25	27-May-25		l Required on Job (ROJ): Electrical Switchgear	
East Dund	lee.Project.9.2.4 Procure: Light Fixtures		118	23-Jul-24	02-Jan-25		02-Jan-25, East Dundee Project 9.2.4 Procure: Light Fixture	s
00073	Submittals - Light Fixtures		15	23-Jul-24	12-Aug-24	: :	Submittals - Light Fixtures : : : : : : : : : : : : : : : : : : :	1 1 1 1 1 1 1 1 1 1 1 1
00085	Submittal Architect Review - Light Fixtures		10	13-Aug-24	26-Aug-24		☐ Submittal Architect Review - Light Fixtures	
00112	Material Procurement - Light Fixtures		15	27-Aug-24	16-Sep-24		☐ Material Procurement - Light Fixtures	
00645	Required on Job (ROJ): Light Fixtures		1	02-Jan-25	02-Jan-25		Required on Job (ROJ): Light Fixtures	
East Dundee.P	Project.17 Procure: Window System		91	23-Jul-24	10-Dec-24	1 1	10-Dec-24, East Dundee Project 17 Procure: Window System	
00111	Submittals - Window System		15	23-Jul-24	06-Aug-24	: :	Submittals - Window System	
00139	Submittal Architect Review - Window System		10	06-Aug-24	20-Aug-24		☐ Submittal Architect Review - Window System	
00147	Material Procurement - Window System		90	21-Aug-24	18-Nov-24		Material Procurement - Window System	
00287	Required On Job (R.O.J.) - Window System		1	10-Dec-24	10-Dec-24		I Required On Job (R.O.J.) - Window System	
East Dundee.P	Project.Procurement Procurement		209	16-Jul-24	27-May-25		27-May-25, East Dundee Project Procurement Pr	ocureme
East Dundee.	.Project.Procurement.2 Buyout		31	16-Jul-24	27-Aug-24	1 1	27-Aug-24, East Dundee Project Procurement, 2 Buyout	
001064	Owner Material Selection - Flooring		1	16-Jul-24	16-Jul-24		I Owner Material Selection - Flooring	
00095	Award Subcontractors - Irrigation & Landscapir	ng	5	16-Jul-24	22-Jul-24		Award Subcontractors - Irrigation & Landscaping	
00096	Award Subcontractors - Roofing & Waterproofi	ng	15	16-Jul-24	05-Aug-24		Award Subcontractors - Roofing & Waterproofing	
00099	Award Subcontractors - Specialty Roof Faming		15	16-Jul-24	05-Aug-24		☐ Award Subcontractors - Specialty Roof Faming	-     
40670	Award Subcontractors - Parking Signage and S	Striping	15	16-Jul-24	05-Aug-24		Award Subcontractors - Parking Signage and Striping	
00114	Award Subcontractors - Parking Equipment an	d Striping	15	16-Jul-24	05-Aug-24		Award Subconfractors - Parking Equipment and Striping	
Remaining Leve	el of Effort Remaining Work	P	age 4 of 1	10			TASK filter: All Activities	
Actual Work	Critical Remaining Work	·	g ·				© Oracl	e Corpor

East D	Oundee Exhibit D Schedu	le	James McHu	ıgh C	onstruc	tion												
Activity ID		Activity Name		Original Duration		Finish	20 Q2	24 Q3	3 Q4 Q1	2025 Q2 Q3	Q4	Q1 (	2026 Q2	Q3 Q4	l G	)1 Q	2027 2 Q	3 Q4
	00102	Award Subcontractors - Doors		20	16-Jul-24	12-Aug-24			Award Subcor	ntractors - Do	ors							
	00105	Award Subcontractors - Paint		30	16-Jul-24	26-Aug-24			Award Subco	ontractors - Pa	aint							
	00106	Award Subcontractors - Drywall		30	16-Jul-24	26-Aug-24			Award Subco	ontractors - D	rywall							
	00110	Award Subcontractors - Misc. Metals and Raili	ngs	30	16-Jul-24	26-Aug-24			Award Subco	ontractors - M	isc. Met	als and F	Railing	s				
	00108	Award Subcontractors - Flooring		30	17-Jul-24	27-Aug-24			Award Subco	ontractors - Fl	ooring							
	East Dundee.Project.Pro	ocurement.6 Procure: Specialty Roof Faming		90	06-Aug-24	25-Dec-24	1 1	<del>       </del>	25-0	Dec-24, East	Dundee	Project.	Procur	ement.6	Proc	ure: Sp	ecialty	Roof Fa
	40693	Submittals - Specialty Roof Faming		15	06-Aug-24	26-Aug-24			Submittals -	Specialty Ro	of Fami	ng						
	40694	Submittal Architect Review - Specialty Roof Fa	ming	10	27-Aug-24	09-Sep-24			Submittal A	rchitect Revie	w - Spe	cialty Ro	of Fan	ning		7-7-7-		
	40695	Material Procurement - Specialty Roof Faming		15	10-Sep-24	24-Sep-24			■ Material Pr	rocurement -	Special	y Roof F	aming					
	40696	Required on Job (ROJ): Specialty Roof Famin	g	1	25-Dec-24	25-Dec-24			I Req	uired on Job	(ROJ):	Specialty	Roof	Faming				
	East Dundee.Project.Pro	ocurement.4 Procure: Parking Equipment and	Striping	110	06-Aug-24	24-Jan-25		<b>V</b>	24	4-Jan-25, Eas	t Dund	ee Projec	t.Proc	urement.	4 Pro	cure: F	Parking	ı Equipn
	40685	Submittals - Parking Equipment and Striping		15	06-Aug-24	26-Aug-24	-		Submittals -	Parking Equi	pment a	and Stripi	ng					
	40686	Submittal Architect Review - Parking Equipmen	nt and Striping	10	27-Aug-24	09-Sep-24	17-7-		Submittal A	rchitect Revie	w - Parl	king Equi	omen	and Strip	bing			
	40687	Material Procurement - Parking Equipment an	d Striping	15	10-Sep-24	24-Sep-24	1		Material Pr	rocurement -	Parking	Equipme	nt an	l Striping				
	40688	Required on Job (ROJ): Parking Equipment a	nd Striping	1	24-Jan-25	24-Jan-25			I R	equired on Jo	b (ROJ	l): Parking	j Equi	oment ar	nd Str	iping		
	East Dundee.Project.Pro	ocurement.12 Procure: Roofing & Waterproof	ing	57	06-Aug-24	23-Oct-24			23-Oct-2	4, East Dund	ee Proj	ect Procu	remer	t.12 Pro	cure:	Roofin	g & W	aterproo
	00361	Submittals - Roofing & Waterproofing	-	15	06-Aug-24	26-Aug-24	- : :		Submittals -	Roofing & W	aterpro	ofing						
	00499	Submittal Architect Review - Roofing & Waterp	proofing	10	27-Aug-24	09-Sep-24			Submittal A	rchitect Revie	w - Roc	fing & W	aterpr	oofing			1 1 1	
	00590	Material Procurement - Roofing & Waterproofi	ng	15	10-Sep-24	30-Sep-24			Material P	rocurement -	Roofing	, & Wate	proofi	ng:				
	01052	Required on Job (ROJ): Roofing & Waterproo	fing	1	23-Oct-24	23-Oct-24			I Required	on Job (RO	J): Root	ing & Wa	terpro	ofing				
	East Dundee.Project.Pro	ocurement.14 Procure: Doors, Frames & Hard	dware	119	13-Aug-24	24-Jan-25		_	▼ 24	4-Jan-25, Eas	t Dund	ee Projec	t.Proc	urement.	14 P	rocure:	Doors	, Frame
	00149	Submittals - Doors, Frames & Hardware		15	13-Aug-24	02-Sep-24	<b>-</b>		Submittals -	Doors, Fram	es & H	ardware						
	00174	Submittal Architect Review - Doors, Frames &	Hardware	10	03-Sep-24	16-Sep-24	15-5-	[	■ Submittal A	rchitect Revie	ew - Do	ors, Fram	es & F	lardware				
	00183	Material Procurement - Doors, Frames & Hard	ware	40	17-Sep-24	11-Nov-24	1		Materia	al Procuremer	nt - Doo	rs, Frame	s & H	ardware				
	00546	Required on Job (ROJ): Doors, Frames & Har	dware	1	24-Jan-25	24-Jan-25			I R	equired on Jo	b (ROJ	): Doors,	Frame	es & Hard	lware			
	East Dundee.Project.Pro	ocurement.15 Procure: Drywall		196	27-Aug-24	27-May-25		V	<b>V</b>	27-Ma	y-25, E	ast Dunc	ee.Pr	ject.Prod	curem	ent 15	Procu	ıre: Dryv
	00168	Submittals - Drywall		15	27-Aug-24	16-Sep-24	- : : : :		Submittals	- Drywall								
	00190	Submittal Architect Review - Drywall		10	17-Sep-24	30-Sep-24			□ Submittal	Architect Rev	iew - Dr	ywall				111	7-1-1-	7-1-1-1
	00224	Material Procurement - Drywall		10	01-Oct-24	14-Oct-24				Procurement	1 1 1							
	00261	Required on Job (ROJ): Drywall		1	27-May-25	27-May-25	1			l Requi	red on .	Job (ROJ	): Dry	vall				
	East Dundee.Project.Pro	ocurement.17 Procure: Paint		64	27-Aug-24	22-Nov-24		V	22-No	v-24, East Du	ındee P	roject.Pro	curen	nent 17 I	Procu	re: Paiı	nt	
	00334	Submittals - Paint		15	27-Aug-24	16-Sep-24		ļ	Submittals	- Paint			1 1					
	Remaining Level of Effort  Actual Work	Remaining Work Critical Remaining Work	Pi	age 5 of 1	0				TASK filter: A	II Activities					(	) Oracl	e Corp	ooration

st Dundee Exhil	bit D Schedule	James McHu	gh C	onstruc	tion											
y ID	Activity Name		Original		Finish	20	)24		2025			2026			2027	7
			Duration			Q2	Q3 Q4	Q1	Q2 Q:	3 Q4	Q1 C	2 Q3	Q4	Q1 (	Q2 (	Q3
00423	Submittal Architect Review - Paint		10	17-Sep-24	30-Sep-24		Suk	bmittal /	Architect Ro	eview - P	aint					
00509	Material Procurement - Paint		10	01-Oct-24	14-Oct-24	1 1	i i ∏iMa	aterial F	rocuremer	it - Paint	1 1 1 1 1	1 1 1 1 1	1 1 1 1 1 1 1 1			1 1
00591	Required on Job (ROJ): Paint		1	22-Nov-24	22-Nov-24			Requir	ed on Job	(ROJ): P	aint		  			1 1
East Dun	dee.Project.Procurement.11 Procure: Landscaping		221	23-Jul-24	27-May-25		<b>V</b>		27-1	/lay-25, I	East Dunde	ee.Project	Procur	ement 1	l Proc	ure
00117	Submittals - Landscaping		10	23-Jul-24	05-Aug-24		Submitt	tals - La	ndscaping							
00122	Submittal Architect Review - Landscaping		10	06-Aug-24	19-Aug-24		☐ Submi	ittal Arcl	itect Revie	w - Land	dscaping					
00128	Material Procurement - Landscaping		20	20-Aug-24	16-Sep-24		Mate	erial Pro	curement	Landsc	aping					
00154	Required on Job (ROJ) - Landscaping		1	27-May-25	27-May-25				l Rec	uired on	Job (ROJ)	- Landsca	ping			
East Dunde	e.Project.12 Site Civil		167	15-Aug-24	28-Apr-25		\ <del>\ \ \ \ \ \ \ \ \ \ \ \ \ \ \ \ \ \ \</del>		<b>₹</b> 28-Ap	-25, Eas	t Dundee.	Project.12	Site C	ivil		
East Dun	dee.Project.12.5 Sitework		167	15-Aug-24	28-Apr-25			1 1 1	<b>₹</b> 28-Ap	-25, Eas	t Dundee.	Project.12	5 Site	work		
East D	undee.Project.12.5.5 Site Utilities -		25	15-Aug-24	19-Sep-24		19-5	Sep-24,	East Dunc	lee Proje	ct.12.5.5	Site Utilitie	s -			17.7
401	80 Sitework: Site Utilities - Water, Sewer, and Sto	orm Taps to Site	8	15-Aug-24	26-Aug-24		■ Sitewo	ork: Site	Utilities - \	Vater, Se	ewer, and S	Storm Taps	s to Site	<b>,</b>		
401	78 Sitework: Grease Trap & Piping Triple Oil Basi	in	1	06-Sep-24	06-Sep-24		I Sitew	vork: Gr	ease Trap &	R Piping	Triple Oil B	asin				
401	81 Sitework: Water		5	06-Sep-24	12-Sep-24		■ Sitev	work: W	ater							
401	82 Sitework: Electric		5	06-Sep-24	12-Sep-24		Sitev	work: El	ectric							
401	83 Sitework: Telecom		5	06-Sep-24	12-Sep-24	11-1-	_ <b>I</b> Sitev	work: Te	lecom				i-i-i-i ! ! ! !		iii	
401	79 Sitework: Underground Storm Piping & Sanita	ary	10	06-Sep-24	19-Sep-24		☐ Site	work: U	nderground	Storm	Piping & Sa	anitary				
East D	undee.Project.12.5.1 Sitework - North River Street, Hill Str	eet, & Surface Lot	130	10-Oct-24	28-Apr-25			1 1 1	<b>₹</b> 28-Ap	-25, Eas	t Dundee.	Project.12	.5.1 Si	tework -	North I	Riv
015	91 Sitework: Grading		5	10-Oct-24	21-Oct-24		. □ \$i	itework:	Grading							
015	89 Sitework - Sidewalk		5	22-Oct-24	28-Oct-24		l s	Sitework	- Sidewalk							
015	61 Sitework - Form & Pour Curbs & Gutters		5	29-Oct-24	04-Nov-24	1:-::-		Sitework	- Form & I	Pour Cur	bs & Gutte	rs :	i-i-i-i		iii	
031	37 Sitework - Asphalt Paving		5	05-Nov-24	12-Nov-24		: ס	Sitewor	k - Asphalt	Paving						
031	53 Sitework - Striping		2	13-Nov-24	14-Nov-24			Sitewor	k - Striping							
407	05 Sitework: EV Charger Install at Suraface Park	king Lot	5	13-Nov-24	19-Nov-24			Sitewo	k: EV Cha	ger Insta	all at Surafa	ace Parkin	g Lot			
407	03 Sitework - Landscaping		10	15-Apr-25*	28-Apr-25				Sitewo	rk - Land	dscaping					
East Dunde	ee.Project.1.2 Structure		62	22-Jul-24	25-Oct-24		2	5-Oct-2	4, East Du	ndee.Pro	ject.1.2 S	tructure	i - i - i - i ! ! ! ! !		,iii	;; ; ;
East Dun	dee.Project.1.2.1.1 Excavation		18	22-Jul-24	14-Aug-24		<b>▼▼</b> 14-Aug	g-24, Ea	ast Dundee	Project.	1.2.1.1 Ex	cavation				
00030	Excavation Mobilization		1	22-Jul-24*	22-Jul-24	1 1	I Excavati	ion Mob	ilization							
00029	Perimeter Fencing		5	22-Jul-24	26-Jul-24		I Perimete	er Fenc	ing							
00040	Soil Erosion and Sediment Controls (SPPP)		1	26-Jul-24	26-Jul-24		Soil Eros	sion an	d Sedimen	Control	s (SPPP)					
00043	Site Prep		5	29-Jul-24	02-Aug-24	1:-::-	Site Pre	эр	i - i - i - i - i - i - 				i-i-i-i ! ! ! ! !		iii ,	ii-
00048	Pothole for ERS		2	05-Aug-24	06-Aug-24		l Pothole	e for ER	s							
Remaining l	Level of Effort Remaining Work Critical Remaining Work	Pa	ge 6 of 1	0			TASK f	filter: A	I Activities					© Orac	cle Co	rpc

East Dundee Exhibit D	Schedule	James McHugh Co	onstruc	tion										
Activity ID	Activity Name	Original Duration	Start	Finish	202 Q2	24 Q3	3 Q4 Q1	2025 Q2 Q3	Q4	Q1 Q2	26 Q3 Q4	Q1	202	7 Q3 Q4
00041	ERS Mobilization	1	07-Aug-24	07-Aug-24			ERS Mobilizatio	n; ; ; ;				1 : : :	: : :	
00050	ERS Installation	5	08-Aug-24	14-Aug-24		0	ERS Installation	1						
East Dundee.Pr	roject.1.2.1.2.1 Foundations	20	15-Aug-24	12-Sep-24		_	▼ 12-Sep-24, E	ast Dundee	Projec	.1.2.1.2.1 F	oundations		1 1 1	
40704	Footings Mobilization / Layout	3	15-Aug-24	19-Aug-24		Ī	Footings Mobili	zation / Lay	out					
00069	Excavate Footings and Frost Walls	5	20-Aug-24	26-Aug-24		0	Excavate Foot	ings and Fro	ost Wa	s				
00075	Form & Pour Footings and Frost Walls	10	22-Aug-24	05-Sep-24			Form & Pour F	ootings an	d Frost	Walls				
00091	Back Fill Footings and Frost Walls and Cut to	Grade 5	06-Sep-24	12-Sep-24	1: :		Back Fill Foot	ings and Fr	ost Wal	sand Cut to	Grade			
East Dundee.Pr	roject.1.2.1.2.2 Garage Structure	19	20-Sep-24	25-Oct-24			25-Oct-24,	East Dund	ee.Proj	ect.1.2.1.2.2	Garage Str	ucture		
East Dundee	e.Project.1.2.1.2.2.2 Garage Elevated Decks & Walls	20	27-Sep-24	25-Oct-24			25-Oct-24	, East Dund	ee Proj	ect.1.2.1.2.2	2 Garage E	levated	Decks &	չ Wals
00097	North Deck Level 02 - Pour 2	5	27-Sep-24	03-Oct-24			North Deck	Level 02 - F	our 2					
00132	South Deck Level 02 - Pour 4	4	10-Oct-24	16-Oct-24	1: : :		South Dec	k Level 02 -	Pour 4					
00140	South Deck Level 03 - Pour 5	3	17-Oct-24	21-Oct-24	1: : :		South Dec	k Level 03	Pour 5					
01856	Elevator Machine Room Roof Form & Pour D	ecks and Walls 4	22-Oct-24	25-Oct-24			l Elevator M	lachine Roc	m Roo	f Form & Po	r Decks and	l Walls		
East Dundee	Project.1.2.1.2.2.13 Garage: Slab-On-Grade	12	20-Sep-24	09-Oct-24			▼ 09-Oct-24,	East Dunde	e Proje	ct 1,2.1.2.2.	3 Garage:	Slab-On-	Grade	
01858	North Slab on Grade - Pour 1	5	20-Sep-24	26-Sep-24	<b>-</b>  : :		North Slab o	n Grade - F	our 1					
01859	South Slab on Grade - Pour 3	3	07-Oct-24	09-Oct-24			I South Slab	on Grade -	Pour 3					
East Dundee.Pro	ject.11 Building Envelope	67	24-Oct-24	31-Jan-25			31-	Jan-25, Eas	st Dund	ee Project.1	Building E	rvelope		
	roject.11.1.5 Roofing	2	24-Oct-24	25-Oct-24			▼ 25-Oct-24,	, East Dund	ee Proj	ect.11.1.5 R	oofing			
02230	Roof: Elevator Machine Room Dry-In	2	24-Oct-24	25-Oct-24			l Roof: Elev	ator Machir	ne Roor	n Dry-In		1-1-1-1		
East Dundee.Pr	roject.11.1 Retail Facade	65	28-Oct-24	31-Jan-25			▼ 31-	Jan-25, Eas	st Dund	ee.Project.1	.1 Retail Fa	cade		
East Dundee	e.Project.11.1.3 West Retail Elevation	65	28-Oct-24	31-Jan-25			▼ 31-	Jan-25, Eas	st Dund	ee.Project.1	.1.3 West F	Retail Ele	vation	
40777	Retail Elevation: CMU	10	28-Oct-24	08-Nov-24	<b>.</b>		🛚 Retail Ele	vation: CM	Ü					
40781	Retail Elevation: Waterproofing	5	12-Nov-24	18-Nov-24	1: : :		Retail El	evation: Wa	te ip roo	ing				
40783	Retail Elevation: Masonry Face Brick	15	19-Nov-24	10-Dec-24			🔲 Retail I	Elevation: M	lasonry	Face Brick				
40784	Retail Elevation: Storefront Window	10	11-Dec-24	24-Dec-24			■ Retail	Elevation:	Storefro	nt Window				
40785	Retail Elevation: Specialty Roofing, Metal Par	nels and Coping 15	26-Dec-24	16-Jan-25			Reta	al Elevation	Specia	alty Roofing,	Metal Panel	s and Co	pping	
40787	Retail Elevation: Lights and Signage	5	17-Jan-25	24-Jan-25			<b>I</b> Ret	ail Elevation	n: Lights	and Signag	e			
40788	Retail Elevation: Awnings	5	27-Jan-25	31-Jan-25	1: : :		l Re	tail Elevatio	n: Awnir	ngs :			1 1 1	1 1 1 1 1 1 1 1 1 1 1 1
East Dundee.Pro	ject.1.7 Interiors	65	22-Oct-24	30-Jan-25			▼ 30-	Jan-25, Eas	st Dund	ee.Project.1.	7 Interiors			
East Dundee.Pr	roject.1.7.1 Interiors - Parking Levels	24	26-Dec-24	30-Jan-25			30-	Jan-25, Eas	st Dund	ee.Project.1.	7.1 Interiors	- Parkin	g Level	s
East Dundee	e.Project.1.7.1.1 Parking - Level 01	22	26-Dec-24	28-Jan-25			28-	Jan-25, Eas	t Dund	ee.Project.1.	7.1.1 Parkir	g - Leve	l 01	
00629	Parking - Level 01: Fire Protection	5	26-Dec-24	02-Jan-25			<b>[</b> Parkii	ng - Level 0	1: Fire F	Protection				
Remaining Level of Actual Work	of Effort Remaining Work Critical Remaining Work	Page 7 of 10	)				TASK filter: All	Activities				© Ora	acle Co	orporation

			James McH	ugn C	onstruc	LION														
ty ID		Activity Name		Original Duration		Finish	20 Q2	024 Q3	Q4	Q1	Q2	2025 2 Q3	Q4	Q1	202 Q2		)4 (	Q1 C	2027	7 Q3
	00675	Parking - Level 01: Light Fixtures		5	03-Jan-25	09-Jan-25						- Level (							_	
	00496	Parking - Level 01: Waterproofing		5	17-Jan-25	24-Jan-25			-1-1-1-			j - Leve				_ L _ 1 _ 1 _ 1			-!!!	
	01248	Parking - Level 01: Striping		2	27-Jan-25	28-Jan-25			1 1 1	1 1	1 1 1	g - Leve	1 1 1	1 1 1						
	01249	Parking - Level 01: Signage		2	27-Jan-25	28-Jan-25				1 1	1 1 1	g - Leve	1 1 1	1. 1.3						
	East Dundee.Proj	ect.1.7.1.3 Parking - Level 02		19	03-Jan-25	30-Jan-25			-	30	0-Jar	i-25, Ea	st Dunc	dee Pr	oject.1.7	7.1.3 Par	king -	Level 0	2	
	00676	Parking - Level 02: Fire Protection		5	03-Jan-25	09-Jan-25			0	Par	rking	- Level (	)2: Fire	Prote	ction					
	00677	Parking - Level 02: Waterproofing above Retail	i	5	10-Jan-25	16-Jan-25			]	<b>I</b> Pa	arking	- Level	02: Wa	terpro	ofing ab	ove Reta	i i			
	01315	Parking - Level 02: East Stair Tower Misc. Stee	el	5	10-Jan-25	16-Jan-25				l Pa	arking	- Level	02: Eas	st Stai	r Tower I	Misc. Ste	el			
	00725	Parking - Level 02: Light Fixtures		5	17-Jan-25	24-Jan-25				I Pa	arking	j - Level	02: Lig	ht Fix	tures					
	01316	Parking - Level 02: East Stair Tower Roofing		5	17-Jan-25	24-Jan-25				I Pa	arking	j - Leve	02: Ea	st Sta	ir Tower	Roofing				
	01313	Parking - Level 02: Striping		2	29-Jan-25	30-Jan-25	1 1			I P	Parkin	g - Leve	I 02: St	riping		1 1 1 1				
	01314	Parking - Level 02: Signage		2	29-Jan-25	30-Jan-25				<b>I</b> P	Parkin	g - Leve	l 02: Si	gnage	•					
Ea	ast Dundee.Project	t.1.7.40 Interiors - Amenities Areas		26	22-Oct-24	02-Dec-24			<b>**</b> 0	02-De	ec-24	, East D	undee.	Projec	t.1.7.40	Interiors	-Ame	enities /	\reas	
	East Dundee.Proj	ect.1.7.40.39 Interiors - Level 01		26	22-Oct-24	02-Dec-24			<b>T</b> 0	)2 <b>-</b> De	ec-24	, East D	undee.	Projec	t.1.7.40	.39 Inter	ors - L	evel 01		
	East Dundee.P	roject.1.7.40.39.7 Interiors - Level 01 - Retail Spa	ace (Whitebox)	28	22-Oct-24	02-Dec-24			0	02 <b>-</b> De	ec-24	, East D	undee.	Projec	t.1.7.40	39.7 Int	eriors	- Level	01 - R	≀etail
	42168	Level 01 - Retail Space (Whitebox): Layout		5	22-Oct-24	28-Oct-24			[ Lev	/el 01	1 - Re	tail Spa	oe (Whi	itebox	): Layou	t i i i				
	42155	Level 01 - Retail Space (Whitebox): CMU		5	29-Oct-24	04-Nov-24			[ Le	vel 01	1 - Re	etail Spa	ice (Wh	itebox	(): CMU					
	42156	Level 01 - Retail Space (Whitebox): MEP Over	rhead Rough	5	29-Oct-24	04-Nov-24	: :		l Le	vel 01	1 - Re	etail Spa	ice (Wh	itebox	): MEP	Overhead	Rou	gh		
	42157	Level 01 - Retail Space (Whitebox): HVAC Due	ct Rough	5	05-Nov-24	12-Nov-24			I Le	evel 0	)1 - R	etail Sp	ace (Wh	hitebo	x): HVA(	Duct R	ough			
	42158	Level 01 - Retail Space (Whitebox): MEP Ceili	ng & Wall Rough	5	13-Nov-24	19-Nov-24	1 1		I Le	evel 0	01 - R	Retail Sp	ace (W	hitebo	x): MEP	Ceiling &	Wall	Rough		
	42159	Level 01 - Retail Space (Whitebox): MEP Inspe	ections	2	20-Nov-24	21-Nov-24	1 1		Le	evel (	01 - F	Retail Sp	ace (W	/hitebo	x): MEF	Inspecti	ons			
	42163	Level 01 - Retail Space (Whitebox): Door Fram	nes	1	22-Nov-24	22-Nov-24			l Le	evel (	01 - F	Retail Sp	ace (W	/hitebo	x): Doo	Frames				
	42170	Level 01 - Retail Space (Whitebox): Doors		1	25-Nov-24	25-Nov-24			I Le	evel (	01 - F	Retail Sp	ace (W	/hitebo	ox): Doo	rs				
	42165	Level 01 - Retail Space (Whitebox): MEP Trim	Out	2	26-Nov-24	27-Nov-24			I L	evel (	01 - F	Retail S	oace (M	Vhiteb	ox): MEI	P Trim Ou	t			
	42171	Level 01 - Retail Space (Whitebox): Fire Alarm	Devices	5	25-Nov-24	02-Dec-24	: :		0 L	_evel	01 -	Retail S	pace (V	Vhiteb	ox): Fire	Alarm D	vices			
	East Dundee.P	Project.1.7.40.39.8 Interiors - Level 01 - Owner Acc	c eptance	6	22-Nov-24	02-Dec-24	: :		₩ 0	)2 <b>-</b> De	ec-24	, East D	undee.	Projec	t.1.7.40	.39.8 Int	eriors	- Level	01 - C	)wner
	02869	Level 01 - Acceptance: Interiors Punch List		5	22-Nov-24	29-Nov-24	1 1			evel	01 - 4	Accepta	nce: Int	eriors	Punch L	ist				
	02922	Level 01 - Acceptance: Owner Acceptance		1	02-Dec-24	02-Dec-24	: :		) L	_evel	01 -	Accepta	nce: Ov	wner A	cceptan	ce				
	East Dundee.P	Project.1.7.40.39.1 Interiors - Elevator Lobby L1-2		14	28-Oct-24	14-Nov-24	1 1		14	4-Nov	v-24, l	East Du	ndee P	roject	1.7.40.3	9.1 Inte	riors -	Elevato	r Lobl	by L1
	001070	Floor Sealing			28-Oct-24	29-Oct-24			1 1 1	1 1	aling									
	001072	Handrails		2	30-Oct-24	31-Oct-24				ndrail										
	001071	MEP Rough		3	01-Nov-24	05-Nov-24			0 ME	EP Ro	ough									<u> </u>
Rem	maining Level of Effo	ort Remaining Work		Page 8 of 1	10			T,	ASK filte	er: A	II Act	ivities								

East Dundee	Exhibit D Schedu	le	James McH	lugh C	onstruc	tion										
Activity ID		Activity Name		Original Duration		Finish	20: Q2		Q4 Q1	2025 Q2 Q3	3 Q4	Q1 Q2	)26 Q3 Q4	Q1	2027 Q2 (	Q3 Q4
	001074	Paint		5	06-Nov-24	12-Nov-24	-		■ Paint					1		
	001075	Signage		2	13-Nov-24	14-Nov-24			I Signag	рe						, 1 1 1 1 , 1 1 1 1 1 1 1 1 1
East D	Dundee.Project.1 M	IEP Systems		143	01-Jul-24	05-Feb-25				1 1 1 1 1	: ∃ast Dun	dee Project.	I MEP Syste	ms		
	st Dundee.Project.1.4			85	01-Jul-24	07-Nov-24						oject 1.4 Ek	1 1 1 1 1 1	1 1 1 1		1 1 1 1 1 1 1 1 1 1 1 1 1 1 1 1 1 1 1
	East Dundee.Project.	1.4.1 Electric Room		85	01-Jul-24	07-Nov-24			<b>▼</b> 07-Nov	-24, East D	undee.Pr	oject.1.4.1 I	lectric Roon			1111- . 1 1 1 1 1
	00171	Electric Room: ComEd Main Transformer Rele	ase	1	01-Jul-24	01-Jul-24		Electri	c Room: C	omEd Mair	r Transfor	mer Release				
	00193	Electric Room: Transformer Arrives on Site		10	10-Oct-24	30-Oct-24	1		Electric	Room: Tran	sformer /	Arrives on Sit	e			
	00191	Electric Room: ComEd Set Transformer and P	ull Cables	5	31-Oct-24	06-Nov-24			Electric	Room: Cor	nEd Set	Transformer	and Pull Cab	les		
	00471	Electric Room: ComEd Energize Main Vault (C	Obtain Permanent Power)	1	07-Nov-24	07-Nov-24	1: : :		I Electric	Room: Cor	nEd Ene	rgize Main V	ault (Obtain F	emane	nt Power	r)
Eas	st Dundee.Project.1.1	Mechanical Systems		10	08-Nov-24	21-Nov-24			₩ 21-No	v-24, East [	Dundee.F	roject.1.1 M	lechanical Sy	stems		
	<u> </u>	1.1.2 Mechanical Comissioning		10	08-Nov-24	21-Nov-24						Project.1.1.2			ning	. 1 1 1 1 1 1 1 1 1 1 1 1 1 1
	001069	HVAC Mechanical System Comissioning		10	08-Nov-24	21-Nov-24			1 1 1 1 1	1 1 1 1 1	1 1 1 1	Comissionin	1 1 1 1 1 1		T	
Eas	st Dundee.Project.1.6	Water Room		43	26-Nov-24	29-Jan-25			<b>7</b> 2	9-Jan-25, E	ast Dunc	lee Project 1	6 WaterRo	om:		
0	02016	Water Room: Deliver Domestic Water Pump		1	26-Nov-24	26-Nov-24	<b>-</b>		l Water	r Room: Del	ver Dom	estic Water I	Pump			1 1 1 1 1 1 1 1 1 1 1 1 1 1 1 1 1
0	02047	Water Room: Pump Room Build Out		3	27-Nov-24	02-Dec-24			. I Wate	r Rcom: Pu	mpRoor	n Build Out		1 1 1 1	1	- 1
0	02189	Water Room: Set & Pipe Domestic Water Pum	nps	3	24-Jan-25	28-Jan-25	1				1 1 1 1	tpe Domesti	: Water Pum	) )\$		1 1 1 1 1 1 1 1 1 1 1
0	02511	Water Room: Domestic Water Pump Start Up		1	29-Jan-25	29-Jan-25	1: : :		1 1 1 1 1	1 1 1 1 1		tic Water Pur	1  1  1  1  1  1			
Eas	st Dundee.Project.1.7	Fire Pump Room		8	17-Jan-25	29-Jan-25			<b>W</b> 2	9-Jan-25, E	ast Dunc	lee Project 1	7 Fire Pump	Room		
0	00192	Fire Pump Room: Deliver Fire Pump		1	17-Jan-25	17-Jan-25			l Fir	re Pump Ro	om: Deli	ver Fire Pum	p : : : : :			
0	00204	Fire Pump Room: Pump Room Build Out		3	21-Jan-25	23-Jan-25			i i i i i i i i i	re Pump Ro	om: Pur	np Room Bu	ild Out			
0	03148	Fire Pump Room: Set & Pipe Fire Pump		3	24-Jan-25	28-Jan-25	1				1 1 1 1	& Pipe Fire				
0	03206	Fire Pump Room: Fire Pump Start Up			29-Jan-25	29-Jan-25	1		1 1 1 1 1	1 1 1 5 1	1 1 1 1	Pump Start				
Eas	st Dundee.Project.1.1	<u> </u>		102	01-Jul-24	04-Dec-24			1 1 1 1 1	1 1 1 1 1	1 1 1 1	Project 1.1.8	1 1 1 1 1 1			
	East Dundee.Project.			102	01-Jul-24	04-Dec-24				1 1 1 1 1		Project 1.1.8		tor:::		1 1 1 1 1 1 1 1 1 1 1 1 1 1 1 1 1 1 1
	01454	Elevator: Drywall and Framing at Door Frames		5	01-Jul-24	08-Jul-24		] Eleva	tor Drywal	l and Framii	ng at Doo	r Frames				
	00877	Elevator: Shaft Work and Rail Install		5	08-Nov-24	15-Nov-24	- : :		. ■ Elevato	or Shaft Wo	ork and R	ail Install				
	01320	Elevator: Set Door Frames Levels		2	18-Nov-24	19-Nov-24	- : :		I Elevat	or: Set Doo	r Frames	Levels				
	01455	Elevator: Build Car			18-Nov-24	22-Nov-24				or Build Ca	1 1 1 1					
	02277	Elevator: Elevator Machine Room Build Out		5	20-Nov-24	26-Nov-24			<b>I</b> Eleva	tor. Elevato	Machine	Room Build	l Out			1 1 1 1
	03098	Elevator: Balancing, Adjustments, & Inspection	is .	5	27-Nov-24	04-Dec-24			<b>I</b> Eleva	itor: Balanci	ng, Adjus	tments, & In	spections			
Eas	st Dundee.Project.1.2	Fire Alarm Panel		25	05-Nov-24	11-Dec-24			11-D	ec-24, East	Dundee	Project.1.2	Fire Alarm Pa	nel		. 1 1 1 1
0	00180	Fire Alarm Panel: Door Install		1	05-Nov-24	05-Nov-24			l Fire Ala	m Panel: C	oor Insta	M	1 1 1 1 1 1 1 1 1 1 1 1 1 1 1 1 1 1 1		1 1 1 1	1 1 1 1
Rema	aining Level of Effort	Remaining Work		Page 9 of 1	0			TAS	SK filter: A	II Activities						
Actual	ıl Work	Critical Remaining Work		-										© Or	acle Cor	rporation

Activity	ID	Activity Name	Original Start	Finish	20	)24				2025			2	2026			2027	7
·			Duration		Q2	Q3	Q4	Q1	ı Q:	2 Q3	3 Q4	1 (	Q1 Q2	Q3	Q4	Q1	Q2	Q3
	00276	Fire Alarm Panel: Control Panel Boxes/Wiring	10 06-Nov-2	4 20-Nov-24				Fire A	Narm I	Panel:	Contro	Par	nel Boxes	/Wiring				
	02806	Fire Alarm Panel: Trim Out/Programming	5 21-Nov-2	4 27-Nov-24			0	Fire /	Alarm	Panel:	Trim O	ut/Pr	rogrammi	ng			1 1 1	1 1
	00700	Fire Alarm Panel: Elevator Control Panel	2 10-Dec-2	4 11-Dec-24				Fire	Alarm	Panel	l: Eleva	tor C	Control Pa	nel				
	East Dundee.Proj	ject.1.3 Life Safety Systems	46 29-Nov-2	4 05-Feb-25			•	-	05-Fe	b-25, E	≣ast Dι	inde	e Project	1.3 Life	Safet	y Syste	ms	
	03041	Life Safety: Fire Alarm and Panel Testing (In House)	2 29-Nov-2	4 02-Dec-24				Life	Safety	: Fire A	Nam a	nd P	anel Test	ing (In H	ouse)			
	03122	Life Safety: Elevator Recall Test (In House)	5 05-Dec-2	4 11-Dec-24				Life	Safet	y: Elev	ator Re	ecall	Test (In F	louse)				
	03207	Life Safety: Fire Pump Test (In House)	5 30-Jan-2	5 05-Feb-25				0	Life S	afety:	Fire Pu	imp∃	Test (In H	ouse)				
	East Dundee.Proje	act.1st TCO CO Inspections	56 22-Nov-2	4 13-Feb-25					13-Fe	eb-25,	East D	unde	ee Project	1st TCC	co	Inspect	ions	
	03164	CO Inspection:Test & Balance Report (Mechanical)	2 22-Nov-2	4 25-Nov-24	1 1		: I	COI	nspec	tion:Te	st & Ba	lanc	e Report	(Mechan	ical)			1 1
	03157	CO Inspection: Emergency Lighting	1 03-Dec-2	4 03-Dec-24				СО	Insped	ction: E	merge	ncy L	Lighting				1 1 1	1 1
	03205	CO Inspection: Fire Safety Systems Inspections	2 03-Dec-2	4 04-Dec-24				CO	Insped	ction: F	ire Safe	ety S	Systems Ir	spection	s			1 1
	03200	CO Inspection: Elevator Inspection	2 12-Dec-2	4 13-Dec-24				l CO	Inspe	ction: E	Elevato	r Ins	pection					
	03212	CO Inspection: MEP Inspections	2 30-Jan-2	5 31-Jan-25			7 - 7 - 7		CO In	spection	n: MEI	P Ins	spections					1 1
	03214	CO Inspection: Inspections & Approval	0	06-Feb-25				•	CO Ir	rspection	on; Ins	pecti	ions & Ap	oroval			1 1 1	1 1
	03209	CO Inspection: Fire Pump Flow Test	1 06-Feb-2	5 06-Feb-25									np Flow T					
	03215	CO Inspection	5 07-Feb-2	5 13-Feb-25				0	COI	nspecti	ion						1 1 1	1 1

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#### **Exhibit E - CLARIFICATIONS**

McHugh Construction's Design-Build Proposal for the East Dundee Parking Structure at 100 N River Street, East Dundee, IL is based upon the Request for Proposal dated June 14, 2023, McHugh's Design-Build Proposal package dated July 8, 2024, and the clarifications stated below.

#### **General Clarifications**

- 1. **Proposal** is based solely on the following documents:
  - a. Request For Proposal prepared by Village of East Dundee, dated June 14, 2023.
  - b. Geotechnical Investigation Report, prepared by Soil and Material Consultants, Inc, dated April 07, 2023.
  - c. Topographic Survey prepared by Gerald L. Heinz & Associates, Inc., dated January 20, 2023.
  - d. Addendum Memorandum prepared by Gerald L. Heinz & Associates, Inc., dated July 28, 2023.
  - e. Addendum Memorandum with Email prepared by Gerald L. Heinz & Associates, Inc., dated August 08, 2023.
  - f. Architectural & structural permit drawings prepared by Desman, dated June 10, 2024.
  - g. Civil permit drawings prepared by Pinnacle Engineering.
- 2. Proposal is based upon a **July 2024** construction start.
- 3. Proposal **does not** include sales tax.
- 4. Included an allowance for ComEd for service and relocation cost which are to be paid by owner. Owner will enter into a service engineering agreement with ComEd to perform service and relocation.
- 5. VOED is to provide internet service for the building life safety and security systems prior to building occupancy inspections.
- 6. We are relying on the owner provided Geotech report and soil borings. We have not included the cost for further Geotech services.
- 7. Environmental studies and reports are not included.
- 8. Proposal does not include an add alternate to provide photovoltaic shade structures over the rooftop parking at this time. We would expect the Village of East Dundee to enter into a service contract with an approved vendor, that vendor would provide the design, furnishing and installation as part of their agreement with the Village.
- 9. The owner must provide a plat of survey for the property.
- 10. Proposal does not include fasteners less than 1/2" in diameter in compliance with the Illinois Steel Procurement Act as manufacturers cannot meet this requirement.
- 11. We have included 5 lost weather days in our construction schedule.
- 12. Proposal does not include the following customary Owner related costs/expenses:
  - a. Special or hazardous or classified material testing, handling, disposal or remediation.
  - b. Cost to modify any systems or structures for publicly or privately-owned utilities or entities located outside of the property lines or utilities that are attached to any surrounding structures.
  - c. We have included an allowance of \$20,000 for removal of piles, asphalt, old foundations or other underground obstructions
  - d. Conditions identified in the geotech report shall not constitute a specifically identified condition at any location other than at that particular boring or location. Generalizations made about site conditions shall not constitute a specifically identified condition.
  - e. Utility relocation cost and fees as required.

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strict need-to-know basis, and shall not be disclosed to third parties without the express permission of McHugh.

- 13. Proposal recognizes that MBE/WBE/DBE Participation and Local/Preferential Hiring are to be considered. We will work in good faith to identify and engage certified DBE firms for this project.
- 14. On-site material testing, i.e. concrete, soil, deep foundation, waterproofing, etc., is to be carried by ownership.
- 15. The egress pathway from the furthest point of the top parking deck to the stairwell at the Northeast corner of the garage was confirmed to be acceptable and is included in the current design. A secondary stair and any additional means of egress from the top parking deck are not required as confirmed by the VOED.
- 16. As a Design-Build project all specifications and drawings are designed and engineered by McHugh Construction team. The project documents provided by the McHugh Construction team will be further developed to align with the final pricing.

#### **Insurance, General Contractor's Bonds & Safety**

17. Proposal does not include the requirement on page 16 of the RFP under the General Requirements-Additional Insured the Owner is requiring that VOED et al be added as an additional insureds on the Professional Liability policy. This requirement cannot be met by any RFP respondent. Professional liability policies do not add third parties as additional insureds.

#### Permits / Codes / City / Utilities

- 18. Contractor shall coordinate with Owner and utility companies and shall use its best efforts to obtain service in accordance with the project schedule requirements but shall not be responsible for delays or resulting costs incurred if the temporary or permanent utility work is not completed when required by Contractor.
- 19. Proposal does not include cut-off/relocation fees for any existing utilities (water, sewer, telephone / data or electrical etc.).
- 20. Contractor **has** included costs for temporary utility consumption costs during construction. Temporary and Permanent power service (ComEd) to be supplied by Owner. At the time of substantial completion or beneficial occupancy the utility cost will become the responsibility of the Owner.
- 21. Proposal does not include patching, relocation or restorations work for ComEd or any other public utilities companies.
- 22. Proposal does not include gas service provided to building including the commercial space.
- 23. Proposal assumes ownership has executed a temporary construction easement up to 10' along the Eastern property line of the site. A permanent easement is required at the Eastern property line for storm water management as shown on the provided easement drawing.
- 24. Proposal assumes ownership has executed a temporary construction easement along the West and South property lines of the site. This is required to allow work to take place in the walkway on the adjacent business properties.

#### LEED/Sustainability

25. Proposal does not include costs to meet sustainability requirements unless clearly specified in the documents – no requirements provided.

#### **Divisions 2, 31-33**

1. Assumes that the excavated material on site is free of contamination and will be accepted by landfills non-hazardous non-special waste. Geotechnical report did not indicate the existence of any soil requiring remediation, special disposal, or environmental fees. No contaminated soil remediation included.

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- 2. Does not include the cost to relocate any existing utilities. We will protect any existing utilities that are not in conflict with the proposed construction.
- 3. Includes excavation to design subgrade only. Proposal does not include any undercut of unsuitable soils. Any unsuitable soil would be handled as an additional cost.
- 4. Includes earth retention as required to protect adjacent properties.
- 5. Includes removal of existing trees within the 6' to 10' of the construction easement area at Eastern side of the project, per VOED direction.
- 6. Proposal anticipates that the Owner will assume all responsibility for existing hazardous materials, contaminated soils, underground storage tanks, asbestos, etc., and the associated disposal costs and documentation. The Owner will be identified as the generator of record on waste manifests if hazardous materials are encountered.
- 7. Proposal assumes existing buildings at 104 River St. and 106 River St. are on shallow foundations and do not have basements. The building at 102 River St is confirmed to have a basement as part of its foundation.
- 8. Proposal assumes existing domestic water utility is available for tap on Hill Street.
- 9. Proposal assumes existing storm water line is available for tap on Hill Street.
- 10. Includes new concrete sidewalk with tactile tiles, as required, at the new Jackson St. driveway apron and the Hill St. Driveway apron.
- 11. Includes re-grading existing stone South of the parking garage at the walkway between the existing dentist office building and the parking garage.
- 12. Includes a properly graded stone walkway West of the surface parking lot next to the existing buildings.
- 13. Proposal does not include a storm drainage system outside of the project site.
- 14. Mill & repave with 2" asphalt is included for half of the width of Hill Street the full length of the parking garage building, and half of the width of Jackson Street at curb and gutter reconstruction locations.
- 15. A drain-tile system is not included.
- 16. Landscaping restoration includes graded topsoil and seeding all areas only. No plantings are being provided for the project.
- 17. A portion of the building footings will encroach under the sidewalk on both Hill and River Streets.
- 18. Proposal includes an Earth Retention System assumed to be soldier beams and lagging. Final design will require VOED Geotechnical Engineer approval.
- 19. Proposal includes (3) helical piles as required to mitigate uplift forces for the building foundation design. Final design will require VOED Geotechnical Engineer approval.

#### **Division 3**

- 1. Owner acknowledges that exposed concrete elements of the project will exhibit normal cracking and that despite architectural details that include various measures to prevent water migration into the building, water may nevertheless migrate into the building and that Contractor is not responsible for water migration through these concrete cracks unless the cracks and water migration were caused solely by Contractor's deficient construction.
- 2. Anticipates standard grey cement for all concrete.
- 3. Split slab over retail space is not included.
- 4. Cast in place concrete floor slab in retail/commercial spaces are not included. Proposal includes compacted aggregate fill at these locations for future buildout.
- 5. Macro Fiber reinforcing per spec 03 30 00 is included in garage slab on grade.
- 6. We are providing concrete mix designs with slag in lieu of corrosion inhibitor, as approved by the structural engineer.

strict need-to-know basis, and shall not be disclosed to third parties without the express permission of McHugh.

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- 7. Epoxy rebar is included for deck slab top bars, top beam bars, stirrups in elevated parking slabs, rebar in upturned beams, rebar in crash walls, rebar in slab on grade, and noted as epoxy in retaining wall schedule.
- 8. For exposed concrete we will provide the following finishes: Class 'A' at architecturally exposed concrete where appearance is of special importance as noted on Contract Documents. Class 'B' at exposed ceilings/slab soffits and columns/walls. Class 'C' at unexposed ceilings. Class 'C' at all back of house areas including egress stairwells. Exposed concrete may require grinding, etc. Exposed concrete soffits will exhibit significant variation of colors, finishes, textures and/or wood grain. Layout markings for all trades will be plainly visible. Remedial measures of exposed concrete are excluded except as required to meet ACI tolerance. Repairs/patching, if required, will be visible and will not match surrounding concrete elements.

#### **Division 4**

- 1. Included CMU (painted) inside of the elevator vestibule.
- 2. The Illini brick specified does not come in utility for the quantity that is required for the job. We have figured the Illini in modular while the Adrian brick is figured as utility size.
- 3. Bond beams were figured above the masonry openings in lieu of steel lintels.

#### **Division 5**

- 1. Included stairs 1 & 2 as cast-in-place concrete with steel/aluminum 1-1/4" pipe guardrails with ½" vertical picket rails.
- 2. All railings to be painted.
- 3. Included typical elevator misc. metals including pit ladders and sump pit cover gratings. We have included a W8x24 hoist beam.

#### **Division 6**

- Included (3) layers of 2 x 6 roof blocking at the perimeter of the East and West stair tower roofs behind masonry parapet walls.
- 2. Included fire treated plywood from 2'-0" to 6'-0" above finish floor on the South wall of electrical rm. 104 for the mounting of panels.

#### **Division 7**

- 1. Retail/commercial space walls do not include cavity insulation.
- 2. Retail/commercial space ceiling is being provided uninsulated. Insulation assumed to be provided by the tenant after future buildout.
- 3. Elevator pit slab waterproofing included for complete "bathtub" waterproof system at elevator pit.
- 4. Traffic coating included as MasterSeal 2500 vehicular grade traffic coating.
- 5. Proposal includes the perforated garage screens at the parking garage with aluminum tube frames (painted to match storefront) and perforated metal mesh screens attached to the inside of the aluminum tube framing. We have excluded custom print designs or cutouts. Perforated metal mesh to be constructed out of 1/8" aluminum with a standard dot pattern (1/4" holes on 3/8" staggered centers) with a painted finish. Aluminum mesh to be by McNichols or equal.

#### **Division 8**

- Included all storefront / punched openings as 2"x4-1/2" framed storefront with a 2-coat painted finish by Pitco Architectural Metals.
- 2. Storefront transom areas have been included with narrow spacing with applied vertical muntin's.
- 3. Included 1" insulated clear low-e glazing with tempered glass at the commercial space.

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- 4. Included ½" clear tempered glass at the Northwest stair tower.
- 5. Included as medium stile non-thermal doors with the following hardware: ABH continuous hinges, LCN surface mount closers, sweeps and thresholds. Doors 101 and 102 have Schlage passage set. Door 102 has a Von Duprin 9947L panic device and core by Pittco with construction cylinder
- 6. Excluded automatic operators. We have assumed ADA parking will be located at the first floor and auto operators are not required.
- 7. Excluded low-iron glazing.
- 8. Excluded "bird friendly" glass films or coatings.
- 9. Excluded all potential mock-up costs.
- 10. Mortise locks will be provided in lieu of electronic locks with hardware set #3 as this is not needed with an electric strike.
- 11. Building awnings to be provided as a solid single color to be selected from the manufacturers standard color range.

#### **Division 9**

- 1. Includes the North building elevation to be painted concrete only. All other exterior elevations of concrete and CMU are to be exposed.
- 2. Interior retail spaces are considered to be gray boxes, with no finishes.
- 3. Painting of interior garage walls and ceiling is not included.
- 4. Painting of interior CMU at the elevator tower interior is included.

#### **Division 11**

- 1. Parking control systems are not included.
- 2. Proposal does not include conduit or wire for future parking control system.
- 3. Proposal does not include tie-offs or davits at the roof areas.

#### **Division 14**

- 1. Proposal does not include elevator materials in compliance with Illinois Steel Procurement Act as the elevator manufacturers cannot meet this requirement.
- 2. Proposal includes an Otis Hydrofit machine-roomless and holeless hydraulic elevator with a stop on Level 1 and Level 2.
- 3. Proposal includes brushed stainless steel walls, handrails, and door finishes. The ceiling finish is white plastic laminate with (4) lights.
- 4. Elevator installation cannot begin until permanent power has been provided to the building from ComEd.
- 5. Elevator includes a battery powered lowering device.

#### **MEP/FP General**

1. Proposal anticipates that the MEP/FP trades will be design-build, and the MEPFP subcontractors will provide Permit Drawings. The Design-Build subcontractors will be the Engineers of Record.

#### **Divisions 15, 21, 22, and 23**

#### Fire Protection

- 1. Proposal is based on a design-build fire protection system with entire building to be provided with sprinkler protection.
- 2. Proposal includes a Dry Pipe Type System with (2) Automatic Dry Standpipes.
- 3. Proposal does not include fire pump. Assumes city water pressure is suitable for sprinkler system design.

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#### **Plumbing**

- 1. Proposal includes a Triple Oil Basin.
- 2. Proposal includes an Elevator Pit Sump Pump.
- 3. Proposal includes one hose bib at the North exterior elevation and one hose bib at the West exterior elevation. Includes (3) hose bibs at the interior of the garage.
- 4. Included stubbing in a 2" water line and a 4" sanitary sewer line into the commercial space for future buildout.

#### **HVAC**

- 1. Radon mitigation system is not included.
- 2. No black iron duct provided for future retails spaces.
- 3. Included electric heaters for space (electric room) heating requirements.
  - a. (3) 10 KW electrical heaters are being provided in the commercial space as temporary heating until the space is built out.
  - b. (1) electric baseboard heater at each elevator vestibule.
  - c. (1) electric heater at the Water Room.

#### **Divisions 16, 26, 27, and 28**

#### Electrical

- 1. Proposal includes ceiling mounted garage high bay LED fixtures with occupancy sensors, lighting at stairwells, back of house lighting, Exterior Decorative Type lighting, Pole Mounted lighting with single and double heads with nuisance light limiting hoods, and Battery Pack Exit Signs.
- 2. Proposal includes one empty 4" PVC conduit from the telecom pole at the North East corner of the project site to the Electrical Room for Low Voltage service.
- 3. Proposal includes a code compliant Fire Alarm system in full conduit.
- 4. Proposal includes conduit and power provisions to two (2) 1<sup>st</sup> floor EV car charger locations. Furnish and installation of the electric vehicle chargers are not provided as part of this proposal.
- 5. Proposal does not include a backup generator.
- 6. Included a security camera system per the Current proposal provided by VOED.
- 7. Included access control for the Elevator Maintenance Room, Water Room, and Electrical Room per the Current proposal provided by VOED.
  - a. This includes the door position switches (door contacts), card readers, and power supplies, etc. per ownerships coordination with Current.
- 8. Included three (3) 200 Amps electrical panels and separate meters for the future buildout of commercial spaces.

#### SECTION 00 01 10 - TABLE OF CONTENTS

#### PART 1 - GENERAL

#### 1.1 SUMMARY

A. This Section includes the Table of Contents for the Project Manual.

#### 1.2 TECHNICAL SPECIFICATIONS (VOLUME 1 OF 1): Divisions 00-14

DIVISION 00 – PROJECT BIDDING REQUIREMENTS	Revisions
Section 00 01 10 - Table of Contents	05/30/2024
Section 00 01 15 - List of Drawing Sheets	
Section 00 85 00 - Electronic Files and Cad Release Form	05/30/2024
<u>DIVISION 1 - GENERAL REQUIREMENTS</u>	Revisions
Section 01 33 00 - Submittal Procedures	05/30/2024
Section 01 40 00 - Quality Requirements	
Section 01 42 00 - References	05/30/2024
Section 01 45 00 - Quality Control	
Section 01 73 29 - Cutting and Patching	05/30/2024
<u>DIVISION 2 – EXISTING CONDITIONS</u> (NOT USED)	<u>Date</u>
DIVISION 3 - CONCRETE	<u>Date</u>
Section 03 10 00 - Concrete Forming and Accessories	05/30/2024
Section 03 20 00 - Concrete Reinforcing	05/30/2024
Section 03 30 00 - Cast-in-Place Concrete	
Section 03 38 16 - Unbonded Mono-Strand Post-Tensioned Concrete	05/30/2024
DIVISION 4 - MASONRY	<u>Date</u>
Section 04 20 00 - Unit Masonry	05/30/2024
<u>DIVISION 5 - METALS</u>	<u>Date</u>
Section 05 05 15 - Hot Dip Galvanizing	05/30/2024
Section 05 05 19 - Post-Installed Anchors in Concrete and Masonry	05/30/2024
Section 05 12 00 - Structural Steel	05/30/2024
Section 05 40 00 - Cold-Formed Metal Framing	05/30/2024
Section 05 50 00 - Metal Fabrications	
Section 05 70 16 - Decorative Metal Screen System	
Section 05 75 00 - Decorative Formed Metal	05/30/2024
<u>DIVISION 6 – WOOD, PLASTICS, AND COMPOSITES</u>	<u>Date</u>
Section 06 10 00 - Rough Carpentry	05/30/2024
Section 06 16 43 - Gypsum Sheathing	05/30/2024

#### **Exhibit F - Specifications**

DIVISION 7 - THERMAL AND MOISTURE PROTECTION	<u>Date</u>
Section 07 11 13 - Bituminous Dampproofing	05/30/2024
Section 07 13 26 - Self-Adhering Sheet Waterproofing	
Section 07 18 00 - Traffic Coating Systems	05/30/2024
Section 07 19 11 - Clear Penetrating Concrete Sealers	05/30/2024
Section 07 27 26 - Fluid-Applied Membrane Air Barriers	05/30/2024
Section 07 53 23 - Ethylene-Propylene-Diene-Monomer (EPDM) Roofing System	
Section 07 62 00 - Flashing and Sheet Metal	05/30/2024
Section 07 65 00 - Flexible Flashing	05/30/2024
Section 07 84 00 - Firestopping	
Section 07 92 00 - Joint Sealants	
Section 07 95 00 - Expansion Control	05/30/2024
<u>DIVISION 8 - OPENINGS</u>	<u>Date</u>
Section 08 11 13 - Hollow Metal Doors and Frames	05/30/2024
Section 08 41 13 - Glazed Aluminum Assemblies	05/30/2024
Section 08 71 00 - Door Hardware	05/30/2024
Section 08 80 00 - Glazing	05/30/2024
<u>DIVISION 9 - FINISHES</u>	<u>Date</u>
Section 09 91 00 - Painting	05/30/2024
, and the second se	
<u>DIVISION 10 - SPECIALTIES</u>	<u>Date</u>
Section 10 14 00 - Signage	05/30/2024
Section 10 44 13 - Fire Extinguishers and Cabinets	
Section 10 73 13 - Awnings	05/30/2024
<u>DIVISION 11 - EQUIPMENT</u> (NOT USED)	<u>Date</u>
<u>DIVISION 12 – FURNISHINGS</u> (NOT USED)	<u>Date</u>
DIVISION 12 CRECIAL CONSTRUCTION (NOT LISED)	Data
<u>DIVISION 13 – SPECIAL CONSTRUCTION</u> (NOT USED)	<u>Date</u>
DIVISION 14 - CONVEYING EQUIPMENT	<u>Date</u>
Section 14 20 00 - Elevators	05/30/2024

SEE DRAWINGS FOR SECTIONS 15 THRU 33

PART 2 - PRODUCTS (Not Applicable)

PART 3 - EXECUTION (Not Applicable)

END OF SECTION 00 01 10

#### SECTION 00 01 15 - LIST OF DRAWING SHEETS

<u>Drawing</u> <u>Number</u>	<u>Title</u>	
	GENERAL SHEETS	<u>Date</u>
G000 G001 G002 G003 G004 G005	Cover Sheet	06/10/2024 06/10/2024 06/10/2024 06/10/2024
	CIVIL SHEETS	<u>Date</u>
C-1 C-2 C-3 C-4 C-5 C-6 C-7 C-8 C-9 C-10 C-11	Cover Sheet	05/28/2024 05/28/2024 05/28/2024 05/28/2024 05/28/2024 05/28/2024 05/28/2024 05/28/2024 05/28/2024
	ARCHITECTURAL SHEETS	<u>Date</u>
A001 A101 A102 A103 A201 A202 A301 A411 A412 A420 A421 A431 A501 A502 A503	Site Plan Level 1 Plan Level 2 Plan East and North Building Elevations. West and South Building Elevations Building Sections West Stair Plans and Elevations West Stair Sections East Stair Sections East Stair Sections Enlarged Plan -Level 1 Ramp Wall Sections Wall Sections Wall Sections	06/10/2024 06/10/2024 06/10/2024 06/10/2024 06/10/2024 06/10/2024 06/10/2024 06/10/2024 06/10/2024 06/10/2024 06/10/2024 06/10/2024 06/10/2024 06/10/2024
A504 A601	Wall Sections  Door Schedules and Details	

#### **Exhibit G - Drawings**

A611	Storefront Details	06/10/2024
A621	Typical Stair and Railing Details Side Mount	• •
A701	Typical Details	
A702	Miscellaneous Thermal & Moisture Protection Details	
A722	Typical Masonry Details	• •
A723	Masonry Plan Details	
A901	Renderings	
A902	Renderings	
7.502	16116611165	00, 10, 202 1
	STRUCTURAL SHEETS	<u>Date</u>
S001	Design Criteria and General Notes	06/10/2024
S001	General Notes	
S002 S003	General Notes	• •
S003	Typical Slab on Grade Details	• •
	**	
S005	Foundation Details	• •
S006	Typical Foundation Details	• •
S007	General Typical Details	
S008	Typical Masonry Details	
S101	Foundation and Grade Level Plan	• •
S102	Sections and Details	
S201	Level 2 Framing Plan	
S202	Level 3 Framing Plan	
S211	Skeletal Elevations	
S212	Skeletal Elevations	• •
S301	Post-Tensioning Framing Details	
S302	Post-Tensioning Framing Details	
S303	Post-Tensioning Framing Details	
S311	Post-Tensioned Beam Schedule	• •
S401	Sections and Details	
S501	Concrete Column Details	• •
S502	Garage Column Schedule	
S601	Enlarged Stair Framing Plan	
S602	Enlarged Stair Sections	06/10/2024
S603	Foundation Section and Details	06/10/2024
S611	Stair Details	• •
S621	Conventionally Reinforced Concrete Beams and Details	06/10/2024
	ELECTRICAL SHEETS	<u>Date</u>
E101	Level 1 Floor Plan - Lighting & Power	
E102	Level 2 & 3 Floor Plans - Lighting and Power	
E200	Symbol List, Schedules, Details and Notes	
E300	Panel Schedules and Service Riser Diagram	06/12/2024

#### **Exhibit G - Drawings**

	MECHANICAL SHEETS	Date
M101 M102	Level 1 Mechanical PlanLevel 2 and Roof Mechanical Plan	· ·
M601	Mechanical Schedules	• •
	PLUMBING SHEETS	<u>Date</u>
P0.00	Plumbing Symbols, Abbreviations, and Materials	06/11/2024
P0.01	Plumbing Waste, Vent, and Water Schematics	06/11/2024
P100	Underground Plumbing Plan	06/10/2024
P101	1 <sup>st</sup> Floor Plumbing Plan	06/10/2024
P102	2 <sup>nd</sup> Floor Plumbing Plan	06/10/2024

END OF SECTION 00 01 15

# DOWNTOWN E. DUNDEE PARKING STRUCTURE

# 304 HILL STREET, EAST DUNDEE, IL 60118


# **Contact Information**

# Owner

Village of East Dundee 120 Barrington Avenue East Dundee IL 60118 847.426.2822


# Design Builder

McHugh Construction 1737 S Michigan Avemue Chicago IL 60616 312.986.8000

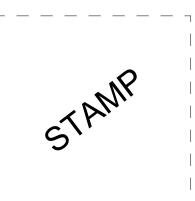

# **Architect & Structural Engineer of Record**

DESMAN, Inc. 20 N Clark Street Suite 300 Chicago IL 60602 312.263.8400

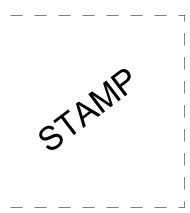

STAMP

# Mechanical, Electrical, & Plumbing Engineer



Pinnacle Engineering Group 1051 E Main Street East Dundee IL 60118 847.551.5300


# **Project Location**



Perspective View from the Intersection of River Street and Hill Street



**Project Location Plan** 

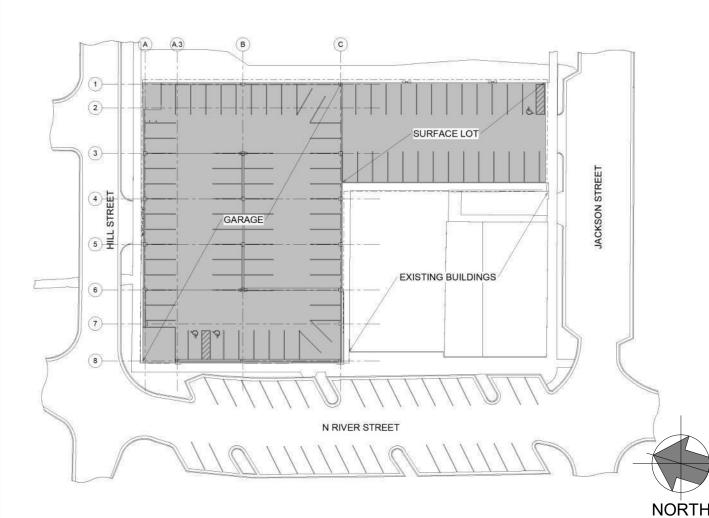

**Project Key Plan** 

# **Sheet Index**

### **GENERAL SHEETS**

GENERAL NOTES, ABBREVIATIONS, & SYMBOLS

### CIVIL SHEETS

# ARCHITECTURAL SHEETS

LEVEL 2 PLAN

**EAST & NORTH BUILDING ELEVATIONS** WEST & SOUTH BUILDING ELEVATIONS **BUILDING SECTIONS** 

WEST STAIR PLANS & ELEVATIONS WEST STAIR SECTIONS **EAST STAIR PLANS & ELEVATIONS** 

EAST STAIR SECTIONS **ENLARGED PLAN-LEVEL 1 RAMP** WALL SECTIONS WALL SECTIONS

WALL SECTIONS WALL SECTIONS DOOR SCHEDULES AND DETAILS

STOREFRONT DETAILS

TYPICAL DETAILS MISCELLANEOUS THERMAL & MOISTURE PROTECTION DETAIL

# TYPICAL MASONRY DETAILS

### PLUMBING SHEETS

**ISSUED FOR PERMIT 06-10-24** 

FIRE PROTECTION SHEETS

MECHANICAL SHEETS

**ELECTRICAL SHEETS** 

### STRUCTURAL SHEETS

DESIGN CRITERIA AND GENERAL NOTES TYPICAL SLAB ON GRADE DETAILS FOUNDATION DETAILS TYPICAL FOUNDATION DETAILS GENERAL TYPICAL DETAILS TYPICAL MASONRY DETAILS FOUNDATION AND GRADE LEVEL PLAN SECTIONS AND DETAILS **LEVEL 2 FRAMING PLAN** LEVEL 3 FRAMING PLAN SKELETAL ELEVATIONS POST-TENSIONING FRAMING DETAILS POST-TENSIONING FRAMING DETAILS POST-TENSIONING FRAMING DETAILS POST-TENSIONED BEAM SCHEDULE SECTIONS AND DETAILS CONCRETE COLUMN DETAILS **ENLARGED STAIR FRAMING PLANS** FOUNDATION SECTIONS AND DETAILS STAIR DETAILS

CONVENTIONALLY REINFORCED CONCRETE

BEAMS & DETAILS

# **GENERAL NOTES**

1. THESE NOTES APPLY TO ALL SHEETS OF THESE CONTRACT DOCUMENTS

2. CODES: THIS PROJECT SHALL FULLY COMPLY WITH ALL ADA/ADDAG REQUIREMENTS. USE OF REFERENCE CODES: WHERE THE SPECIFIC DATE OR ISSUE OF A CODE IS NOT INCLUDED WITH THE REFERENCE, THE LATEST EDITION AND AMENDMENTS ADOPTED. PUBLISHED AND AVAILABLE TO THE PUBLIC UPON THE SUBMISSION OF DOCUMENTS FOR BUILDING PERMIT SHALL APPLY, EXCEPT WHERE OTHERWISE REQUIRED BY THE BUILDING CODE. WHERE THE LATEST EDITION OF A REFERENCE CODE HAS NOT BEEN INCORPORATED INTO THE BUILDING CODE, THE ISSUE REFERENCED IN THE BUILDING CODE SHALL GOVERN, UNLESS THE CURRENT ISSUE OF THE REFERENCE CODE IS ACCEPTABLE TO THE GOVERNING AUTHORITY. SEE APPLICABLE CODE NOTES THIS SHEET FOR ADDITIONAL CODE INFORMATION.

- 3. CONTRACTOR SHALL BE RESPONSIBLE FOR VERIFYING ALL DIMENSIONS, ELEVATIONS AND EXISTING CONDITIONS AT THE SITE BEFORE CONSTRUCTION IS STARTED.
- 4. DO NOT SCALE DRAWINGS.
- 5. ALL BUILDING DIMENSIONS INDICATED ARE TO COLUMN CENTER LINE, TO FACE OF CONCRETE OR TO FACE OF MASONRY, UNLESS OTHERWISE NOTED.
- 6. GRADE AND FLOOR ELEVATIONS ARE INDICATED ON THE ARCHITECTURAL PLANS. ELEVATIONS ARE GIVEN TO THEORETICAL TOP OF ARCHITECTURAL MATERIAL, GRADE SLAB OR STRUCTURAL CONCRETE SLAB ELEVATION AT GRIDLINE INTERSECTION OR POINT SHOWN AND IS EXCLUSIVE OF ANY CURBS, FLOWLINES OR CANTS. ELEVATIONS NOT SHOWN ARE STRAIGHT LINE INTERPOLATIONS BETWEEN POINTS SHOWN. SEE SHEET CIVII DRAWINGS FOR DATUM INFORMATION.
- 7. MINIMUM VERTICAL CLEARANCE SHALL BE 8'-2". CONTRACTOR SHALL BE RESPONSIBLE FOR VERIFYING MINIMAL VERTICAL CLEARANCE PRIOR TO AND AFTER CONSTRUCTION.
- 8. UPON COMMENCEMENT OF THE WORK, CONTRACTOR SHALL INSTALL SURVEY MARKERS ON ALL CORNERS OF THE LEGALLY DESCRIBED PROPERTY FOR INSPECTION BY THE CITY OF EAST DUNDEE, ILLINOIS.
- 9. CONTRACTOR IS RESPONSIBLE FOR ALL REPAIRS IN THE PUBLIC WAY NECESSITATED BY THE WORK AND FOR DAMAGE TO ON-SITE OR ADJACENT PROPERTIES CAUSED BY THE CONTRACTOR DURING THE PERFORMANCE OF THE WORK.
- 10. ALL EXTERIOR STREET AND SIDEWALK PAVING SHALL CONFORM TO ALL STANDARDS AND REQUIREMENTS OF THE VILLAGE OF EAST DUNDEE AND STATE OF ILLINOIS.
- 11. SIZES GIVEN ON DOOR SCHEDULE ARE DOOR DIMENSIONS: ALLOWANCES FOR THRESHOLDS, ETC. SHALL BE ADDED TO DOOR SIZE. REINFORCE ALL DOORS AND FRAMES FOR SCHEDULED HARDWARE, SEE SPECIFICATIONS.
- 12. ALL EXIT DOORS SHALL BE OPERABLE FROM THE INSIDE WITHOUT THE USE OF A KEY OR ANY SPECIAL KNOWLEDGE.
- 13. ALL CONTRACTORS SHALL COORDINATE ALL UTILITIES, PIPE SLEEVES, STUB-UPS AND ALL WALL & FOOTING PENETRATIONS WITH THE STRUCTURAL, CIVIL, MECHANICAL AND ELECTRICAL DRAWINGS.
- 14. INFORMATION REGARDING EXISTING SITE CONDITIONS WAS OBTAINED FROM A SURVEY DATED JANUARY 9, 2023 PREPARED UNDER SEPARATE CONTRACT BY:

NAME: GERALD L. HEINZ & ASSOCIATES, INC. STREET: 206 N RIVER STREET CITY: EAST DUNDEE, ILLINOIS 60118 PHONE: 847-426-4535

- 15. THE OWNER, ARCHITECT, ENGINEER, CONSULTANTS TO THE ARCHITECT, OR CONSULTANTS TO THE ENGINEER ARE NOT RESPONSIBLE FOR THE ACCURACY OR COMPLETENESS OF THE SURVEY INFORMATION.
- 16. INFORMATION REGARDING EXISTING SUBSURFACE CONDITIONS WAS OBTAINED FROM A GEOTECHNICAL REPORT DATED APRIL 7, 2023 AND ADDENDUM LETTER DATED APRIL 4, 2024 PREPARED UNDER SEPARATE CONTRACT BY:

NAME: SOIL AND MATERIAL CONSULTANTS, INC. STREET: 8 W COLLEGE DR SUITE C CITY: ARLINGTON HEIGHTS, IL 60004

PHONE: 847-870-0544

17. THE OWNER, ARCHITECT, ENGINEER, CONSULTANTS TO THE ARCHITECT, OR CONSULTANTS TO THE ENGINEER ARE NOT RESPONSIBLE FOR THE ACCURACY OR COMPLETENESS OF THE GEOTECHNICAL REPORT.

## **ABBREVIATIONS**

ACT

ADD

ADJ

AFF

**AGGR** 

AISC

ALT

ANOD

APPD

AVE

BD

BLK

BM

BRG

BS

CB

BSMT

BTWN

COND

CAB

CEM

CER

CIP

CLG

CLOS

CMU

CO

COL

CONC

CONN

CONST

CONT

CONTR

CORR

CRS

CSK

CW

DBL

DEPT

DIM

DWG

**DWLS** 

**ELEV** 

EQ

**EMERG** 

EQUIP

EWH EXH

**EXIST** 

EXP

FDN

FHC

FIN

FL FLR

FOOTING

**FURRING** 

**FUTURE** 

**GUTTER** 

GAUGE

GENERAL

GRADE

GYPSUM

HEADER

HOOK

HARDWARE

HORIZONTAL

HIGH POINT

HIGHWAY

INCH

JOIST

JOINT

**INSIDE DIAMETER** INVERT ELEVATION

INFORMATION INSULATION INTERIOR INVERT

GYPSUM BOARD

HANDICAPPED

**HOLLOW METAL** 

HIGH PRESSURE SODIUM

HEATING VENTILATING AND AIR CONDITIONING

GALVANIZED

GRADE BEAM

GENERAL CONTRACTOR

**GALLONS PER MINUTE** 

FEET

FLOUR

FSP

FTG

FT (')

FURR

FUT

GALV

GEN

GPM GRD

GYP

HDR

HDW

IN (")

GYP BD

GB

APPROX

AD

AMERICAN CONCRETE INSTITUTE ACOUSTICAL TILES AREA DRAINS AMERICANS WITH DISABILITIES ADA ACCESSIBILITIES GUIDELINES **ADDITIONAL** ADJACENT ABOVE FINISH FLOOR AGGREGATE AIR CONDITION AMERICAN INSTITUTE OF STEEL CONSTRUCTION AL ALUM ALUMINUM ALTERNATE ANODIZED APPROVED APPROXIMATE ARCHITECTURAL AMERICAN SOCIETY FOR TESTING MATERIALS **AVENUE BOTTOM OF BOTTOM OF CURBS** BOARD **BITUMINOUS** BIT PAV'T BITUMINOUS PAVMENT BUILDING BLOCK BEAM BOT BOTTOM **BEARING BOTH SIDES** BASEMENT BETWEEN CATCH BASIN CONDUIT CABINET CEMENT CERAMIC CAST IRON CAST IN PLACE CONTROL JOINT CIRCUIT CENTER LINE CEILING CLOSET CONCRETE MASONRY UNITS COMPANY COLUMN CONCRETE CONNECTION CONSTRUCTION CONTINUOUS CONTRACTOR CORRIDOR CARPET COURSE COUNTERSINK COLD WATER DOUBLE DECK DRAIN DEPARTMENT DIAMETER **DIMENSION** DEAD LOAD DOWN DITTO DOWN SPOUT DETAIL DRAWING DOWELS EACH **EACH FACE ELEVATION** ELECTRICAL **ELEVATOR EMERGENCY** EQUAL **EQUIPMENT EQUIVALENT** EACH WAY ELECTRIC WALL HEATER **EXHAUST EXISTING EXPANSION EXPANSION JOINT** EXTERIOR FLOOR DRAIN FOUNDATION FIRE EXTINGUISHER FIRE EXTINGUISHER CABINET FIRE HOSE CABINET FINISHED FLOOR FLUORESCENT FIRE STAND PIPE

#### MATERIAL SYMBOLS ABBREVIATIONS CONT.

**KIPS** 

KO

KSI

KW

LAV

MAX

MECH

**MEZZ** 

MHA

MIN

MISC

MO

MTD

MTG

NIC

NO (#)

NOM

NTS

OPP

**PLWD** 

PNL

PPT

PΤ

PJF

RB

RECEP1

REINF

RET

RM

RO

ROW

SCH

SF

SHT

SIM

SK

SQ

SS

ST

STD

STL ST

STRUCT

STOR

T & B

T/BM

TEL

TEM

**TEMP** 

TO T/

TOIL

T/PC

TYP

UNO

WD

W/O

WP

WWF

TH THK

KNOCKED

KILOWATT

LEADER

LEFT HAND

LIVE LOAD

LIGHT POLE

LOW POINT

LIGHTING

MAXIMUM

MEDIUM

**MECHANICAL** 

**MEZZANINE** 

MANHOLE

MINIMUM

MOUNTED

MOUNTING

NUMBER

NOMINAL

NOT TO SCALE

ON CENTER

OD DIA (Ø) OUTSIDE DIAMETER

OFFICE

PLATE

PANEL

PLYWOOD

PARAPET

PAINTED

**RADIUS** 

RISERS

**ROOF BEAM** 

**ROOF DRAIN** 

RECEPTACLE

REQUIRED

RETAINING

RIGHT HAND

**ROUGH OPENING** 

RIGHT OF WAY

SQUARE FEET

**SPECIFICATION** 

STAINLESS STEEL

SCHEDULE

SECTION

SHEET

SIMILAR

SKETCH

SLAB

SINGLE

SQUARE

STANDARD

STORAGE

TREADS

STRUCTURAL

TOP AND BOTTOM

TOP OF BEAM

TOP OF CURB

TELEPHONE

TEMPERED

THICK

TOP OF

TOILET

TYPICAL

VOLTS

WOOD

WITHOUT

TOS T/SL TOP OF SLAB

TOS T/S TOP OF STEEL

TOW T/W TOP OF WALL

TEMPERATURE

TOP OF PILE CAP

WATER CLOSET

WEATHERPROOF

WELDED WIRE FABRIC

WELDED WIRE MESH

UNDERWRITERS LABORATORIES

UNLESS OTHERWISE NOTED

UNLESS NOTED OTHERWISE

STEEL

ROOM

REINFORCING

PARTITION

OPENING

OPPOSITE

OPPOSITE HAND

PANIC HARDWARE

POUNDS PER SQUARE INCH

PREMOLDED JOINT FILLER

PROPERTY LINE

POST-TENSIONED

PASSENGER

**MANUFACTURER** 

MISCELLANEOUS

MASONRY OPENING

NOT IN CONTRACT

NATIONAL ELECTRICAL CODE

METAL HALIDE

LIGHT

LAMINATED

LAVORATORY

KNOCKOUT

KIPS PER SQUARE FOOT

KIPS PER SQUARE INCH

MATERIALS IN SECTION:

**COMPACTED EARTH** 

# # # # # # # # # # # # # # # # # # # #

PAVEMENT

PRECAST CONCRETE

**CONCRETE MASONRY UNITS** 

CAST-IN-PLACE CONCRETE (U.N.O.)

**PLYWOOD** 

WOOD/ ROUGH BLOCKING

COMPACTED GRANULAR FILL

**BATT INSULATION** 

RIGID INSULATION

PRECAST PANEL

**CONCRETE MASONRY UNIT** 


MATERIALS IN ELEVATION

CONCRETE


**BRICK** 

GLASS

# REFERENCE SYMBOLS

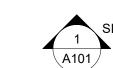


**BUILDING ELEVATION REFERENCE** 

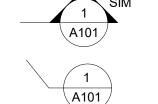

DETAIL REFERENCE

SECTION REFERENCE

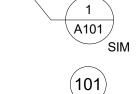

DOOR NUMBER

REVISION


KEY NOTE - OR WINDOW NUMBER



101

**ROOM NAME ROOM NUMBER** 

**COLUMN GRID** 

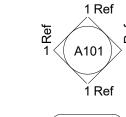

**INTERIOR ELEVATION** 

FLOOR ELEVATION



(IN FEET ABOVE DATUM) EXISTING GRADE ELEVATION TO REMAIN

(IN FEET ABOVE DATUM)



SIGN AND MOUNTING

MATCH LINE




(ADA COMPLIANT)

INTERNATIONAL ACCESSIBILITY SYMBOL



WORK OR CONTROL POINT




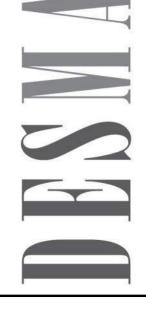







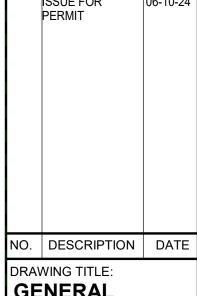

**GENERAL** NOTES, ABBREVIATIONS, & SYMBOLS

DRAWING NO:

SCALE: 12" = 1'-0" PERMIT 06-10-, PROJECT NO: 50-24102

esigner Author

EX nibitie GDE: 2006 INTERNATIONAL BUILDING CODE (IBC)

a. MOTOR-VEHICLE-RELATED OCCUPANCY: OPEN PARKING GARAGE (IBC 406.2. 406.3).

B. MIXED USE AND OCCUPANCY, SEPARATED (IBC 508.3) ACTUAL USE GROUPS TO BE

a. ASSEMBLY (FOOD/DRINK): USE GROUP A-2 (IBC 303)

b. BUSINESS: USE GROUP B (IBC 304)

c. MERCANTILE: USE GROUP M (IBC 309)

C. REQUIRED SEPARATIONS OF OCCUPANCIES (IBC 508.3, T.508.3.3) a. ONE HOUR SEPARATION REQUIRED FROM S-2 TO B AND/OR M OCCUPANCIES.

3. CONSTRUCTION TYPE: TYPE II-B NONCOMBUSTIBLE (IBC 602.2)

. BUILDING HEIGHT AND AREA LIMITATIONS

A. MAX. ALLOWABLE BUILDING HEIGHT: 55 FT (IBC T.503) B. MAX. BUILDING STORIES/AREAS

a. STORAGE GROUP (S-2): 4 STORIES/MAX. AREA 26,000 SF PER STORY (IBC T.503). ALLOWABLE INCREASES: SEE IBC 504 b. OPEN PARKING GARAGE (S-2): TWELVE TIERS/UNLIMITED AREA (IBC T.406.3.5).

5. FIRE RESISTANCE RATED CONSTRUCTION AND PROTECTION REQUIREMENTS A. MINIMUM RATINGS FOR TYPE II-B CONSTRUCTION

a. BUILDING STRUCTURE (IBC 603, TABLE 601)

ALLOWABLE INCREASES: SEE IBC 406.3.6

BUILDING ELEMENT .STRUCTURAL FRAME (COLUMNS & GIRDERS) .INTERIOR BEARING WALLS

.FLOOR CONSTRUCTION (SLAB & BEAMS) .ROOF CONSTRUCTION (SLAB & BEAMS)

EXTERIOR BEARING WALLS

a. NON-BEARING WALLS (IBC 603, TABLE 602, S-2 OCCUPANCY) BUILDING ELEMENT

..INTERIOR NON-BEARING WALLS ..EXTERIOR NON-BEARING WALLS

FIRE SEPARATION DISTANCE 10 OR GREATER (TYPE 1B, OPEN PARKING STRUCTURE) .FIRE SEPARATION DISTANCE 0 TO 10 FT (TYPE 1B, OPEN PARKING

STRUCTURE) .FIRE SEPARATION DISTANCE 30 FT OR GREATER (ALL TYPES OF CONSTRUCTION) .FIRE SEPARATION DISTANCE 0 TO 30 FT (TYPE 1B CONSTRUCTION)

\*NONCOMBUSTIBLE CONSTRUCTION REQ'D; USE SEPARATIONS, IF ANY, WILL

B. ALLOWABLE AREA OF UNPROTECTED EXTERIOR WALL OPENINGS (IBC TABLE 704.8) FIRE SEPARATION DISTANCE

NOT PERMITTED.5 FT OR LESS ..OVER 5 TO 10 FT

NOT LIMITED......OVER 10 FT (OPEN PARKING STRUCTURE) ..OVER 10 TO 15 FT

25%.. .OVER 15 TO 20 FT 45%.. .OVER 20 TO 25 FT 70%... .OVER 25 TO 30 FT

NO LIMIT.. ....OVER 30 FT C. THE AREA OF OPENINGS IN AN OPEN PARKING STRUCTURE WITH A FIRE SEPARATION DISTANCE GREATER THAN 10 FT SHALL NOT BE LIMITED.

D. VERTICAL SEPARATION OF UNPROTECTED OPENINGS: 3'-0"; 1-HOUR RATING a. NOT APPLICABLE TO 3 STORY BLDG. OR LESS (IBC 704.9, EXCEPTION 1). b. NOT APPLICABLE TO FULLY SPRINKLERED BUILDING (IBC 704.9, EXCEPTION 2).

c. NOT APPLICABLE TO OPEN PARKING GARAGES (IBC 704.9, EXCEPTION 3). E. SHAFT ENCLOSURES (IBC 707) a. NOT REQUIRED ON PARKING GARAGE RAMPS (IBC 707.2, EXCEPTION 8).

b. FIRE-RESISTANCE RATING (IBC 707.4): 1-HOUR (TYPE II-B CONSTRUCTION) F. OPENING PROTECTIVES

a. FIRE DOORS & SHUTTERS TO COMPLY WITH NFPA 80 (IBC 715.4). G. INTERIOR WALL AND CEILING FINISHES (IBC 803.5, NFPA 286)

a. PARKING GARAGE/USE GROUP S-2 (IBC TABLE 803.5): CLASS C FINISHES ALLOWED FOR ALL AREAS.

b. RETAIL AREAS/USE GROUP A-2 OR M (IBC TABLE 803.5): CLASS C FINISHES ALLOWED FOR ALL AREAS.

FIRE PROTECTION REQUIREMENTS

GENERAL NOTE: ALL FIRE PROTECTION EQUIPMENT, PROPOSED LOCATIONS AND APPLICABILITY OF REFERENCED CODES ARE SUBJECT TO THE REVIEW OF THE FIRE OFFICIAL(S) HAVING JURISDICTION.

A. SPRINKLER SYSTEM a. OPEN PARKING GARAGE: SHALL BE EQUIPPED WITH A SPRINKLER SYSTEM COMPLYING WITH NFPA 13 (IBC 903.2.9).

B. STANDPIPE SYSTEM

a. STANDPIPES ARE REQUIRED. STANDPIPE SYSTEM ALLOWED TO BE COMBINED WITH AUTOMATIC SPRINKLER SYSTEMS AND MUST COMPLY WITH NFPA 14 (IBC 406.3.9, 905.2, 905.3.1.3, 905.8)

C. PORTABLE FIRE EXTINGUISHERS (IBC 906.1) a. PROVIDE FIRE EXTINGUISHERS PER THE INTERNATIONAL FIRE CODE (IFC).

b. REQUIRED IN ALL A, M & S OCCUPANCIES/GROUP CLASSIFICATIONS (IFC 906.1).

7. MEANS OF EGRESS

A. DESIGN OCCUPANT LOAD (IBC 1004, TABLE 1004.1.1) a. PARKING GARAGES: 200 SF PER OCCUPANT (GROSS)

b. ACCESSORY STORAGE/MECHANICAL: 300 SF PER OCCUPANT (GROSS) B. EGRESS WIDTH (IBC 1005, TABLE 1005.1)

a. OCCUPANCIES, OTHER - 0.2 INCHES PER OCCUPANT FOR STAIRWAY WIDTH. b. OCCUPANCIES, OTHER - 0.15 INCHES PER OCCUPANT FOR DOOR WIDTH.

C. EGRESS ROUTE CEILING HEIGHT (IBC 1003.2, 1003.3, 1009.2) a. NOT LESS THAN 90 INCHES (7'-6") EXCEPT AT STAIRWAYS OR PROTRUDING OBJECTS.

b. HEADROOM AT PROTRUDING OBJECTS TO BE 80 INCHES (6'-8") MINIMUM (REDUCED HEIGHT AT 50% MAXIMUM CEILING AREA). PROVIDE BARRIERS FOR HEADROOM LESS THAN 80 INCHES (6'-8").

c. VEHICLE USE AREAS: 8'-4" CLEAR IS PROJECT REQUIREMENT (GOVERNS AT VEHICLE USE AREAS).

D. STAIRWAY HEADROOM TO BE 80 INCHES (6'-8") MINIMUM. E. HORIZONTAL PROJECTIONS (1003.3.3): 4" MAXIMUM BETWEEN 27" & 80" ABOVE WALKING SURFACE. SEE EXCEPTION BELOW FOR STAIRWAY HANDRAILS

F. GUARDS (IBC 1013) REQUIRED AT ALL OPEN-SIDED AREAS MORE THAN 30 INCHES ABOVE THE FLOOR OR GRADE BELOW.

a. HEIGHT: 42 INCHES MINIMUM ABOVE WALKING SURFACE OR LEADING EDGE OF STAIR TREAD. b. STRENGTH AND ATTACHMENT REQUIREMENTS PER IBC 1607.7.

G. ACCESSIBLE MEANS OF EGRESS (IBC 1007) a. NOT LESS THAN ONE ACCESSIBLE MEANS OF EGRESS SHALL BE PROVIDED FOR ACCESSIBLE SPACES.

b. AN ACCESSIBLE MEANS OF EGRESS, INCLUDING THOSE WITH MULTIPLE COMPONENTS, MUST BE CONTINUOUS TO A PUBLIC WAY.

c. LEVEL OF EXIT DISCHARGE THIS PROJECT: GROUND LEVEL EAST AND GROUND LEVEL WEST. d. ALL GRADE LEVEL EXITS THIS PROJECT ARE ACCESSIBLE ROUTES. H. ACCESSIBLE EGRESS CONTINUITY: EGRESS FROM EACH LEVEL ABOVE OR BELOW THE

LEVEL OF EXIT DISCHARGE SHALL BE PROVIDED WITH AT LEAST TWO COMPONENTS FROM THE FOLLOWING: a. ACCESSIBLE EGRESS STAIRWAYS WITHIN VERTICAL EXIT ENCLOSURES (IBC 1007.3

b. "AREAS OF REFUGE" TO BE PROVIDED AT ALL LEVELS OTHER THAN AT GRADE (IBC

c. UNENCLOSED ACCESSIBLE EGRESS STAIRWAYS (IBC 1007.3 AND 1020). d. NO "AREA OF REFUGE" IS REQUIRED AT EXIT STAIRWAYS SERVING OPEN PARKING GARAGES (IBC 1007.3, EXCEPTION 5).

I. EXTERIOR ACCESSIBLE EGRESS STAIRWAYS (IBC 1007.3 AND 1023). a. "EXTERIOR AREA FOR ASSISTED RESCUE" TO BE PROVIDED AT ALL LEVELS OTHER THAN AT GRADE (IBC 1007.8).

J. EMERGENCY ELEVATORS (IBC 1007.4). a. ELEVATORS SHALL COMPLY WITH THE EMERGENCY OPERATION AND SIGNALING DEVICE REQUIREMENTS OF SECTION 2.27 OF ASME A17.1, STANDBY POWER SHALL BE PROVIDED (ASME SECTION 2702, 3003). ELEVATOR SHALL BE ACCESSED FROM EITHER AN AREA OF REFUGE (1007.6) OR A HORIZONTAL EXIT.

b. ELEVATORS NOT REQUIRED TO BE ACCESSED FROM AN AREA FO REDUGE OR HORIZONTAL EXIT IN OPEN PARKING GARAGES (IBC 1007.4). K. ACCESSIBLE AREAS OF RESCUE ASSISTANCE

a. WHERE EITHER AN "AREA OF REFUGE" OR AN "EXTERIOR AREA OF ASSISTED RESCUE" IS REQUIRED, ONE 30"X48" AREA OF RESCUE ASSISTANCE SHALL BE

ACCOMMODATED FOR EACH 200 OCCUPANTS OR PORTION THEREOF (IBC 1007.6).

c. WHERE THE ACCESSIBLE AREAS OF RESCUE ASSISTANCE ARE ENCLOSED (AREA OF REFUGE), PROVIDE TWO-WAY COMMUNICATION AND INSTRUCTIONS PER IBC 1007.6.3 AND 1007.6.4. L. MEANS OF EGRESS COMPONENTS

. MEANS OF EGRESS CONT

K. ACCESSIBLE AREAS OF RESCUE ASSISTANCE

a. DOORS (IBC 1008) 32" MINIMUM CLEAR OPENING WIDTH. 4" MAXIMUM PROJECTION INTO CLEAR WIDTH ALLOWED ABOVE 34" FROM WALKING

a. WHERE EITHER AN "AREA OF REFUGE" OR AN "EXTERIOR AREA OF ASSISTED RESCUE"

b. PROVIDE IDENTIFICATION OF ACCESSIBLE AREAS OF RESCUE ASSISTANCE PER IBC

FOR EACH 200 OCCUPANTS OR PORTION THEREOF (IBC 1007.6).

IS REQUIRED, ONE 30"X48" AREA OF RESCUE ASSISTANCE SHALL BE ACCOMMODATED

A. REQUIREMENTS PER IBC CHAPTER 27.

A. REQUIREMENTS PER IBC CHAPTER 28.

A. REQUIREMENTS PER IBC CHAPTER 29.

A. REQUIREMENTS PER IBC CHAPTER 30.

RATING PER IBC 707.4 (IBC 3006.4). C. CAR EMERGENCY REQUIREMENTS

ONLY) (1-HOUR)

• [ASME A17.1 - 2.14.2.3.2]

<u>15.MECHANICAL SYSTEMS</u>

16.PLUMBING SYSTEMS

17.ELEVATOR SYSTEMS

B. SEE ELECTRICAL DRAWINGS FOR ADDITIONAL INFORMATION.

B. SEE MECHANICAL DRAWINGS FOR ADDITIONAL INFORMATION.

B. SEE PLUMBING DRAWINGS FOR ADDITIONAL INFORMATION.

a. ELEVATORS SYSTEMS TO COMPLY WITH ASME A 17.1.

LIGHTING (4-HOURS) [ASME A17.1 - 2.14.7.1.3]

24"X84" AMBULANCE STRETCHER (IBC 3002.4).

ELEVATOR ACCESS TO ALL FLOORS (IBC 3003.1).

B. FIRE-RESISTANCE RATING OF ELEVATOR EQUIPMENT ROOM SHALL MATCH THE SHAFT

MECHANICAL VENTILATION (GLASS-BACK ELEVATORS EXPOSED TO SUNLIGHT

b. ACCOMMODATION OF AMBULANCE STRETCHER: ELEVATOR CAB TO ACCOMMODATE

FIREFIGHTERS' OPERATION: PROVIDE STANDBY POWER TO ALLOW EMERGENCY

ELEVATOR MACHINE ROOM HVAC TO CONNECT TO STANDBY POWER (IBC 3003.1.4).

a. AUXILIARY POWER REQUIRED FOR SYSTEMS PROVIDED TO ELEVATOR CARS

D. EMERGENCY ELEVATORS (WHERE REQUIRED BY CODE - SEE SECTION 7 ABOVE)

a. EMERGENCY EQUIPMENT OPERATION FOR EMERGENCY ELEVATORS

AUDIBLE SIGNALING DEVICE (1-HOUR) [ASME A17.1 - 2.27.1.1.3.a]

TWO-WAY COMMUNICATION (4-HOURS) [ASME A17.1 - 2.27.1.1.3.b]

 80 INCHES MINIMUM DOOR HEIGHT DIRECTION OF DOOR SWING: IN DIRECTION OF EGRESS TRAVEL FOR OCCUPANCY

WALKING SURFACE. b. PANIC HARDWARE (IBC 1008.1.9) NOT REQUIRED FOR GROUP S OCCUPANCY (PARKING GARAGES).

DOOR HARDWARE: HEIGHT TO FIT COMPLETELY WITHIN 34 TO 48 INCHES ABOVE

M. AREAS OF REFUGE (IBC 1007.6): NOT REQUIRED FOR OPEN PARKING GARAGES (IBC 1007.3.5).

N. STAIRWAYS (IBC 1009)

a. WIDTH STAIRWAYS: 44 INCHES MINIMUM EGRESS WIDTH REGARDLESS OF OCCUPANT

ACCESSIBLE EGRESS STAIRWAYS: WHERE AREAS OF REFUGE ARE REQUIRED.

PROVIDE 48 INCHES MINIMUM CLEAR WIDTH BETWEEN HANDRAILS (IBC 1007.3)

 NOT REQUIRED IF BUILDING IS FULLY SPRINKLERED (IBC 1007.3 EXCEPTION 3) SEE CALCULATIONS THIS SHEET FOR MINIMUM WIDTH OF STAIRS FOR THIS b. LANDINGS: LANDING WIDTH SHALL BE EQUAL TO STAIRWAY WIDTH OR GREATER.

c. HANDRAILS (IBC 1012) PROVIDE HANDRAILS AT BOTH SIDES OF STAIRWAYS.

HEIGHT: 34 TO 38 INCHES.

 STRENGTH AND ATTACHMENT REQUIREMENTS PER IBC 1607.7. PROJECTIONS INTO REQUIRED WIDTH AT EACH HANDRAIL SHALL NOT EXCEED 4.5

 DOES NOT APPLY TO ACCESSIBLE STAIRWAYS. MAXIMUM OUTSIDE DIAMETER: 2 INCHES.

 MINIMUM CLEARANCE TO WALL OR OTHER OBSTRUCTION: 1.5 INCHES HANDRAIL EXTENSIONS: TOP OF STAIR: 12 INCHES, BOTTOM OF STAIR: 12 INCHES

PLUS ONE TREAD WIDTH. INTERMEDIATE HANDRAILS: MAXIMUM REACH IS 30 INCHES. INTERMEDIATE HANDRAIL SHALL BE PROVIDED FOR STAIRWAYS WIDER THAN 60 INCHES CLEAR

BETWEEN OUTER HANDRAILS. O. PARKING RAMPS: PARKING RAMP SLOPE SHALL NOT EXCEED 6.67% (IBC 406.2.5) a. DOES NOT APPLY TO RAMPS USED FOR VEHICLES ONLY (NO PEDESTRIAN FACILITIES).

A. ARRANGEMENT: MINIMUM SEPARATION DISTANCE EQUAL TO ONE-THIRD THE OVERALL DIAGONAL DIMENSION OF THE AREA BEING SERVED (IBC 1015.2.1).

B. MAXIMUM TRAVEL DISTANCE (IBC 1016, TABLE 1016.1) a. S-2 OCCUPANCY (PARKING GARAGES): 400 FT.

A. MINIMUM NUMBER OF EXITS: 2 EXITS FROM EACH STORY MINIMUM (IBC 1019) (500 MAXIMUM OCCUPANT LOAD). SEE CALCULATIONS THIS SHEET FOR MINIMUM NUMBER OF EXITS FOR THIS PROJECT. B. EXIT ENCLOSURES

a. EXIT CORRIDORS (IBC 1017): CORRIDORS SHALL BE ENCLOSED WITH A 0-HOUR RATED FIRE BARRIERS. b. STAIRWAYS IN OPEN PARKING GARAGES ARE PERMITTED TO EXIT THROUGH THE

OPEN PARKING GARAGE AT THE LEVEL OF EXIT DISCHARGE (IBC 1024.1 EXCEPTION 3). C. EXIT STAIRWAYS (IBC 1020) a. FIRE BARRIERS AT INTERIOR WALLS OF EXIT STAIRWAYS (IBC 1020.1): 1-HOUR RATING

LESS THAN FOUR STORIES. b. NOT REQUIRED FOR EXIT STAIRWAYS IN OPEN PARKING STRUCTURES (IBC 1020.1 EXCEPTION 5).

D. FIRE BARRIERS AT EXTERIOR WALLS OF EXIT STAIRWAYS (IBC 1020.1.4) a. NO RATING REQUIRED IF OTHER EXTERIOR BUILDING WALLS ARE NOT REQUIRED TO BE RATED.

b. ANGLE BETWEEN BUILDING AND STAIRWAY WALLS SHALL BE 180 DEGREES OR MORE. E. SMOKEPROOF ENCLOSURES (IBC 1020.1.7) a. NOT REQUIRED FOR OPEN PARKING GARAGES OF ANY HEIGHT (IBC 403.1 EXCEPTION

F. DISCHARGE IDENTIFICATION BARRIER: WHERE VERTICAL EXIT ENCLOSURES CONTINUE BEYOND THE EXIT DISCHARGE, AN APPROVED BARRIER SHALL BE PROVIDED (IBC 1020.1.5).

A. DESIGN REFERENCE CODE (IBC 1101): ICC A117.1.

a. THIS PROJECT IS ALSO GOVERNED BY THE AMERICANS WITH DISABILITIES ACT (ADA). b. WHERE CODE REQUIREMENTS ARE IN CONFLICT, THE STRICTER REQUIREMENT SHALL

B. GENERAL EXEMPTIONS (IBC 1103): EQUIPMENT SPACES AND LIMITED ACCESS, NON-OCCUPIABLE SPACES ARE NOT REQUIRED TO BE ACCESSIBLE

C. ACCESSIBLE ROUTE (IBC 1104): ACCESSIBLE ENTRANCES SHALL HAVE AN ACCESSIBLE ROUTE TO A PUBLIC SIDEWALK AND ANY OTHER SITE ARRIVAL POINTS. D. ACCESSIBLE ENTRANCES (IBC 1105): ALL PARKING GARAGE ENTRANCES ARE TO BE

ACCESSIBLE. E. ACCESSIBLE PARKING SPACES (IBC 1106) a. PROVIDE QUANTITIES PER IBC TABLE 1106.1. b. LAYOUT OF PARKING SPACES AND ACCESS AISLES TO MEET ALL CODE

REQUIREMENTS. c. ACCESS AISLE SHARING: TWO ACCESSIBLE PARKING SPACES MAY SHARE A COMMON ACCESS AISLE.

 EXCEPTION: ANGLED VAN SPACES SHALL HAVE ACCESS AISLES LOCATED ON THE PASSENGER SIDE OF THE PARKING SPACE (NO SHARING) d. ACCESSIBLE VAN SPACES: 1 FOR EVERY 6 SPACES OR FRACTION THEREOF.

e. VERTICAL CLEARANCE: PARKING SPACES FOR VANS, ACCESS AISLES SERVING THEM, AND VEHICULAR ENTRY/EXIT ROUTES TO/FROM AN ENTRANCE SHALL PROVIDE A MINIMUM VERTICAL CLEARANCE OF 98 INCHES (8'-2").

11.CODE SIGNAGE REQUIREMENTS

A. EGRESS SIGNAGE a. EXIT SIGNS: PROVIDE ILLUMINATED EXIT SIGNS AT ALL EXIT DOORS (IBC 1011.1).

F. ELEVATORS (IBC 1109.6, 3001.3): COMPLY WITH ICC A117.1 (SEE ITEM 10.A ABOVE)

 EXIT SIGNS NOT REQUIRED AT AREAS REQUIRING ONLY ONE EXIT (IBC 1011.1.1 ACCESS TO EXITS SHALL BE SIGNED WHERE EXIT IS NOT IMMEDIATELY VISIBLE (100

e. TACTILE AND ILLUMINATED SIGNAGE AT EXTERIOR AREAS FOR RESCUE ASSISTANCE

FT MAX. SPACING) (IBC 1011.1). B. DIRECTIONAL SIGNS SHALL BE PROVIDED AT DISCHARGE IDENTIFICATION BARRIERS (IBC

1020.1.5). C. ACCESSIBILITY SIGNAGE (IBC 1110)

a. COMPLY WITH ICC A117.1 (SEE ITEM 10.A ABOVE).

D. IDENTIFICATION SIGNS (IBC 1110.1) a. TACTILE EXIT SIGNS AT ALL EGRESS DOORS (IBC 1011.3). b. ACCESSIBLE PARKING SPACES.

c. ALL ELEVATORS. d. TACTILE AND ILLUMINATED SIGNAGE AT AREAS OF REFUGE (IBC 1007.6.5)

(IBC 1007.8.3) E. ELEVATOR SIGNAGE

a. EMERGENCY SIGNS (IBC 3002.3). b. ACCESSIBILITY SIGNAGE (SEE ITEM 11.B ABOVE).

12.SPECIAL REQUIREMENTS FOR OPEN PARKING STRUCTURE A. PARKING STRUCTURE IS CLASSIFIED AS A RAMP ACCESS PARKING GARAGE (IBC

B. EXTERIOR WALL OPENINGS: PROVIDE UNIFORMLY DISTRIBUTED OPENINGS ON TWO OR MORE SIDES (IBC 406.3.3.1). a. DISTRIBUTE OPENING OVER 40% OF BUILDING PERIMETER MINIMUM.

b. AREA OF OPENINGS: AT LEAST 20% OF PERIMETER WALL AREA OF TIER.

13.STRUCTURAL DESIGN

A. REQUIREMENTS PER IBC CHAPTERS 16 THROUGH 22.

B. SEE STRUCTURAL DRAWINGS FOR ADDITIONAL INFORMATION.

C. ENCLOSURE IS NOT REQUIRED FOR VERTICAL OPENINGS (IBC 406.3.11).

CODE COMPLIANCE CALCULATIONS

NOTE: CALCULATIONS ARE REFERENCED TO THE PRECEDING CODE SUMMARY

REF. 2. MINIMUM STAIR WIDTH: SEE REF. 7B CALCULATIONS BELOW.

REF. 4. BUILDING HEIGHT: 25.25'± (HIGHEST), 2 STORIES ABOVE GRADE

REF. 4. AREA SUMMARY AREA PROVIDED (SF) LEVEL FUNCTION PARKING GARAGE 9,790

PARKING GARAGE 19,960

PARKING GARAGE 4,840 REF. 5. FIRE SEPARATION DISTANCE PROVIDED: ±25.17 FT

REF. 7A. OCCUPANT LOAD LEVEL AREA (SF) DIVISOR OCCUPANTS

9.790 200 19,960 200 100 200 4,840

REF. 7B. EGRESS OPEN PARKING GARAGE EGRESS WIDTH:

A. DOORS: 1. REQUIRED EXIT WIDTH =  $173 \times 0.15 = 26$ " OF WIDTH

2. PROVIDED EXIT WIDTH = 1 x 36" (CLEAR) = 36" (CLEAR) OK B. EAST STAIRS 1. REQUIRED EXIT WIDTH = 87 x 0.2 = 17.4" OF WIDTH

2. PROVIDED EXIT WIDTH = 1 x 48"= 48" OK C. WEST STAIRS

1. REQUIRED EXIT WIDTH = 87 x 0.2 = 17.4" OF WIDTH 2. PROVIDED EXIT WIDTH = 1 x 48"= 48" OK

D. MAX. TRAVEL DISTANCE 1. RETAIL AREAS: PROVIDED MAX. TRAVEL DISTANCE = X FT < 200 FT OK 2. PARKING AREAS: PROVIDED MAX. TRAVEL DISTANCE = X FT < 400 FT OK

REF. 9. MINIMUM NUMBER OF EXITS: SEE REF. 7 CALCULATIONS ABOVE. REF. 12. OPENNESS OF STRUCTURE: OPENINGS ARE PROVIDED ON ALL 4-SIDES

OF BUILDING (UNIFORMLY DISTRIBUTED) TIER WALL AREA NORTH SIDE OPEN TO SKY SOUTH SIDE 358 SF OPEN TO SKY **EAST SIDE** 0 SF OPEN TO SKY **WEST SIDE** 0 SF OPEN TO SKY OPEN WALL AREA (S.F.)/% OPEN NORTH SIDE 100% Χ% SOUTH SIDE 100% 100% **EAST SIDE** 100% 100% WEST SIDE 100% 100% Χ% TOTAL TIER OPENNESS (%) OK OK





ISSUE FOR

NO. DESCRIPTION DATE DRAWING TITLE: **IBC 2006 CODE** SUMMARY

DRAWING NO:

SCALE: 12" = 1'-0" DATE: ISSUED FOR PROJECT NO: 50-24102

G002

RWN. Author





SECTION 1015 EXIT AND EXIT ACCESS DOORWAYS

1015.1 EXIT OR EXIT ACCESS DOORWAYS REQUIRED

TWO EXITS OR EXIT ACCESS DOORWAYS FROM ANY SPACE SHALL BE PROVIDED WHERE THE FOLLOWING CONDITION EXISTS:

2. THE COMMON PATH OF EGRESS TRAVEL EXCEEDS THE LIMITATIONS OF SECTION 1014.3.

SECTION 1014 COMMON PATH OF EGRESS TRAVEL


1014.3 COMMON PATH OF EGRESS TRAVEL

IN OCCUPANCIES OTHER THAN GROUPS H-1, H-2, AND H-3, THE COMMON PATH OF EGRESS TRAVEL SHALL NOT EXCEED 75 FEET. IN GROUP H-1, H-2, AND H-3 OCCUPANCIES, THE COMMON PATH OF EGRESS TRAVEL SHALL NOT EXCEED 25 FEET. FOR COMMON PATH OF EGRESS TRAVEL IN GROUP A OCCUPANCIES HAVING FIXED SEATING, SEE SECTION 1025.8.

## **EXCEPTIONS**:

1. THE LENGTH OF A COMMON PATH OF EGRESS TRAVEL IN THE GROUP B, F, AND S OCCUPANCIES SHALL NOT BE MORE THAN 100 FEET, PROVIDED THAT THE BUILDING IS EQUIPPED THROUGHOUT WITH AN AUTOMATIC SPRINKLER SYSTEM INSTALLED IN ACCORDANCE WITH SECTION 903.3.1.1.

TOTAL MAXIMUM TRAVEL DISTANE FOR S-2 OCCUAPNCY (PARKING GARAGE) IS

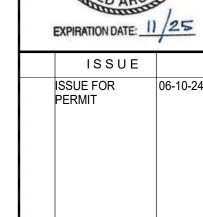

NO. DESCRIPTION DATE DRAWING TITLE: LIFE SAFETY PLANS

DRAWING NO:

G003

SCALE: 1/16" = 1'-0" DATE: ISSUED FOR PERMIT 06-10-24 PROJECT NO: 50-24102 RWN. CHK'D. Designer Author Checker

4 WEST OPENNESS REQUIREMENT-GRIDLINE 6
G004 SCALE: 1/8" = 1'-0"



DOWNTOWN E. DUNDEE PARKING S

STEPHEN ATEGIO DATE: 11 25

ISSUE FOR PERMIT

DRAWING TITLE:
OPENNESS
REQUIREMENT
ELEVATIONS

DRAWING NO:

G004

SCALE: 1/8" = 1'-0"

DATE: ISSUED FOR
PERMIT 06-10-24
PROJECT NO: 50-24102

DES. RWN. CHK'D.
Designer Author Checker

4 WEST OPENNESS PROVISION-GRIDLINE 6
G005 SCALE: 1/8" = 1'-0"





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STEPHEN A REBORA STEPHEN A REBORA SED ARCHISED A

ISSUE FOR PERMIT 06-10-24

NO. DESCRIPTION DATE

DRAWING TITLE:
OPENNESS
PROVISION
ELEVATIONS

DRAWING NO:

SCALE: 1/8" = 1'-0"

DATE: ISSUED FOR
PERMIT 06-10-24
PROJECT NO: 50-24102

DES. RWN. CHK'D.
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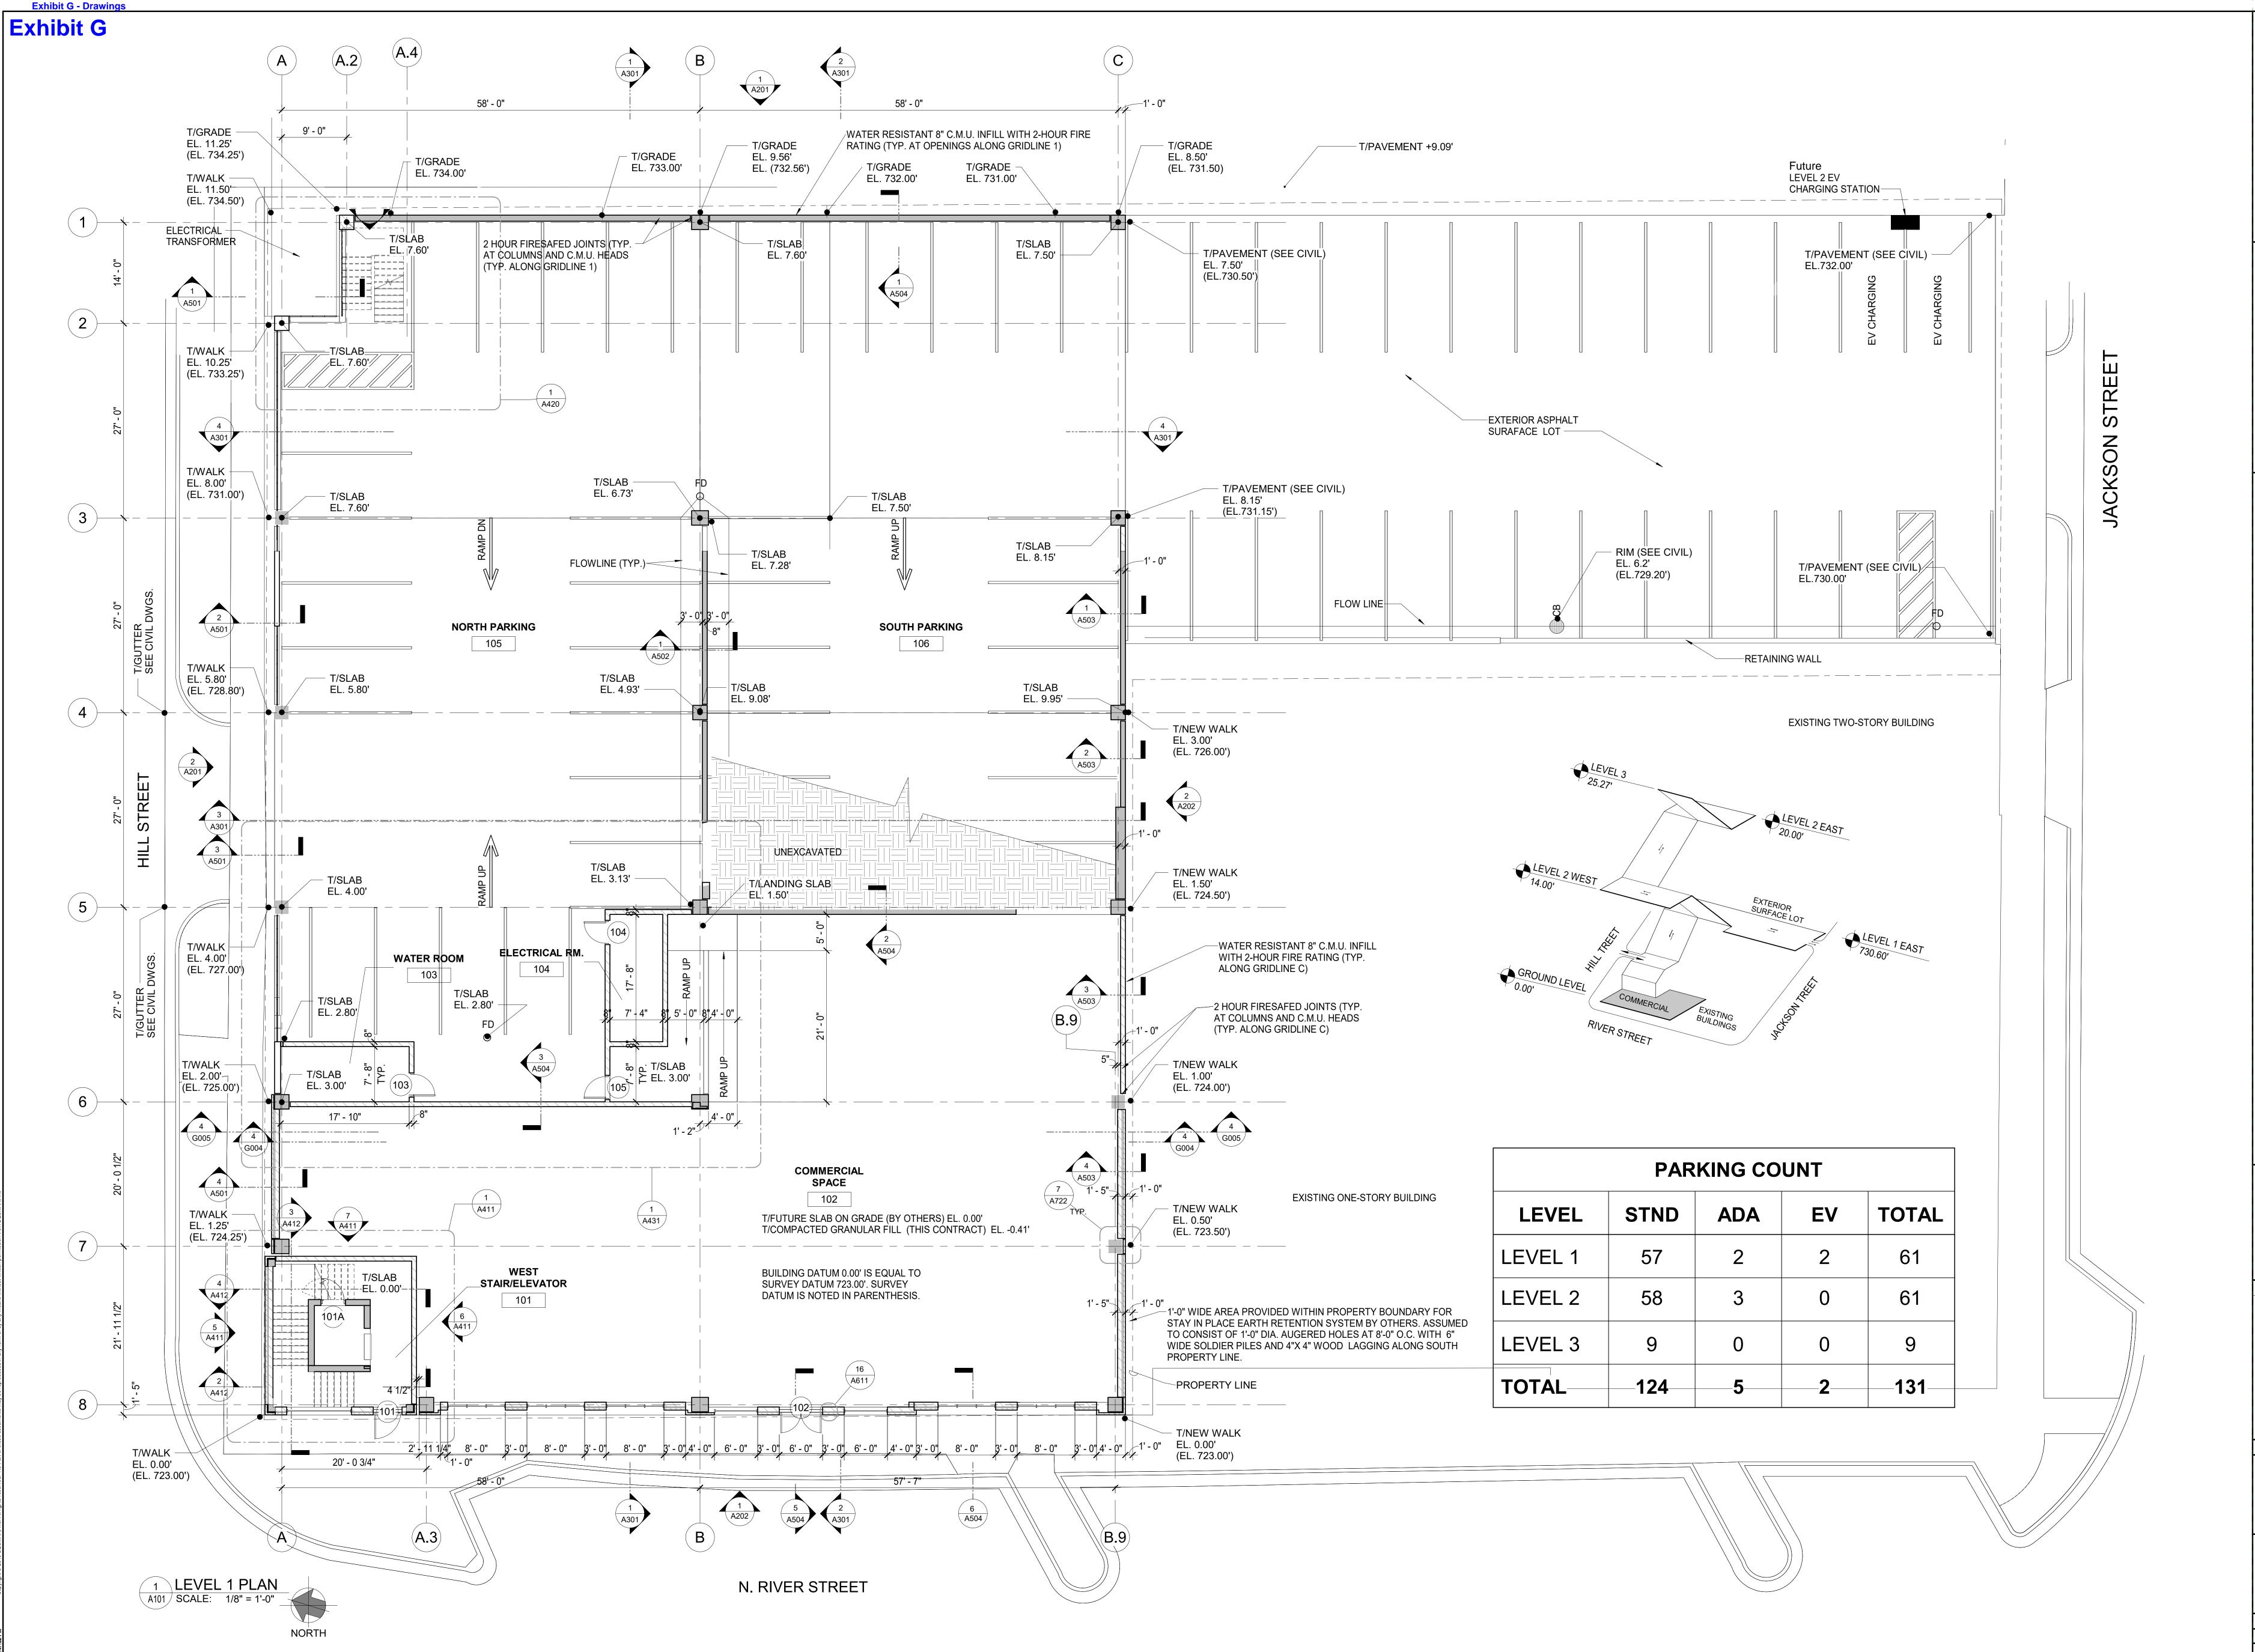
EXPIRATION DATE: 11/25

ISSUE ISSUE FOR PERMIT

NO. DESCRIPTION DATE DRAWING TITLE:
SITE PLAN

DRAWING NO: **A001** 

SCALE: As indicated DATE: ISSUED FOR
PERMIT 06-10-24
PROJECT NO: 50-24102 DES. RWN. CHK'D. Designer Author Checker





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VN E. DUNDEE PARKING STRU

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ISSUE

ISSUE FOR PERMIT 06-10-24

NO. DESCRIPTION DATE

DRAWING TITLE:


LEVEL 1 PLAN


DRAWING NO:
A101

SCALE: As indicated

DATE: ISSUED FOR
PERMIT 06-10-24
PROJECT NO: 50-24102

DES. RWN. CHK'D.
Designer Author Checker

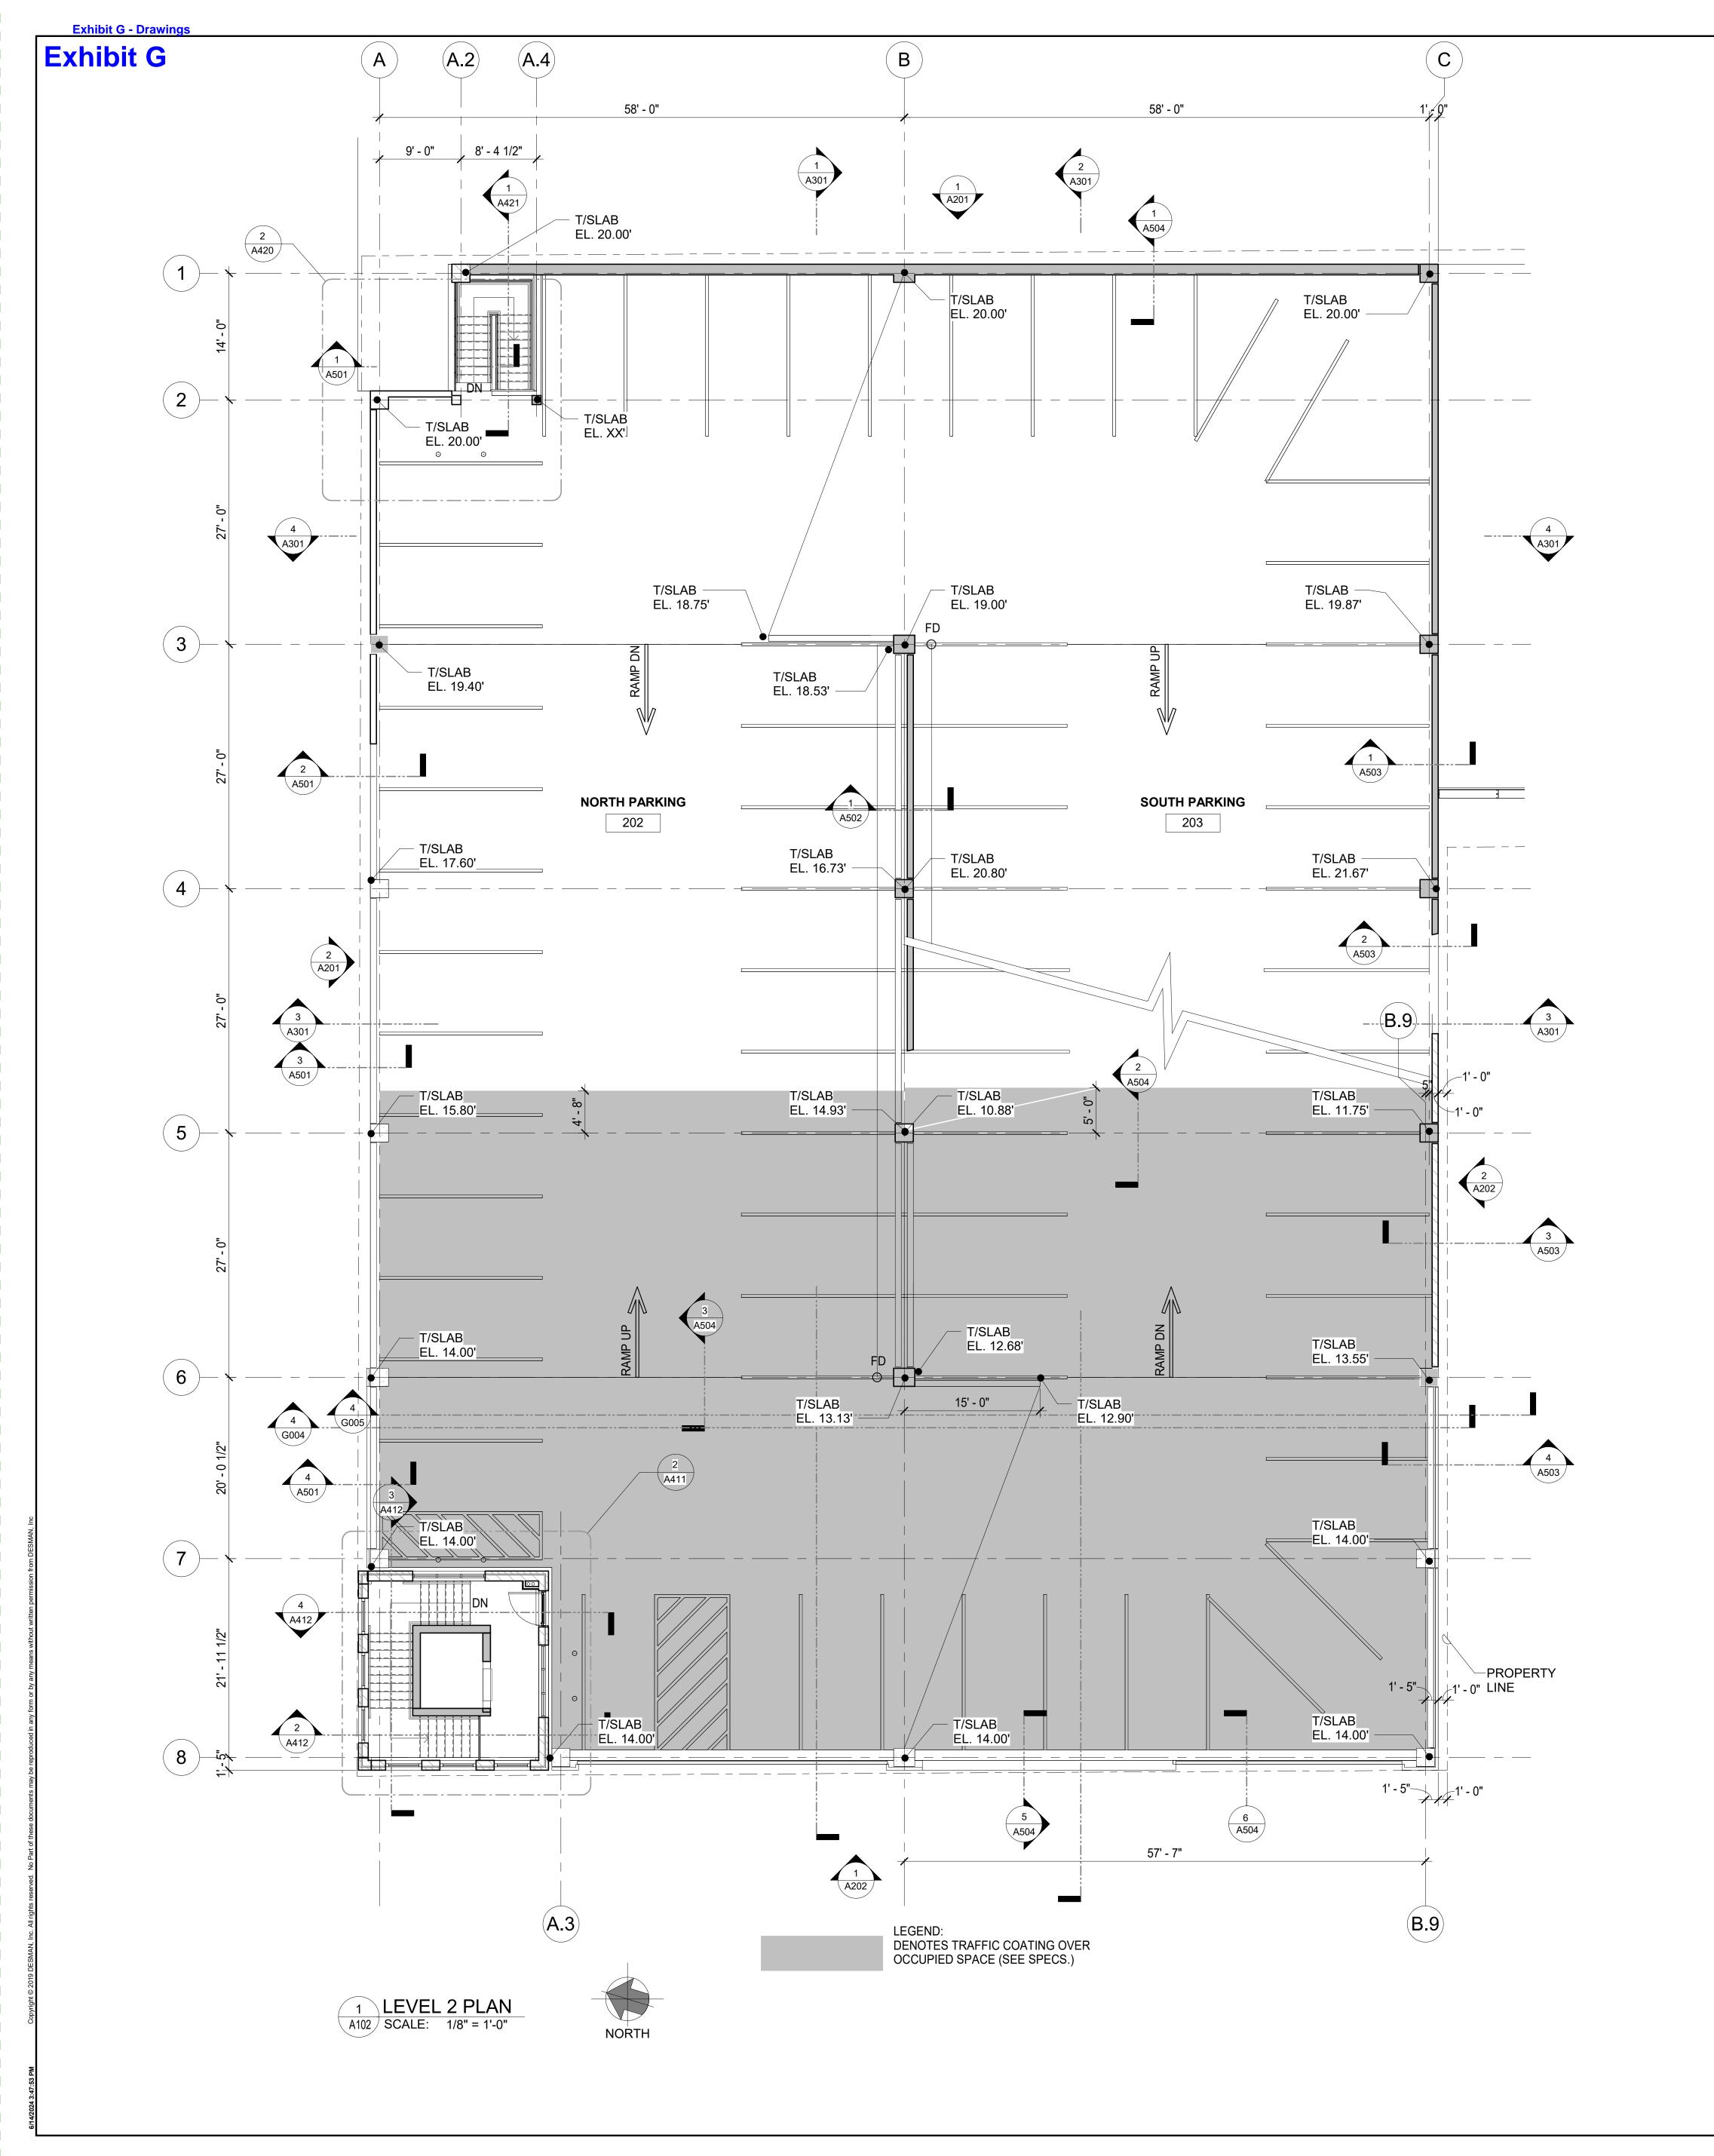

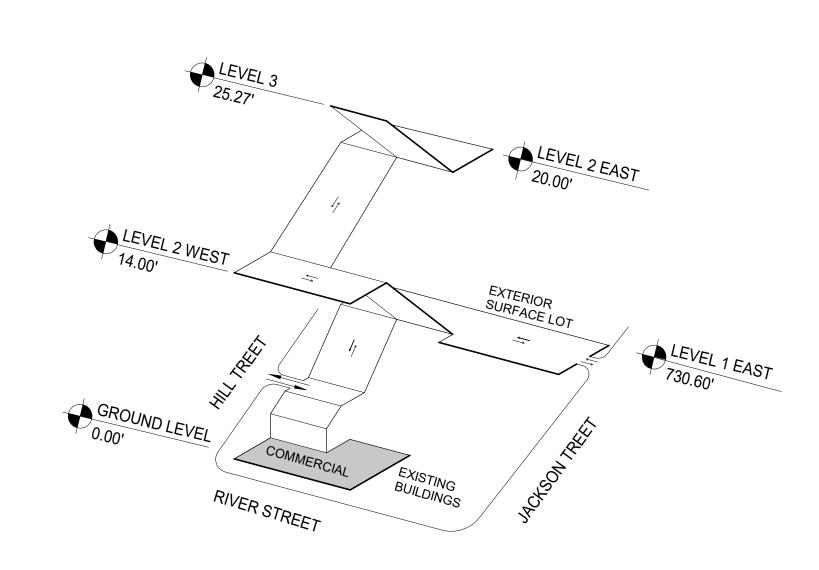

PARKING COUNT									
LEVEL	STND	ADA	EV	TOTAL					
LEVEL 1	57	2	2	61					
LEVEL 2	58	3	0	61					
LEVEL 3	9	0	0	9					
TOTAL	124	5	2	131					





JEE PARKING OIRUCIUR

STEPHEN AREBORA

EXPIRATION DATE: 11/25

ISSUE

ISSUE FOR
PERMIT

06-10-24

NO. DESCRIPTION DATE


DRAWING TITLE:
LEVEL 2 PLAN

DRAWING NO:
A102

SCALE: As indicated


DATE: ISSUED FOR
PERMIT 06-10-24
PROJECT NO: 50-24102

DES. RWN. CHK'D.
Designer Author Checker

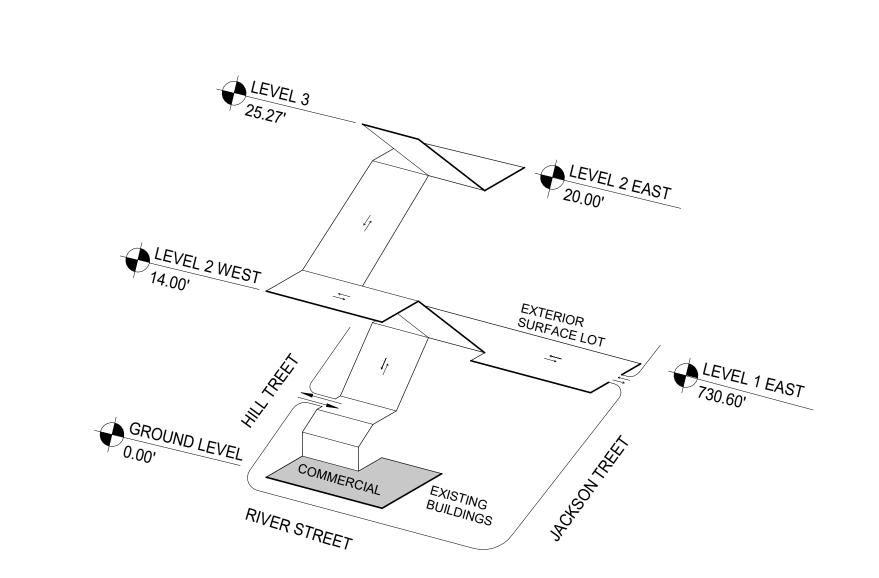

PARKING COUNT													
LEVEL	LEVEL STND ADA EV TOTAL												
LEVEL 1	57	2	2	61									
LEVEL 2	58	3	0	61									
LEVEL 3	9	0	0	9									
TOTAL	TOTAL 124 5 2												



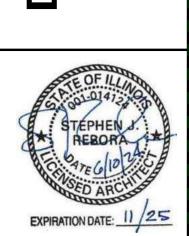

ISSUE ISSUE FOR PERMIT


NO. DESCRIPTION DATE DRAWING TITLE:

LEVEL 3 PLAN

DRAWING NO: A103

SCALE: As indicated

DATE: ISSUED FOR
PERMIT 06-10-24
PROJECT NO: 50-24102 DES. RWN. CHK'D. Designer Author Checker

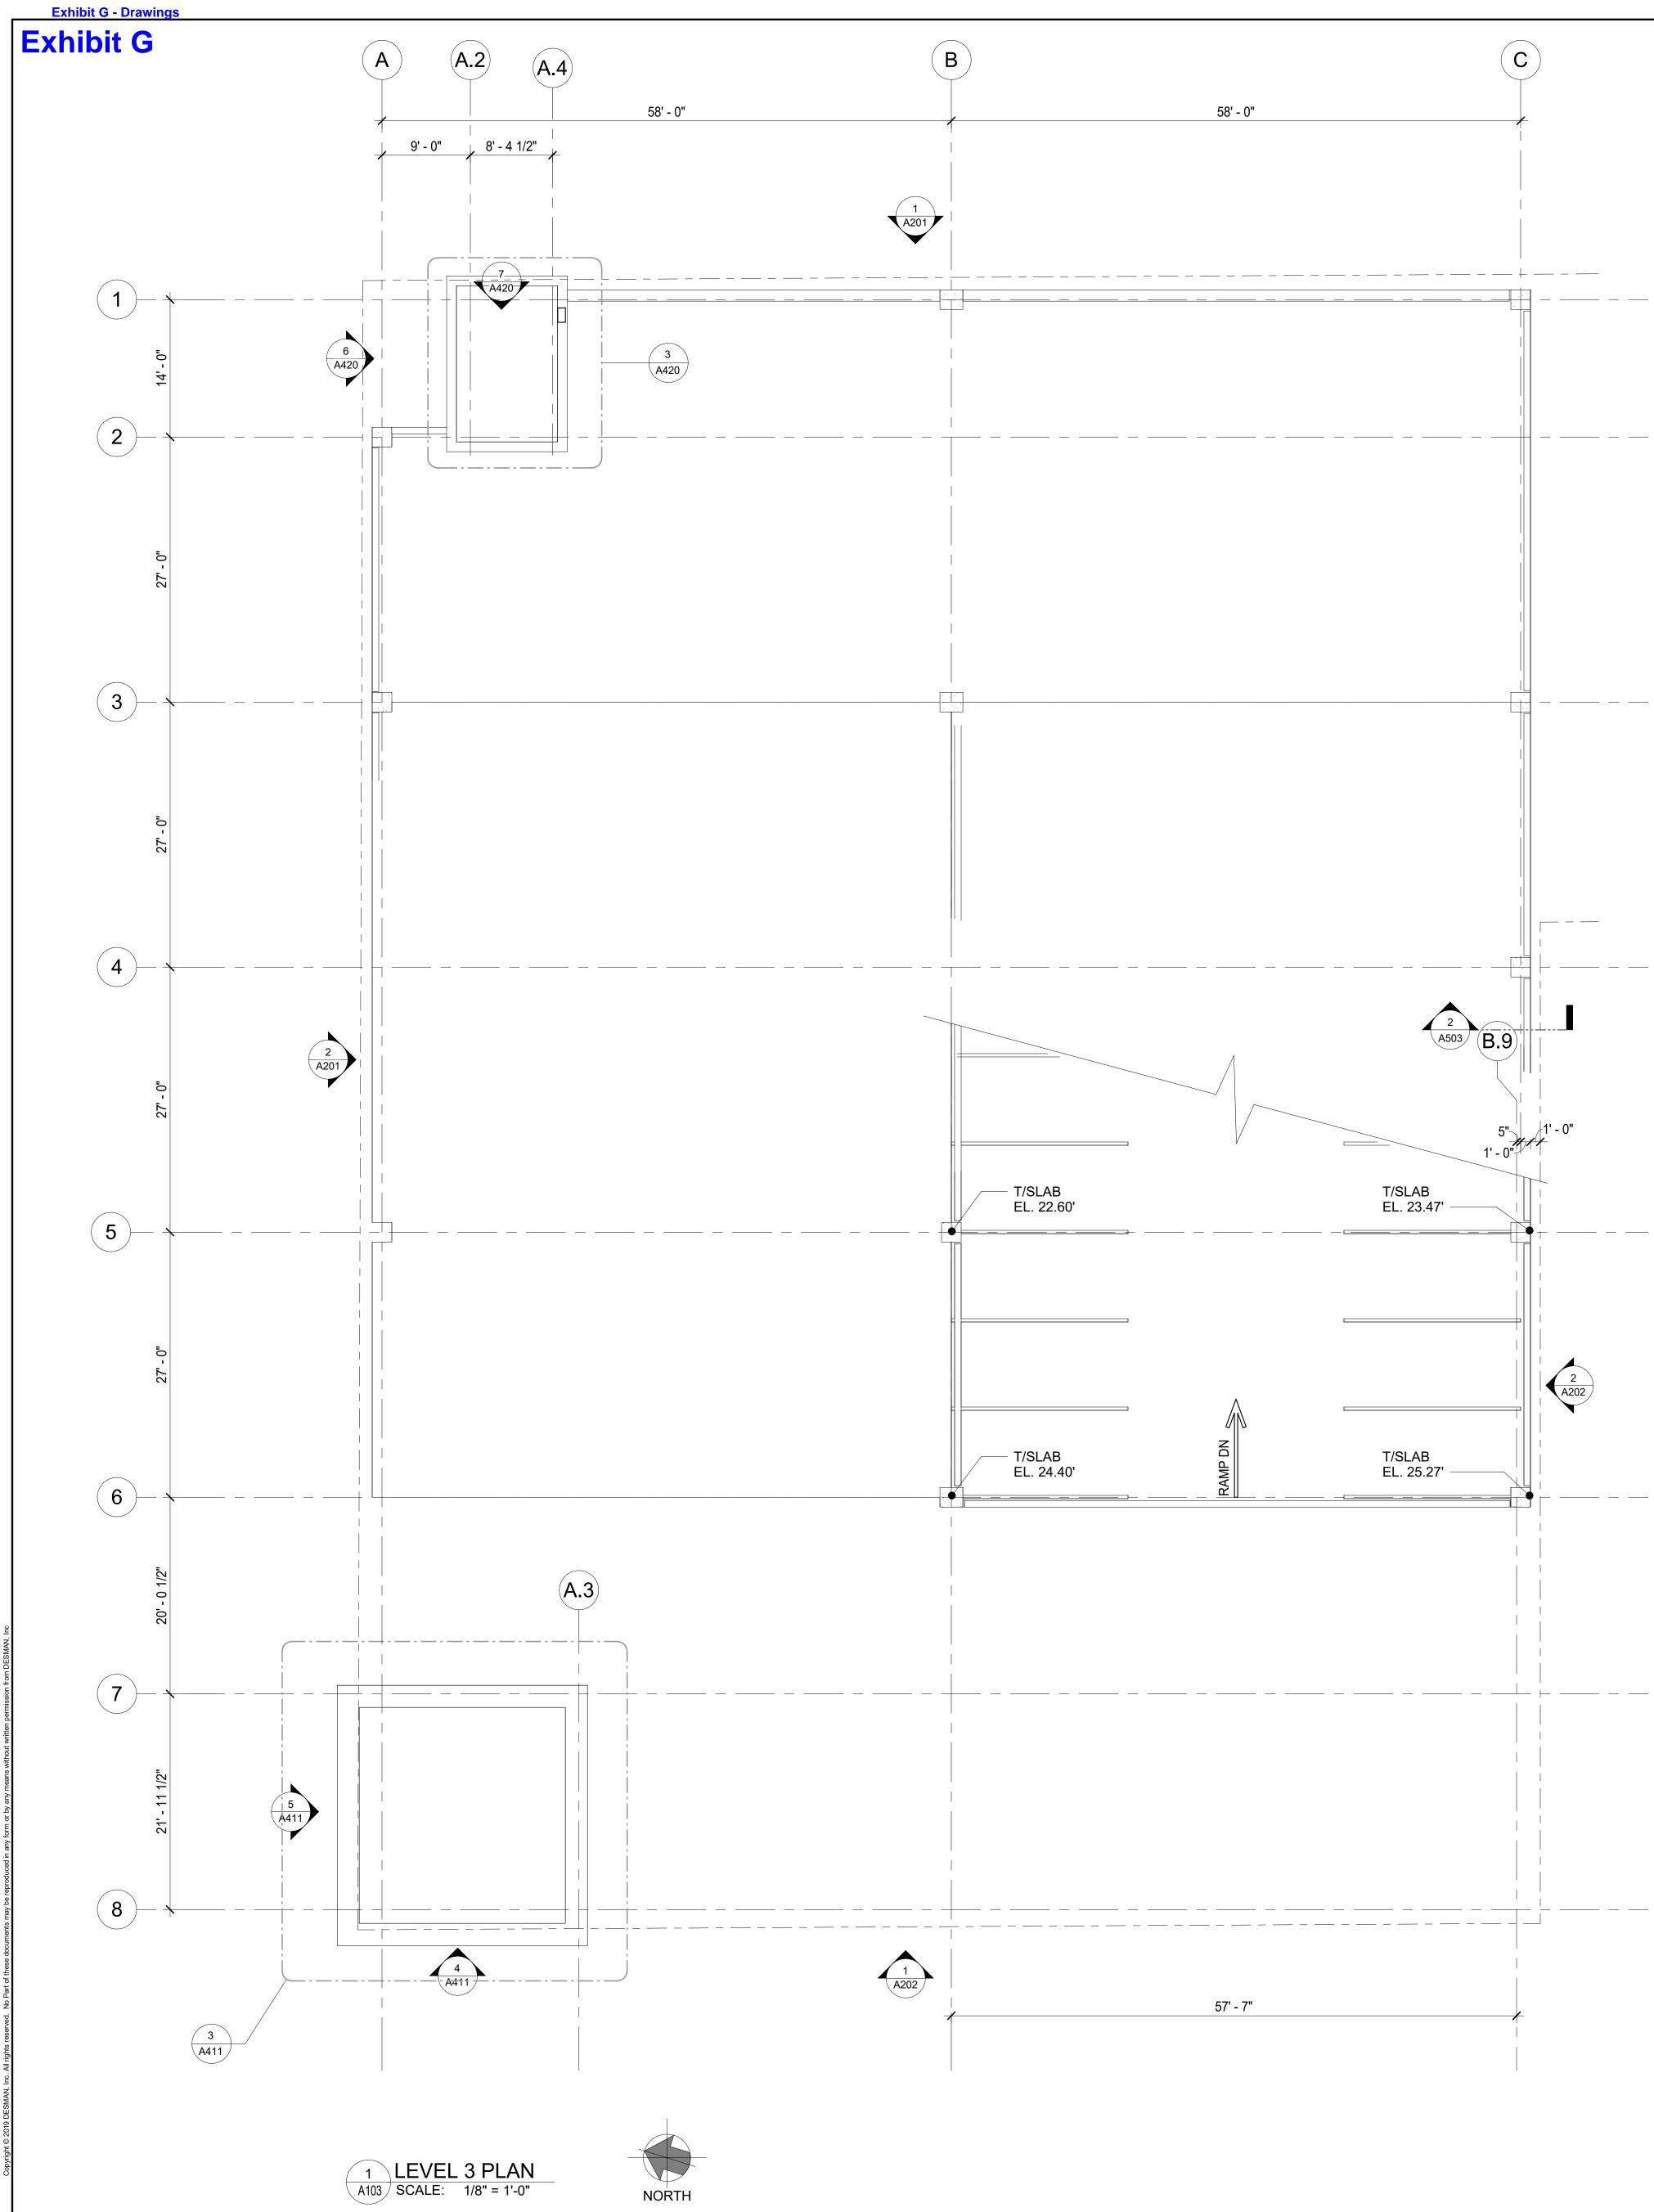

EXPIRATION DATE: 11/25

ISSUE ISSUE FOR PERMIT

NO. DESCRIPTION DATE DRAWING TITLE: EAST & NORTH

BUILDING ELEVATIONS

DRAWING NO: **A201** 


JMCC Note: Cornice and corbel


through the shop drawings process.

the design can be finalize.

DATE: ISSUED FOR

design and material selection to be finalized through the design process.
An allowance has been included until SCALE: 3/16" = 1'-0" PERMIT 06-10-24 PROJECT NO: 50-24102 Note: Masonry shelf angle location and requirements to be confirmed with engineers DES. RWN. CHK'D. Designer Author

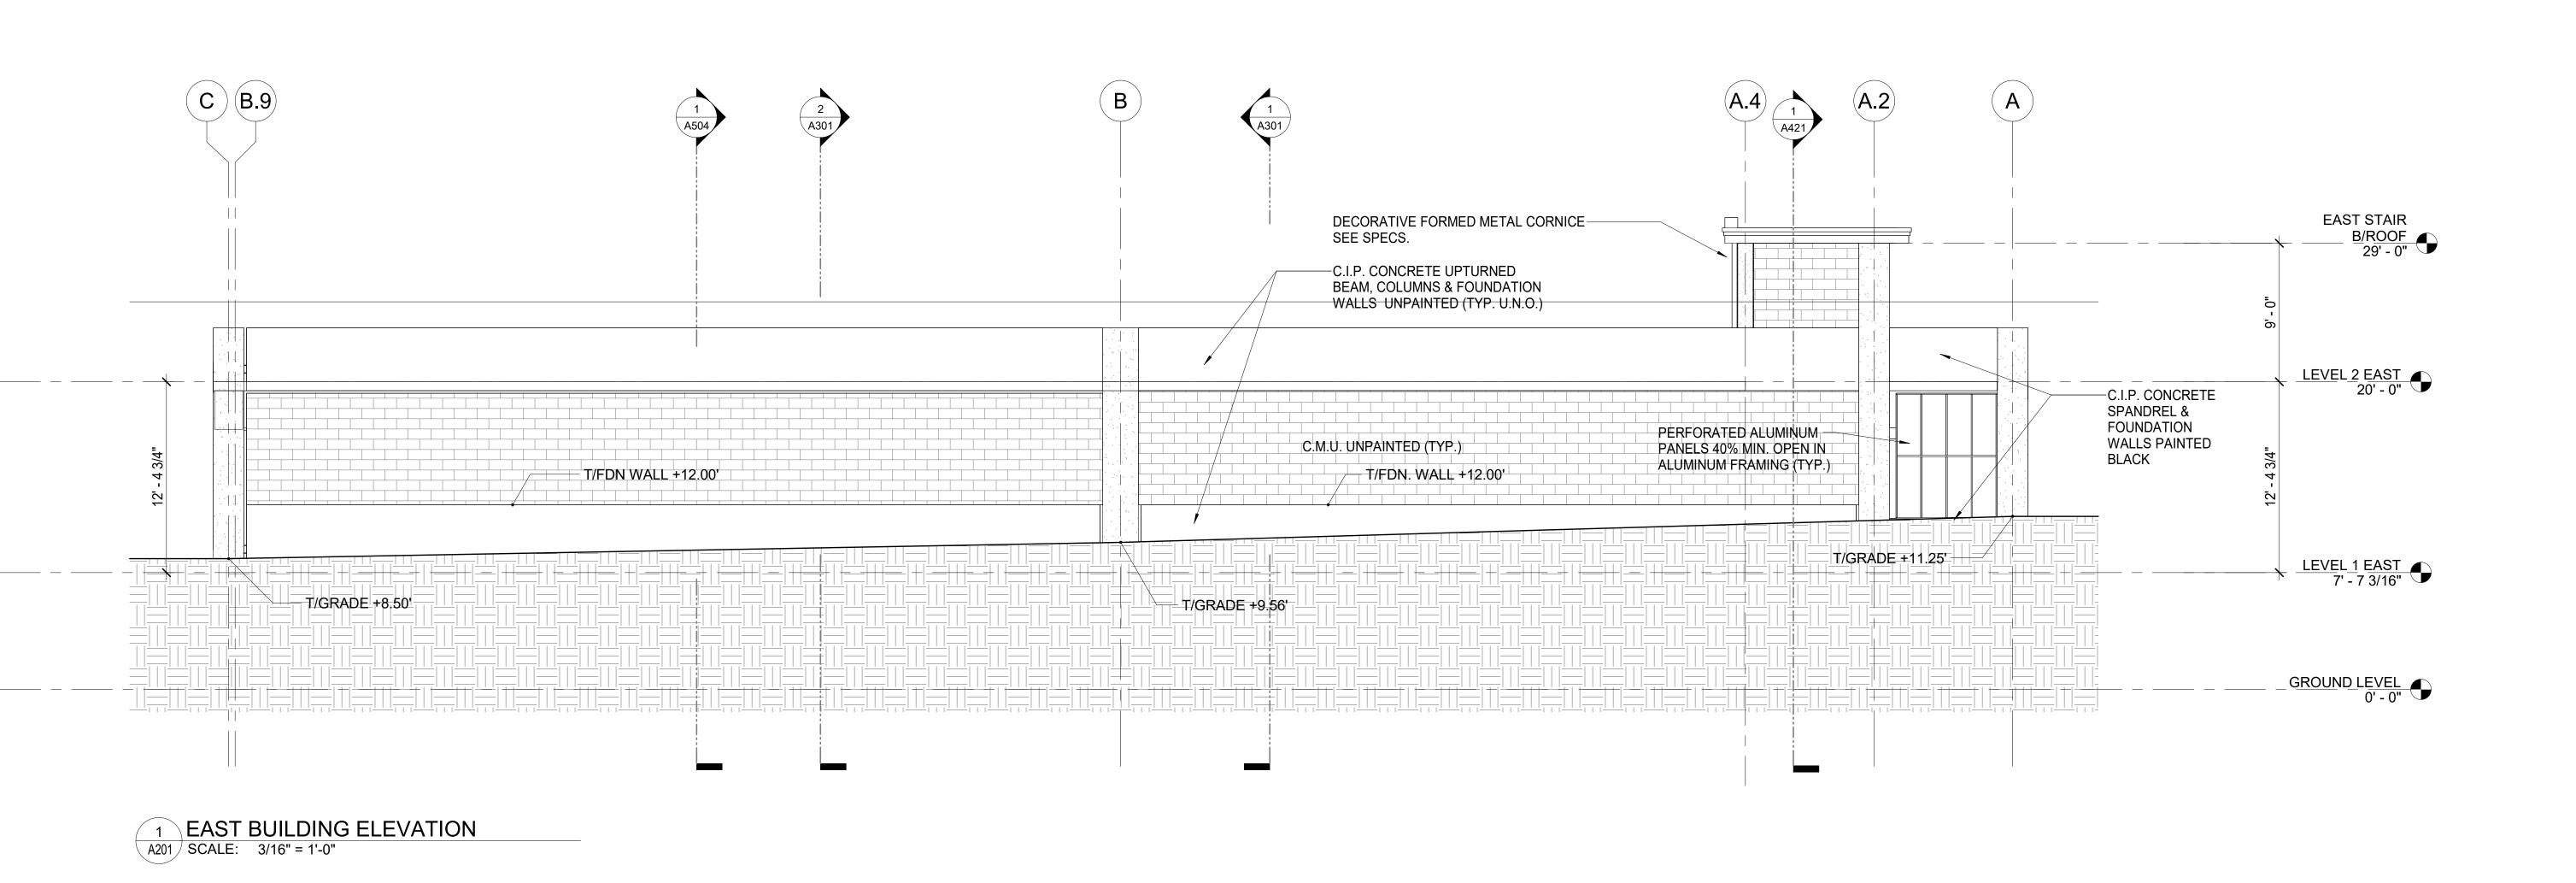

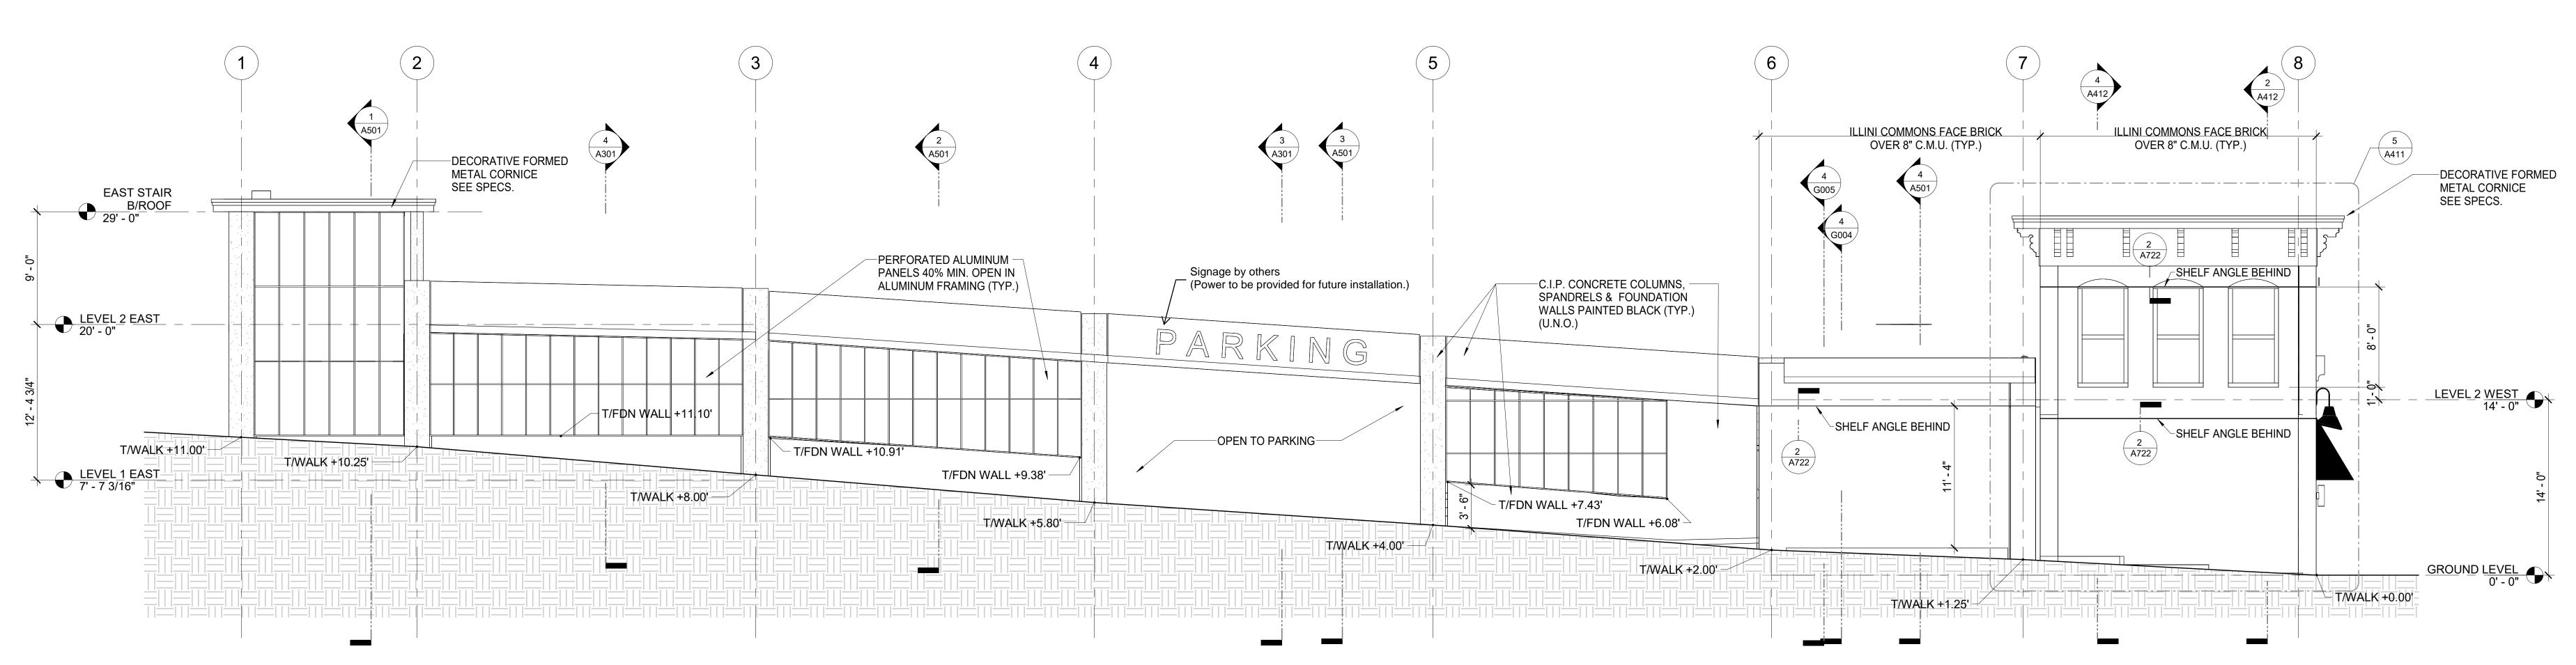

2 NORTH BUILDING ELEVATION
A201 SCALE: 3/16" = 1'-0"

NO. DESCRIPTION DATE DRAWING TITLE: WEST & SOUTH BUILDING ELEVATIONS


DRAWING NO: **A202** 


JMCC Note: Cornice and corbel design and material selection to be

through the shop drawings process.

the design can be finalize.

finalized through the design process.
An allowance has been included until SCALE: 3/16" = 1'-0" DATE: ISSUED FOR PERMIT 06-10-24 PROJECT NO: 50-24102 Note: Masonry shelf angle location and requirements to be confirmed with engineers DES. RWN. CHK'D.

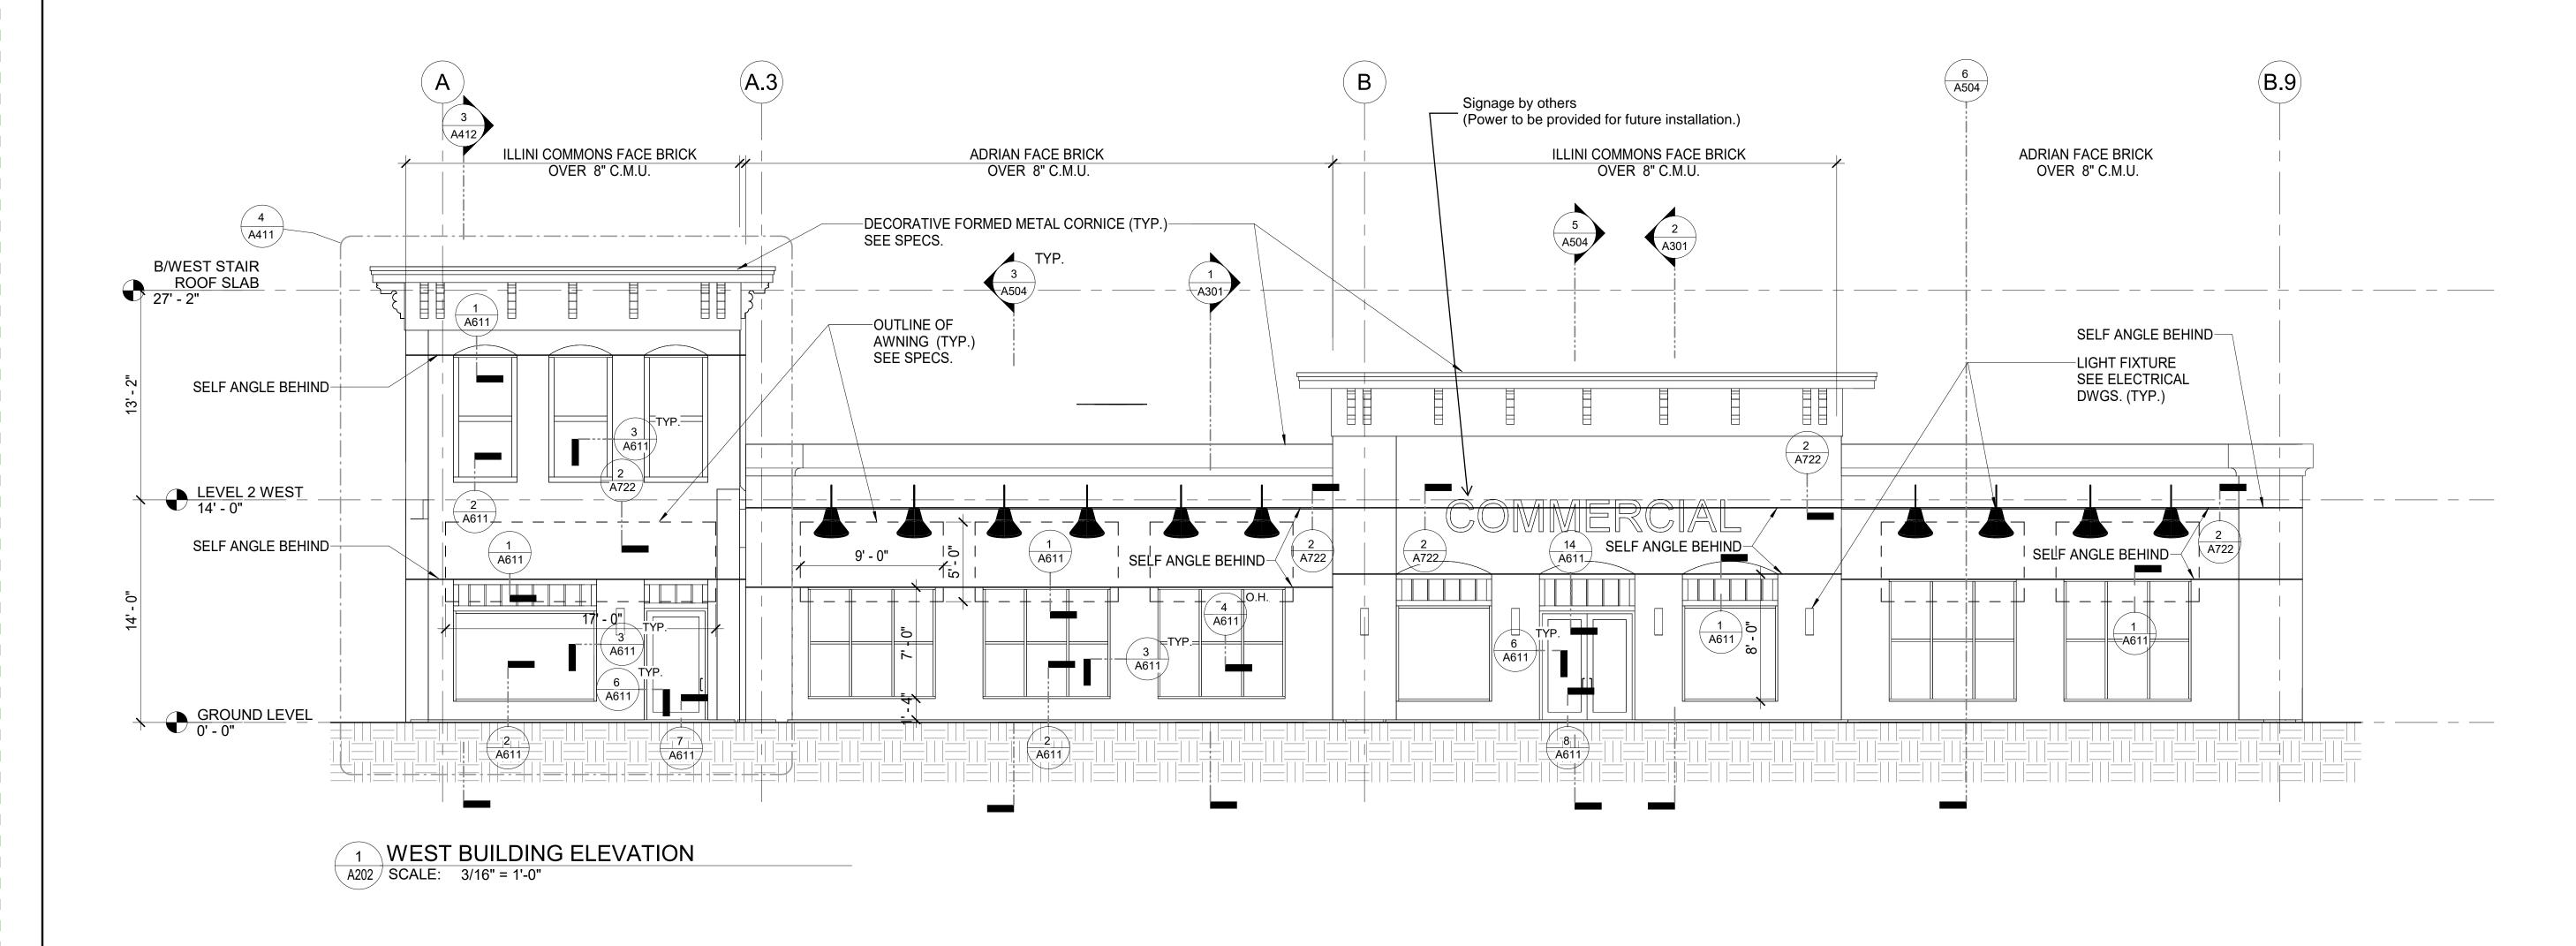

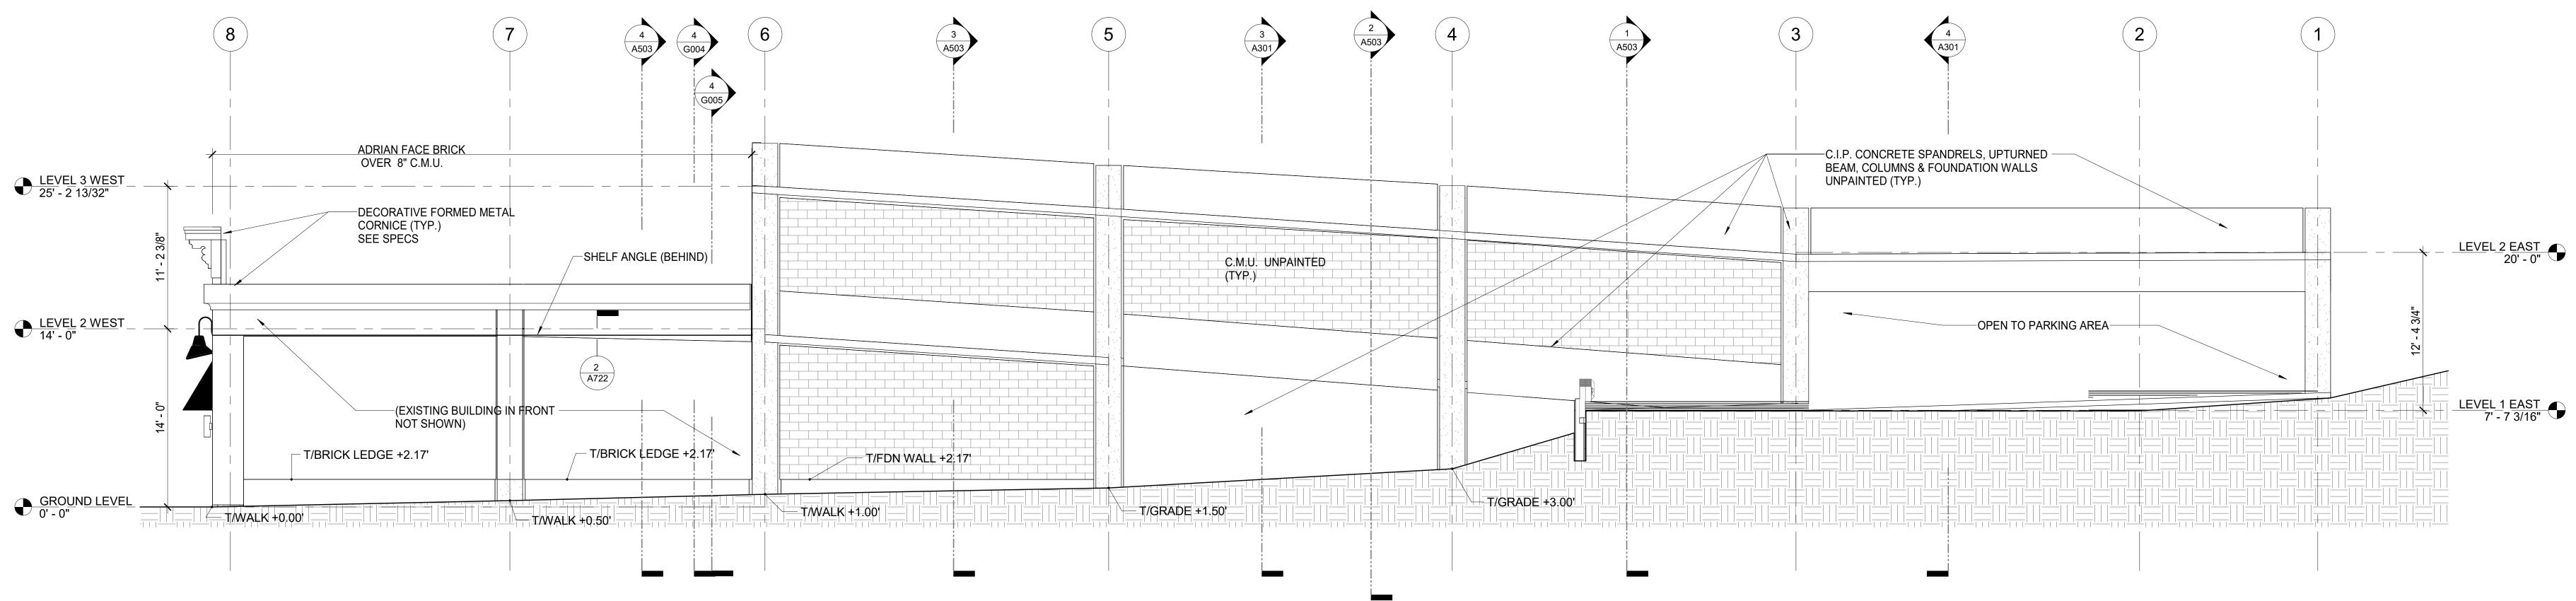


2 SOUTH BUILDING ELEVATION
A202 SCALE: 3/16" = 1'-0"

DRAWING NO: **A301** SCALE: 1/8" = 1'-0" DATE: ISSUED FOR
PERMIT 06-10-24
PROJECT NO: 50-24102

DES. RWN. CHK'D. Designer Author Checker

ISSUE FOR PERMIT

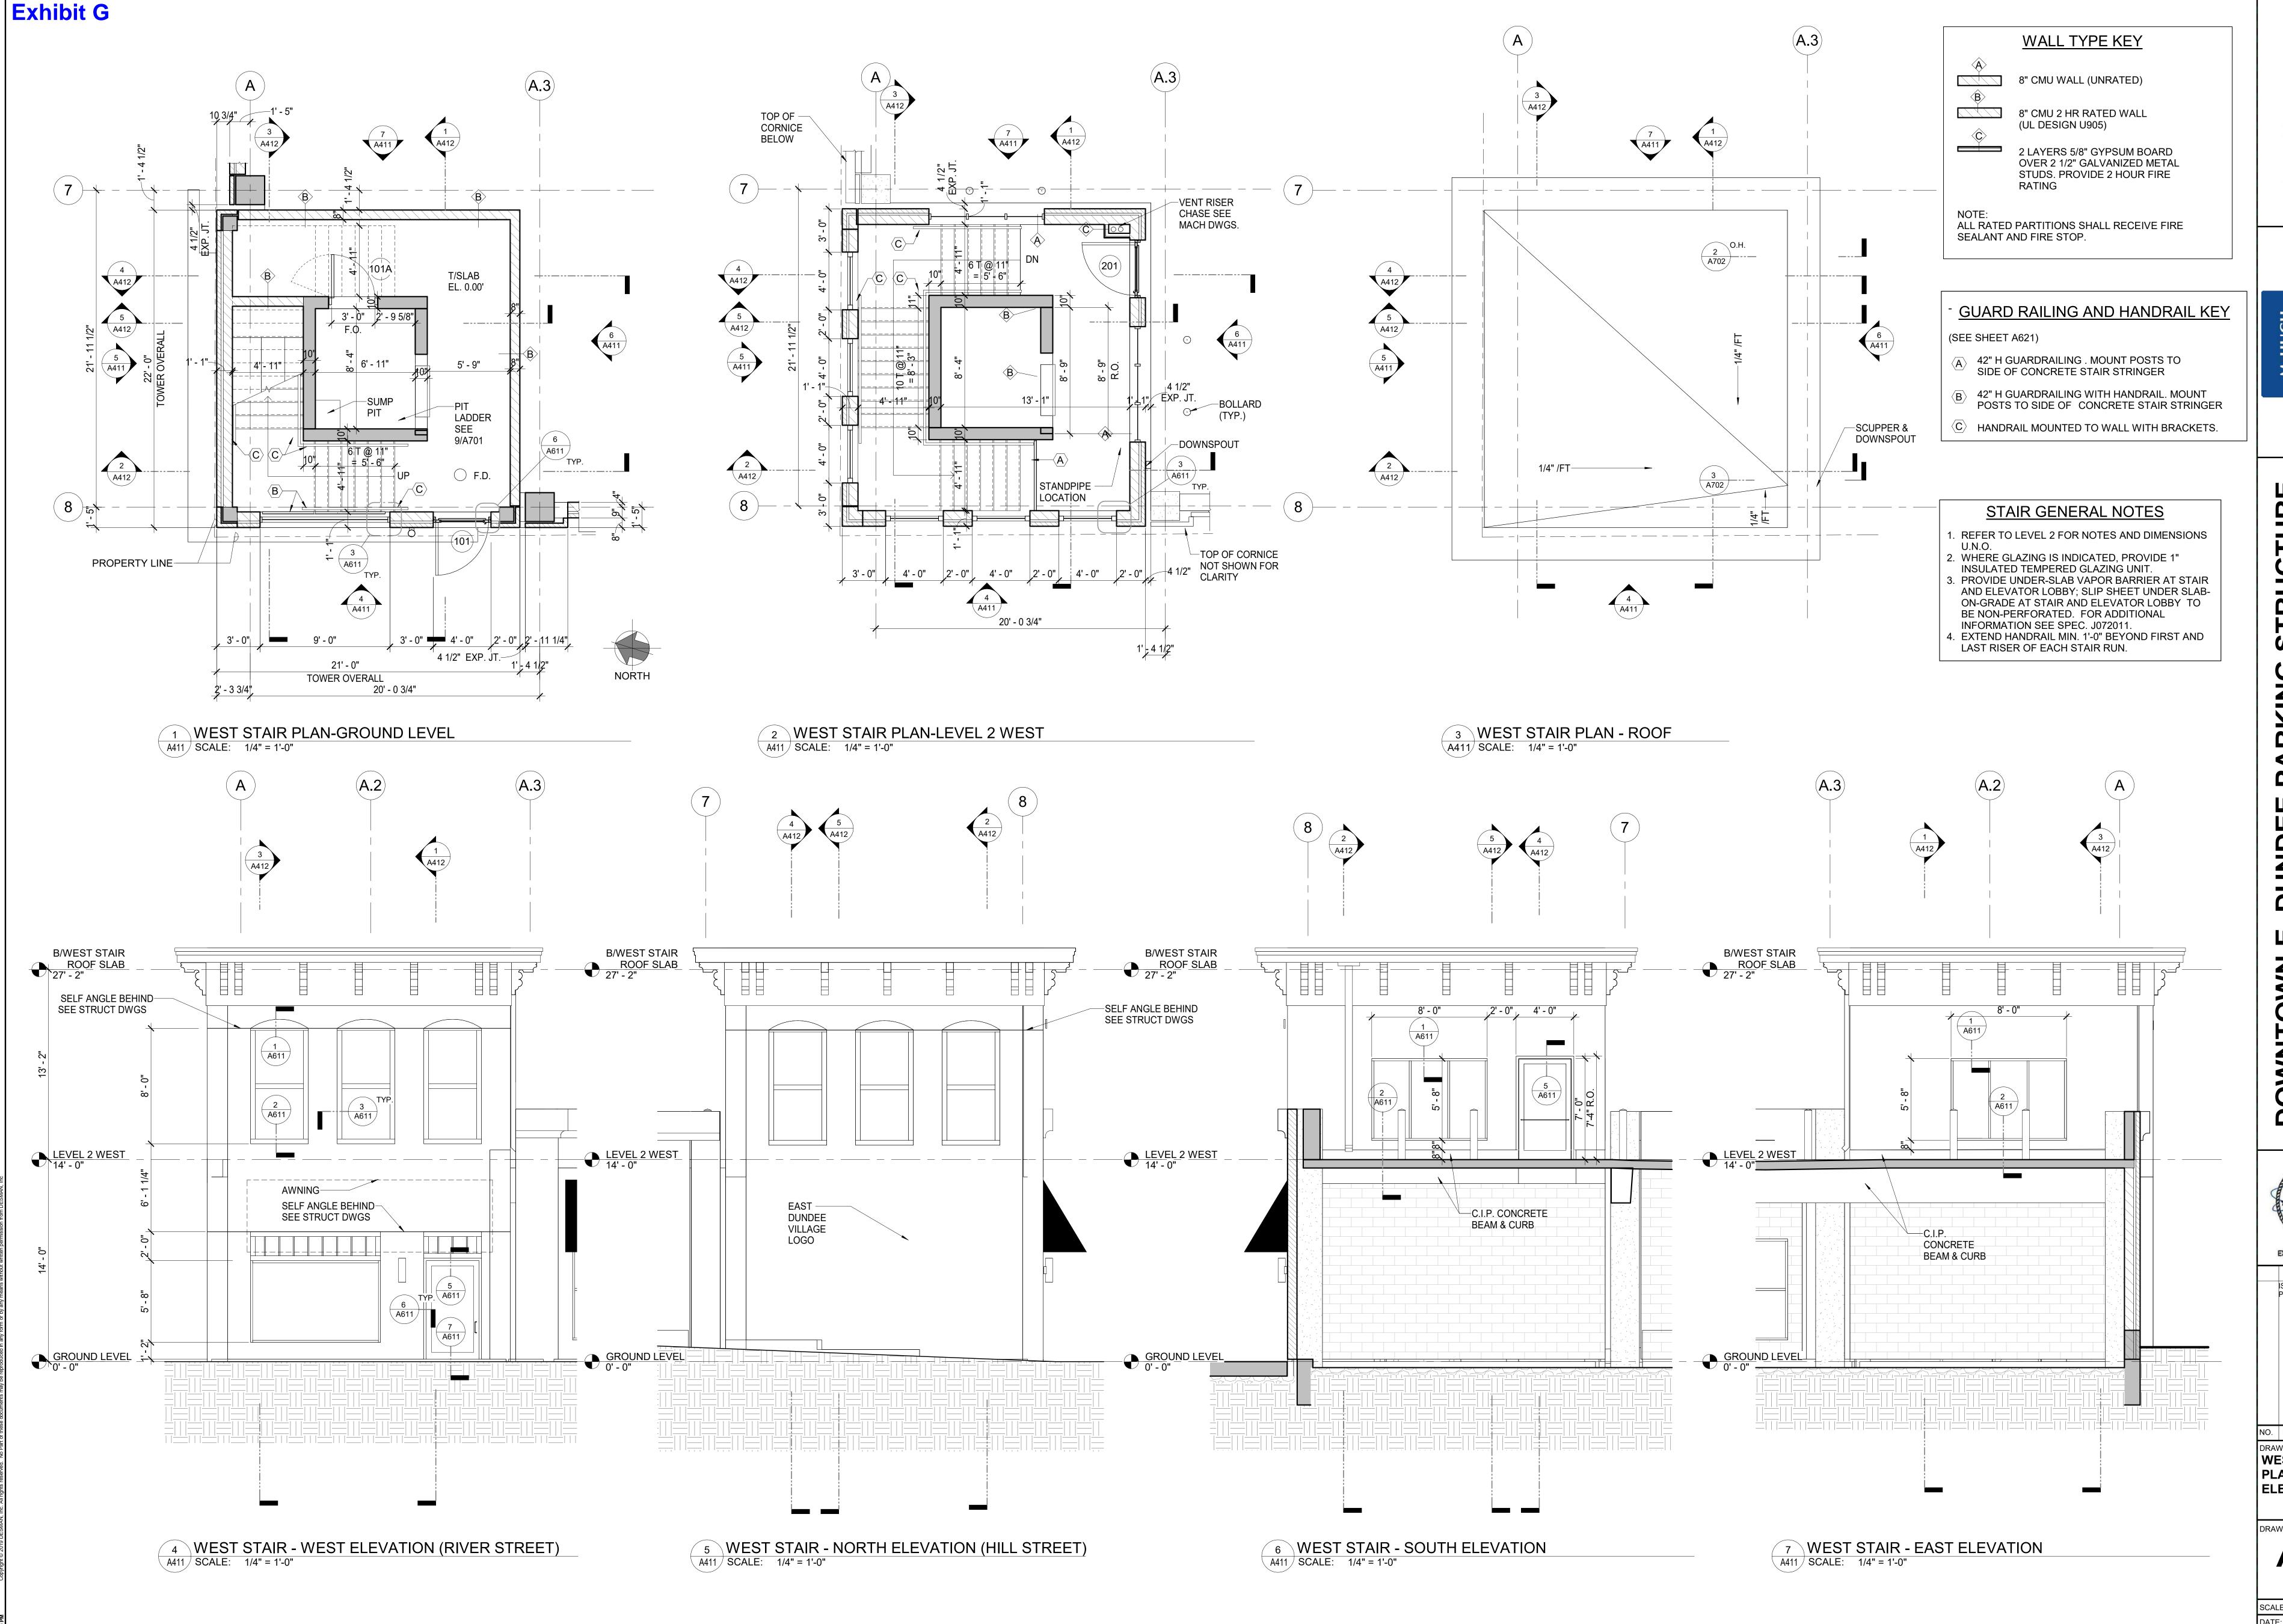

**Exhibit G - Drawings** 

EXPIRATION DATE: 11/25

ISSUE ISSUE FOR PERMIT

NO. DESCRIPTION DATE DRAWING TITLE:
WEST STAIR

PLANS & ELEVATIONS

DRAWING NO: **A411** 

SCALE: As indicated DATE: ISSUED FOR PERMIT 06-10-20 PROJECT NO: 50-24102 DES. RWN. CHK'D. Designer Author Checker



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STEPHEN AREBORA

EXPIRATION DATE: 11 25

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ISSUE FOR D6-10-24
PERMIT

NO. DESCRIPTION DATE

DRAWING TITLE:

WEST STAIR

SECTIONS

DRAWING NO:

A412

SCALE: 1/4" = 1'-0"

DATE: ISSUED FOR
PERMIT 06-10-24
PROJECT NO: 50-24102

DES. RWN. CHK'D.
Designer Author Checker

EAST STAIR
B/ROOF
29' - 0"

<u>LEVEL 1 EAST</u> 7' - 7 3/16"

4 EAST STAIR ELEVATION-GRID 2-1
A420 SCALE: 1/4" = 1'-0"

A 42" H GUARDRAILING . MOUNT POSTS TO SIDE OF CONCRETE STAIR STRINGER

(SEE SHEET A621)

—SCUPPER & DOWNSPOUT

### STAIR GENERAL NOTES

. REFER TO LEVEL 2 FOR NOTES AND DIMENSIONS


GUARD RAILING AND HANDRAIL KEY

B 42" H GUARDRAILING WITH HANDRAIL. MOUNT POSTS TO SIDE OF CONCRETE STAIR STRINGER

C HANDRAIL MOUNTED TO WALL WITH BRACKETS.

- 2. WHERE GLAZING IS INDICATED, PROVIDE 1"
  INSULATED TEMPERED GLAZING UNIT.
  3. PROVIDE UNDER-SLAB VAPOR BARRIER AT STAIR
- AND ELEVATOR LOBBY; SLIP SHEET UNDER SLAB-ON-GRADE AT STAIR AND ELEVATOR LOBBY TO BE NON-PERFORATED. FOR ADDITIONAL INFORMATION SEE SPEC. J072011.

  EXTEND HANDRAIL MIN. 1'-0" BEYOND FIRST AND
- LAST RISER OF EACH STAIR RUN.

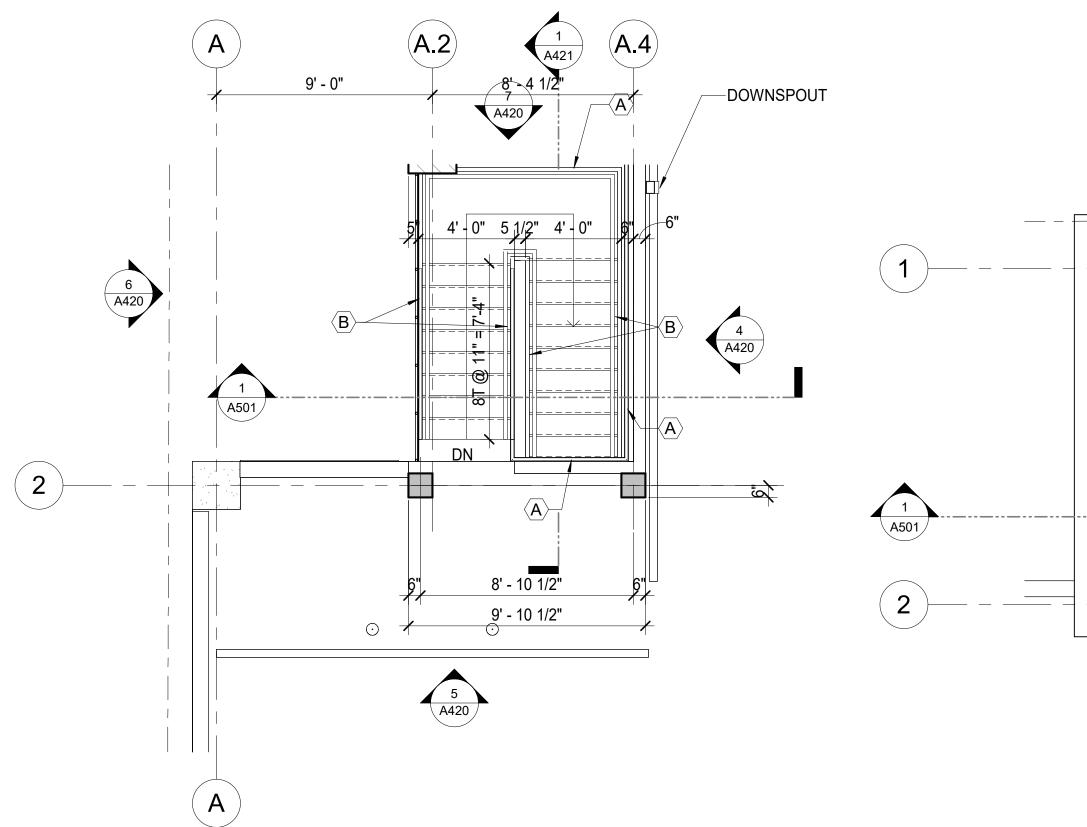


3 EAST STAIR PLAN-ROOF A420 SCALE: 1/4" = 1'-0"

1/4" /FT-----

LEVEL 2 EAST 20' - 0"

LEVEL 1 EAST 7' - 7 3/16"

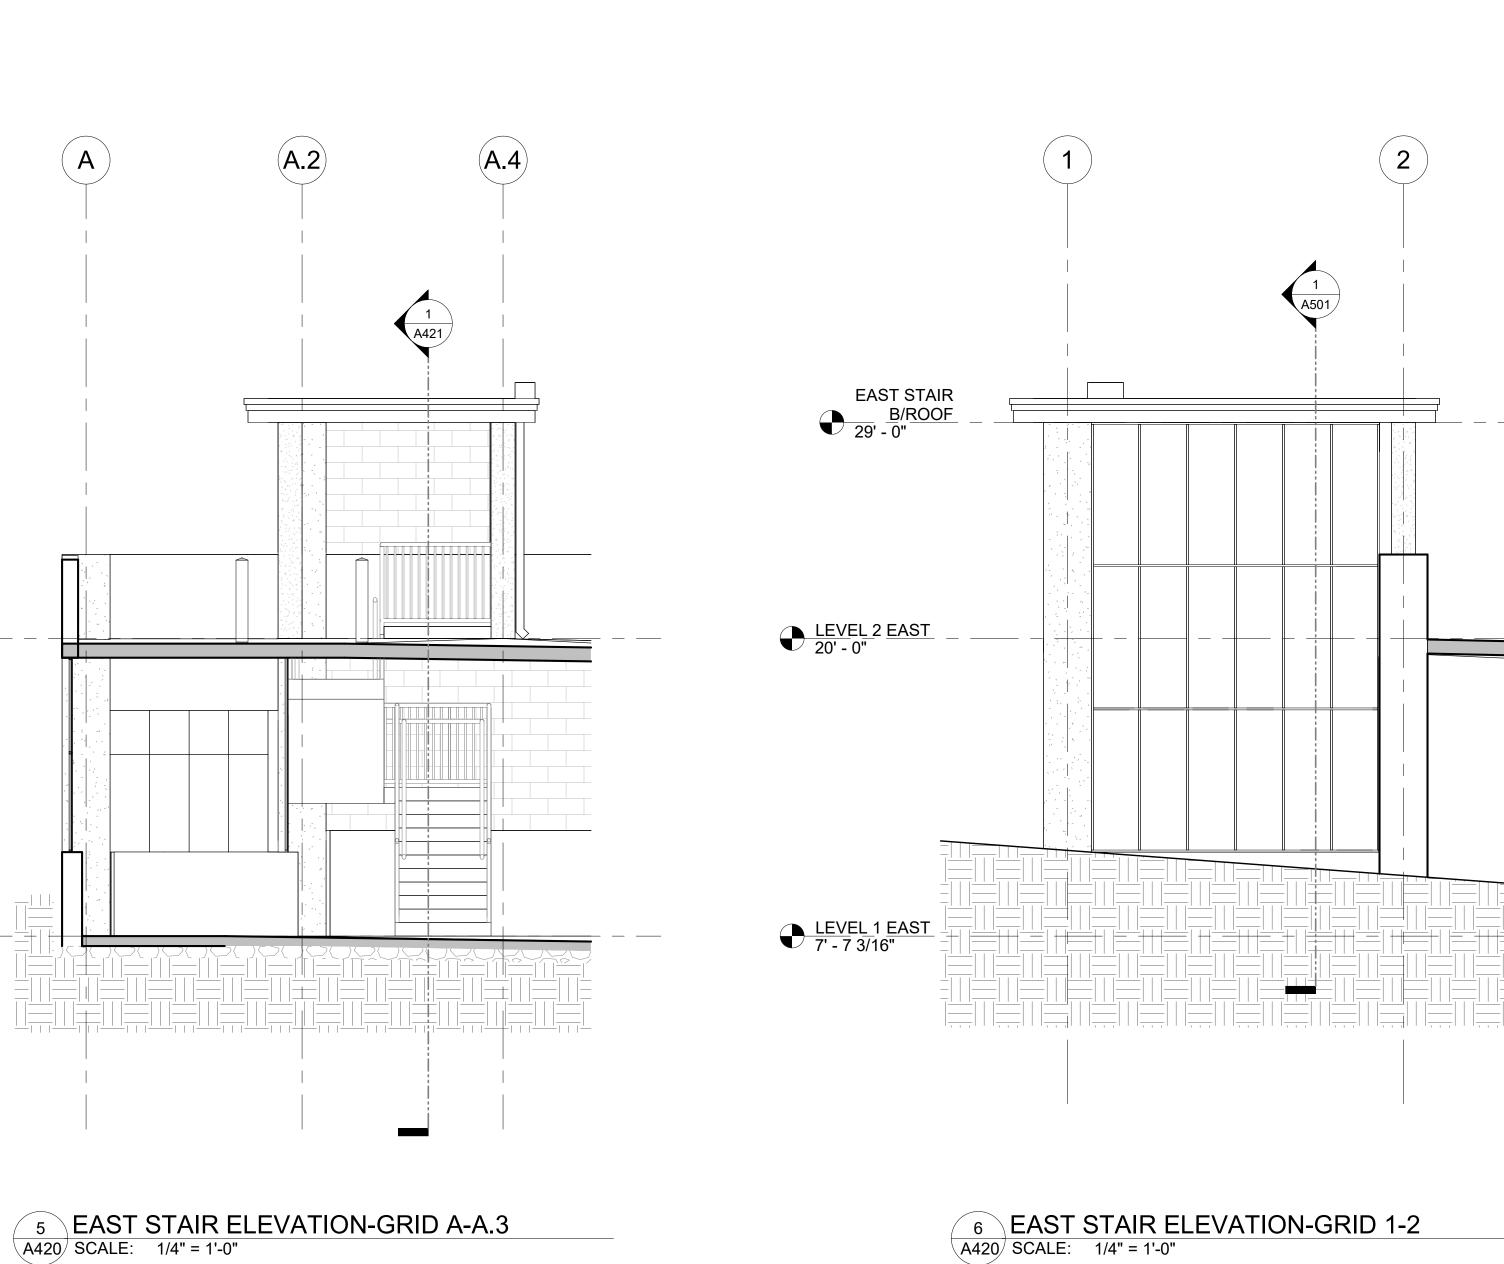

EAST STAIR
B/ROOF
29' - 0"

7 EAST STAIR ELEVATION-GRID A.3-A
A420 SCALE: 1/4" = 1'-0"

DRAWING TITLE:
EAST STAIR PLANS & ELEVATIONS DRAWING NO:


ISSUE

NO. DESCRIPTION DATE

ISSUE FOR PERMIT

**A420** SCALE: As indicated

DATE: ISSUED FOR
PERMIT 06-10-24
PROJECT NO: 50-24102 DES. RWN. CHK'D. Designer Author Checker

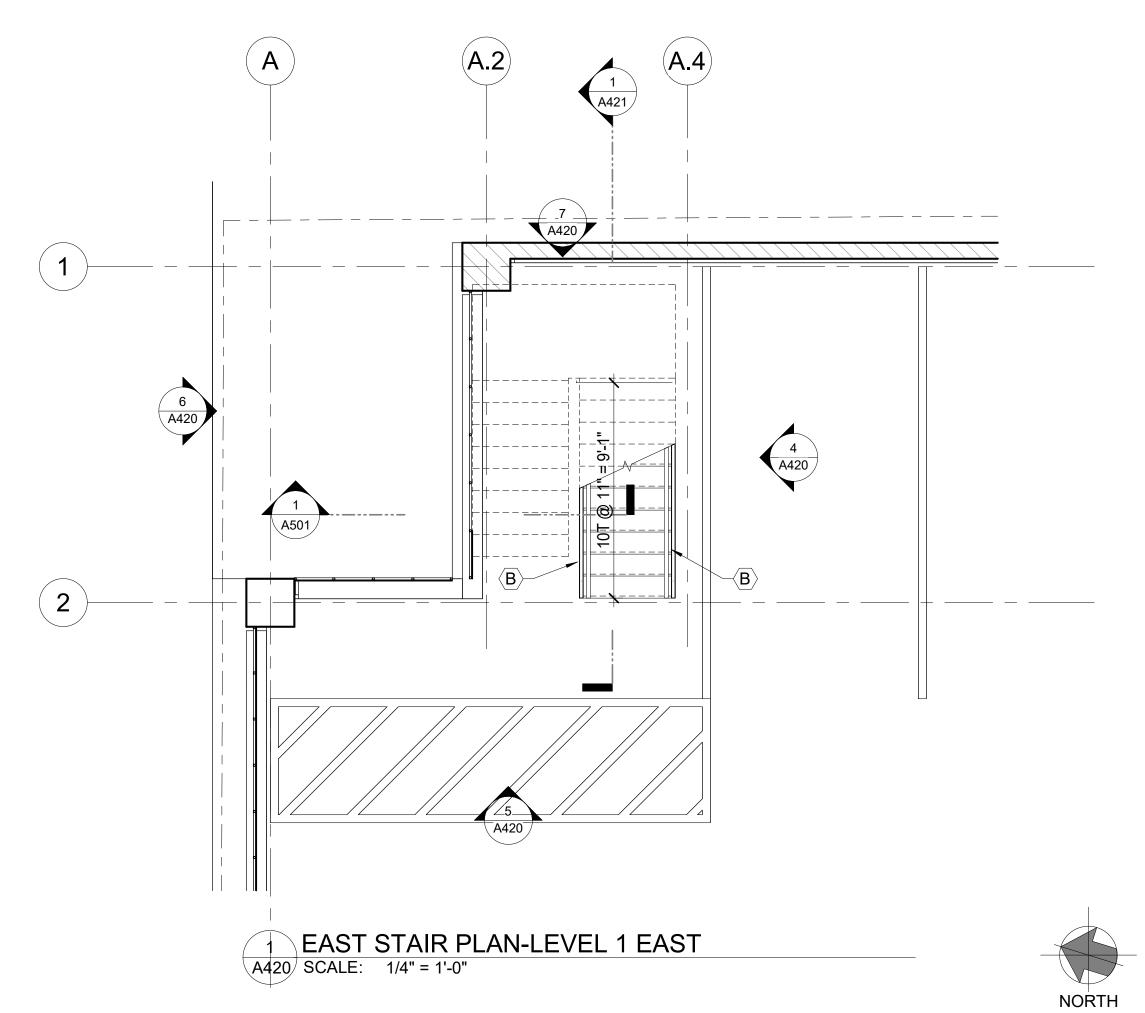



EAST STAIR
B/ROOF
29' - 0"

ISSUE FOR PERMIT

NO. DESCRIPTION DATE DRAWING TITLE:
EAST STAIR
SECTIONS

DRAWING NO: **A421** 

SCALE: 1/4" = 1'-0" DATE: ISSUED FOR
PERMIT 06-10-24
PROJECT NO: 50-24102 DES. RWN. CHK'D.
Designer Author Checker

LEVEL 2 EAST \_\_\_\_\_\_ LEVEL 1 EAST 7' - 7 3/16" 1 EAST STAIR SECTION-GRID 2-1
A421 SCALE: 1/4" = 1'-0"

NO. DESCRIPTION DATE


DRAWING TITLE:
ENLARGED
PLAN-LEVEL 1
RAMP

DRAWING NO:

SCALE: 1/4" = 1'-0"

DATE: ISSUED FOR
PERMIT 06-10-24
PROJECT NO: 50-24102

DES. RWN. CHK'D.
Designer Author Checker

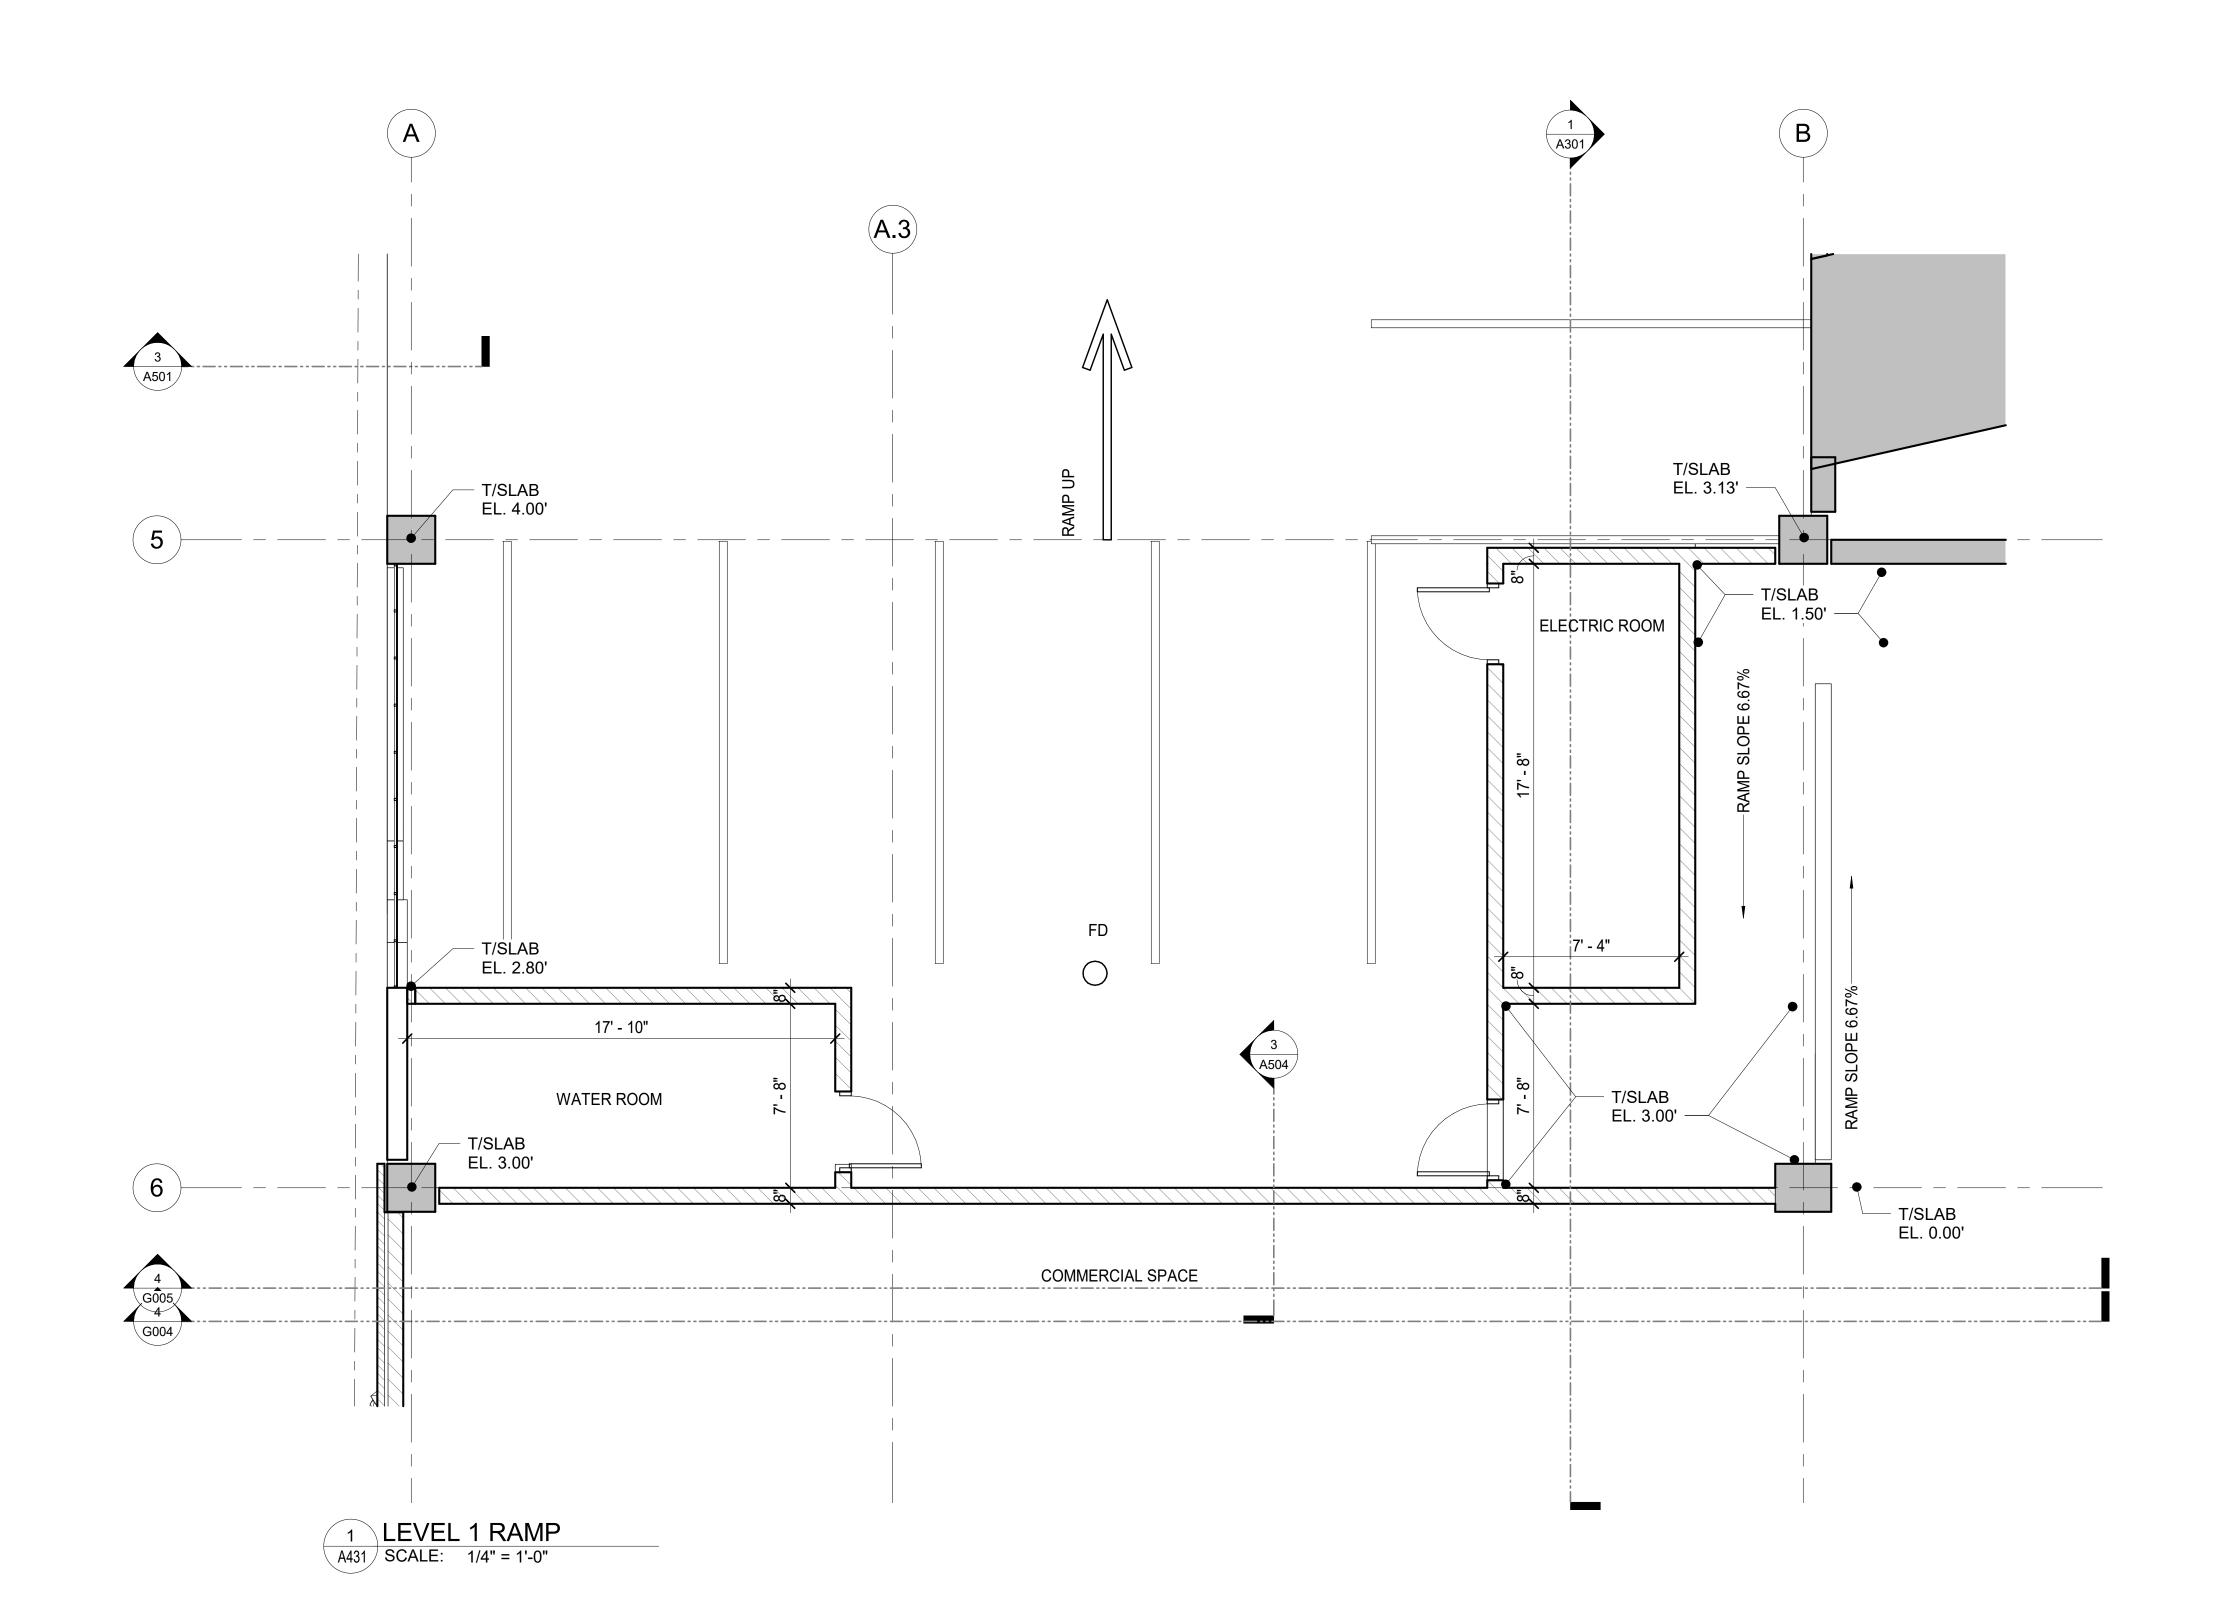

UNDEE


NO. DESCRIPTION DATE
DRAWING TITLE:
WALL SECTIONS

DRAWING NO:

SCALE: 1/2" = 1'-0"

DATE: ISSUED FOR
PERMIT 06-10-24
PROJECT NO: 50-24102

DES. RWN. CHK'D.
Designer Author Checker

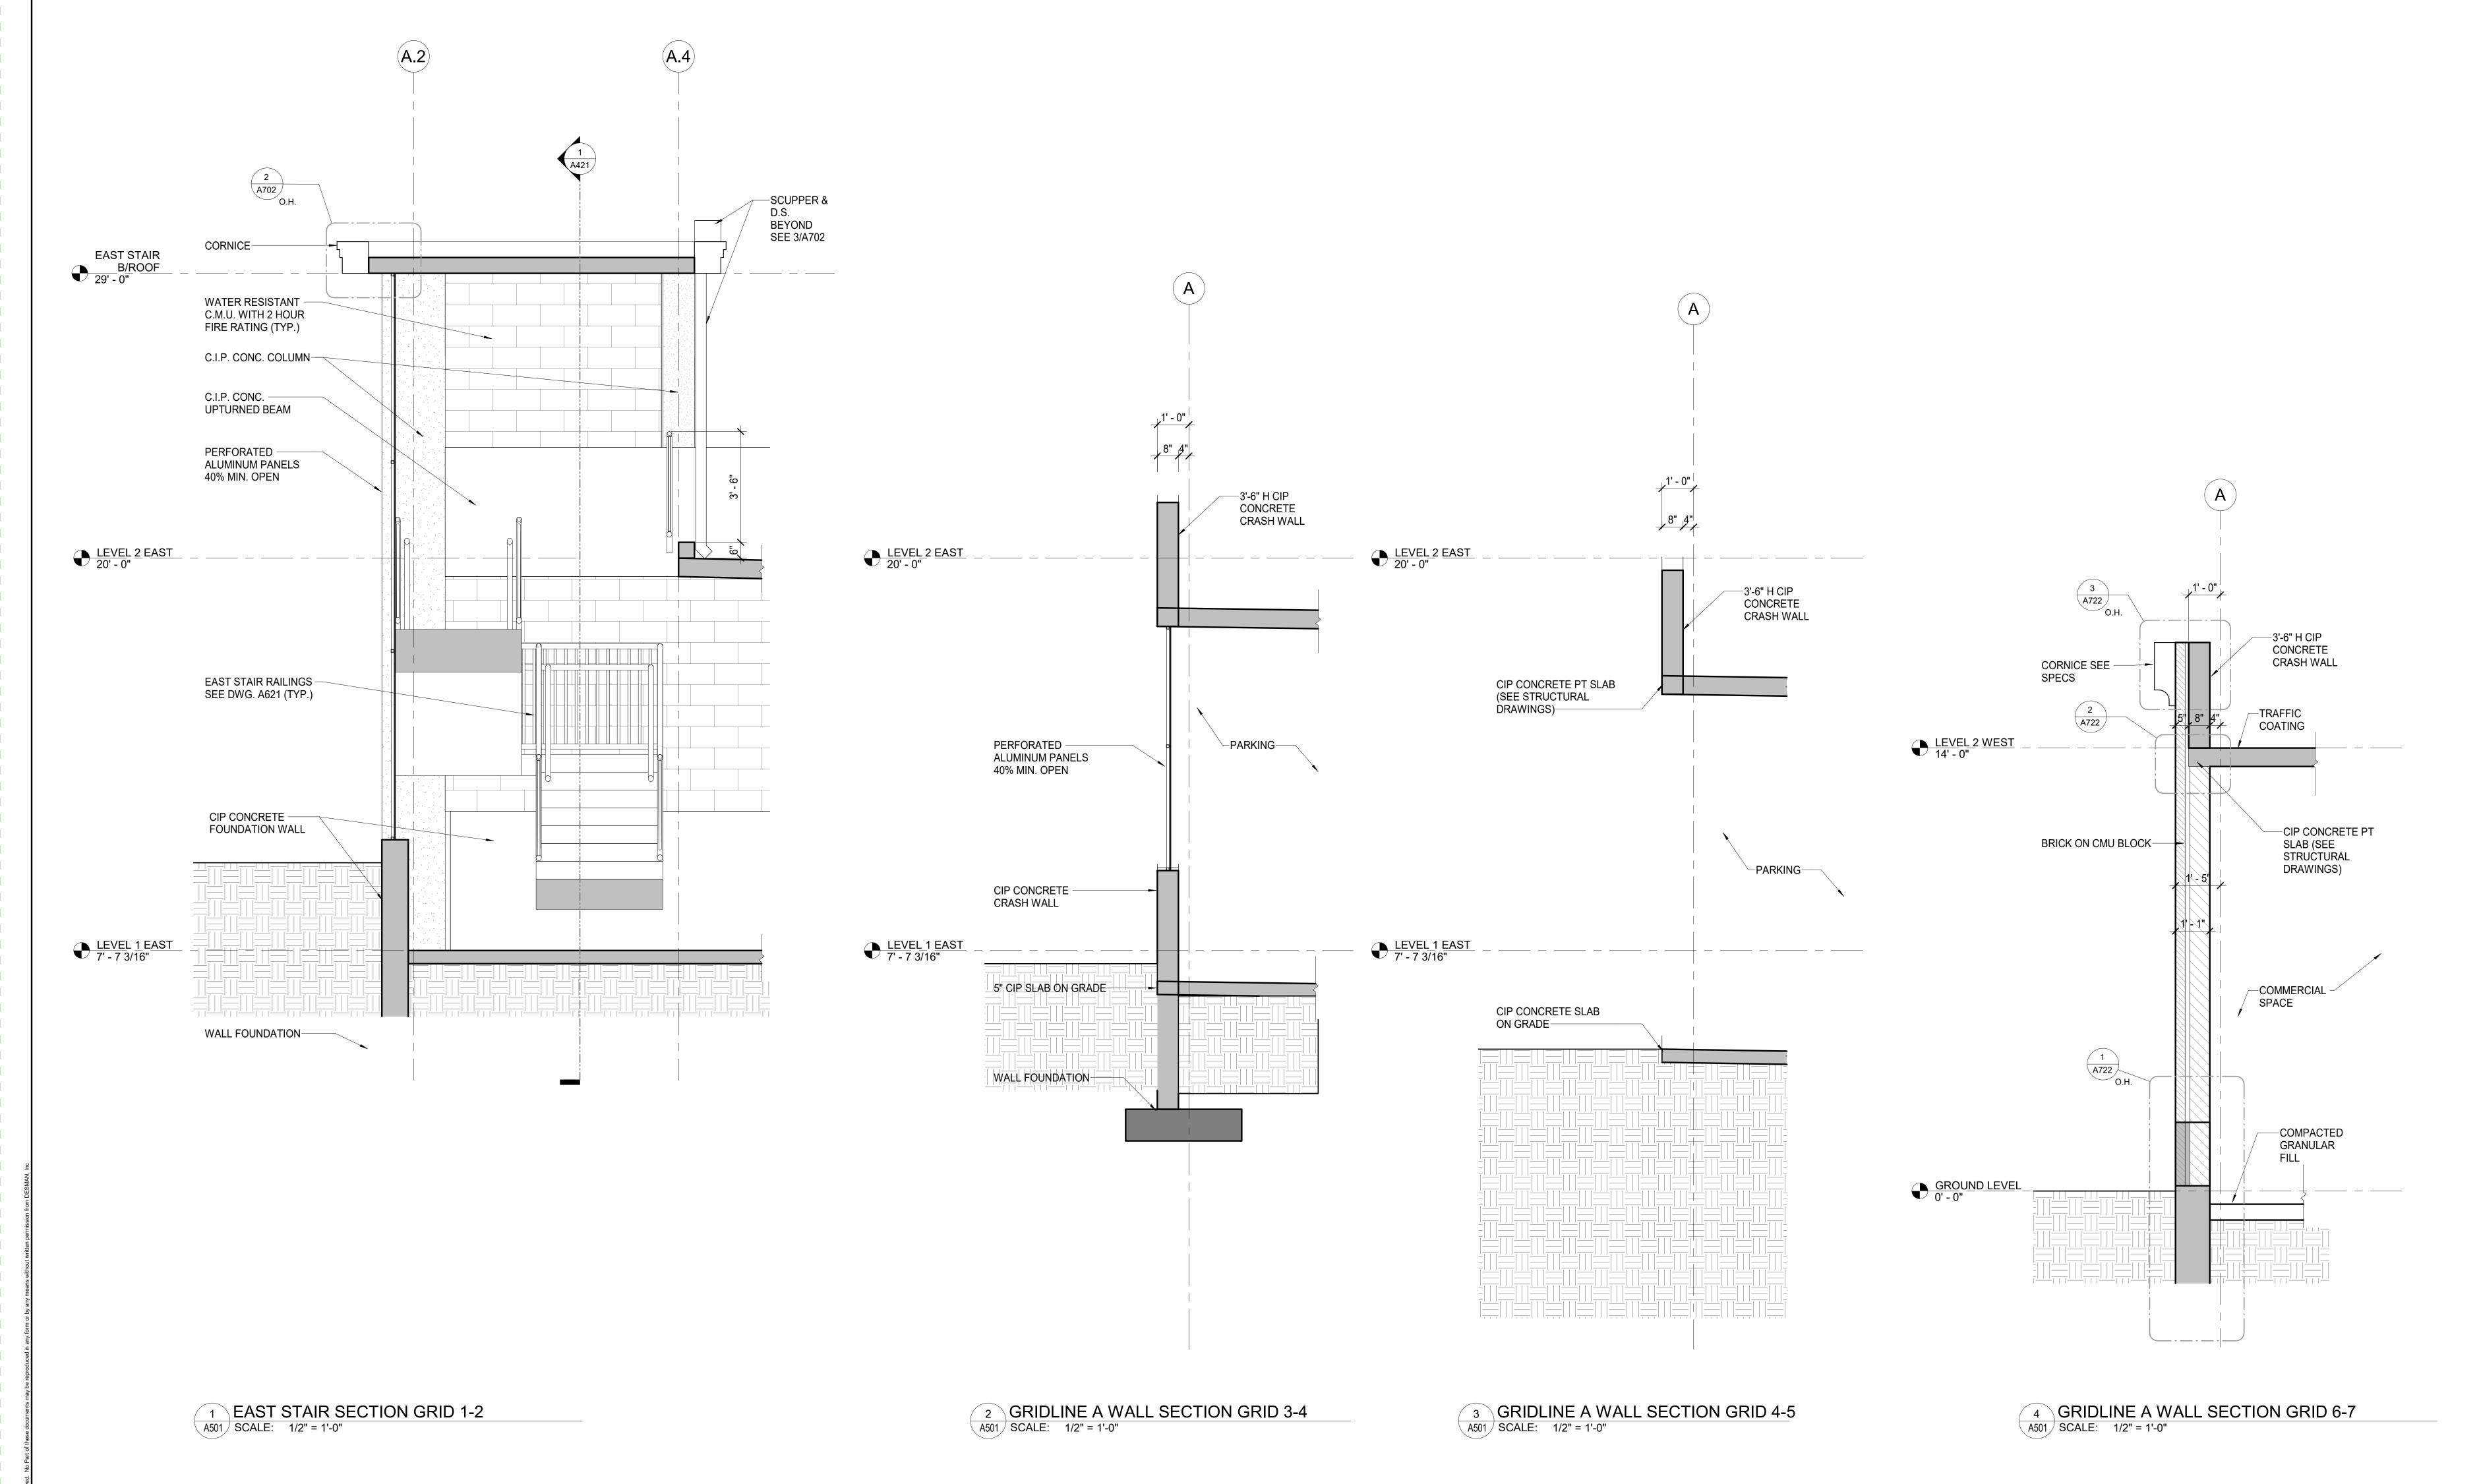

ISSUE

NO. DESCRIPTION DATE

DRAWING TITLE:


WALL SECTIONS

DRAWING NO:
A502

SCALE: 1/2" = 1'-0"

DATE: ISSUED FOR
PERMIT 06-10-24
PROJECT NO: 50-24102

DES. RWN. CHK'D.
Designer Author Checker

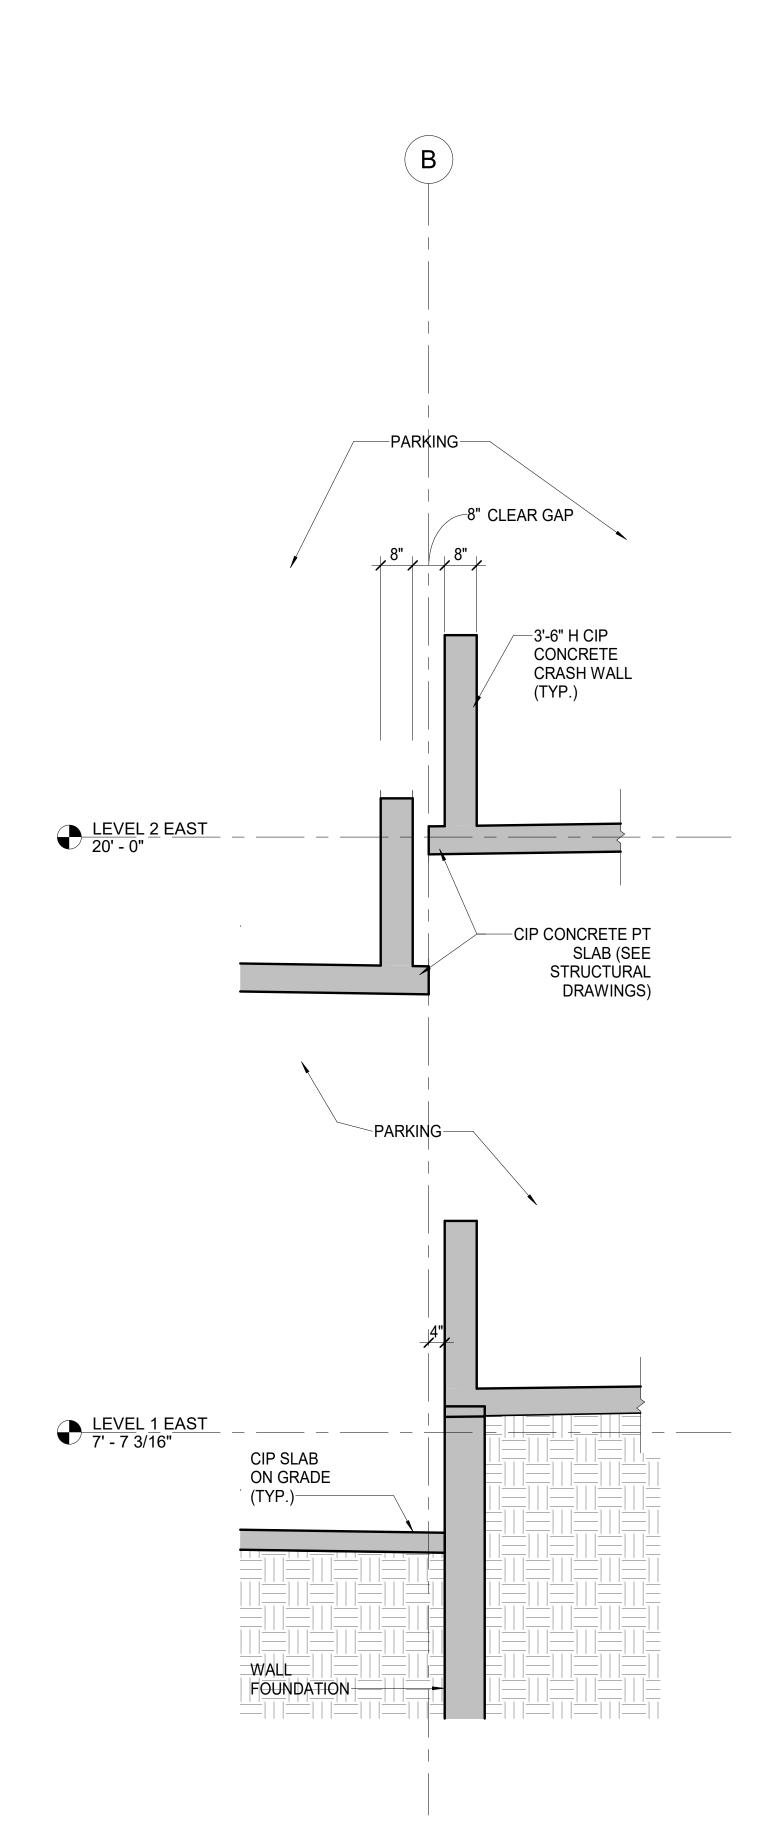

1 GRIDLINE B WALL SECTION GRID 3-4
A502 SCALE: 1/2" = 1'-0"

EXPIRATION DATE: 11/25 ISSUE ISSUE FOR PERMIT


NO. DESCRIPTION DATE DRAWING TITLE:
WALL SECTIONS

5 GRIDLINE 8 ENLARGED STOREFRONT SECTION
A503 SCALE: 1/2" = 1'-0"

DRAWING NO:

**A503** 

SCALE: 1/2" = 1'-0" DATE: ISSUED FOR
PERMIT 06-10-24
PROJECT NO: 50-24102

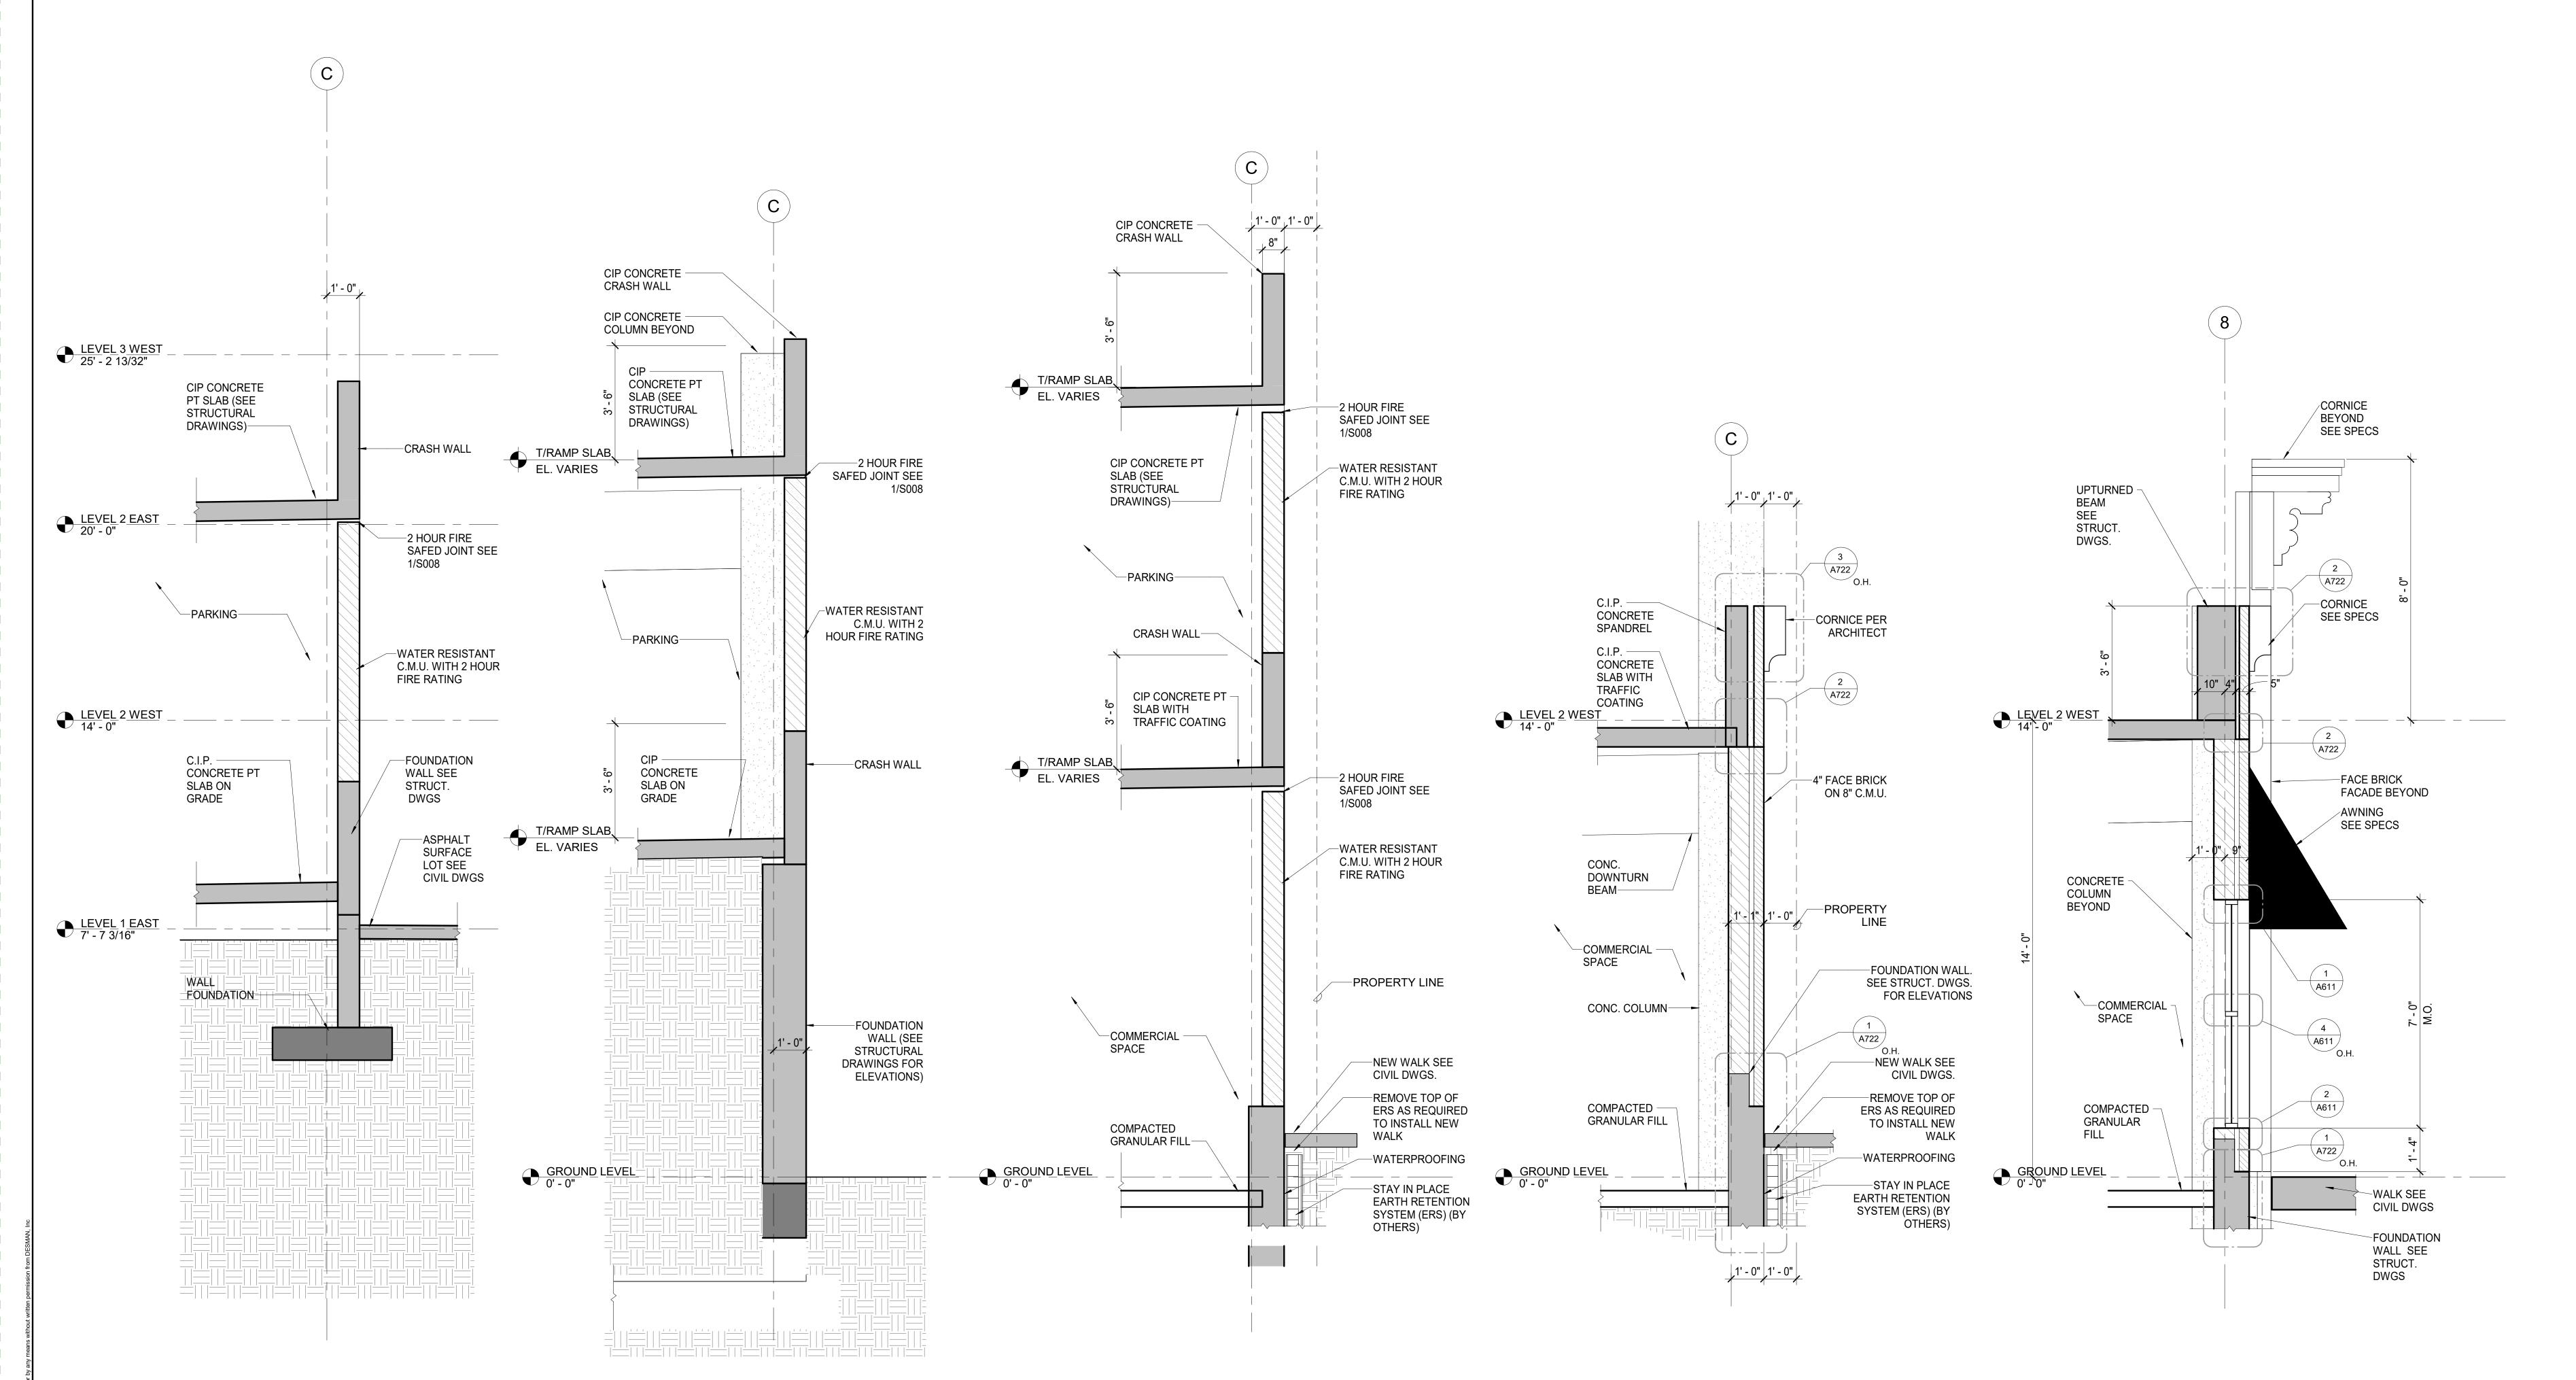

1 GRIDLINE C WALL SECTION GRID 3-4
A503 SCALE: 1/2" = 1'-0"

2 GRIDLINE C WALL SECTION GRID 4-5
A503 SCALE: 1/2" = 1'-0"

3 GRIDLINE C WALL SECTION GRID 5-6
A503 SCALE: 1/2" = 1'-0"

4 GRIDLINE C WALL SECTION GRID 6-7
A503 SCALE: 1/2" = 1'-0"

PERMIT 00-10-24

NO. DESCRIPTION DATE
DRAWING TITLE:
WALL SECTIONS

DRAWING NO:


A504

SCALE: 1/2" = 1'-0"

SCALE: 1/2" = 1'-0"

DATE: ISSUED FOR
PERMIT 06-10-24
PROJECT NO: 50-24102

DES. RWN. CHK'D.
Designer Author Checker

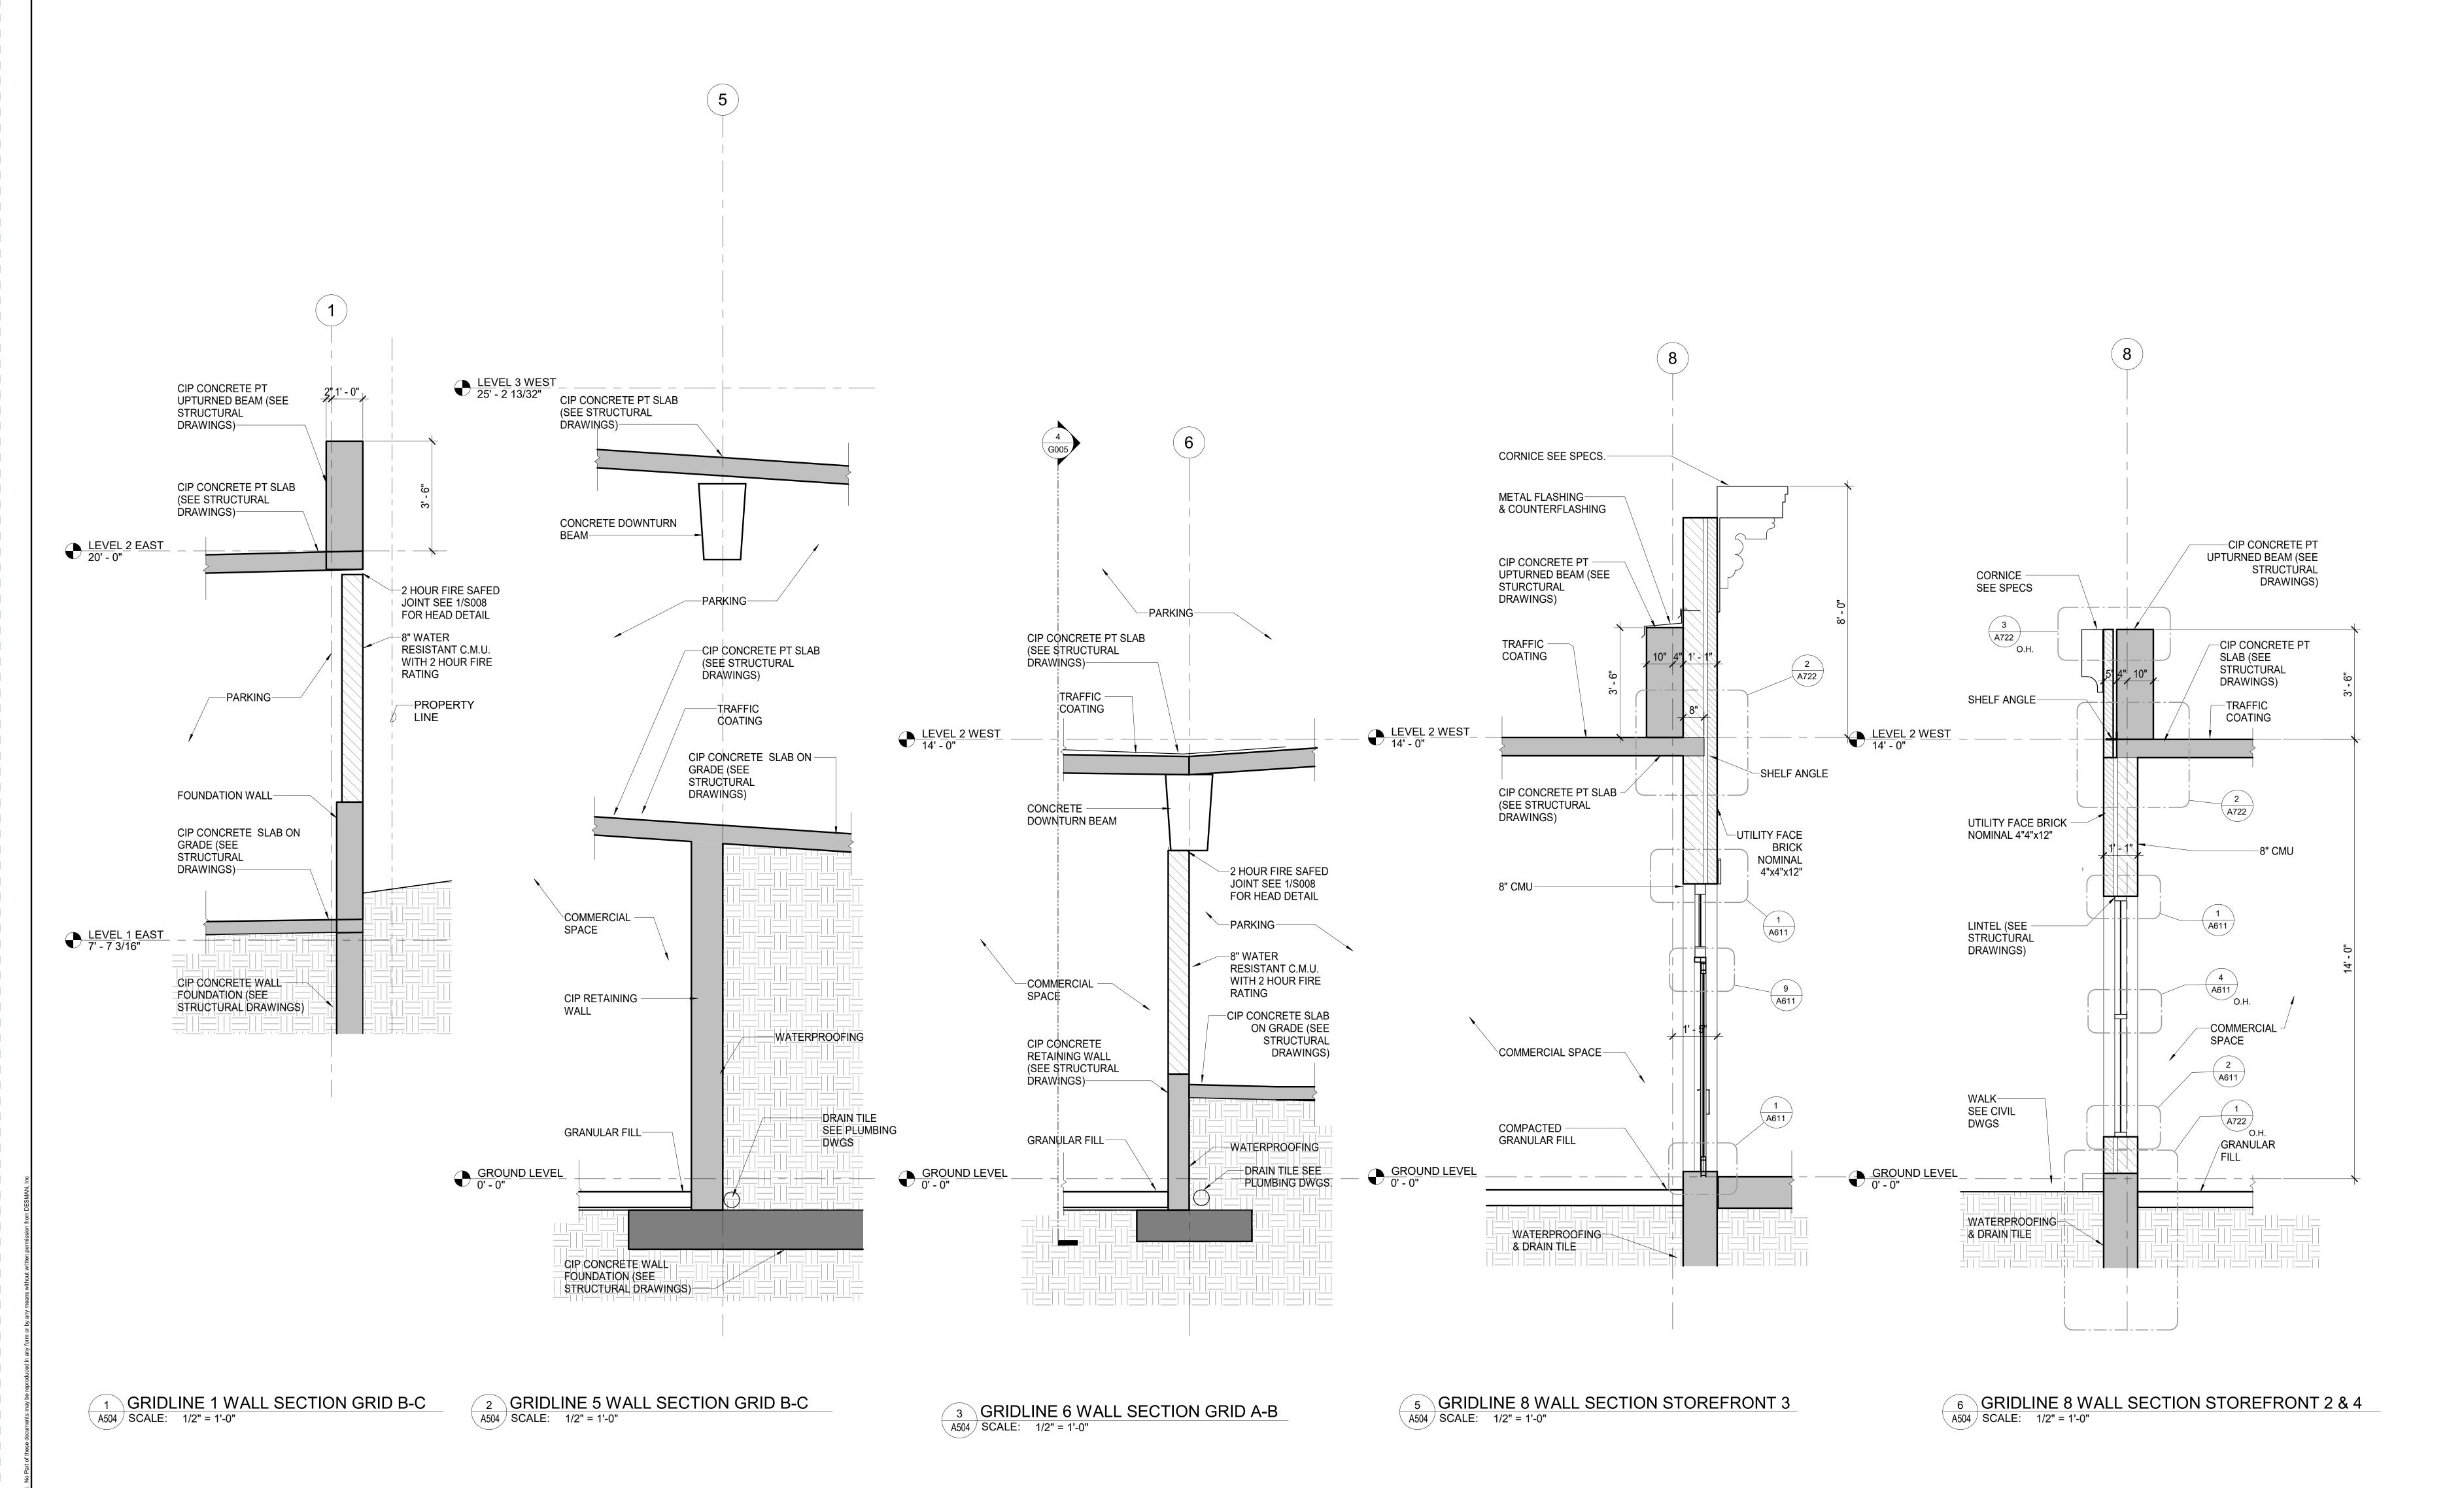

# **Exhibit G**

								DOOR S	SCHED	ULE						
		LOCATION				DOOR						FRAME				
			WIDTH									FRAME DE	TAIL SECTION	ON MARKS		
MARK	ROOM NUMBER	ROOM NAME	(INCL. FRAME)	WIDTH	HEIGHT	THICKNESS	TYPE	MATERIAL	RATING (MINUTES)	TYPE	MATERIAL	HEAD	JAMB	SILL	HARDWARE SET	COMMENTS
101	101	STAIR / ELEV	4' - 0"	4' - 0"	7' - 2"	0' - 1 3/4"	С	AL/GL	-	ALUM	ALUM	5/A611	6/A611	7/A611	HS1	
101A	101	ELEVATOR HOISTWAY	3' - 0"	3' - 0"	7' - 0"	0' - 1 3/4"	Α	HM	90	НМ	HM	5/A601	6/A601	3/A601	HS4	Door Must Open 180 degrees
102	102	COMMERCIAL	6' - 0"	6' - 0"	7' - 0"	0' - 1 3/4"	С	AL/GL	-	ALUM	ALUM	5/A611	6/A611	7/A611	HS3	
103	103	WATER ROOM	3' - 0"	3' - 0"	7' - 0"	0' - 1 3/4"	Α	HM	45	HM	HM	5/A601	6/A601	3/A601	HS4	
104	104	ELECTRICAL ROOM	3' - 0"	3' - 0"	7' - 0"	0' - 1 3/4"	В	HM	45	HM	HM	5/A601	6/A601	3/A601	HS4	
105	105	HALL	3' - 0"	3' - 0"	7' - 0"	0' - 1 3/4"	Α	HM	45	НМ	HM	5/A601	6/A601	3/A601	HS4	
201	201	STAIR/ELEV	4' - 0"	4' - 0"	7' - 2"	0' - 1 3/4"	С	AL/GL	-	ALUM	ALUM	5/A611	6/A611	7/A611	HS2	
x45			3' - 0"		7' - 0"	0' - 1 3/4"	Α		45			5/A601	6/A601	3/A601	(none)	

		ROOM F	INISH S	CHEDU	ILE			
ROOM NUMBER	ROOM NAME	FLOOR MATERI AL	Floor Finish	BASE FINISH	WALL MATERI AL	WALL FINISH	CEILING MATERI AL	CEILING FINISH
101	WEST STAIR/ELEVATOR	Concrete - Cast-in-Plac e	SEA	-		-		-
102	COMMERCIAL SPACE		SEA	-		-		-
103	WATER ROOM		SEA	-		-		-
104	ELECTRICAL RM.		SEA	-		-		-
105	NORTH PARKING		SEA	-		-		-
106	SOUTH PARKING		SEA	-		-		-
201	WEST STAIR/ELEVATOR		SEA	-		-		-
202	NORTH PARKING		SEA	-		-		-
203	SOUTH PARKING		SEA	-		-		-
204	Room							
205	Room							
206	Room							
207	Room							
208	Room							
209	Room							
210	Room							
211	Room							
212	Room							
213	Room							
214	Room							

<b>ROOM</b>	FIN	SHE	

ALUM ALUMINUM ASSEMBLIES AL/GL ALUM & GLASS ANOD ANODIZED

CIP CAST-IN-PLACE CONCRETE CMU CONCRETE MASONRY UNIT CO/CM PARTIAL CONC AND CMU CO/PC PARTIAL CONC AND PCC

GB FIBERGLASS REINFORCED GYP.BD. GL/CM PARTIAL AL/GL AND CMU GL/CO PARTIAL AL/GL AND CONC

GL/PC PARTIAL AL/GL AND PCC

HM HOLLOW METAL


PCC PRECAST CONCRETE PC/CM PARTAIL PCC AND CMU PT PAINTED


SEA SEALED SOG SLAB ON GRADE


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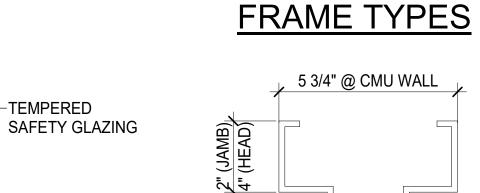
NOTE: REFER TO SPECIFICATION SECTIONS 08 70 00 AND 08 51 13 FOR FURTHER INFORMATION ON HARDWARE.

# **DOOR TYPES**



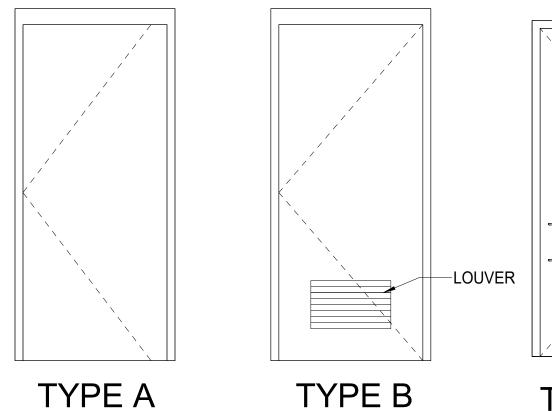


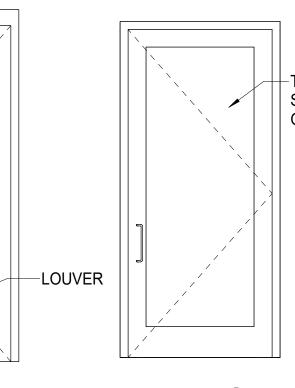

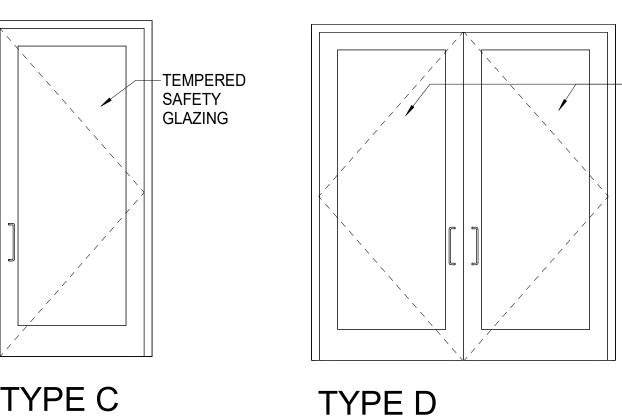


5 3/4" @ CMU WALL


FRAME TYPE F1

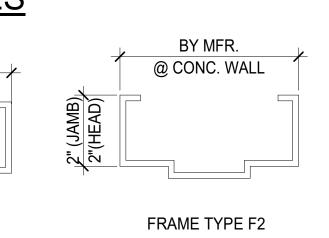


TYPE B TYPE C

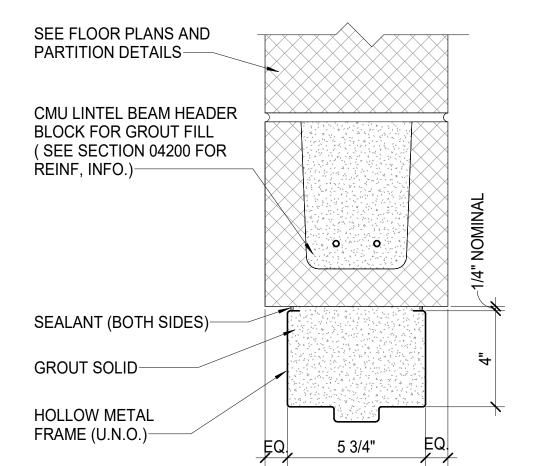




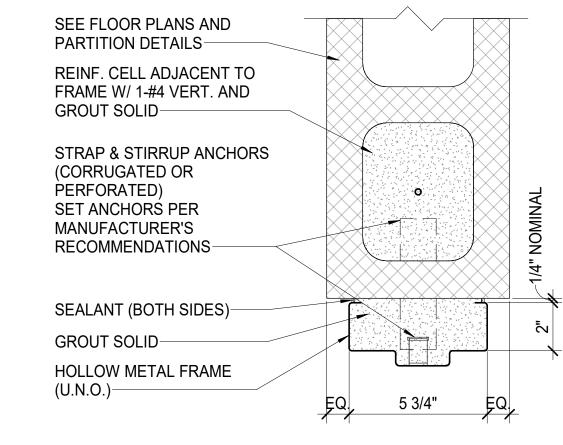




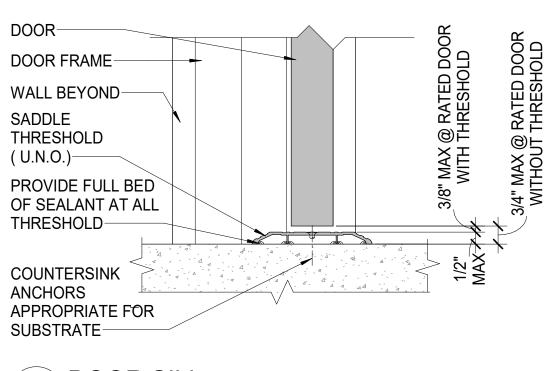




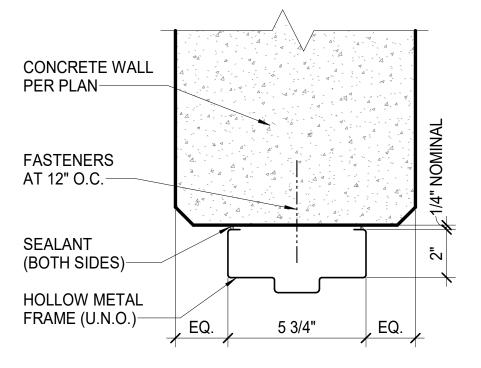




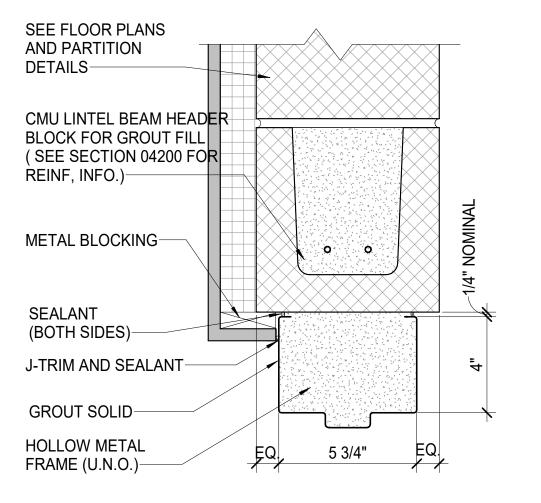





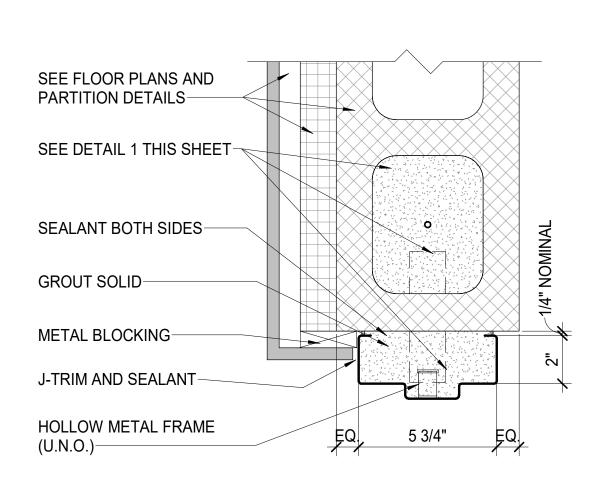

6 DOOR JAMB AT CMU WALL W/ FURRING A601 SCALE: 3" = 1'-0"

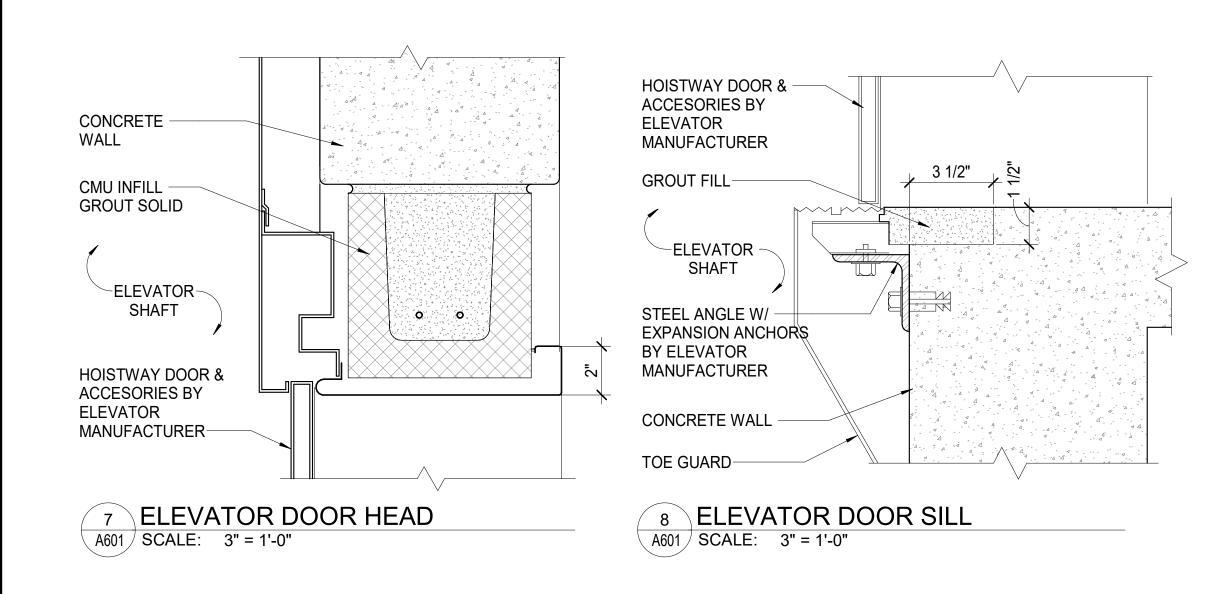

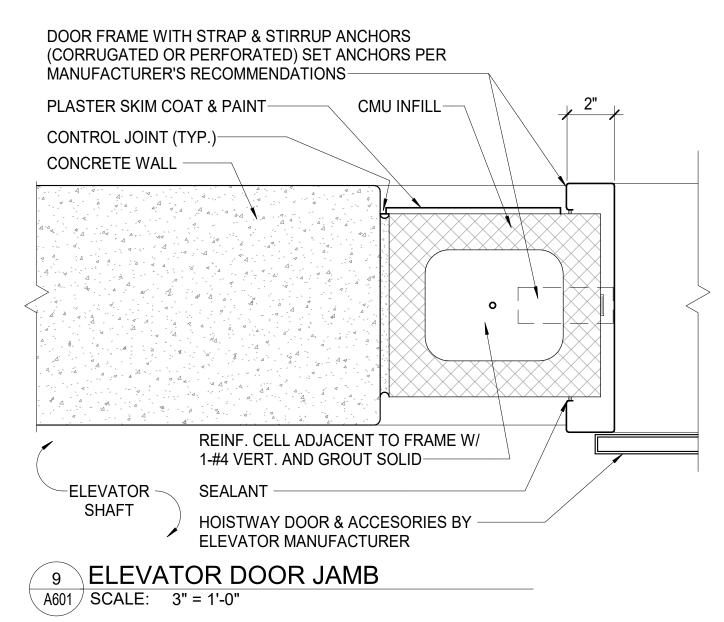

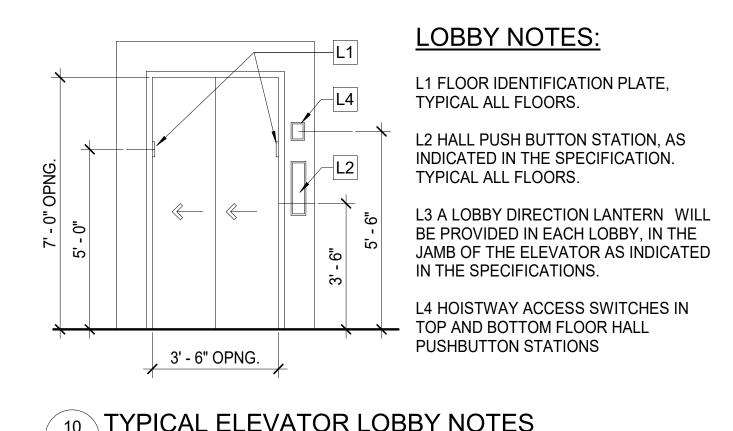

10 TYPICAL ELEVATOR LOBBY NOTES A601 SCALE: NOT TO SCALE

NO. DESCRIPTION DATE DRAWING TITLE: DOOR SCHEDULES AND DETAILS

DRAWING NO: A601

SCALE: As indicated DATE: ISSUED FOR PERMIT 06-10-24 PROJECT NO: 50-24102 RWN. CHK'D.

Designer Author Checker



**Exhibit G** 1' - 1" FLEXIBLE FLASHING, METAL TERMINATION BAR AND 8" C.M.U. LINTEL -SEALANT (TO BE SHOWN ) **BLOCK SEE** 1 3/4", 3 5/8" 7 5/8" STRUCT. DWGS. AIR GAP FOR REINFORCING -UTILITY FACE BRICK GALV. L6x4x7/16" CONT. STEEL SHELF ANGLE ATTACHED TO

C.M.U. LINTEL BLOCK WITH 5/8" DIA. HILTI KWIK BOLT TZ EXP. ANCHORS @ 1'-6" O.C. (4" MIN. EMBEDMENT) (TO BE SHOWN) -SHIM, BACKER ROD & SEALANT BOTH SIDES -ALUMINUM STOREFRONT SYSTEM -1" INSULATING GLAZING AT ALL COMMERCIAL STOREFRONTS (SHOWN) 1/4" SINGLE PANE GLAZING AT 4 1/2" ALL WEST STAIR

STOREFRONTS


1 TYPICAL STOREFRONT HEAD DETAIL A611 SCALE: 3" = 1'-0"

-1" INSULATING GLAZING AT ALL COMMERCIAL STOREFRONTS (SHOWN) 1/4" SINGLE PANE GLAZING AT ALL WEST STAIR STOREFRONTS -ALUMINUM STOREFRONT SYSTEM -1/2" SHIM, BACKER ROD & SEALANT BOTH SIDES BOTH SIDES -CAST STONE SILL -1/2" DRIP 8" C.M.U.--UTILITY FACE 1 3/4" 3 5/8" **BRICK** 7 5/8" ÁIR GÁP 1' - 1"


2 TYPICAL STOREFRONT SILL DETAIL A611 SCALE: 3" = 1'-0"


-1" INSULATING GLAZING AT ALL COMMERCIAL STOREFRONTS (SHOWN) 1/4" SINGLE PANE GLAZING AT ALL WEST STAIR STOREFRONTS ∠CMU **BLOCK** ALUMINUM STOREFRONT SYSTEM-SHIM, BACKER ROD & SEALANT BOTH SIDES BOTH SIDES—


3 TYPICAL STOREFRONT JAMB DETAIL A611 SCALE: 3" = 1'-0"

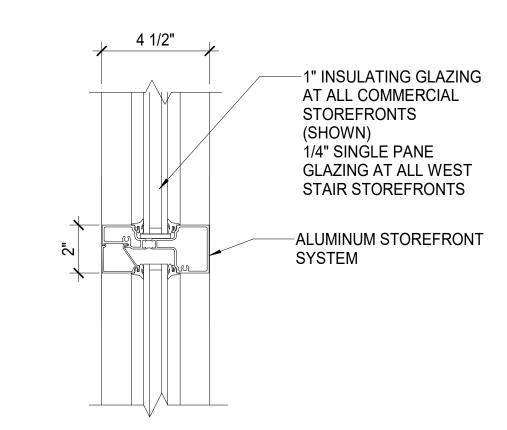


4 TYPICAL STOREFRONT INTERMEDIATE MULLION DETAIL A611 SCALE: 3" = 1'-0"

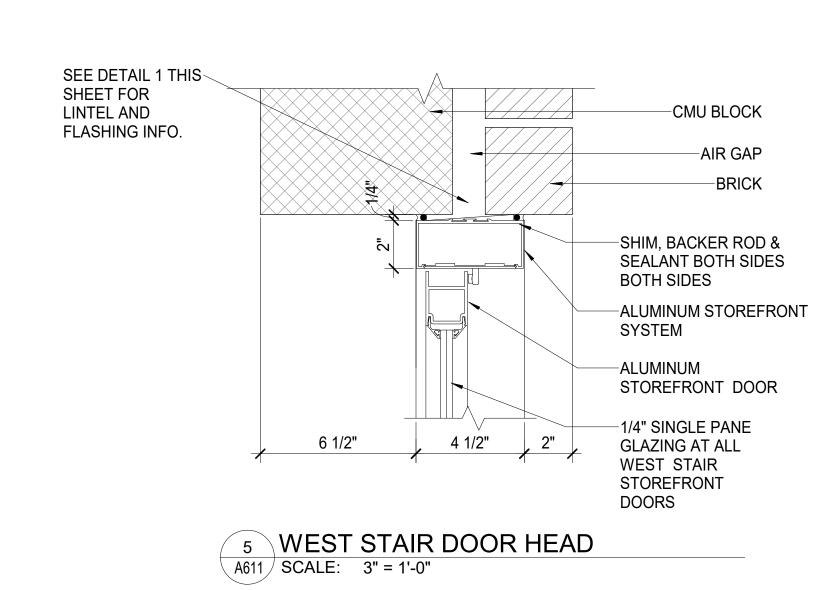

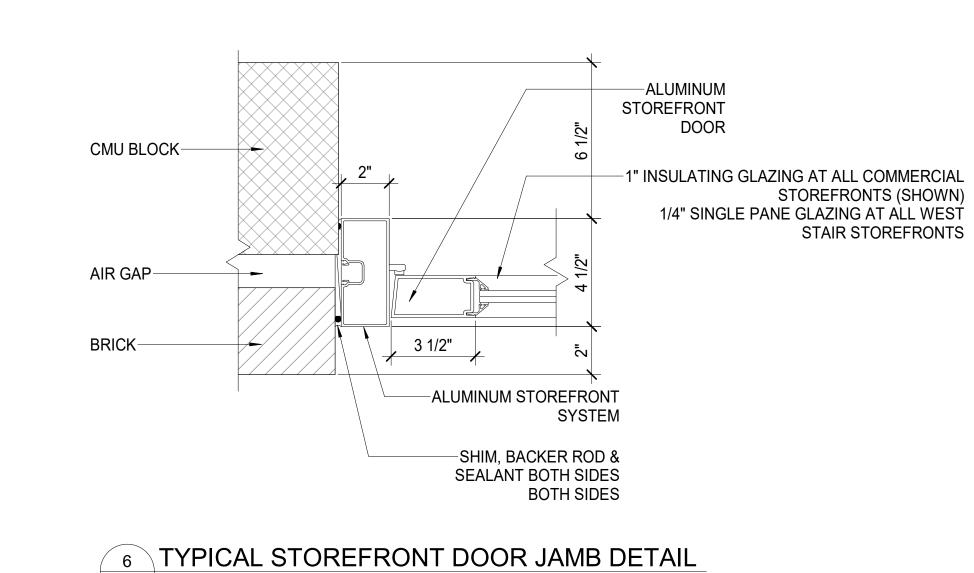


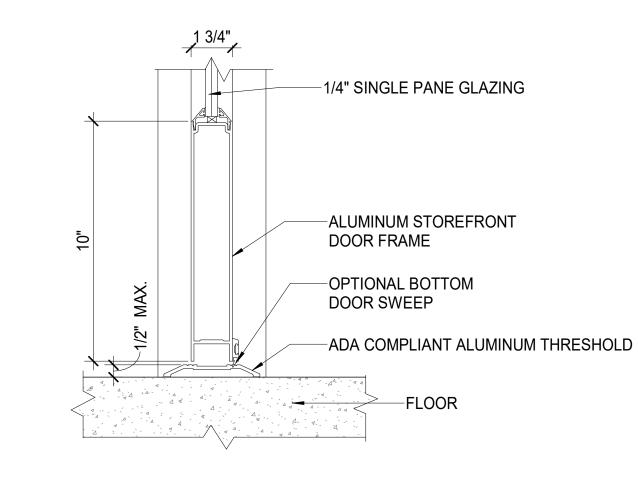




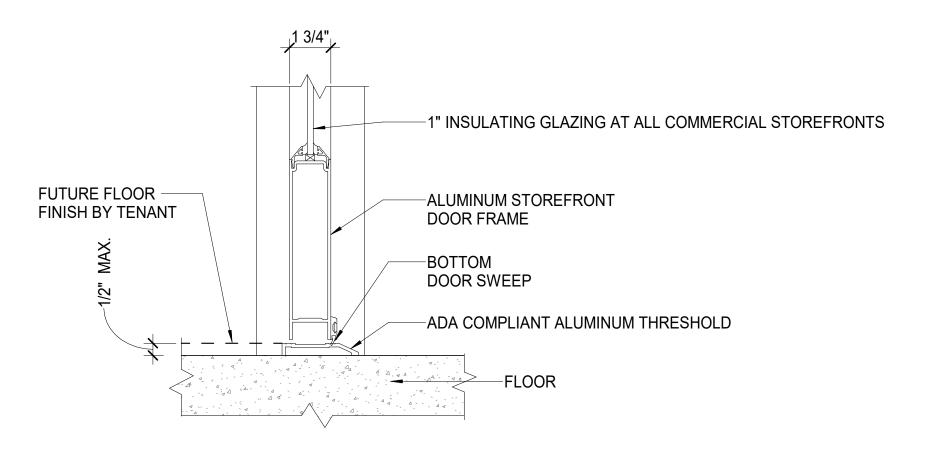


8 DOOR SILL DETAIL AT COMMERCIAL SPACE
A611 SCALE: 3" = 1'-0"

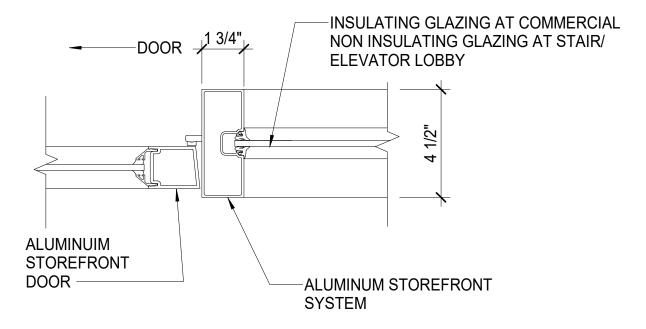

9 DOOR JAMB OR HEAD TO STOREFRONT DETAIL A611 SCALE: 3" = 1'-0"

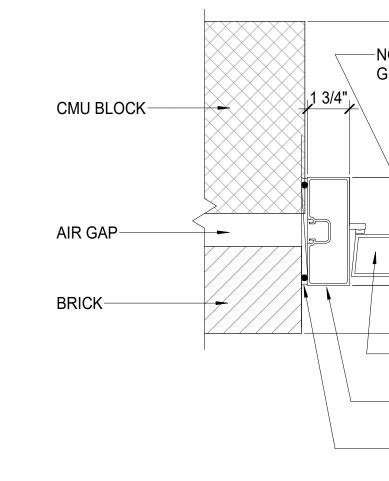

16 STOREFRONT 1/4" DOOR JAMB A611 SCALE: 3" = 1'-0"

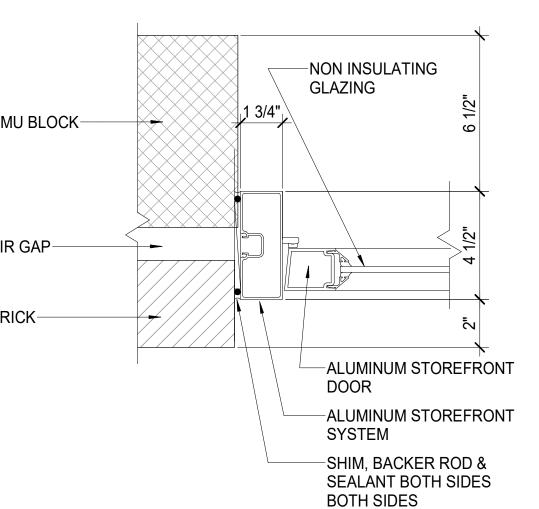

DRAWING TITLE: STOREFRONT DETAILS

NO. DESCRIPTION DATE

EXPIRATION DATE: 11/25


ISSUE

ISSUE FOR

DRAWING NO:

A611 SCALE: 3" = 1'-0"


DATE: ISSUED FOR PERMIT 06-10-24 PROJECT NO: 50-24102 DES. RWN. CHK'D. Designer Author Checker

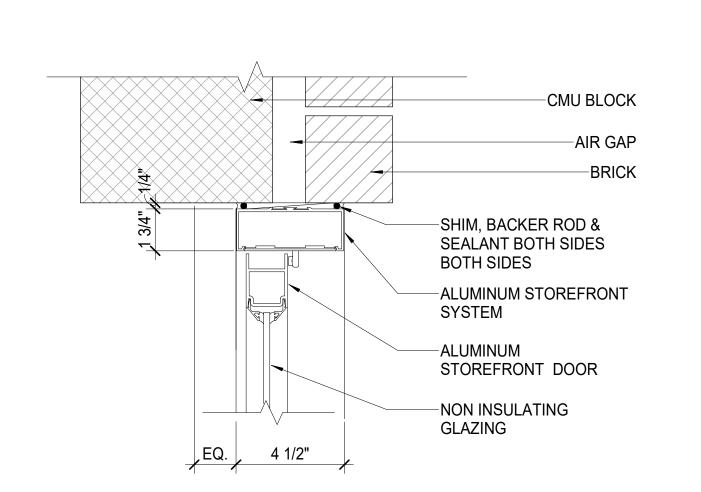


A611 SCALE: 3" = 1'-0"


14 STOREFRONT 1/4" DOOR HEAD A611 SCALE: 3" = 1'-0"

TYPICAL GUARDRAIL/HANDRAIL PLAN @ OFFSET RISER A621 SCALE: 3/4" = 1'-0"

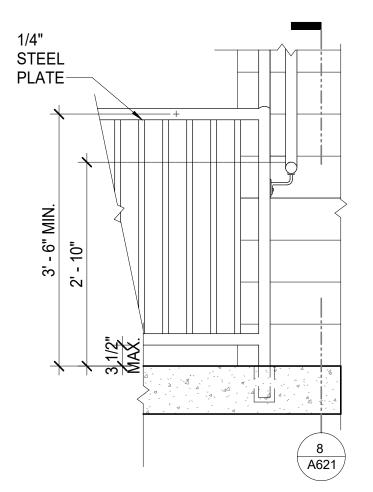

TYPICAL GUARDRAIL/HANDRAIL 7 ELEVATION @ BOT. OF STAIR
A621 SCALE: 3/4" = 1'-0"

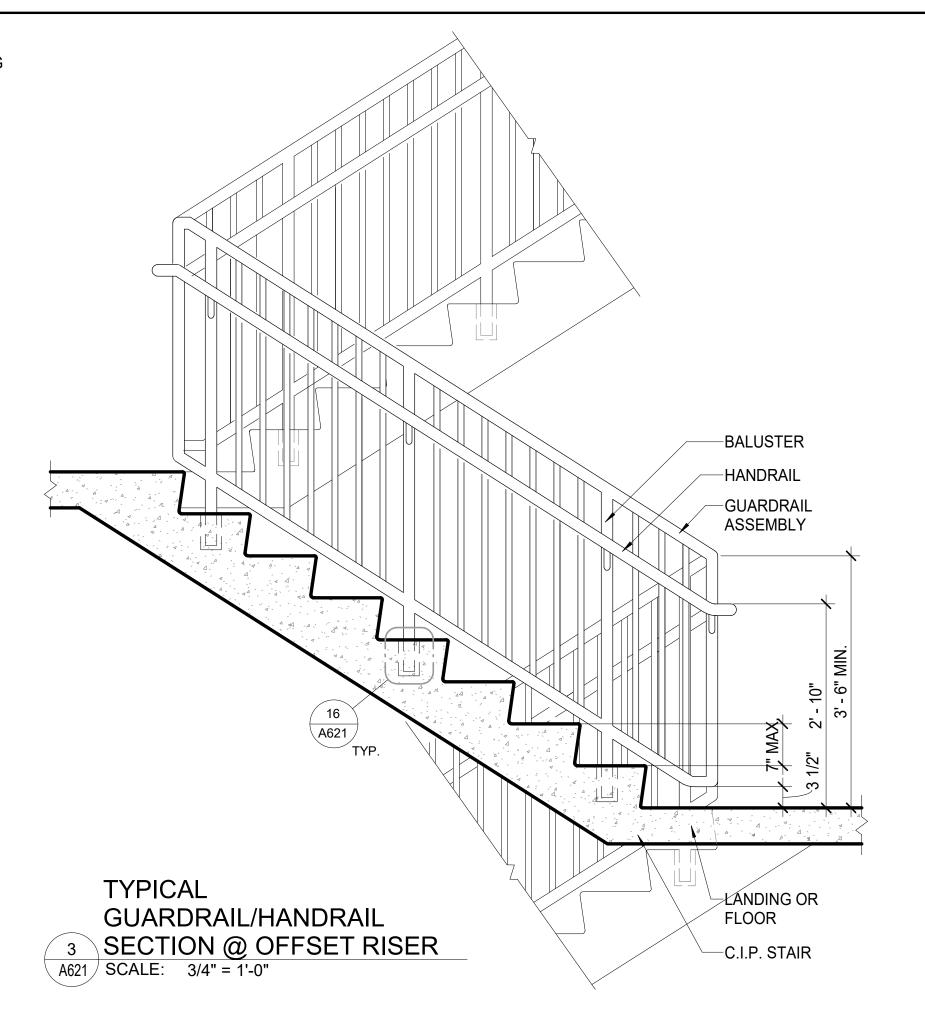


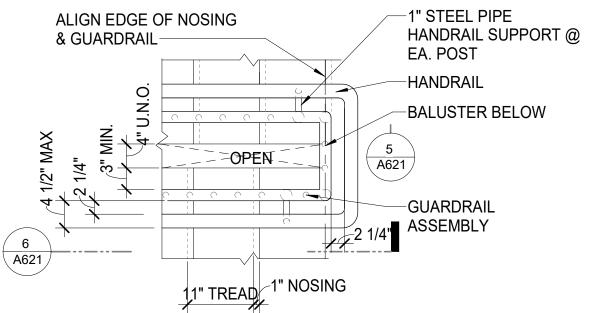


TYPICAL GUARDRAIL/HANDRAIL 4 PLAN @ ALIGNED RISER


A621 | SCALE: 3/4" = 1'-0"

A621 | SCALE: 3/4" = 1'-0"

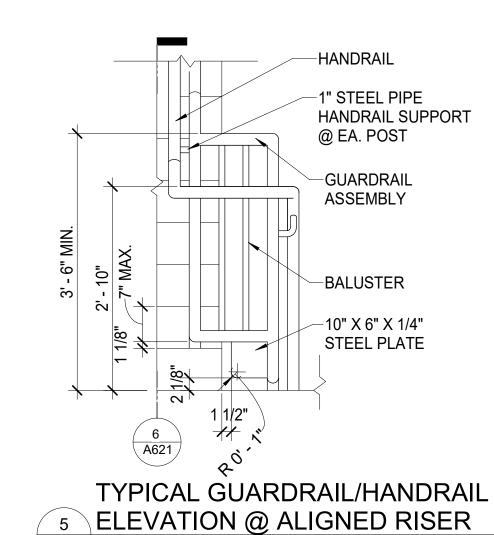

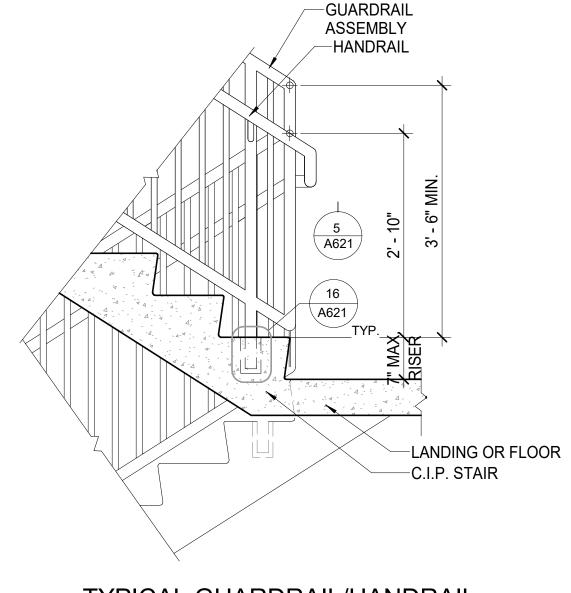

TYPICAL GUARDRAIL/HANDRAIL 6 SECTION @ ALIGNED RISER A621 SCALE: 3/4" = 1'-0"

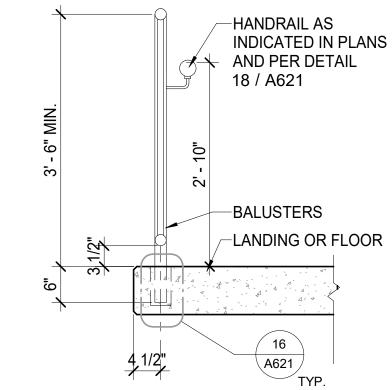


ASSEMBLY -HANDRAIL

-BALUSTER -C.I.P. STAIR

-SEE STRUCTURAL

DRAWINGS FOR

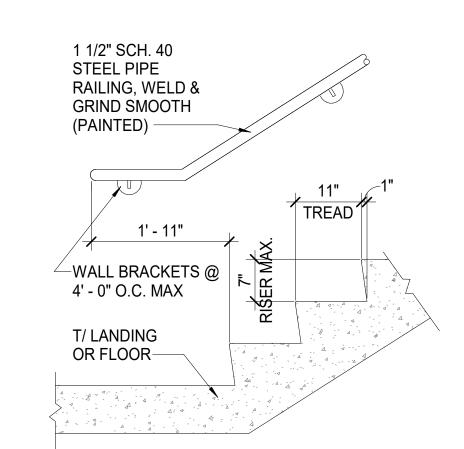

**STAIR AND RAILING NOTES:** 

3. ALL HANDRAILS TO BE 1 1/2" DIAMETER NOMINAL (ACTUAL 1.9"

EXCEPTION OF BALUSTERS) TO BE 1 1/2" DIAMETER NOMINAL

5. ALL BALUSTERS TO BE 3/4" DIAMETER NOMINAL (ACTUAL 1.05"

HANDRAILS, AND BALUSTERS) TO BE WELDED AND GROUND

8. ALL STEEL GUARDRAIL AND HANDRAIL COMPONENTS SHALL BE

**GALVANIZED OR PAINTED**. COLOR TO BE SELECTED BY **OWNER**/

**ARCHITECT**. SEE SPECIFICATION FOR ADDITIONAL INFORMATION.

OUTSIDE DIAMETER) STEEL PIPE SPACED AT 4" O.C. MAX. 6. VERTICAL PIPES TO BE SPACED AT MAXIMUM OF 4'-0" O.C.

2. PROVIDE SCHEDULE 80 PIPE IF CONDITIONS REQUIRE RAIL

1. ALL PIPE TO BE SCHEDULE 40 STEEL PIPE U.N.O.

SUPPORT FARTHER THAN SHOWN THIS SHEET.

4. ALL GUARDRAIL ASSEMBLY COMPONENTS, (WITH THE


(ACTUAL 1.9" OUTSIDE DIAMETER) STEEL PIPE, U.N.O.

'. ALL STEEL RAILING SYSTEM CONNECTIONS (GUARDS,

SMOOTH (NO MECHANICAL FASTENERS).


OUTSIDE DIAMETER) STEEL PIPE.

18a TYPICAL MOUNT HANDRAIL - CHI BC A621 SCALE: 3/4" = 1'-0"

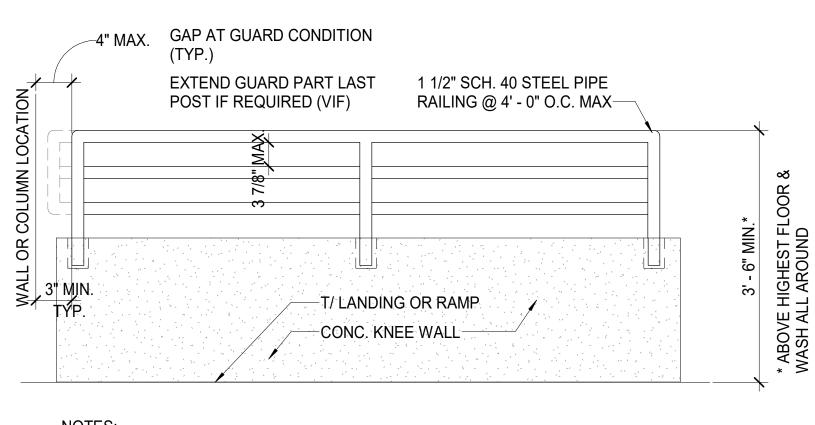

1) T/WALL MAY SLOPE TO MATCH RAMP CONDITION - GUARD TO MATCH SLOPE (VIF). 2) ALL STEEL GUARDRAIL COMPONENTS SHALL BE PAINTED.


12 TYPICAL STAIR GUARDRAIL DETAIL A621 SCALE: 3/4" = 1'-0"

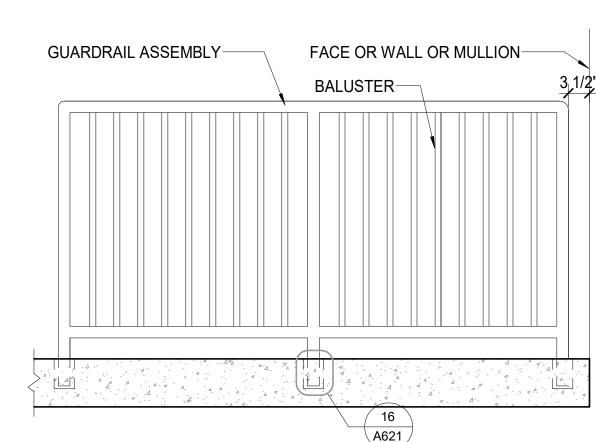

ASSEMBLY -HANDRAIL -BALUSTER -C.I.P. STAIR -SEE STRUCTURAI DRAWINGS FOR CONNECTION TYPICAL GUARD/HANDRAIL

8 SECTION @ BOT. OF STAIR
A621 SCALE: 3/4" = 1'-0"

CONNECTION 9 GUARDRAIL/HANDRAIL SECTION @ BOT. OF STAIR
A621 SCALE: 3/4" = 1'-0"

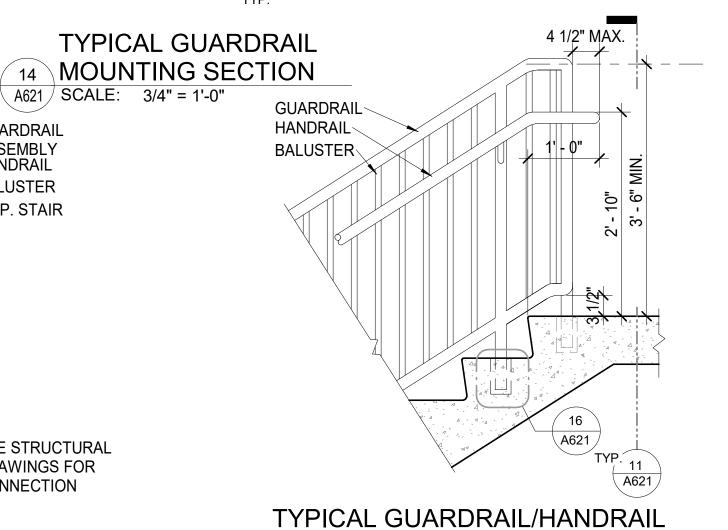


10 SECTION AT TOP OF LANDING

A621 SCALE: 3/4" = 1'-0"

4 1/2" MAX

TYPICAL GUARDRAIL/HANDRAIL 11 ELEVATION @ TOP OF LANDING A621 SCALE: 3/4" = 1'-0"

> TYPICAL RAILING CONNECTIONS TO BE SIDE MOUNTED TO STAIR **STRINGERS**

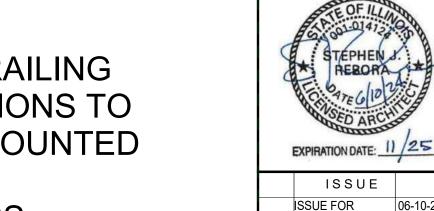

NO. DESCRIPTION DATE -BALUSTER -GUARDRAIL BOTTOM

-6" DIA. SPHERE SHALL

NOT PASS THRU


DRAWING TITLE: TYPICAL STAIR AND RAILING **DETAILS SIDE MOUNT** 

A621


SCALE: As indicated DATE: ISSUED FOR PROJECT NO: 50-24102 RWN. CHK'D. Designer Author Checker


DRAWING NO:

STAIR NOSING SHALL BE "BALCO" (OR APPROVED EQUAL) EXTRA HEAVY, SOLID SURFACE TYPE 13 TYPICAL END OF GUARDRAIL PLACEMENT A621 SCALE: 3/4" = 1'-0" DXH-330, WITH TREAD COVER 3/8" THK. BY 3" WIDE. COVERS TO BE

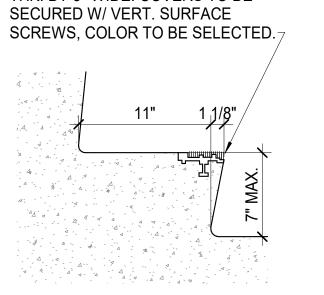



NOTE: CONTRACTOR MAY PROVIDE TOOLED GROOVES (4" MIN) AS AN ACCEPTABLE ALTERNATÈ TO STAIR NOSING. 17a TYPICAL CIP NOSING A621 | SCALE: 1 1/2" = 1'-0"

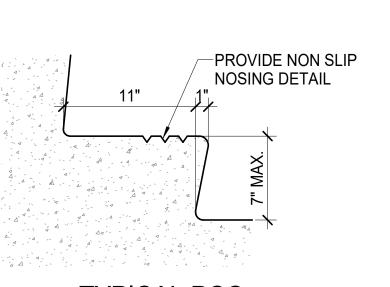

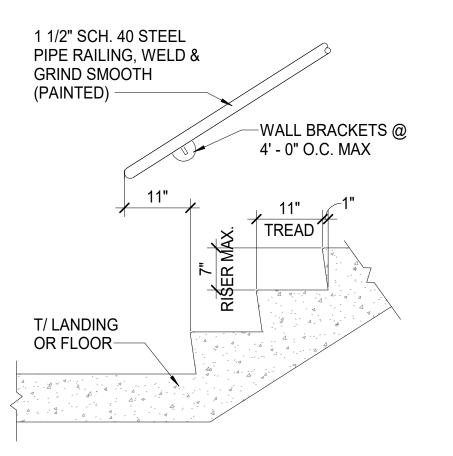




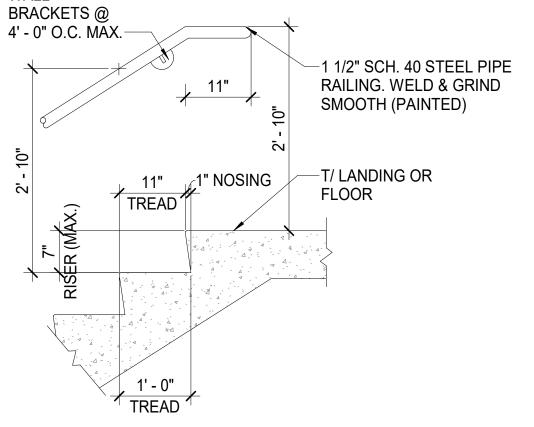

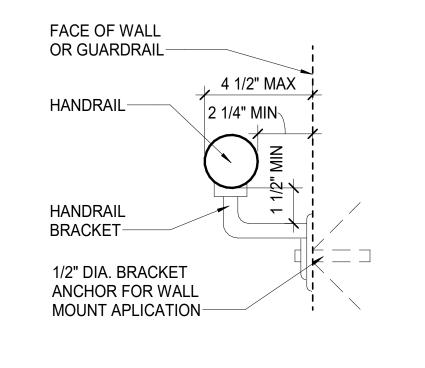

20 TYPICAL HANDRAIL SECTION A621 SCALE: 3" = 1'-0"

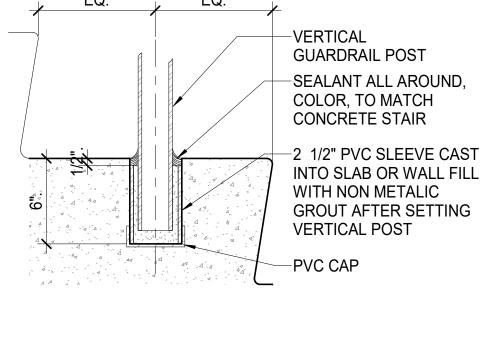

TYPICAL SLEEVE **MOUNTED POST** 16 DETAIL A621 SCALE: NOT TO SCALE

15 PLACEMENT A621 SCALE: NOT TO SCALE

4" DIA. SPHERE SHALL NOT PASS

TYPICAL PCC 17b NOSING DETAIL A621 SCALE: 1 1/2" = 1'-0"

19 TYPICAL HANDRAIL TOP OF FLOOR A621 SCALE: 3/4" = 1'-0"

TYPICAL BOTTOM RAIL

MANUFACTURER'S RECOMENDED METHODS AND MATERIALS.

ALL C.I.P. CONCRETE FINISHES EXPOSED TO VIEW ARE FOR SMOOTH FORMED FINISH.

2 3/8" 1. PIPE GUARD SIZE AND SHAPE MAY VARY DUE TO SHAPE, LOCATION AND SIZE OF PIPE LEADER/ CONDUIT. VERIFY IN FIELD. -3/8" THK. BENT STEEL PLATE 2. PROVIDE PIPE GUARD @ ALL PIPES & GALV. MOUNTED 3/4" Ø EXP. CONDUITS EXPOSED TO VEHICULAR BOLTS GALV. TRAFFIC (SEE MEP & FP DWGS.) CONTRACTOR SHALL LOCATE AND MEASURE EACH EXPOSED PIPE IN THE -CONCRETE COLUMN 3/8" GAP AROUND PIPE FIELD. A VARIETY OF PLAN SHAPES WILL BE REQUIRED TO -PIPE SLEEVE ACCOMMODATE THE FIELD -CONCRETE DECK 3. COORDINATE ANCHOR LOCATIONS WITH CONC. REINFORCEMENT (SEE

> AROUND WHERE REQUIRED GALV. PIPE HANGER--CONTINUOUS SEALANT AND BACKER ROD TOP AND BOTTOM-PROVIDE FIRE RATED CAULKING **SECTION** SYSTEM IF REQUIRED

CONCRETE COLUMN -PIPE LEADER OR CONDUIT. SEE MEP DWG'S. FOR SIZE OF PIPE. MAINTAIN MIN. 2" CLEARANCE ALL <u>PLAN</u> AROUND -PIPE GUARD

3 TYPICAL LEVEL PLAN & SECTION AT PIPE GUARD DETAIL A701 | SCALE: 3/4" = 1'-0"


-FINE BROOM CONC. -FINE BROOM CONC. FINISH TOP W/ SMOOTH FINISH TOP W/ SMOOTH RADIUS RADIUS -STANDARD WEIGHT -STANDARD WEIGHT CONC. FILLED GALV. CONC. FILLED GALV. STEEL PIPE BOLLARD STEEL PIPE BOLLARD -EMBED PLATE,SEE -EMBED PLATE, SEE STRUCTURAL DRAWINGS STRUCTURAL DRAWINGS FOR DETAILS FOR DETAILS SLOPE

NOTES:

CONDITIONS.


STRUCT.)

BOLLARD AT SUPPORTED 7 SLOPED SLAB DETAIL A701 SCALE: 3/4" = 1'-0"

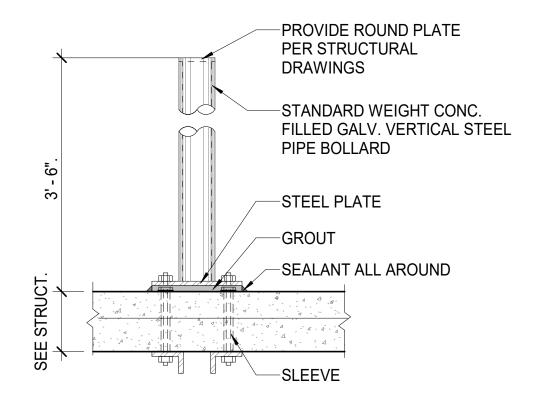


-FIRE STOPPING ALL

REMOVABLE BOLLARD AT 12 SUPPORTED LEVEL A701 SCALE: 3/4" = 1'-0"

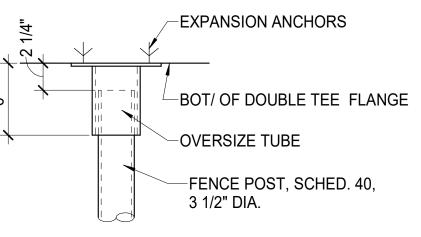

TYPICAL CHAINLINK 101 POST SUPPORT A701 SCALE: 1 1/2" = 1'-0"

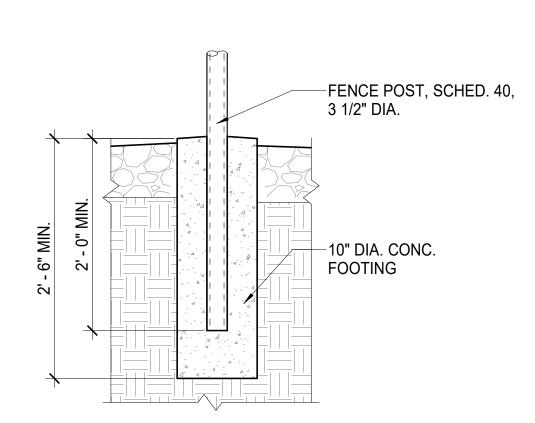

TYPICAL CHAINLINK FENCE 100 POST FOOTING DETAIL
A701 SCALE: 1" = 1'-0"

DRAWING NO: A701

SCALE: As indicated DATE: ISSUED FOR PERMIT 06-10-PROJECT NO: 50-24102 RWN. esigner Author

EXPIRATION DATE: 11/25

ISSUE

NO. DESCRIPTION DATE

DRAWING TITLE: TYPICAL

DETAILS

ISSUE FOR

PERMIT

-EDGE OF SLAB OR BEAM **REQUIRING ALTERNATE** COMPRESSIBLE FILLER ANGLE LOCATION (FIRE STOP SYSTEM AS REQUIRED)--EMBED (SEE **BOTTOM OF** STRUCTURAL CONC. SLAB OR DRAWINGS) BEAM--GALVANIZED ANGLE (SEE STRUCTURAL SEALANT BOTH DRAWINGS) SIDES--ALTERNATE LOCATION CMU WALL (RATED FOR ANGLE (INTERIOR OR NON-RATED) APPLICATION) SEE STRUCTURAL -ALTERNATE LOCATION **DRAWINGS** FOR ANGLE (EXTERIOR HIDDEN APPLICATION)

1)USE 1" GAP W/ SEALANT ADJACENT TO CONCRETE WALLS. COLUMNS AND BEAMS (FIRE STOP SYSTEM AS REQUIRED) 2)SEE STRUCTURAL DRAWINGS AND DETAILS TO DETERMINE MINIMUM

WEIGHTS AT WHICH BRACING EMBEDS & ANGLES ARE REQUIRED

MASONRY HEAD TYP. DETAIL A701 SCALE: 1" = 1'-0"

-DECK DRAIN DRAIN MFR.-BARRIER CABLE (IF -RIM EL. APPLICABLE) DOWN-N+0.08' N+0.06' 1. N= NOMINAL ELEVATION. USE ELEVATION AT COLUMN CENTERLINE AS SHOWN ON THE ARCHITECTURAL DRAWINGS FOR SLOPE ---NOMINAL ELEVATION. —SLAB EDGE ON 2. TOP SURFACE OF CONCRETE IS TO MAINTAIN A CONSTANT SLOPE RAMP BETWEEN SPOT ELEVATIONS. BELOW ─N+0.13' GIRDER GIRDER **FUNNEL** RAD. PER DRAIN MFR. RIM EL. 3' - 0" 3' - 0" VERTICAL POSSIBLE PLUMBING -DECK -RAD. PER PIPE LOCATIONS. SEE

DRAIN MFR.

2 PARTIAL PLAN AT FLOOR DRAINS AT SUPPORTED LEVEL A701 | SCALE: 1/2" = 1'-0"

DRAIN

-CONCRETE OR MASONRY STRUCTURE -PIPE OR CONDUIT ANCHORED ELSEWHERE PER SPEC.(SEE MEP & FP -CONTINUOUS SEALANT AND BACKER ROD BOTH SIDES-PROVIDE FIRE RATED CAULKING SYSTEM IF REQUIRED -PVC PLASTIC SLEEVE (AT C.I.P. CONCRETE WALL CONSTRUCTION ONLY) PIPE PENETRATION THRU

4 WALL TYP. DETAIL

A701 SCALE: 1" = 1'-0"

-STUD. WEIGHT CONC. FILLED GALV. STEEL PIPE BOLLARD -COVE SEALANT PROVIDE ROUND BLOCKOUT IN S.O.G. -SLAB ON GRADE -18" DIA. CONC. FOOTING SEE STRUCTURAL DRAWINGS FOR DETAILS


PLUMBING DRAWINGS.

FINE BROOM CONC. FINISH TOP

W/ SMOOTH RADIUS

**BOLLARD DETAIL AT SLAB** 5 ON GRADE TYP. DETAIL A701 | SCALE: 3/4" = 1'-0"

BOLLARD AT SUPPORTED 6 SLAB DETAIL A701 | SCALE: 3/4" = 1'-0"

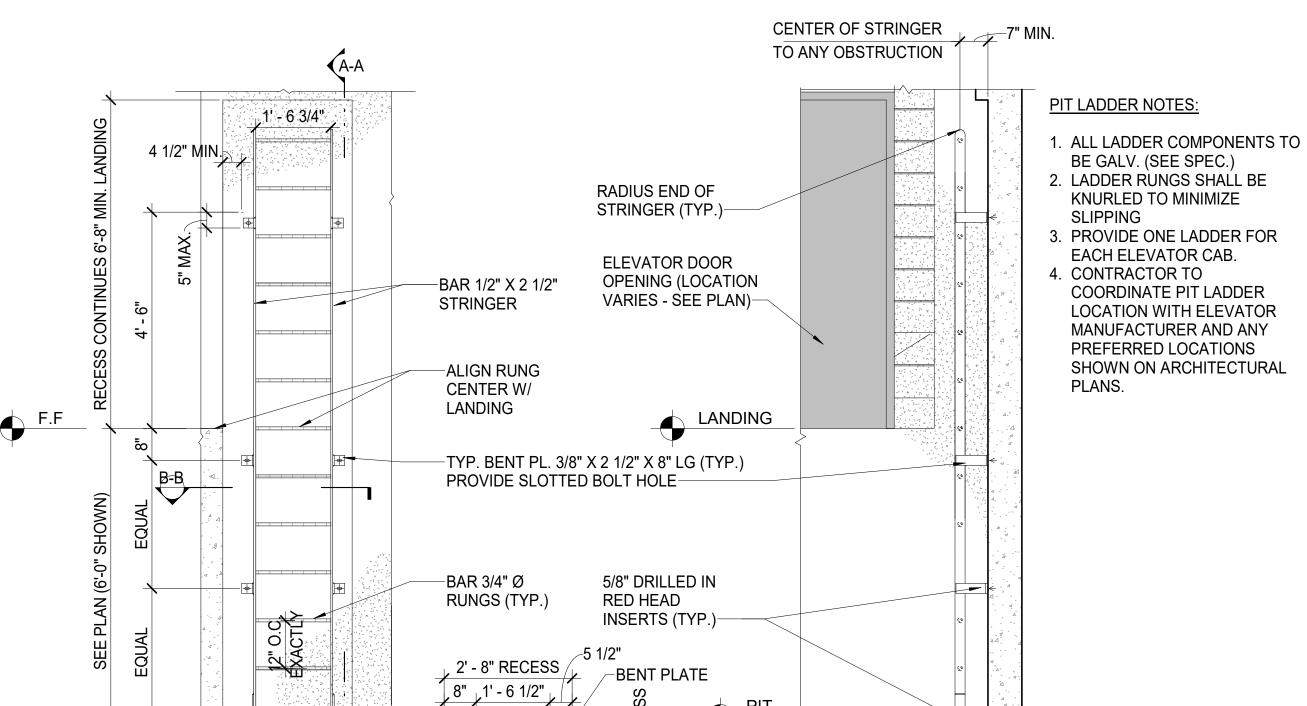

—BAR 3/4" Ø RUNGS (TYP.)

**SECTION A-A** 

COORDINATE PIT LADDER LOCATION WITH ELEVATOR MANUFACTURER AND ANY PREFERRED LOCATIONS SHOWN ON ARCHITECTURAL PLANS.

9 PIT LADDER DETAIL TYP.

A701 SCALE: 1/2" = 1'-0"

**ELEVATION** 



MCA YEAR

UNN E. DUNDEE PARKING SIRU

STEPHEN A REBORA PER GIO DA RELIGIO DA RECUISED ARCHIVES

ISSUE FOR PERMIT 06-10-24

NO. DESCRIPTION DATE

DRAWING TITLE:

MISCELLANEOUS

THERMAL &

MOISTURE

PROTECTION

DETAIL

DRAWING NO:

**A702** 

SCALE: As indicated

DATE: ISSUED FOR
PERMIT 06-10-24
PROJECT NO: 50-24102

DES. RWN. CHK'D.
Designer Author Checker

ISSUE

NO. DESCRIPTION DATE
DRAWING TITLE:
TYPICAL
MASONRY
DETAILS

DRAWING NO: **A722** 

SCALE: As indicated

DATE: ISSUED FOR
PERMIT 06-10-24
PROJECT NO: 50-24102


DES. RWN. CHK'D.
Designer Author Checker

-5/8" CONTROL JOINT W/ BACKER —CAST STONE SILL W/ ROD AND SEALANT BRICK VENEER FACADE UTILITY -MASONRY TIES AT 16" O.C. BRICK SIZE 4"x4"x12" NOMINAL - DRIP VERTICALLY AND HORIZONTALLY.-STAINLESS STEEL DRIP EDGE TROUGH WALL FLEXIBLE FLASHING -BRICK VENEER —SS PIN , CAULK AROUND FLASHING PENETRATION BACKER ROD AND 3 TYPICAL DETAIL AT STONE CAP SEALANT EA. SIDE-A722 SCALE: 3" = 1'-0"


C.I.P. CONCRETE

COLUMN-


7 TYPICAL DETAIL AT COLUMN
A722 SCALE: 1 1/2" = 1'-0"

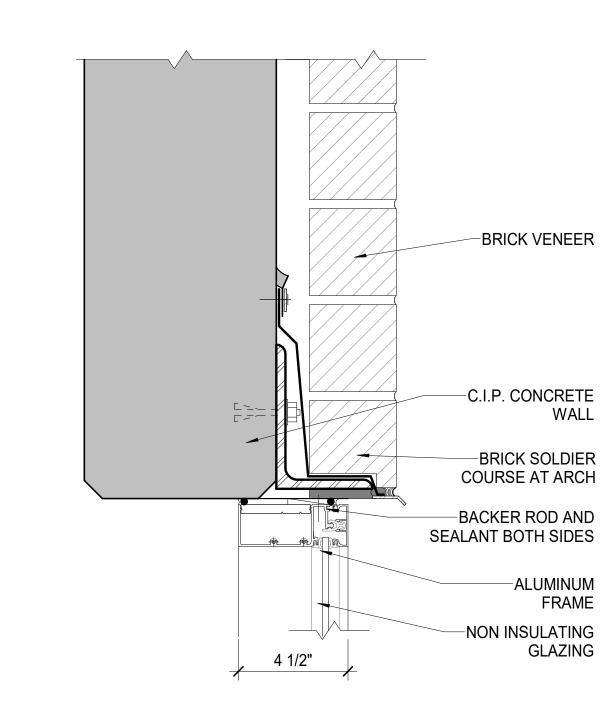

6 TYPICAL DETAIL MASONRY WINDOW HEAD SCALE: 3" = 1'-0"

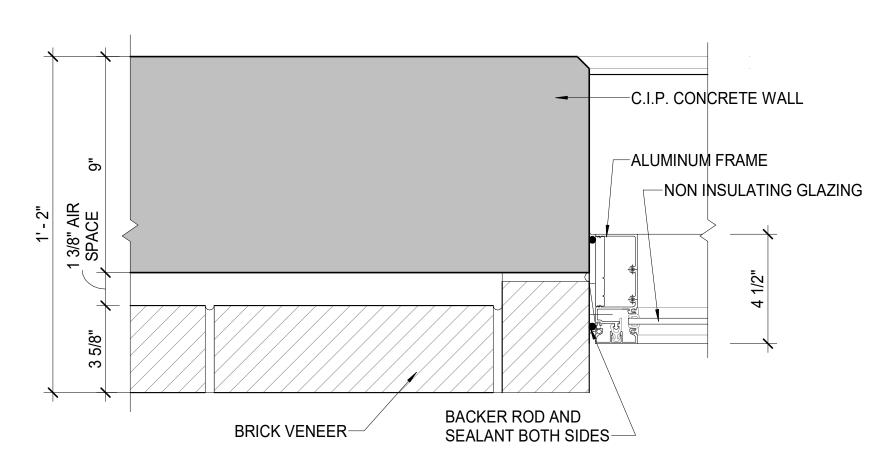

5 TYPICAL DETAIL MASONRY WINDOW JAMB SCALE: 3" = 1'-0"

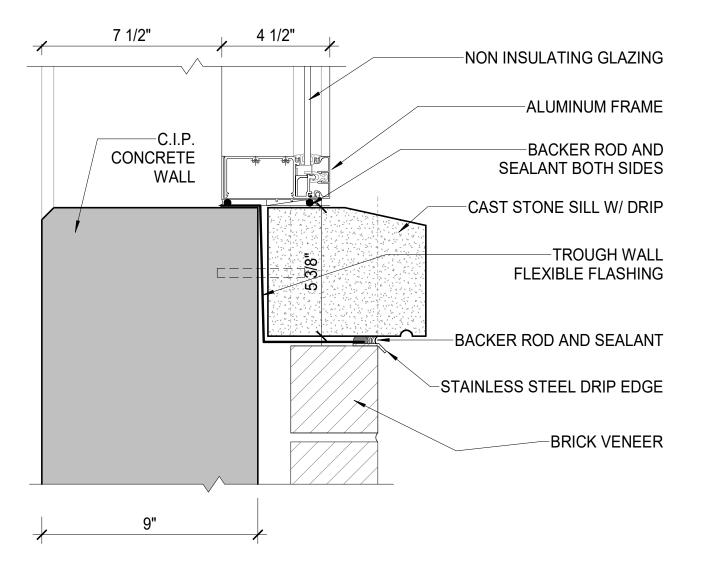

4 TYPICAL DETAIL MASONRY WINDOW SILL
A722 SCALE: 3" = 1'-0"

L6X4X5/16" CONT. STEEL SHELF
ANGLE PER STRUCTURAL ATTACHED
WITH 5/8" \$\Phi\$ HILTI KWIK BOLT TZ EXP.
ANCHORS @1'-6" (MIN. 4" EMBED.)

TERMINATION BAR

FLEXIBLE FLASHING. PROVIDE RECTANGULAR
PLASTIC WEEPHOLES W. COTTON WICK AND INSECT SCREEN @ 16" O.C..

BACKER ROD AND SEALANT

**DETAIL GENERAL NOTES:** 

FORMED FINISH.


1. PROVIDE GALVANIC ISOLATION WHERE DISSIMILAR MATERIALS MEET.

3. ALL C.I.P. CONCRETE FINISHES EXPOSED TO VIEW ARE FOR SMOOTH

2. ALL SYSTEMS AND MATERIALS TO BE INSTALLED USING

MANUFACTURER'S RECOMENDED METHODS AND MATERIALS.

9 TYPICAL FACE BRICK SHELF ANGLE DETAIL AT COLUMNS A722 SCALE: 3" = 1'-0"

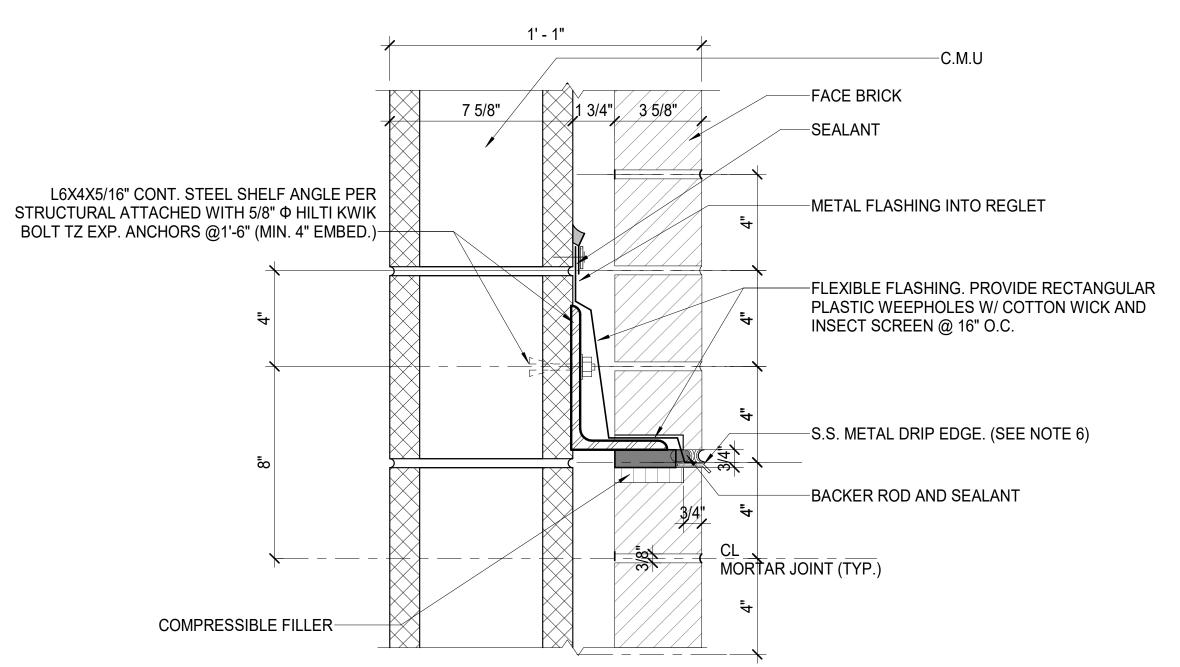



—STAINLESS STEEL DRIP EDGE

BACKER ROD AND SEALANT

BRICK SHELF ANGLE PER STRUCTURAL

8 TYPICAL FACE BRICK SHELF ANGLE DETAIL AT C.M.U. BACKUP A722 SCALE: 3" = 1'-0"

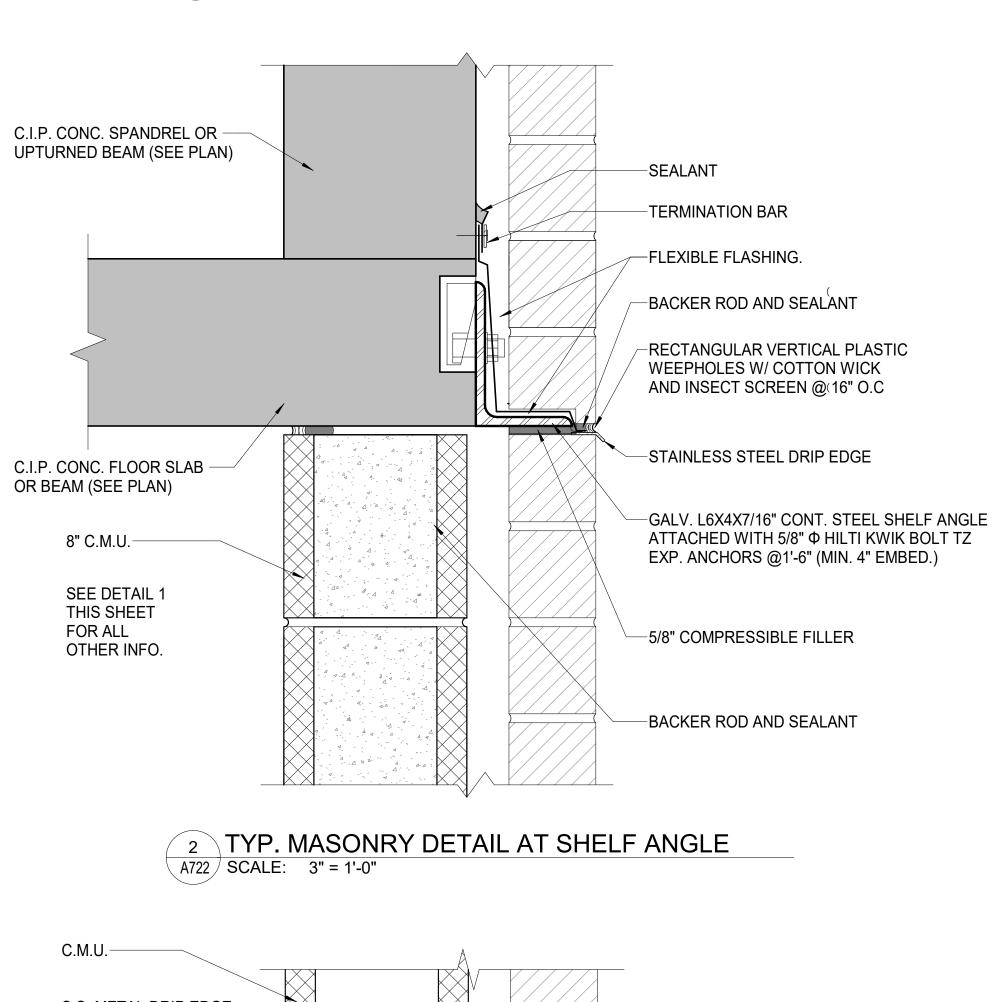


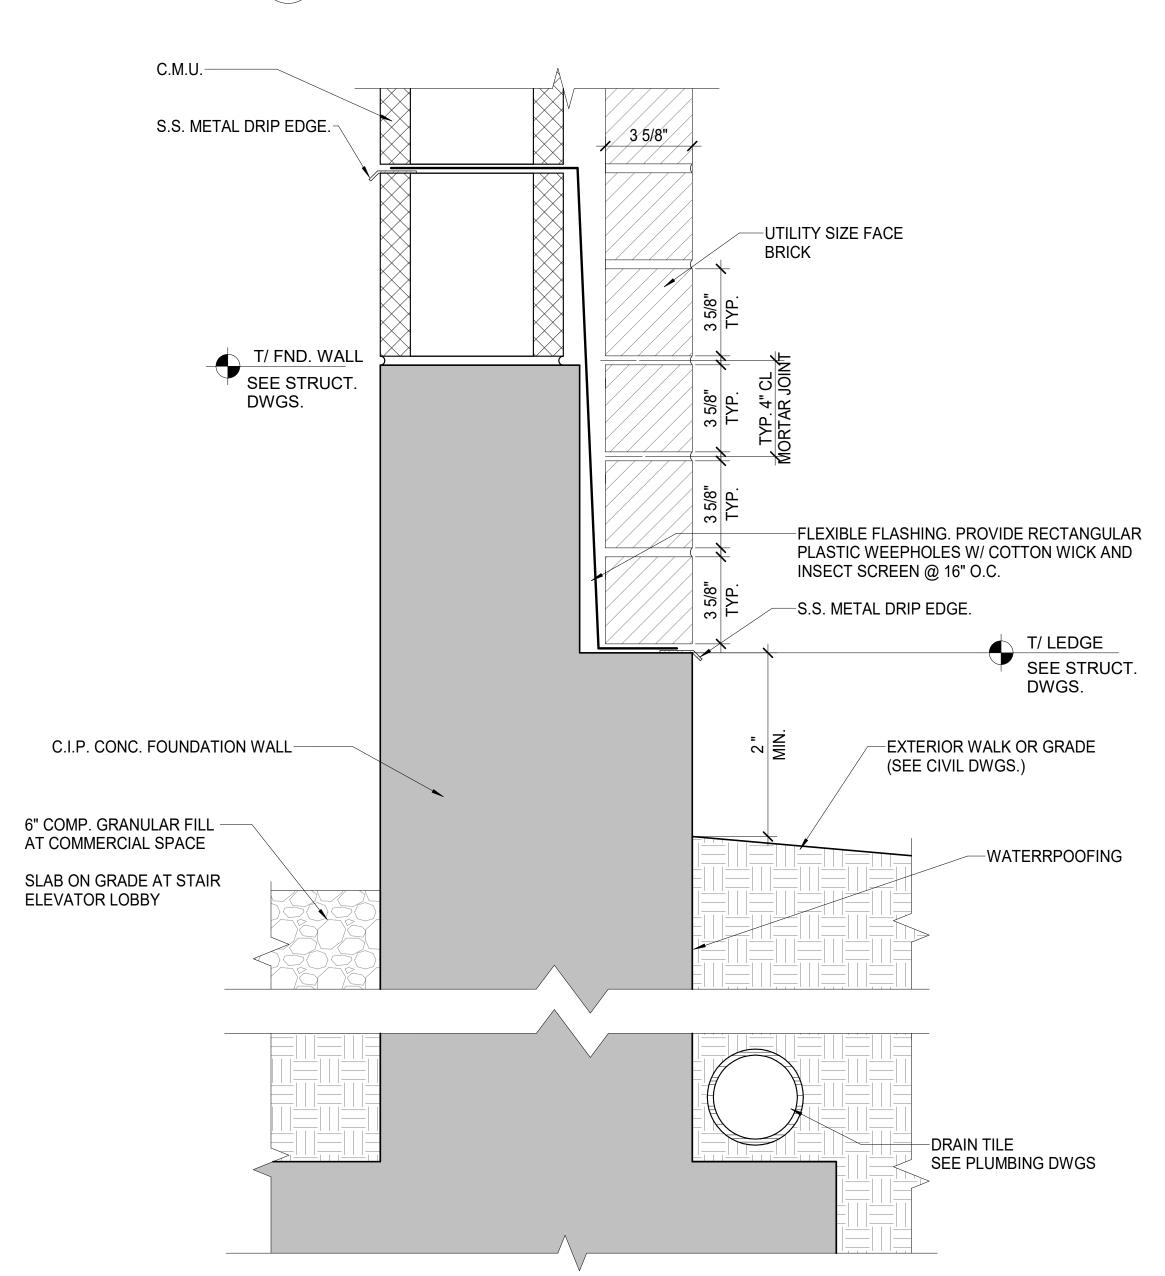


1 TYPICAL FACE BRICK BASE DETAIL
A722 SCALE: 3" = 1'-0"





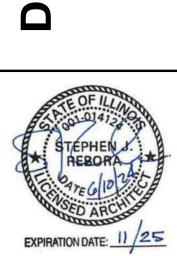

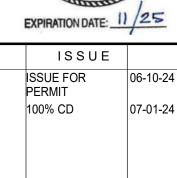


NO. DESCRIPTION DATE DRAWING TITLE:
RENDERINGS

DRAWING NO:

A901

DATE: 100% CDs 07-01-24 PROJECT NO: 50-24102 DES. RWN. CHK'D. Designer Author Checker




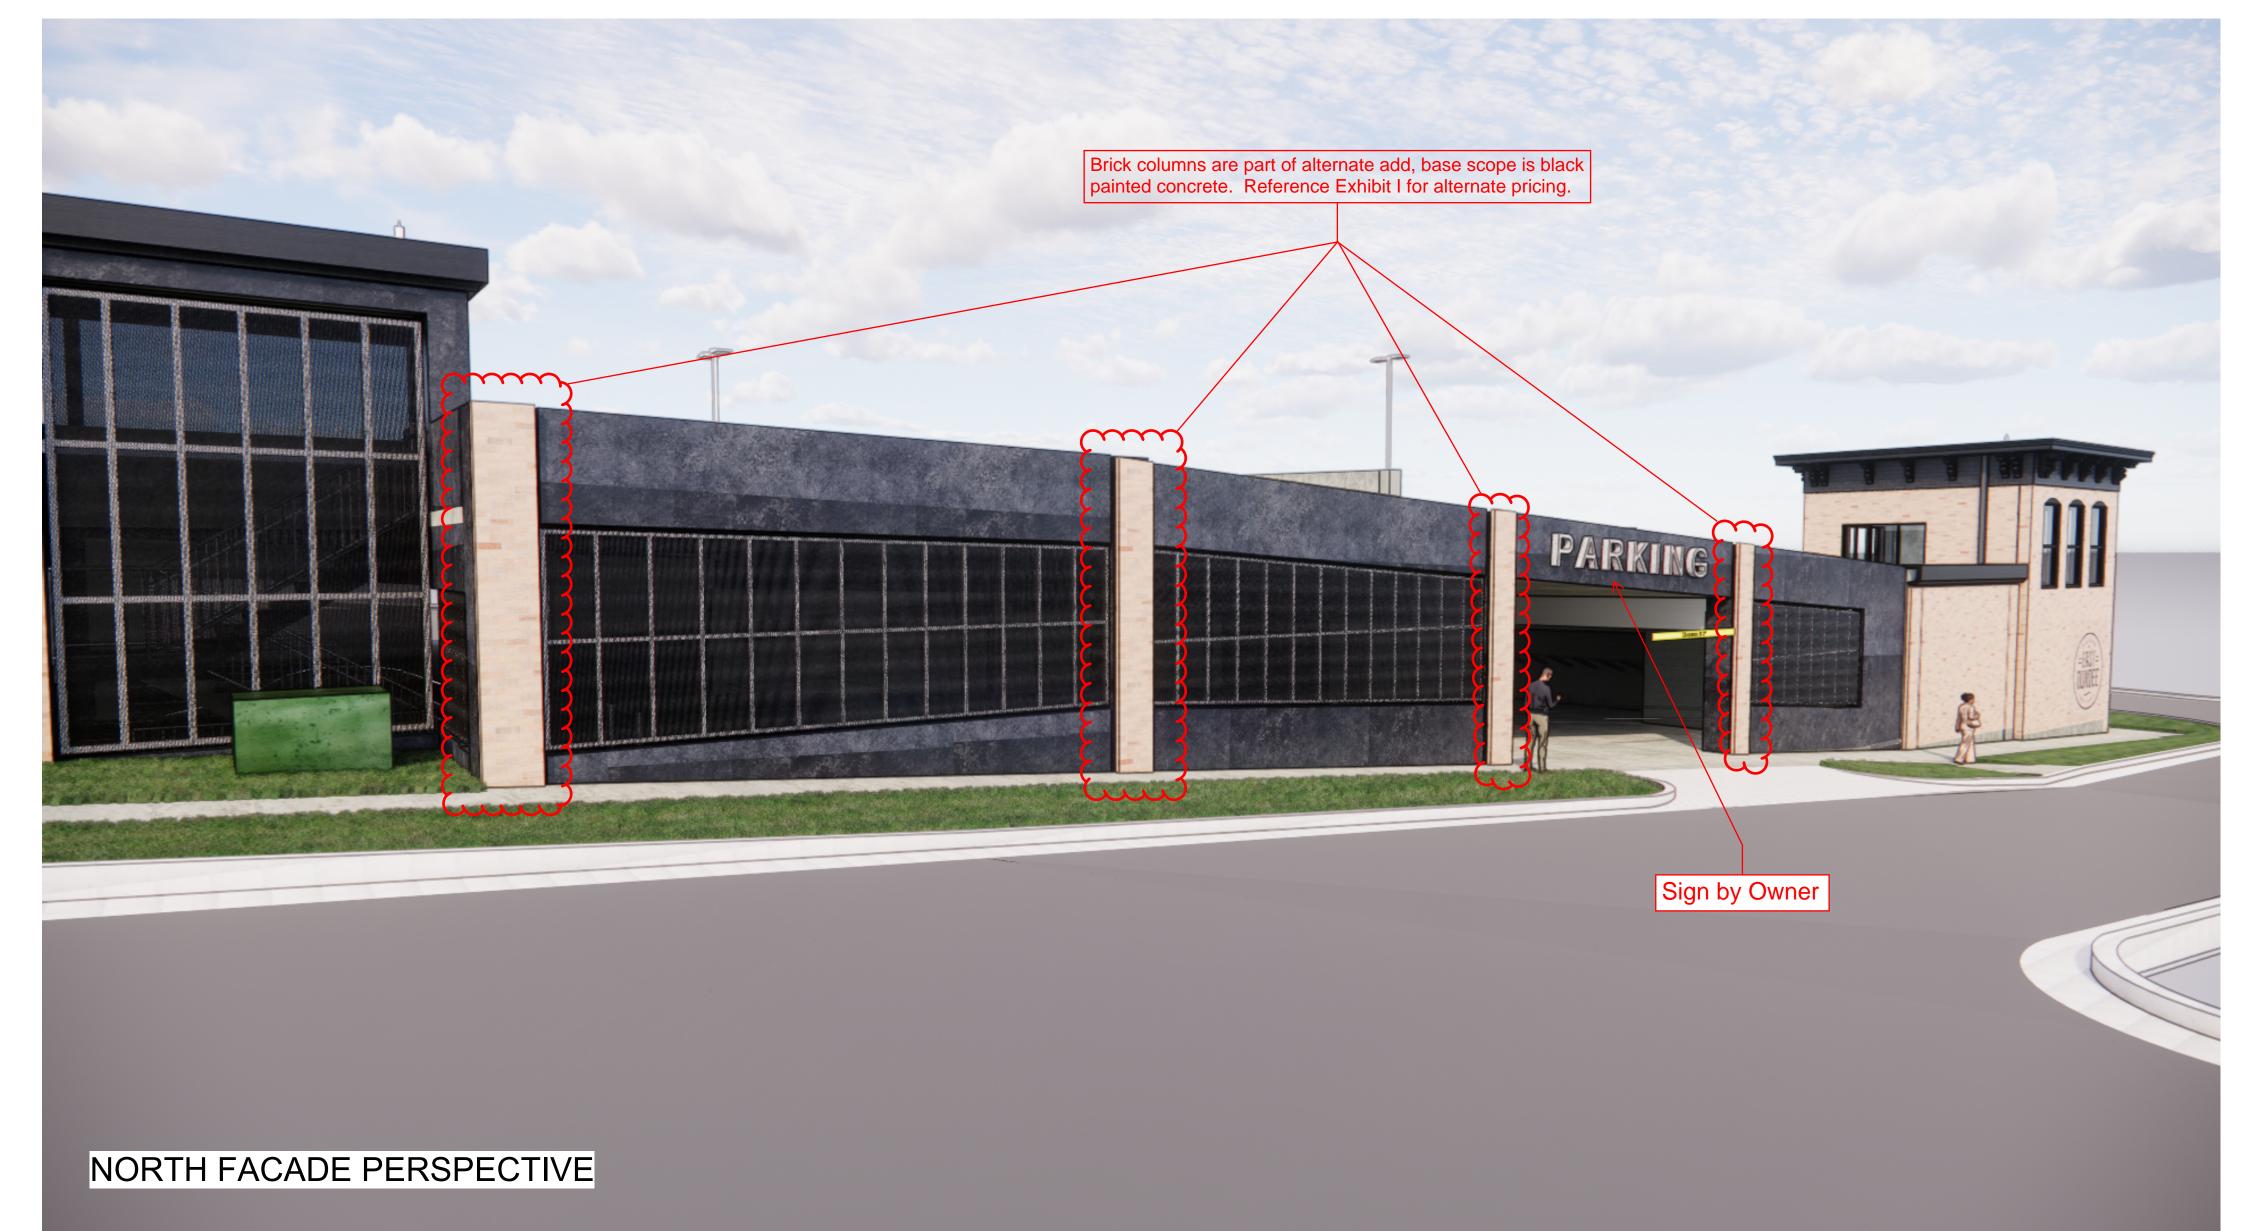

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NO. DESCRIPTION DATE DRAWING TITLE:
RENDERINGS

DRAWING NO:

A902

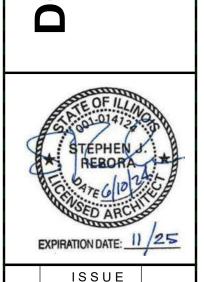DATE: 100% CDs 07-01-24 PROJECT NO: 50-24102

DES. RWN. CHK'D. Designer Author Checker

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SOUTH FACADE PERSPECTIVE

WEST FACADE PERSPECTIVE

Sign by Owner

COMMERCIAL

2.1.1 PARKING STRUCTURE: A. ELEVATED LEVEL 3 PSF MISCELLANEOUS SUSPENDED 40 PSF B. BRICK CLADDING (PER VERTICAL UNIT AREA WHERE APPLICABLE) 2.1.2 STAIR AND STAIR/ELEVATOR ENCLOSURES A. TYPICAL LEVEL, AS APPLICABLE GLAZING (PER VERTICAL UNIT AREA) BRICK CLADDING (PER VERTICAL UNIT AREA) 40 PSF B. ROOF ROOFING, INSULATION 6 PSF MISCELLANEOUS SUSPENDED 4 PSF 2.2LIVE LOADS (OCCUPANCY LOADS, U.N.O.) 2.1.1 PARKING STRUCTURE: A. ELEVATED LEVEL

 PARKING STALLS, DRIVE ISLES 40 PSF 2.2.2 STAIR AND STAIR/ELEVATOR ENCLOSURES 100 PSF A. STAIR STEPS AND STAIR AND ELEVATOR LOBBIES 20 PSF B. DESIGN ROOF LIVE LOAD C. DESIGN ROOF SNOW LOAD PER 2.3 D. ELEVATOR MACHINE LOADS PER CONTRACTOR'S SPECIFICATIONS E. ELEVATOR SERVICE AREAS PER CONTRACTOR'S SPECIFICATIONS BUT NOT TO **EXCEED 150 PPSF UNIFORM LOAD** 2.3ROOF SNOW LOADS

 $C_{\rm e} = 1.0$  SNOW EXPOSURE FACTOR SNOW LOAD IMPORTANCE FACTOR I = 1.0 THERMAL FACTOR  $C_t = 1.2$  SNOW DRIFT LOADING PER ASCE 7 CHAPTER 7 2.4WIND LOADS A. ALL WIND LOADS SHALL BE IN ACCORDANCE WITH THE GOVERNING IBC SECTION 1609 AND ASCE 7 CHAPTER 6 AS FOLLOWS

GROUND SNOW LOAD ASCE 7 FIG. 7-1

FLAT ROOF SNOW LOAD

V = 90 MPH BASIC WIND SPEED (ASCE 7 FIG. 6-1) IMPORTANCE FACTOR I = 1.0 WIND EXPOSURE WIND INTERNAL PRESSURE COEFF. – PARKING STRUCTURE  $GC_{pi} = \pm 0.55$ WIND INTERNAL PRESSURE COEFF. – STAIR/ELEVATOR ENCLOSURE GCpi = ±0.18

 $P_q = 25 PSF$ 

 $P_f = 21 PSF$ 

HEIGHT ABOVE	MAIN WIND FORCE	COMPONENTS & CLADDING						
BASE	RESISTING SYSTEM	AWAY FROM	AT CORNERS					
0 - 20 FT	14 PSF	22 PSF	35 PSF					
20 - 25 FT	15 PSF	22 PSF	35 PSF					
25 - 30 FT	15 PSF	22 PSF	35 PSF					

NOTE: WIND PRESSURES ON COMPONENTS AND CLADDING HAVE BEEN BASED ON EFFECTIVE WIND AREA ON 10 FT2 OR LESS. IN THE EVENT ACTUAL EFFECTIVE WIND AREA ON A COMPONENT IS GREATER THAN THE BASIS USED IN CALCULATION OF THE ABOVE PRESSURES, THE CLADDING SPECIALTY CONTRACTOR SHALL RE-CALCULATE THE PRESSURES ABD SUBMIT THIS CALCULATION TO THE ARCHITECT FOR APPROVAL

2.5SEISMIC LOADS A. SEISMIC LOADS SHALL BE IN ACCORDANCE WITH THE GOVERNING IBC SECTION 1613 AND PER ASCE 7 CHAPTERS 11 AND 12, WITH THE FOLLOWING CRITERIA:

A. NO PROVISIONS HAVE BEEN MADE FOR STRUCTURE EXPANSION IN ANY

DIRECTION.

 OCCUPANCY CATEGORY SEISMIC IMPORTANCE FACTOR  $I_e = 1.0$  MAPPED SPECTRAL RESPONSE COEFFICIENTS  $S_{DS} = 0.149$  $S_{D1} = 0.097$  SITE CLASS SEISMIC DESIGN CATEGORY BASIC SEISMIC FORCE RESISTING SYSTEMS PER ASCE 7 TAB. 12.2-1:

PARKING STRUCTURE E-W & N-S ORDINARY REINFORCED CONCRETE MOMENT FRAMES (C-7) RESPONSE MODIFICATION FACTOR R = 30.0497 x W<sub>i</sub> DESIGN BASE SHEAR (GARAGE FRAME) STAIR/ELEVATOR ENCLOSURE ORDINARY REINFORCED CONCRETE SHEAR WALLS (A-2)

RESPONSE MODIFICATION FACTOR R = 4 DESIGN BASE SHEAR (STAIR/ELEVATOR ENCL.) 0.0373 x Wi EQUIVALENT LATERAL FORCE ANALYSIS PROCEDURE 2.6FUTURE EXPANSION

#### **GENERAL NOTES**

1. ALL NOTES GIVEN ON THESE DRAWINGS ARE SUPPLEMENTAL TO THE PROJECT SPECIFICATIONS AND ARE NOT INTENDED TO REPLACE THEM. IN THE EVEN OF AN APPARENT CONFLICT BETWEEN THE NOTES ANDD THE PROJECT SPECIFICATIONS, THE CONTRACTOR MUST OBTAIN CLARIFICATION IN WRITING FROM THE ARCHITECT

2. ALL DESIGN AND CONSTRUCTION SHALL BE DONE IN ACCORDANCE WITH THE MOST STRINGENT OF THE GOVERNING CODES IF NOT SPECIFICALLY INDICATED. THE LATEST EDITION OF THE STATE AND LOCAL CODES AND ALL OTHER PERTINENT CODES, REGULATIONS AND ORDINANCES MUST BE USED.

3. DRAWINGS ARE NOT TO BE USED FOR SHP DETAILING UNLESS SPECIFICALLY INDCATED BY THE ARCHITECT/ENGINEER "FOR DETAILING" OR "FOR CONSTRUCTION" THESE DRAWINGS ARE NOT TO BE REPRODUCED FOR THE PURPOSE OF USING THEM AS SHOP DETAIL DRAWINGS.

4. STRUCTURAL DRAWINGS ARE INTENDED TO BE USED ALONG WITH CIVIL. ARCHITECTURAL, MECHANICAL, PLUMBING, FIRE PROTECTION AND ELECTRICAL DRAWINGS. THE CONTRACTOR IS RESPONSIBLE FOR COORDINATING THE REQUIREMENTS OF ALL DRAWINGS INTO THEIR SHOP DRAWINGS AND WORK.

5. SMALL OPENINGS ARE GENERALLY NOT SHOWN ON THE STRUCTURAL DRAWINGS. REFER TO ARCHITECTURAL, MECHANICAL, PLUMBING, FIRE PROTECTION, AND ELECTRICAL DRAWINGS FOR LOCATIONS AND DIMENSIONS OF THOSE OPENINGS PROVIDE MINIMUM REINFORCEMENT AROUND OPENINGS PER TYPICAL DETAILS SHOWN ON THE STRUCTURAL DRAWINGS UNLESS OTHERWISE SHOWN OR REFERENCED. MULTIPLE OPENINGS SPACED CLOSER TOGETHER THAN THE DIAMETER (OR SMALLER DIMENSION FOR RECTANGULAR CONFIGUURATION) OF THE LARGER OF ADJACENT OPENINGS OR 6 INCHES, WHICHEVER IS GREATER, SHALL BE TREATED AS ONE OPENING DEFINED BY OUTER TANGENT LINES CONNECTING ADJACENT OPENINGS IN A CLUSTER.

6. THE CONTRACTOR SHALL SUBMIT SLEEVE/OPENING LAYOUTS FOR ALL PIPES. CONDUITS AND SIMILAR FACILITIES PENETRATIONS THROUGH STRUCTURAL MEMBERS (ALL TRADES INCLUDED) TO THE ARCHITECT FOR APPROVAL PRIOR TO CONSTRUCTION REFER TO TYPICAL DETAILS FOR ADDITIONAL REINFORCEMENT REQUIRED AROUND OPENINGS. SPECIFIC SITUATIONS BASE ON THE CONTRACTOR'S SELECTED ROUTING OF PIPES, CONDUITS, DUCTS, ETC., MAY REQUIRE SEPARATE ANALYSIS AND ADDITIONAL REINFORCEMENT ABOVE AND BEYOND THAT SHOWN IN TYPICAL DETAILS. SUCH ADDED REINFORCEMENT SHALL BE PROVIDED BY THE CONTRACTOR AT NO ADDITIONAL COST TO THE OWNER.

7. NO OPENINGS OTHER THAN THOSE SHOWN ON THE DESIGN DRAWINGS AND APPROVED SHOP DRAWINGS, SHALL BE MADE WITHOUT THE WRITTEN APPROVAL OF THE ARCHITECT.

8. NO FIELD REVISIONS TO ANY STRUCTURAL COMPONENT INCLUDING BUT NOT LIMITED TO SIZE, DIMENSION(S), MATERIAL(S), ETC. SHALL BE MADE WITHOUT THE WRITTEN APPROVAL OF THE ARCHITECT. THIS ALSO INCLUDES REVISIONS DUE TO MISLOCATION, MISFIT, OR ANY OTHER CONSTRUCTION ERRORS. STANDARD REQUIEST FOR INFORMATION DOCUMENT SHALL NOT BE USED AS A TOOL TO OBTAIN ARCHITECT'S INSTRUCTIONS CONCERNING CORRECTION(S) OF CONSTRUCTION ERRORS. NON-CONFORMANCE REPORT SHALL BE USED TO REPORT SUCH CONDITIONS AND TO REQUEST ARCHITECT'S GUIDANCE.

9. DO NOT SCALE THESE DRAWINGS, USE DIMENSIONS AS SHOWN.

10.THE CONTRACTOR SHALL SUPERVISE AND DIRECT ALL WORK SO AS TO MAINTAIN SOLE RESPONSIBILITY FOR ALL CONSTRUCTION MEANS, METHODS, TECHNIQUES, SEQUNCES AND PROCEDURES.

11. THE STRUCTURE IS DESIGNED TO FUNCTION AS A UNIT UPON COMPLETION. BASED ON THE CONTRACTOR'S CONSTRUCTION METHODS AND SEQUENCING OF CONSTRUCTION, THE CONTRACTOR SHALL RETAIN SERVICES OF A LICENSED PROFESSIONAL ENGINEER TO DESIGN LATERAL SUPPORT SYSTEM REQUIRED TO RESIST LATERAL LOADS AND PROVIDE OVERALL STABILITY OF THE STRUCTURE UNTIL COMPLETION. THE CONTRACTOR SHALL FURNISH AND PROVIDE THE NECESSARY BRACING AND SUPPORTS DURING CONSTRUCTION AND SHALL BE RESPONSIBLE FOR THE OVERALL STABILITY OF THE STRUCTURE DURING CONSTRUCTION.

12.THE CONTRACTOR IS RESPONSIBLE FOR LIMITING THE AMOUNT OF CONSTRUCTION LOAD IMPOSED UPON STRUCTURAL FRAMING INCLUDING BUT NOT LIMITED TO ELEVATED CONSTRUCTION AND SLAB-ON-GRADE. CONSTRUCTION LOAD SHALL NOT EXCEED THE CAPACITY OF THE FRAMING AT THE TIME THE LOADS ARE IMPOSED.

13. THE CONTRACTOR SHALL BE RESPONSIBLE FOR PROPER DESIGN. ADEQUATE INSTALLATION AND MAINTENANCE OF ANY AND ALL SHEETING, SHORING AND UNDERPINNING AGAINST EXISTING STRUCTURE AS REQUIRED, SO THAT THEY ARE NOT ENDANGERED BY THIS CONSTRUCTION. TEMPORARY MEMBERS AND CONNECTIONS SHALL NOT BE REMOVED UNTIL PERMANENT MEMBERS ARE IN PLACE AND FINAL CONNECTIONS ARE MADE.

14.THE CONTRACTOR SHALL PROVIDE ALL THE NECESSARY MEASURES AND PRECAUTIONS TO PREVENT DAMAGE AND SETTLEMENT OF EXISTING OR NEW CONSTRUCTION INSIDE OR OUTSIDE THE PROJECT LIMITS DURING EXCAVATION. ANY DAMAGE TO NEW OR EXISTING CONSTRUCTION INSIDE OR OUTSIDE THE PROJECT LIMITS, CAUSED BY CONSTRUCTION TECHNIQUES OR MOVEMENTS OF THE SOIL PILE(S) AND/OR RETENTION SYSTEM, SHALL BE THE RESPONSIBILITY OF THE CONTRACTOR.

15. THE CONTRACTOR'S CONSTRUCTION AND/OR ERECTION SEQUENCES SHALL RECOGNIZE AND CONSIDER THE EFFECTS OF THERMAL MOVEMENTS OF STRUCTURAL **ELEMENTS**.

16.NEITHER THE ARCHITECT NOR THE STRUCTGURAL ENGINEER SHALL BE RESPONSIBLE FOR OR HAVE CONTROL OR CHARGE OF CONSTRUCTION MEANS, METHODS, TECHNIQUES, SEQUENCES, PROCEDURES, OR SAFETY PRECAUTIONS/PROGRAMS IN CONNECTION WITH THIS PROJECT. NEITHER THE ARCHITECT NOR THE STRUCTURAL ENGINEER SHALL BE RESPONSIBLE FOR, OR HAVE CONTROL OVER THE ACTS OF OMISSIONS BY THE CONTRACTOR, SUBCONTRACTORS, ANY OF THEIR AGENTS, EMPLOYEES, OR ANY OTHER PERSONS PERFORMING ANY OF THE WORK, OR FOR THE FAILURE OF ANY OF THE ENTITIES OR INDIVIDUALS MENTIONED HEREIN ABOVE, TO CARRY OUT THE WORK IN ACCORDANCE WITH THE CONTRACT DOCUMENTS.

17. MINIMUM ACTUAL HEADROOM CLEARANCE IN THE PARKING STRUCTURE SHALL BE NOT LESS THAN 8'-2". THE CONTRACTOR SHALL ASCERTAIN THE REQUIRED CLEAR HEIGHT BELOW ALL BEAMS BEFORE PLACING CONCRETE. THE CONTRACTOR SHALL NOTIFY THE ARCHITECT/ENGINEER IMMMEDIATELY UPON DISCOVERY IN WRITING FOR EVERY LOACTION WHERE THE CLEAR HEIGHT IS LESS THAN THE MINIMUM INDICATE HEREIN ABOVE

#### **GENERAL NOTES**

1. THE FOUNDATION DESIGN IS BASED ON THE GEOTECHNICAL INVESTIGATION REPORT PREPARED BY SOIL AND MATERIAL CONSULTANTS, INC. (SMCI), 8 W. COLLEGE DR., SUITE C. ARLINGTON HEIGHTS, IL 60004, TEL. (847) 870-0544 & FACSIMILE (847) 870-0661, DATED APRIL 7, 2023 AND THE LETTER ADDENDUM DATED APRIL 4, 2024. SMCI FILE No. 27129. IT IS THE RESPONSIBILITY OF THE CONTRACTOR TO REVIEW THE GEOTECHNICAL REPORT AND ACCOMPANYING DATA PRIOR TO BIDDING. ALL WORK SHALL BE DONE PER THE RECOMMENDATIONS GIVEN IN THE GEOTECHNICAL REPORT AND ADDENDA.

2. ALL SOIL SUPPORTED STRIP AND SPREAD FOOTINGS SHALL BE FOUNDED UPON UNDISTURBED NATURAL SUBGRADE OR ENGINEERED FILL OF NOT LESS THAN 12 INCHES IN DEPTH, WITH A MINIMUM ALLOWABLE BEARING CAPACITY OF 3,000 PSF AS FIELD VERIFIED AND APPROVED BY THE OWNER;S GEOTECHNICAL ENGINEER. THE BOTTOM OF THE FOOTING ELEVATIONS AND SOIL BEARING CAPACITIES AS SHOWN ON THE DRAWINGS ARE BASED ON THE SOIL BORNG DATA AND REPORT. FINAL EXACT ELEVATIONS AND SOIL BEARING CAPACITIES SHALL BE FIELD DETERMINED AND VERIFIED BY THE OWNER'S GEOTECHNICAL ENGINEER AND REVIEWED BY THE ARCHITECT/ENGINEER DURING CONSTRUCTION.

3. THE SOIL SUBGRADE FOR ALL FOOTINGS AND SLABS SHALL BE INSPECTED AND APPROVED BY THE OWNER'S GEOTECHNICAL ENGINEE PRIOR TO PLACING FOUNDATION CONCRETE OR CONCRETE SLABS.

4. THE NATURAL SOIL SUBGRADE FOR ALL FOOTINGS AND SLABS SHALL BE PREPARED AS INDICATED IN THE PROJECT SPECIFICATIONS AND/OR GEOTECHNICAL REPORT. THIS PREPARATION SHALL BE OBSERVED AND APPROVED BY THE OWNER'S GEOTECHNICAL ENGINEER. THE BOTTOM OF GENERAL EXCAVATION SHALL BE COMPACTED BY SEVERAL PASSES OF A HEAVY VIBRATORY ROLLER, 20 TON MINIMUM STATIC WEIGHT, APPROVED BY THE OWNER'S GEOTECHNICAL ENGINEER.

PROOF-ROLLING REVEALING AREAS OF UNSTABLE SOIL CONDITIONS MAY BE FOLLOWED BY AERATION OF HIGH MOISTURE CONTENT SOILS EFFECTIVE TO DEPTH OF UP TO 1.0 FOOT. REMOVAL OF UNSTABLE SOILS MAY BE NECESSARY AS DETERMINED BY THE OWNER'S GEOTECHNICAL ENGINEER WHO WILL ALSO ADVISE ON THE EXTENTS AND DEPTHS OF UNDERCUTS.

6. FOLLOW RECOMMENDATIONS OF THE OWNER'S GEOTECHNICAL ENGINEER RELATIVE TO TREATMENT OF SOFT OR UNSTABLE SIL CONDITIONS WITH THE USE OF AN EFFECTIVE DEPTH OF CRUSHED GRANULAR MATERIAL IN CONJUNCTION WITH THE USE OF AN APPROPRIATE GEOTEXTILE FABRIC.

7. BUILDING FOOTING FOUNDATIONS ARE EXPECTED TO BEAR UPON GRANULAR SOILS SUSCEPTIBLE TO DISTURBANCE DURING EXCAVATION AND DEWATERING, IF NECESSARY BEARING SOIL SURFACES DETERMINED BY THE OWNER'S GEOTECHNICAL ENGINEER TO BE DISTURBED DUE TO SUCH CONSTRUCTION OPERATIONS SHOULD BE PROPERLY DE-WATERED AND RE-COMPACTED. THIS PROCESS SHOULD UTILIZE LARGE VIBRATORY PLATE COMPACTOR(S) AND PROCEED TO THE CONDITION SATISFACTORY TO THE OWNER'S GEOTECHNICAL ENGINEER.

8. ALL UNSUITABLE FINE, ORGANIC, OR ANY OTHER SOFT, EXCESSIVELY YIELDING MATERIAL SHOULD BE REMOVED FROM THE EXCAVATION TO REACH ACCEPTABLE BEARING GRANULAR DEPOSITS. AND REPLACED WITH CONTROLLED INERT GRANULAR FILL APPROVED BY THE OWNER'S GEOTECHNICAL ENGINEER. UNDERCUTS SHOULD EXTEND LATERALLY ON A 2(H):1(V) SLOPE A MINIMUM DISTANCE AWAY FROM THE EDGE OF FOOTING EQUAL THE DEPTH OF FILL THAT WILL BE PRESENT BENEATH THAT FOOTING.

9. ALL WELL GRADED GRANULAR MATERIAL FOR FILLS DEEMED ACCEPTABLE BY THE OWNER'S GEOTECHNICALL ENGINEER SHALL BE PLACED IN LIFTS NOT EXCEEDING 8 INCHES IN LOOSE THICKNNESS, AND COMPACTED TO A MINIMUM OF 95 PERCENT COMPACTION BASED ON THE MODIFIED PROCTOR TEST (ASTM D 1557). REFER TO ITEM 11 HEREIN BELOW FOR FURTHER INFORMATION ON COMPACTION.

10.NO FOOTINGS OR SLABS SHALL BE PLACED INTO OR AGAINST SUBGRRADE CONTAINING FREE WATER, FROST OR ICE. SHOULD WATER OR FROST ENTER A FOOTING EXCAVATION AFTER SUBGRADE APPROVAL, THE SUBGRADE SHALL BE RE-INSPECTED BY THE OWNER'S GEOTECHNICAL ENGINEER FOLLOWING THE REMOVAL OF WATER OR FROST JUST PRIOR TO CONCRETE PLACEMENT.

11.THE CONTRACTOR SHALL PROVIDE ALL NECESSARY MEASURES TO PREVENT ANY FROST OR ICE FROM PENETRATING ANY FOOTING OR SLAB SUBGRADE BEFORE AND AFTER PLACING OF CONCRETE AND UNTIL SUCH SUBGRADES ARE FULLY PROTECTED BY THE PERMANENT BUILDING STRUCTURE.

12.ALL FOOTING SUBGRADES AS REQUIRED AND ALL SLAB SUBGRADES INCLUDING PIT SLABS. AND BACKFILL AROUND AND ABOVE ALL FOUNDATION ELEMENTS. FOOTINGS. MATS AND PITS, SHALL BE COMPACTED TO A MINIMUM OF 98 PERCENT OF OPTIMUM DENSITY BASED ON THE MODIIFIED PROCTOR TEST ASTM D 1557. THE DETERMINATION OF DENSITY OF THE SUBGRADES OR COMPACTED FILLS MAY BE BASED ON A DIFFERENT STANDARD ACCEPTABLE TO THE OWNER'S GEOTECHNICAL ENGINEER AS LONG AS THE RESULTING APPROVED DENSITY IS EQUIVALENT TO THAT DETERMINED BY THE STANDARD MENTIONED HEREIN ABOVE.

13. THE CONTRACTOR SHALL LOCATE CONSTRUCTION JOINTS IN CONTINUOUS STRIP FOOTINGS SUCH THAT THE MAXIMUM LENGTH OF THE CONCRETE PLACEMENT DOES NOT EXCEED 60 FEET. PLACE CONTROL/CONSTRUCTION JOINTS IN WALLS AS SHOWN ON THE DRAWINGS. IF NOT SHOWN, FOLLOW NOTE 19.C UNDER "CONCRETE NOTES" ON DWG. S002. THE CONTRACTOOR SHALL UTILIZE A CONSTRUCTION SEQUENCE/PATTERN OF CONCRETE PLACEMENT SUCH THAT THE EFFECT OF SHRINKAGE IS MINIMIZED. THE CONTRACTOR SHALL SUBMIT A PROPOSED JOINT LOCATIONS AND SEQUENCE OF CONCRETE PLACEMENT IN FOOTING FOUNDATIONS AND WALLS TO THE ARCHITECT/ENGINEER FOR REVIEW.

14. THE CONCRETE FOR EACH ISOLATED SPREAD FOOTING SHALL BE PLACED IN ONE CONTINUOUS PLACEMENT

15.BACKFILL ALL WALLS SIMULTENEOUSLY ON BOTH SIDES TO THE LOWER OF ADJACENT GRADES. DIFFERENTIAL DEPTH OF BACKFILL DURING THIS STAGE SHALL NOT EXCEED TWELVE (12) INCHES.

16. CANTILEVER RETAINING WALLS SCHEDULED AND SHOWN ON THE DRAWINGS DO NOT REQUIRE LOW BACKFILL SIDE BRACING AND MAY BE BACKFILLED UPON WALL CONCRETE ATTAINING 75% OF THE DESIGN STRENGTH. OTHER FOUNDATION WALLS MAY REQUIRE TEMPORARY LATERAL BRACING IF THE CONTRACTOR CHOOSES TO BACKFILL PRIOR TO CONSTRUCTING PERMANENT LATERAL SUPPORT AFFORDED BY THE BUILDING STRUCTURE, U.N.O. IN DETAILS ON THESE DRAWINGS. WHEN TEMPORARY BRACING IS REQUIRED, IT IS TO BE DESIGNED BY A STRUCTURAL ENGINEER CURRENTLY LICENSED TO PRACTICE IN THE **STATE OF ILLINOIS** AND RETAININED BY THE CONTRACTOR. AND FURNISHED BY THE CONTRACTOR. SUCH TEMPORARY BRACING SHALL BE THEN FURNISHED BY THE CONTRACTOR.

17. THE CONTRACTOR SHALL BE FULLY RESPONSIBLE FOR LOCATING, PROTECTING AND MAINTAINING IN SERVICE ALL EXISTING UTILITIES. FAILURE TO OBTAINING AND VERIFY INFORMATION CONCERNING OPERATING UTILITIES PRIOR TO COMMENCEMENT OF THE WORK SHALL NOT BE CONSIDERED A CAUSE FOR CONSIDERATION OF ENCOUNTERING SUCH UTILITIES OR RELATED FACILITIES AS UNFORESEEN CONDITIONS. ANY AND ALL DAMAGE TO THE EXISTING OPERATING UTILITIES CAUSED BY THE CONTRACTOR, SHALL BE REPAIRED BY THE CONTRACTOR TO THE SATISFACTION OF THE AUTHORITY HAVING JURISDICTION AND AT NO COST TO THE OWNER.

18. THE CONTRACTOR SHALL NOTIFY THE ARCHITECT/ENGINEER IN THE EVENT ANY EXISTING UTILITIES, UTILITY STRUCTURES OR ANY OBSTRUCTION INTERFERES WITH THE PROPER INSTALLATION OF THE FOUNDATION WORK.

19.ALL FOOTINGS SUBJECTED TO FREEZE-THAW CYCLES OF SURROUNDING SOIL SHALL BEAR A MINIMUM OF 42.0 INCHES BELOW LOWEST FINISHED ADJACET GRADES.

20.SEE PLUMBING DRAWINGS FOR DRAINAGE SYSTEM AND SPECIAL GRANULAR FILL REQUIREMENTS.

21.SEE ARCHITECTURAL DRAWINGS FOR ALL WATERPROOFING AND DAMP PROOFING DETAILS.

22.ALL ELEVATIONS ARE REFERENCED TO NAVD '88. SEE CIVIL DRAWINGS FOR BENCHMARKS DESCRIPTIONS.

23. THE CONTRACTOR SHALL EXERCISE DUE CARE AND CAUTION WORKING IN THE AREAS ADJOINING EXISTING CONSTRUCTION TO REMAIN. THE CONTRACTOR SHALL BE FULLY RESPONSIBLE FOR PROVIDING AND MAINTAINING MEASURES PROTECTING EXISTING CONSTRUCTION. ANY AND ALL DAMAGES TO THE EXISTIG CONSTRUCTION CAUSED BY THE CONTRACTOR'S MEANS AND METODS AND/OR CONTRACTOR'S FAILURE TO PROVIDE PROTECTION SHALL BE REPAIRED BY THE CONTRACTOR TO THE SATISFACTION OF THE AUTHORITY HAVING JURISDICTION AND AT NO COST TO THE OWNER.

#### EXCAVATION, EARTH RETENTION, AND **DEWATERING NOTES**

1. WHEREVER SITE CONDITIONS ARE DICTATED BY THE PROXIMITY OF THE FOUNDATIONS TO THE PROPERTY LINE, ADJACENT EXISTING STRUCTURES TO REMAIN OR INABILITY TO PROVIDE OPEN CUT EXCAVATION, PARTS OF THE PERIMETER OF EXCAVATIONS FOR BELOW GRADE CONSTRUCTION SHALL BE RETAINED BY SOIL RETENTION SYSTEM(S). THE DESIGN, FURNISHING, INSTALLATION, MAINTENANCE AND REMOVAL OF SUCH SYSTEM(S) SHALL BE THE COMPLETE AND SOLE RESPONSIBILITY OF THE CONTRACTOR. REFER TO ITEM 14 OF THE GENERAL NOTES.

2. THE CONTRACTOR SHALL COORDINATE ALL ELEMENTS OF THE RETENTION SYSTEM WITH ALL ELEMENTS OF THE PERMANENT BUILDING AND IDENTIFY AND ADDRESS POTENTIAL CONFLICTS.

3. PRIOR TO ANY EXCAVATION OR INSTALLATION OF THE ELEMENTS OF THE SOIL RETENTION SYSTEM, THE CONTRACTOR SHALL ESTABLISH SURVEY POINTS AROUND THE PERIMETER OF THE AREA TO BE EXCAVATED AND OTHER POINTS UP TO 200 FEET BEYOND THE EXCAVATED PERIMETER. THESE POINTS SHALL BE SURVEYED FOR VERTICAL AND HORIZONTAL MOVEMENTS AT FREQUENT INTERVALS DURING ACTUAL EXCAVATION AND/OR RETENTION SYSTEM INSTALLATION, AND CONTINUE DURING SUBSEQUENT PHASE OF THE WORK UP AND INCLUDING THE TIME OF FULL UNBRACED ERECTION OF ALL STRUCTURAL AND ARCHITECTURAL COMPONENTS OF THE BUILDING. SURVEYING DATA SHALL BE SUBMITTED TO THE ARCHITECT NO LATER THAN THREE 93) BUSINESS DAYS FOLLOWING ITS RECORDING BY THE SURVEYOR.

4. ALL EXCAVATION SHALL BE BASED ON ENGINEERED DRAWINGS PREPARED BY THE CONTRACTOR'S PROFESSIONAL ENGINEER SPECIALIZING IN THIS KIND OF WORK AND CURRENTLY LICENSED TO PRACTICE IN THE STATE OF ILLINOIS. THESE DRAWINGS SHALL INCLUDE PLANS AND SECTIONS OF EXCAVATION SEQUENCES, THE NECESSARY SIZES/SPACINGS OF RETENTION SYSTEM COMPONENTS AND DETAILS OF CONNECTIONS AND EMBEDMENTS.

5. ALL EXCAVATIONS BELOW THE GENERAL LOWEST LEVEL OF THE PERMANENT BUILDING REQUIRED FOR PITS, MAY BE RETAINED BY LOCALIZED SOIL RETENTION SYSTEMS AS DEEMED NECESSARY BY THE CONTRACTOR. SUCH SYSTEMS SHALL BE DESIGNED BASED ON APPROPRIATE EARTH AND HYDROSTATIC PRESSURES AND OTHER CONSTRUCTION LOADINGS.

6. THE CONTRACTOR SHALL PROVIDE POSITIVE PROTECTION (MAT/SHEET COVERINGS) FOR ALL EXCAVATION SLOPES AND MAINTAIN PROPER DRAINAGE WITHIN EXCAVVATIONNS AT ALL TIMES. THE CONTRACTOR SHALL BE FULLY RESPONSIBLE FOR DESIGNING AND CONSTRUCTING STABLE TEMPORARY EXCAVATIONS BY PROVIDING ADEQUATE PROTECTION AGAINST SLOPES INSTABILITY AND DETERIORATION DUE TO RAIN, WIND, ICE OR SNOW.

7. UPON COMPLETION OF THE EARTH RETENTION SYSTEM INSTALLATION THE EXCAVATION SITE OR SEGEMENT THEREOF SHALL BE DEWATERED BEFORE OR AS THE EXCAVATION PROCEEDS. THE CONTRACTOR SHALL SUBMIT TO THE ARCHITECT FOR RECORD COMPLETE PLANS AND DETAILS OF THE DEWATERING SYSTEM INCLUDING TRENCHES, SUMPS, DEWATERING WELLS, OBSERVATION WELLS, PUMPING SYSTEM DISPOSAL LOCATION, SETTLING BASIN, MAINTENANCE OR BACKUP EQUIPMENT, ETC. THE DEWATERING SYSTEM DESIGN, CONSTRUCTION, MAINTENANCE AND TERMINATION SHALL BE COMPLETE AND SOLE RESPONSIBILITY OF THE CONTRACTOR.

8. AT ALL TIMES, THE DEWATERING SYSTEM SHALL MAINTAIN THE GROUND WATER LEVEL A MINIMUM OF THREE (3) FEET BELOW THE DEEPEST FOUNDATION SUBGRADE WITHIN THE DEWATERING SEGMENT OF THE FOUNDATION. THE DEWATERING SYSTEM SHALL BE MAINTAINED UNTIL STRUCTURES POTENTIALLY AFFECTED BY THE GROUND WATER RISE ARE INSTALLED AND CURED IN PLACE, WATERPROOFING IS INSTALLED AND THE PERMANENT BUILDING DRAINAGE SYSTEM IS FULLY OPERATIONAL

9. MONITORING OF THE DEWATERING SYSTEM SHALL BE DONE BY THE CONTRACTOR AND THE OWNER'S GEOTECHNICAL ENGINEER. THIS SHALL INCLUDE MONITORING OF THE SITE CONDITIONS JUST PRIOR, DURING AND FOLLOWING EXCAVATION, OBSERVATION WELLS FOR GROUND WATER LEVELS BELOW GROUND SURFACE AND EFFICIENCY AND HANDLING OF THE SITE DRAINAGE.

10. DEPENDING ON THE ACTUAL CONDITIONS ENCOUNTERED, THE AGGRESSIVE DEWATERING MAY ADVERSELY AFFECT THE FOUNDATION SUBGRADES AS OBSERVED BY THE OWNER'S GEOTECHNICAL ENGINEER. SHOULD THESE CONDITIONS BE ENCOUNTERED, THE RESPECTIVE SUBGRADES MAY REQUIRE RE-COMPACTION OR REMOVAL AND REPLACEMENT BY ENGINEERED FILL AS DIRECTED BY THE OWNER'S GEOTECHNICAL ENGINEER.

11.JUST PRIOR TO TERMINATION OF DEWATERING THE CONTRACTOR MUST ASCERTAIN THAT THE GRAVITY OF THE PERMANENT BUILDING OR STRUCTURE IN PLACE AT THE TIME OF TERMINATION ADEQUATELY COUNTERACTS THE IMPOSED BUOYANT FORCES BASED ON KNOWN HYDROGEOELOGY OF THE SITE AND AN APPROPRIATE FACTOR OF SAFETY. 12.SEE PROJECT SPECIFICATIONS FOR ADDITIONAL REQUIREMENTS.

### **ABBREVIATIONS**

BRG

C.G.

C.I.P.

C.J.

CL

CLR.

C.M.U

COL.

COMP.

CONC.

CONN.

**CONST** 

CONT.

DET.

DIAG

DIAM

D.L.

D.P.

DWG

EA.

E.F.

E.J.

**ELEC** 

ELEV.

FABR.

FIN. FL.

FNDN.

FP

F.S.

GA.

GALV.

FD

EQ.

DWLS.

EACH

EACH FACE

ELEVATION

**ELECTRICAL** 

**ELEVATOR** 

FACE TO FACE

FABRICATOR

FLOOR DRAIN

FINSHED FLOOR

FOUNDATION

FOOT OR FEET

GALVANIZED

FAR SIDE

FOOTING

GAUGE

FIRE PROTECTION

EQUAL

FINISH

**FLOOR** 

**EXPANSION JOINT** 

COV. PL

BEARING

SCHED. SCHEDULE AMERICAN CONCRETE INSTITUTE SECT. SECTION AMERICAN INSTITUTE OF S.F. STEEL CONSTRUCTION SHT. SHEET ADDL ADDITIONAL SIM. SIMILAR ADJ. **ADJACENT** S.O.G. AGG. **AGGREGATE** SPEC. **SPECIFICATION** ALTERNATE SPEC'D SPECIFIED APPROXIMATELY STL. STEEL STANDARD STD. ARCHITECT STIFF. STIFFENER STIRRUP BUILDING STIR. B/ OR BOT. BOTTOM STRUCT. STRUCTURE BETWEEN SUB-CONT. SUB-CONTRACTOR BTWN

> CHANNEL TOP OF CENTER OF GRAVITY T&B CAST IN PLACE CONSTRUCTION JOINT OR TEMP. CONTROL JOINT TEN. **TENSION** CENTERLINE THK. THICK **TYPICAL** CLEAR TYP. CONCRETE MASONRY UNIT

COLUMN U.N. COMPRESSION U.N.O. CONCRETE CONNECTION CONSTRUCTION SHEAR VERT. CONTINUOUS COVER PLATE

WITH WITHOUT DOUBLE W/O DETAIL WF WIDE FLANGE WIDE FLANGE SECTION DIAGONAL W XxXX DIAMETER W.P. **WORK POINT** DIMENSION W.S. WATER STOP DEAD LOAD WELDED WIRE FABRIC DRILLED PIER DRAWING **DOWELS** 

SQUARE FOOT (FEET) **SLAB ON GRADE** 

SUPT. SUPPORT SYMMETRICAL SYM. TOP AND BOTTOM TEMPERATURE

**UNLESS NOTED UNLESS NOTED** OTHERWISE

VERTICAL

G.C. GENERAL CONTRACTOR GRADE GRADE BEAM GR. BM. G.S. **GALVANIZED STEEL** HEADED HOOK

HD. HORIZONTAL H.P. HIGH POINT HOLLOW STRUCTURAL SECTION (TUBE) **HGT** HEIGHT

INSIDE DIAMETER INSIDE FACE INFORMATION INT. INTERIOR INTERM. INTERMEDIATE

JST. **JOIST JOINT** 

KIPS PER LINEAL FOOT K.S.F KIPS PER SQUARE FOOT **ANGLE** 

POUND LIVE LOAD LONG LEG HORIZONTAL L.L.V. LONG LEG VERTICAL LONG. LONGITUDINAL **LOW POINT** LTWT. LIGHT WEIGHT MATERIAL MAXIMUM

**MECHANICAL** MIDDLE MINIMUM MISCELLANEOUS MFR. MANUFACTURER MTL. METAL

NO. OR # NUMBER NOMINAL NEAR SIDE NOT TO SCALE O.C. ON CENTER **OUTSIDE DIAMETER** 

NOT IN CONTRACT

O.D. O.F. **OUTSIDE FACE** OPPOSITE HAND OPENING OPN. OPP. **OPPOSITE** PARALLEL

PARTITION PART. PRE-CAST CONCRETE POUNDS PER CUBIC FOOT POUNDS PER CUBIC INCH P.C.I. PERP. PERPENDICULAR PLATE

P.S.F. POUNDS PER SQUARE P.S.I. POUNDS PER SQUARE INCH POINT

**RADIUS** REINF. REINFORCEMENT REQ. REQUIRE

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D. YURY X M21-081-004519 🧳 Expiration Date 11.30-2024

ISSUE ISSUE FOR

NO. DESCRIPTION DATE DRAWING TITLE: DESIGN **CRITERIA AND GENERAL NOTES** 

DRAWING NO: **S001** 

SCALE: 3/4" = 1'-0" DATE: ISSUED FOR PROJECT NO: 50-24102 RWN. MBT

24. SEE SPECIFICATIONS FOR ADDITIONAL REQUIREMENTS.

## DATE: ISSUED FOR ROJECT NO: 50-24102

#### **CONCRETE NOTES**

1. ALL CONCRETE WORK SHALL CONFORM TO THE REQUIREMENTS OF ACI 301. THIS DOCUMENT SHALL BE AVAILABLE IN THE CONTRACTOR'S FIELD OFFICE.

2. EXCEPT WHERE OTHERWISE INDICATED, CONCRETETYPES AND MINIMUM 28-DAY COMPRESSIVE STRENGTHS SHALL BE AS FOLLOWS:

Α	COLUMN AND WALL FOOTINGS, ELEVATOR PIT MAT	4,500 PSI REGULAR WEIGHT
В	RETAINING WALLS, FOUNDATION WALLS	4,500 PSI REGULAR WEIGHT
С	SLAB-ON-GRADE	4,000 PSI REGULAR WEIGHT
D	COLUMNS (SEE DWG S)	5,000 PSI REGULAR WEIGHT
Е	ELEVATOR SHAFT WALLS	5,000 PSI REGULAR WEIGHT
F	ELEVATOR FLOOR AND ROOF FRAMING, STAIR SLABS	5,000 PSI REGULAR WEIGHT
G	ALL OTHER	4,000 PSI REGULAR WEIGHT

3. ALL CONCRETE EXPOSED TO MOISTURE AND/OR FREEZE-THAW CYCLES IN SERVICE SHALL BE AIR ENTRAINED WITH 5%-7.5% AIR CONTENT. SEE PROJECT SPECIFICATIONS FOR ADDITIONAL INFORMATION.

4. CEMENT SHALL CONFORM TO ASTM 150 TYPE OR TYPE II. ALTERNATIVELY, CEMENT MAY CONFORM TO ASTM C595 TYPE IS, IP OR IL. FOR ASTM C595 MATERIAL CONTENT OF GROUND GRANULATED BLAST FURNACE SLAG IN TYPE IS OR CONTENT OF POZZOLAN (LIKE FLY ASH) IN TYPE IP SHALL NOT EXCEED PERCENTAGES LISTED IN ACI 301 TABLE 4.2.1.1(b). NO OTHER CEMENTITIOUS ADDITIVE SHALL BE ADDED TO ASTM C595 BLENDED CEMENTS. AGGREGATES FOR CONCRETE SHALL CONFORM TO ASTM C33 (REGULAR WEIGHT), U.N.O. ALL CONCRETE SHALL CONTAIN AN APPROVED WATER REDUCING ADMIXTURE. NO CALCIUM CHLORIDE SHALL BE USED I ANY CONCRETE. SEE PROJECT SPECIFICATIONS FOR ADDITIONAL INFORMATION.

5. ALL REINFORCING BARS SHALL CONFORM TO ASTM A615 OR ASTM A706, GRADE 60, UNLESS NOTED OTHERWISE ON THE DRAWINGS. WHERE WELDING OF REINFORCEMENT BARS IS REQUIRED, USE STEEL BARS CONFORMING TO ASTM A706 GRADE 60, UNLESS NOTED OTHERWISE. ALL WELDED WIRE FABRIC SHALL CONFORM TO ASTM A185. REFER TO THE PROJECT SPECIFICATIONS FOR REQUIREMENTS RELATIVE TO COATED REINFORCEMENT.

6. ALL MILD STEEL REINFORCEMENT SHALL BE DETAILED, FABRICATED, LABELED, SUPPORTED AND SPACED IN FORMS AND SECURED IN PLACE IN ACCORDANCE WITH THE ACI DETAILING MANUAL SP-066, LATEST EDITION. BAR SUPPORTS IN CONTACT WITH SURFACES EXPOSED TO EARTH, VIEW OR WEATHER SHALL BE PLASTIC TIPPED.

7. ALL 135° HOOKS SHALL BE MINIMUM 6d, WHERE 'd" IS BAR DIAMETER. ALL OTHER HOOKS SHALL BE STANDARD ACI 90° OR 180° HOOKS. SEE NOTE 14 HEREIN BELOW FOR HOOKED REBAR DEVELOPMENT REQUIREMENTS.

8. MNIMUM CLEAR SPACING OF PARALLEL MILD STEEL REINFORCING BARS IN A LAYER SHALL NOT BE LESS THAN A BAR DIAMETER (USE LARGER OF THE TWO ADJACENT BARS FOR DISSIMILAR SIZES), BUT SHALL NOT BE LESS THAN ONE (1) INCH. FOR BUNDLED BARS, USE EQUIVALENT DIAMETER OF A BUNDLE BASED ON CROSS-SECTIONAL AREA. WHERE PARALLEL BARS ARE TO BE PLACED IN TWO (2) OR MORE LAYERS, PLACE UPPER LAYER BARS DIRECTLY ABOVE THE LOWER LAYER BARS. CLEAR DISTANCE BETWEEN THE ADJACENT LAYERS SHALL NOT BE LESS THAN ONE

9. UNLESS OTHERWISE NOTED, PROVIDE CLEAR COVER TO REINFORCEMENT IN ALL CAST-IN-PLACE CONCRETE AS FOLLOWS, BUT IN NO CASE LESS THAN THE VALUES INDICATED IN ACI 301 ART. 3.3.2.3:

MEMBER TYPE	EXPOSED	NOT EXPOSED
CAST AGAINST AND PERMANENTLY EXPOSED TO EARTH	3"	-
EXPOSED TO EARTH OR WEATHER, U.N.O.	2"	-
BEAM - TO STIRRUP	1.5"	1.5"
BEAM - TO PRIMARY REBAR	2"	-
COLUMN - TO TIES	2"	1.5"
CRASH WALL, PARAPET	1.5"	-
SLAB - TOP	2"	.75"
SLAB - BOTTOM (INTERIOR)	1"	.75"
SLAB - BOTTOM (EXTERIOR)	1.5"	1"
WALL	2"	1"

\*"EXPOSED" IN THE ABOVE TABLE MEANS UNDERGOING FREEZE-THAW CYCLES AND MOISTURE IN SERVICE.

10.ALL SLABS-ON-GRADE (S.O.G.) SHALL BE REINFORCED WITH STRUCTURAL FIBER OR MILD STEEL REINFORCEMENT AS NOTED ON PLANS. WHERE NEITHER FIBER NOR STEEL REINFORCEMENT IS NOTED ON THE DRAWINGS, PROVIDE AT LEAST ONE (1) LAYER OF 6x6-W2XW2 W.W.F., UNLESS NOTED OTHERWISE. PROVIDE ONE (1) LAYER OF 6x6-W1.4xW1.4 CONTINUOUS IN ALL CONCRETE FILLS OVER THE STRUCTURAL SLAB OR S.O.G., UNLESS NOTED OTHERWISE. ALL WELDED WIRE FABRIC REGARDLESS OF SLAB COMPONENT SHALL BE FURNISHED IN SHEETS (NOT ROLLS), AND SHALL BE PROPERLY SUPPORTED ON APPROPRIATE CHAIRS/BOLSTERS AND TIED DOWN SECURELY. SHEET SHALL BE LAPPED TWO FULL PANELS.

11.PROVIDE ADEQUATE BOLSTER, HI-CHAIRS, SUPPORT BARS, ETC., TO MAINTAIN MINIMUM SPECIFIED CLEAR CONCRETE COVER FOR THE ENTIRE LENGTH OF ANY AND ALL BARS. PROVIDE CONTINUOUS #4 SPACER BARS IN WALLS AND SLABS TO SUPPORT DOWELS. HEAVIER SPACER BATS MAY BE REQUIRED IN BEAMS TO ALLEVIATE CONGESTION IN THE PRESENCE OF TENDON BUNDLES AND MILD STEEL REINFORCEMENT IN THE SAME OR IN PARALLEL LAYERS.

12. SPLICES OF REINFORCEMENT SHALL BE MADE ONLY WHERE REQUIRED OR PERMITTED ON THE CONTRACT DRAWINGS OR IN PROJECT SPECIFICATIONS, OR SPECIFICALLY AUTHORIZED BY THE ENGINEER. WHHEREEVER PERMITTED, SPLICING MAY BE OF MECHANICAL TYPE OR LLAP SPLICE TYPE. MECHANICAL SPLICES SHALL BE CAPABLE OF DEVELOPING 125% OF BAR YIELD STRENGTH. FOR MECHANICALLY SPLICED OR LAP SPLICED DISSIMILAR BARS USE SMALLER BAR YIELD STRENGTH OR TABULATED LAP LENGTH RESPECTIVELY TO DETERMINE THE REQUIRED MINIMUM MECHANICAL SPLICER STRENGTH OR LAP LENGTH. PLACEMENT OF SPLICES REGARDLESS OF TYPE, SHALL BE MADE AT POINTS OF MINIMUM STRESS AS MUCH AS POSSIBLE. WHERE NOT SPECIFICALLY INDICATED, DOWELS SHALL MATCH SIZE, NUMBER AND SPACING OF THE MAIN REINFORCEMENT ONTO WHICH THEY ARE BEING SPLICED, UNLESS NOTED OTHERWISE. NO LAP SPLICES SHALL BE PERMITTED IN INDIVIDUAL SPREAD FOOTING REINFORCEMENT, ELEVATOR PIT MAT REINFORCEMENT AND RETAINING WALL FOOTING TOP SHORT DIRECTION REINFORCEMENT.

13.ALL RENFORCEMENT LAP SPLICES SHALL CONFORM TO THE LAP SPLICE SCHEDULES BELOW. ALL WELDED WIRE FABRIC SHALL BE LAPPED TWO (2) FULL MESH PANELS AND TIED SECURELY.

#### CONCRETE NOTES CONT

				SCHE	EDUL	E NO	. 1 - l	JNCC	ATE	O TO	P BAF	RS					
BAR SIZ	ZE	#	4	#	<sup>!</sup> 5	#	<sup>£</sup> 6	#	<del>!</del> 7	#	<del>!</del> 8	#	:9	#	10	#	11
MIN. SP	ACING	S =	2.5"	S =	2.5"	S=	2.5"	S=	3.0"	S=	3.0"	S =	3.5"	S = 1	3.75"	S = 4	4.25
SPLICE	CLASS	Α	В	Α	В	А	В	А	В	А	В	Α	В	А	В	Α	В
	4000	15	20	19	25	23	29	33	43	37	49	46	60	57	74	68	89
f'c (psi)	4500	14	19	18	23	21	28	31	40	35	46	44	57	54	70	65	84
, ,	5000	14	18	17	22	20	26	29	38	34	44	42	54	51	66	61	80

		SC	CHED	ULE	NO. 2	? - UN	COA	TED (	OTHE	R TH	AN T	OP B	ARS				
BAR SIZ	ΖE	#	4	#	<del>!</del> 5	#	£6	#	<del>!</del> 7	#	8	#	9	#	10	#	11
MIN. SP	ACING	S=	2.5"	S =	2.5"	S =	2.5"	S =	3.0"	S=	3.0"	S=	3.5"	S = 3	3.75"	S = 4	4.25"
SPLICE	CLASS	Α	В	Α	В	Α	В	Α	В	Α	В	Α	В	Α	В	Α	В
	4000	12	15	15	19	18	23	25	33	29	37	36	46	44	57	53	68
f'c (psi)	4500	12	14	14	18	17	21	24	31	27	35	34	44	42	54	50	65
,	5000	12	14	13	17	16	20	23	29	26	34	32	42	39	51	47	61

			SC	HED	ULE I	NO. 3	- EP	YXC	COAT	ED T	OP B	ARS					
BAR SIZ	ZE	#	4	#	5	#	<del>!</del> 6	#	7	#	8	#	:9	#	10	#	11
MIN. SP	ACING	S=	2.5"	S =	2.5"	S=	2.5"	S=	3.0"	S=	3.0"	S =	3.5"	S = 3	3.75"	S = 4	4.25
SPLICE	CLASS	А	В	Α	В	Α	В	Α	В	Α	В	Α	В	Α	В	Α	В
	4000	18	23	23	29	30	38	43	56	49	63	61	79	75	97	89	116
f'c (psi)	4500	17	22	21	28	28	36	40	52	46	60	57	74	70	91	84	109
(1 /	5000	16	21	20	26	26	34	38	50	44	57	54	70	67	87	80	104

	SCHEDULE NO. 4 - EPOXY COATED OTHER THAN TOP BARS																
BAR SIZ	ĽΕ	#	4	#5		#6		#7		#8		#9		#10		#11	
MIN. SP	ACING	S=	2.5"	S=	2.5"	S=	2.5"	S =	3.0"	S=	3.0"	S =	3.5"	S = 3	3.75"	S = 4	4.25"
SPLICE	CLASS	Α	В	Α	В	Α	В	Α	В	Α	В	Α	В	Α	В	Α	В
	4000	14	18	18	23	26	34	38	49	43	56	53	69	66	85	79	102
f'c (psi)	4500	13	17	17	21	25	32	36	46	41	53	50	65	62	81	74	97
, ,	5000	13	16	16	20	23	30	34	44	39	50	48	62	59	76	71	92

**TENSION LAP SPLICE SCHEDULE NOTES:** 

THE FOLLOWING NOTES SHALL APPLY TO THE ABOVE SCHEDULES: REINFORCEMENT IN CONCRETE MEMBERS COVERED BY THESE NOTES SHALL BE IONSTALLED TO A MINIMUM CLEAR CONCRETE COVER IN ACCORDANCE WITH THE TABLE UNDER ITEM (9) HEREIN ABOVE, UNLESS OTHERWISE INDICATED ON THE DRAWINGS. VALUE "S" IN THE ABOVE TABULATION IS THE CENTER-TO-CENTER MINIMUM DISTANCE BETWEEN THE RESPECTIVE SIZE BARS IN A LAYER AS A BASIS

• LAP SPLICING OF BARS LARGER THAN #11 IS NOT PERMITTED, CLEAR VERTICAL SPACING BETWEEN ADJACENT LAYERS OF BARS IN BEAMS OR GIRDERS SHALL NOT BE LESS THAB THAT INDICATED UNDER ITEM (8) ABOVE. FOR CENTER-TO-CENTER OF BARS SPACED CLOSER THAN VALUE "S" IN THE ABOVE TABLE BUT NOT CLOSER IN CLEAR SPACING NOTED UNDER ITEM (8) ABOVE, NOTIFY

FOR THE DEVELOPMENT AND LAP SPLICE LENGTH CALCULATION.

ENGINEER FOR ADJUSTMENT IN THE SPLICE LENGTH AS APPLICABLE. CLEAR SPACING BETWEEN BARS BEING DEVELOPED (OR SPLICED) IN WALLS AND/OR SLABS, SHALL NOT BE LESS THAN TWO (2) TIMES BAR DIAMETER (SMALLER OF THE TWO IN A LAP SPLICE, IF DISSIMILAR).

 FOR PURPOSES OF DEFINING TOP BARS, THOSE INDICATED ON THE CONTRACT DRAWINGS AS "TOP" BARS SHALL BE DETAILED ACCORDINGLY. OTHERWISE, THOSE BARS WHERE MORE THAN TWELVE (12) INCHES OF FRESH CONCRETE IS CAST BELOW THE DEVELOPMENT LENGTH OR SPLICE LENGTH SHALL BE CONSIDERED REQUIRED FOR TOP BARS. EXCEPTION TO THIS SHALL BE WALL HORIZONTAL REINFORCEMENT WHERE ALL BARS SHALL BE CONSIDERED "OTHER THAN TOP

 CLASS "A" SPLICE SHALL BE USED ONLY WHERE SPECIFICALLY REFERENCED ON THE CONTRACT DRAWINGS. IN ALL OTHER CASES THE REQUIRED LAP SPLICE LENGTH SHALL BE THAT OF CLASS "B" SPLICE.

 WHEN REFRENCED ON THE DRAWINGS, FOR TENSION DEVELOPMENT LENGTH USE CLASS "A" LENGTH FROM THE ABOVE SCHEDULES.

14. TENSION DEVELOPMENT LENGTH OF BARS WITH STANDARD HOOKS IS TABULATED ON

THIS DRAWING. SEE DETAIL 1 AND ACCOMPANYING TABLE BELOW. 15. ADDITIONAL REINFORCING BARS SHALL BE PROVIDED AROUND ALL SLAB-ON-GRADE, ELEVATED FLOOR AND WALL OPENINGS IN ACCORDANCE WITH TYPICAL DETAILS, UNLESS

NOTED OTHERWISE. 16. THERE SHALL BE NO FIELD CUTTING OF ANY REINFORCEMENT WITHOUT AN EXPRESSED WRITTEN CONSENT OF THE ARCHITECT. FIELD MODIFICATIONS TO APPROVED

17.ALL FIELD BENDING OF REINFORCEMENT SHALL BE DONE COLD AND SHALL BE APPROVED IN WRITING BY THE ARCHITECT. HEATING OF BARS WILL NOT BE PERMITTED. FIELD BENDING OF REINFORCEMENT LARGER THAN #5 IS NOT PERMITTED, UNLESS

SPECIFICALLY APPROVED IN WRITING BY THE ARCHITECT OR NOTED ON THE DRAWINGS.

SHOP DRAWINGS SHALL NOT BE DONE WITHOUT ARCHITECT'S WRITTEN APPROVAL

18.ALL WALLS AND STRUCTURAL SLABS SHALL BE REINFORCED. EXCEPT FOR POST-TENSIONED CONCRETE SLABS, IN THE EVENT WALL OR SLAB REINFORCEMENT HAS NOT BEEN INDICATED ON THE DRAWINGS, PROVIDE A MINIMUM OF #4@12" EACH WAY, EACH FACE.

19.NO CONSTRUCTION JOINT SHALL BE MADE WIITHOUT ADDITIONAL REINFORCEMENT INSTALLED PERPENDICULAR TO THE PLANE OF THE JOINT. REFER TO TYPICAL DETAILS ON THE CONTRACT DRAWINGS. THE FOLLOWING QUANTITIES ARE MINIMUM IN PERCENT OF CROSS-SECTIONAL AREA OF THE CONCRETE ELEMENT IN THE PLANE OF THE CONSTRUCTION JOINT, UNLESS SPECIFICALLY NOTED OTHERWISE IN SECTIONS AND/OR **DETAILS:** 

STRUCTURAL COMPONENT	LOCATIONS	PERCENTAGE	MIN. TRAVERSE
SLABS	TOP & BOTTOM	0.20%	-
BEAMS	TOP & BOTTOM	0.33%	-
BEAMS	STIRRUPS, EACH SIDE OF VERTICAL JOINT	-	5-#4@8"
COLUMNS	VERTICAL	1.00%	-
COLUMNS	HORIZ. TIES ABOVE & BELOW HORIZ. JOINT	-	5-#4@4"
WALLS	VERTICAL & HORIZ.	-	SEE TYP. DETAILS

### **CONCRETE NOTES CONT**

20. CONSTRUCTION AND CONTROL JOINTS IN STRUCTURES SHALL BE PROVIDED IN ACCORDANCE WITH ACI 301 ARTICLE 2.2.2.5 AND AS FOLLOWS: A. FOR CONVENTIONAL CONSTRUCTION OF SLABS AND BEAMS, PLACE VERTICAL

CONSTRUCTION JOINTS (BETWEEN SUCCESSIVE PLACEMENTS) WITHIN MIDDLE THIRD OF RESPECTIVE SPANS. B. HORIZONTAL CONSTRUCTION JOINTS IN WALLS SHOULD BE AVOIDED. WHEN REQUIRED FOR CONSTRUCTABILITY, PLECE WITHIN MIDDLE THIRD OF VERTICAL

SPAN FOR WALLS SUPPORTED AGAINST HORIZONTAL TRANSLATION AT BOTH THE TOP AND BOTTOM ONLY. C. VERTICAL CONSTRUCTION JOINTS IN WALLS SHALL BE PROVIDED AS PER NOTE 13 UNDER "GENERAL FOUNDATION NOTES" ON DWG. S002, OR WHEREVER CONTROL JOINTS ARE PLACED. LOCATE WALL CONTROL/CONSTRUCTION JOINTS NO FARTHER APART THAN THREE (3) TIMES THE CLEAR WALL HEIGHT OR 25 FEET, WHICHEVER IS LESS, BUT NOT LESS THAN 10 FEET ON-CENTER. FOLLOW TYOICAL DETAILS FRO

JOINT GROOVES AT ALL CONSTRUCTION AND CONTROL JOINTS. D. PROVIDE CONTROL JOINTS CONSTRUCTED WITH THE USE OF CHAMFER STRIPS IN ALL UPTURNED BEAMS AND "CRASH" (VEHICULAR BARRIER) WALLS. EXTEND JOINT OVER THE TOP OF UPTIRNED BEAM OR "CRASH" WALL, AND FILL WITH SPECIFIED SEALANT. IF NOT SPECIFICALLY INDICATED. SPACE SUCH JOINTS AT 10 FT MAXIMUM ON-CENTER.

E. SURFACE OF A MEMBER CROSS-SECTION AT A CONSTRUCTION JOINT SHALL BE INTENTIONALLY ROUGHENED TO A MINIMUM 1/4 INCH AMPLITUDE PRIOR TO PLACEMENT OF ADJACENT CONCRETE SEGMENT. PROVIDE RUGHENING IN A FORM OF HORIZONTAL UNDULATIONS FOR VERTICAL JOINTS IN HORIZONTAL MEMBERS. F. FOR CONVENTIONALLY REINFORCED CONCRETE CONSTRUCTION, STRUCTURE ON EITHER SIDE OF JOINT SHALLE SHORED UNTIL THE AFFECTED MEMBER CONCRETE HAS ATTAINED MINIMUM SPECIFIED 28-DAY COMPRESSIVE STRENGTH. G. FOR POST-TENSIONED CONSTRUCTION, PLACE CONSTRUCTION JOINT SUCH THAT AN INTERMEDIATE STRESSING POINT IS APPROXIMATELY AT A MEMBER MID-DEPTH. GENERALLY, SHORING OF POST-TENSIONED CONCRETE MEMBERS ON EITHER SIDE OF CONSTRUCTION JOINT IS REQUIRED UNTIL THE STRUCTURE IS FULLY STRESSED

WHICH ARE SPECIFICALLY DETAILED. H. IN ALL INSTANCES, LOCATIONS OF ALL CONSTRUCTION JOINTS SHALL BE REVIEWED BY THE ARCHITECT. NO HORIZONTAL CONSTRUCTION JOINTS WILL BE PERMITTED IN BEAMS, SLABS, MATS, FOOTINGS, OR PADS UNLESS SPECIFICALLY SHOWN ON THE DRAWINGS.


AND STRESSING RECORD IS APPROVED BY THE ARCHITECT/ENGINEER. EXCEPTIONS

TO THIS ARE STAGE CONSTRUCTED AND/OR STAGE STRESSED TRANSFER GIIRDERS.

I. ALL CONSTYRUCTION JOINTS SHALL BE WIRE BRUSHED, CLEANED, MOISTENED AND TREATED WITH A CONCRETE SLURRY OR NEAT CEMENT GROUT IMMEDIATELY PRIOR TO PLACING NEW CONCRETE.

21. ISOLATION JOINTS: ALL SLABS-ON-GRADE SHALL BE ISOLATED FROM ADJACENT WALLS AND BUILDING COLUMNS, PIERS OR PILASTERS, PER TYPICAL DETAILS, UNLESS NOTED OTHERWISE.

22.WHERE HOOKED BARS ARE SHOWN ON THE DRAWINGS, PROVIDE ACI STANDARD 90° HOOKS UNLESS SPECIFICALLY SHOWN OR NOTED OTHERWISE. FOR TENSION DEVELOPMENT LENGTH OF HOOKED BARS REFER TO SCHEDULE AND DETAIL 1 BELOW.

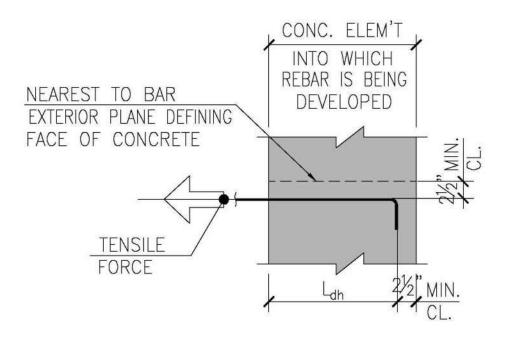



HOOKED BAR DEVELOPMENT TABLE NOTES: 1. SIDE COVER (NORMAL TO PLANE OF HOOK) SHALL NOT BE LESS THAN 21/2". OTHERWISE INCREASE TABULATED VALUES

BY A FACTOR OF 1.4. STANDARD HOOKED BAR (ACI 318-14 TAB. 25.3.1) DEVELOPMENT LENGTHS IN SHADED COLUMNS (FOR COATED BARS) MAY BE USED FOR UNCOATED BARS OF THE SAME SIZE, AT CONTRACTOR'S OPTION.

STANDARD HOOKED BAR DEVELOPMENT LENGTH SCHEDULE								
fc', PSI	4,0	000	5,0	000	7,000			
C - COATED U - UNCOATED	С	U	С	U	С	U		
#4	8"	7"	8"	6"	6"	6"		
#5	10"	9"	9"	8"	8"	7"		
#6	12"	10"	11"	9"	9"	8"		
#7	14"	12"	13"	11"	11"	9"		
#8	16"	14"	15"	12"	12"	10"		
#9	18"	15"	17"	14"	14"	12"		
#10	21"	17"	18"	15"	16"	13"		
#11	23"	19"	20"	17"	17"	15"		

23.PLACE ALL SLABS-ON-GRADE AND SLABS-ON-FILL WITH AN APPROVED PATTERN AND SEQUENCE OF CONTROL AND CONSTRUCTION JOINTS TO MINIMIZE SHRINKAGE CRACKING. REFER TO TYPICAL DETAILS, NOTES AND SUGGESTED JOINT ARRANGEMENT SHOWN ON THESE DRAWINGS.

24.PROVIDE WATERSTOPS AT ALL WALL AND MAT CONTRACTION AND CONSTRUCTION JOINTS BELOW EXTERIOR GRADE AS SHOWN ON THE DRAWINGS. REFER TO THE PROJECT SPECIFICATIONS FOR INFORMATION.

25. FOLLOW ARCHITECTURAL DRAWING SHOWING LOCATIONS OF FLOOR DRAINS AND PITCH ALL SLABS TO DRAIN AS INDICATED ON THE DARWINGS.

26.PROVIDE 3/4" SHAMFER AT EDGES OF ALL CONCRETE ELEMENTS EXPOSED TO VIEW I.E. TOPS OF RETAINING WALLS, "CRASH" WALLS, EDGES OF BEAMS, GIRDERS, COLUMNS, SLABS, ETC. PROVIDE TYPICAL "DRIP" EDGE DETAIL AT ALL STRUCTURE EDGES EXPOSED TO RAIN OR RAIN RUNOFF ON THE WAY TO DRAINS. REFER TO TYPICAL DETAILS. 27. COMPONENTS WITHIN CONCRETE BUILDING FRAME SHALL BE GIVEN THE FOLLOWING PRIORITY FOR REINFORCEMENT, EMBEDMENTS AND HARDWARE PLACEMENT:

1. POST-TENSIONING TENDONS; 2. MILD STEEL REINFORCEMENT

EMBEDDED STRUCTURAL ITEMS SUCH AS PLATES, INSERRTS, ETC.

4. EMBEDDED ARCHITECTURAL ITEMS SUCH AS REGLETS, DRIPS, ETC

5. EMBEDDED CONDUITS AND/OR PIPES.

### **CONCRETE NOTES CONT**

28.NO HORIZONTAL OR NOMINALLY HORIZONTAL ELECTRICAL CONDUITS AND/OR MECHANICAL/PLUMBING PIPES SHALL BE CAST INTO THE SLAB-ON-GRADE, FOOTINGS, FOUNDATION MATS OR PADS. CASTING OF CONDUITS OR PIPES INCLINED TO PLANE OF SLABS OR FOOTINGS IS POSSIBLE BUT NOT DESIRABLE AND SHOULD BE AVOIDED AS MUCH AS POSSIBLE. CASTING OF CONDUITS OR PIPES INTO CONCRETE FOOTINGS, MATS OR PADS, OR SLABS-ON-GRADE SET VERTICALLY IS POSSIBLE, BUT MUST BE APPROVED BY THE ARCHITECT IN WRITING FOLLOWING ENGINEERING REVIEW.

29.ELECTRICAL CONDUITS AND MECHANICAL/PLUMBING PIPES CAST INTO ELEVATED SLABS SHALL BE PLACED BETWEEN THE TOP AND BOTTOM LAYERS OF REINFORCEMENT, IN A WAY NOT CONFLICTING WITH THE POST-TENSIONING TENDONS, WHERE APPLICABLE, AND SHALL NOT HAVE AN OUTSIDE DIAMETER GREATER THAN ONE-FIFTH THE SLAB THICKNESS, UNLESS NOTED OTHERWISE PREFERRED LOCATION OF SUCH FACILITIES WITHIN THE SLAB CROSS-SECTIN IS MID-DEPTH. CROSSOVERS OF CONDUITS AND/OR PIPES ARE UNDESIRABLE. SITUATIONS AFFECTING CONSTRUCTABILITY REQUIRING SUCH FACILITIES SHALL BE REVIEWED BY THE ARCHITECT/ENGINEER FOLLOWING DISCOVERY AND NOTIFICATION BY THE CONTRACTOR. FOR CONDITIONS REQUIRING STRENGTHENING RESULTING FROM ACCOMMODATING CROSSOVERS REFER TO NOTE 36 BELOW. THE CLEAR DISTANCES BETWEEN CONDUITS AND/OR PIPES SHALL NOT BE LESS THAN 1.5 TIMES THE LARGER OF THE TWO ADJACENT DIAMETERS BUT IN NO CASE SHALL A CLEAR SPACING BE LESS THAN TWO (2) INCHES. REFER TO THE PROJECT SPECIFICATIONS FOR MORE INFORMATION.

30.IN SLABS, NO CONDUITS OR PIPES SHALL BE PLACED CLOSER THAN TWELVE (12) INCHES TO A COLUMN FACE OR EDGE OF CONCRETE. UNLESS NOTED OTHERWISE.

31.DOWELS IN FOUNDATION STRUCTURES FOR THE CONSTRUCTION IMMEDIATELY ABOVE HAVE GENERALLY BEEN IDENTIFIED ON THE DARWINGS. IF NO DOWELS ARE INDICATED. PROVIDE AS A MINIMUM NUMBER AND SIZE MATCHING THAT OF RESPECTIVE WALL, PIER, COLUMN, ETC. IMMEDIATELY ABOVE.

32.NO BEAM OR SLAB REINFORCEMENT SHALL BE SLEEVED THROUGH OR OTHERWISE INTERRUPTED, EXCEPT AS SHOWN ON THE STRUCTURAL DRAWINGS.

33.NO ALUMINUM OF ANY TYPE SHALL BE ALLOWED IN THE CONCRETE WORK, UNLESS COATED TO PREVENT ALUMINUM-CONCRETE REACTION AND REVIEWED AND APPROVED BY THE ARCHITECT.

34.DESIGN OF FORMWORK FOR CONCRETE SHALL BE THE RESPONSIBILITY OF THE CONTRACTOR. THE DESIGN SHALL INCLUDE ALL FORCES ACTING UPON FORMWORK BEFORE, DURING AND AFTER CONCRETE PLACEMENT. THE CONTRACTOR'S PROFESSIONAL ENGINEER SPECIALIZING IN FORMWORK/SHORING DESIGN AND CURRENTLY LICENSED TO PRACTICE IN THE STATE OF ILLINOIS, SHALL DESIGN ALL FORMWORK AND ASSOCIATED SHORING, BRACING AND ANCHORAGE. SEE ALSO NOTES 36 AND 37 BELOW.

35.EACH SUBCONTRACTOR SHALL PROVIDE SLEEVES IN CONCRETE FORMWORK SLEEVE LOCATION AND SIZES SHALL BE SUBMITTED TO AND APPROVED BY THE CONTRACTOR DURING COORDINATION.

36.PLACEMENT OF SLEEVES BY ALL TRADES SHALL BE COORDINATED BY THE CONTRACTOR AND SUBMITTED TO THE ARCHITECT IN THE FORM OF COMPOSITE DRAWING SUMMARIZING ALL REQURED SLEEVES AND PENETRATION PER GIVEL LEVEL OF THE STRUCTURE FOLLOWING THIS COORDINATION. NO CORING OF THE CONCRETE WORK WILL BE ALLOWED WITHOUT AN EXPRESSED WRITTEN CONSENT OF THE ARCHITECT. TYPICAL SLEEVE PLACEMENT DETAILS AND MAXIMUM SLEEVE SIZES AND SPACING ARE SHOWN ON THE CONTRACT DRAWINGS. PLACEMENT. SPACING OR SIZING OF SLEEVES NOT IN ACCORDANCE WITH THE DRAWINGS MAY RESULT IN RE-SIZING OF MEMBERS, ADDED REINFORCEMENT OR OTHER STRENGTHENING REQUIRING RE-DESIGN. ALL SUCH CHANGES IN THE STRUCTURE DESIGN SHALL BE CONTRACTOR'S RESPONSIBILITY.

37. CONCRETE TESTING WILL BE PERFORMED BY THE OWNER'S TESTING LABORATORY IN ACCORDANCE WITH ACI 301 SUBSECTION 1.6 AND THE PROJECT SPECIFICATIONS. ACCEPTANCE OF CONCRETE WILL BE BASED ON THE RESULTS OF FIELD TESTING AS OUTLINED IN THE SOPECIFICATIONS AS WELL AS ON THE LAB STRENGTH TESTING. EARLY CONCRETE STRENGTH AS REQUIRED FOR STRESSING OR FORM REMOVAL SHALL NOT BE CONSIDERED AN ACCEPTANCE CRITERION. DETERMINATION OF THIS STRENGTH TO ASCERTAIN CONSTRUCTABILITY SHALL BE PART OF THE TESTING SCOPE OF WORK PROVIDED BY THE CONTRACTOR.

38. FORMWORK FOR SLABS AND BEAMS SHALL BE CAMBERED TO COMPENSATE FOR DEFLECTIONS OF SHRING/FORMWORK SYSTEM DUE TO CONSTRUCTION LOADS. THIS CAMBER SHALL BE IN ADDITION TO THAT SHOWN ON THE CONTRACT DRAWINGS, IF

39. FORMWORK DESIGN FOR POST-TENSIONED STRUCTURES SHALL INCLUDE THE EFFECT OF STRESSING SEQUENCE UPON FORMWORK FRAMING, AND MUST BE COORDINATED WITH POST-TENSIONING SYSTEM MANUFACTURER.

41.SHOP DRAWINGS SHOWING REINFORCING DETAILS INCLUDING STEEL REBAR

SIZES, SPACING AND PLACEMENT SHALL BE SUBMITTED TO THE ARCHITECT FOR

40.THE CONTRACTOR SHALL SUBMIT DETAILED DRAWINGS SHOWING LOCATIONS OF ALL CONSTRUCTION JOINTS, REVEALS, CURBS, SLEEVES, OPENINGS, ETC.

REVIEW PRIOR TO FABRICATION. 42. THE CONTRACTOR SHALL INCLUDE INTO THE BASE BID CONTRACT THE COST OF SUPPLYING AND INSTALLING 1,000 LBS (INCLUDING 500 LBS EPOXY COATED) OF

COMPENSATED FOR PROVISIONS NOT USED. 43. THE CONTRACTOR SHALL INCLUDE INTO THE BASE BID CONTRACT THE COST FOR ROUTING AND SEALING OF 400 LINEAL FEET OF CONCRETE CRACKS AS DIRECTED BY THE ARCHITECT. THE OWNER SHALL BE COMPENSATED FOR THE UNUSED SEALED

ADDED REINFORCING BARS AS DIRECTED BY THE ARCHITECT. THE OWNER SHALL BE

44.ITEMS 42 AND 43 ABOVE ARE ALLOWANCE ITEMS. THE CONTRACTOR MUST PROVIDE UNIT PROCES FOR THESE ITEMS, AND WILL BE PAID FOR QIUANTITIES ACTUALLY INSTALLED.

45.SEE PROJECT SPECIFICATIONS FOR ADDITIONAL REQUIREMENTS

CRACK LENGTH.

STRENGTH OF 270,000 PSI.

2. THE POST-TENSIONING TENDONS SHALL BE COATED WITH CORROSION INHIBITIVE COATING AND WRAPPED IN WATERTIGHT EXTRUDED PLASTIC SHEATH AS SPECIFIED. TENDONS SET IN PLACE READY FOR CONCRETE PLACEMENT, SHALL BE IN SATISFACTORY CONDITION.

3. THE OWNER'S TESTING AGENCY SHALL INSPECT ALL TENDONS IN PLACE PRIOR TO CONCRETE PLACEMENT. ANY DAMAGE TO SHEATHING, STRANDS OR OTHER UNSATISFACTORY CONDITIONS SHALL BE REPAIRED IN ACCORDANCE WITH RECOMMENDATIONS OF PTI FIELD PROCEDURES MANUAL FOR UNBONDED SINGLE STRAND TENDONS IN AGGRESSIVE ENVIRONMENTS. SUBJECT TO CUMULATIVE SPECIFIED LIMIT OF SHEATH DAMAGE PER TENDON, THE REPAIR SHALL BE OBSERVED AND APPROVED BY THE OWNER'S TESTING AGENCY'S REPRESENTATIVE PRIOR TO CONCRETE PLACEMENT.

4. ANCHORAGES FOR POST-TENSIONING TENDONS SHALL BE DESIGNED BY THE SYSTEM MANUFACTURER PER ACI 318 CODE AND COMMENTARY. SAMPLES OF ANCHORAGES IN INDUSTRY-WIDE USE FOR LESS THAN FIVE (5) YEARS SHALL BE SUBMITTED TO THE ARCHITECT FOR APPROVAL.

5. UNLESS OTHERWISE SPECIFIED ON THE DRAWINGS, TENDONS SHALL BE PLACED VERTICAL PROFILE OF SMOOTH PARABOLIC CURVES BETWEEN POINTS DIMENSONED HIGH AND LOW POINTS CORRESPOND TO SUPPORT (COLUMN OR BEAM) CENTERLINE AND MID-SPAN RESPECTIVELY. UNLESS OTHERWISE NOTED. ALL DIMENSIONS LOCATING TENDON PROFILES APPLY TO THE CENTER OF GRAVITY OF THE GROUP OF TENDONS. TENDON PLACEMENT SHALL NOT VARY BY MORE THAN 1/4 INCH VERTICALLY FROM THE POINTS DIMENSIONED.

6. LOCATION OF INFLECTION POINT OR TANGENT POINT OF CURVATURE REVERSAL FROM THE CENTERLINE OF SUPPORT SHALL BE L/10 FOR SLABS AND L/20 FOR BEAMS, WHERE "L" IS THE SPAN CENTER-TO-CENTER OF SUPPORTS, UNLESS NOTED OTHERWISE.

7. AT THE TIME OF STRESSING OF THE TENDONS AT NOT EARLIER THAN 48 HOURS AND NOT LATER THAN 72 HOURS AFTER CONCRETE PLACEMENT, POST-TENSIONED CONCRETE SHALL HAVE A MINIMUM COMPRESSIVE STRENGTH OF 3,000 PSI. THE CONTRACTOR SHALL SUBSTANTIATE ADEQUATE CONCRETE COMPRESSIVE STRENGTH BEFORE STRESSING TENDONS. IF CONCRETE FAILS TO REACH COMPRESSIVE STRENGTH OF 3.000 PSI IN 72 HOURS, THE CONTRACTOR SHALL CONTACT THE ARCHITECT FOR GUIDELINES OF PARTIAL STRESSING OF TENDONS.

8. THE NORMAL SEQUENCE OF STRESSING FOR ONE-WAY CONSTRUUCTION (SLAB, BEAMS) SHALL BE AS FOLLOWS:

- A. SLAB TEMPERATURE TENDONS
- **B. SLAB MAIN TENDONS**
- C. BEAM TENDONS D. GIRDER TENDONS

9. TENDONS MAY BE TEMPORARILY OVERSTRESSED TO A MAXIMUM OF 0.8\*Fpu AND LOCKED OFF AT A MAXIMUM STRESS OF 0.7\*Fpu, WHERE Fpu IS SPECIFIED TENSILE STRENGTH OF PRESTRESSING STEEL. FRICTION LOSSES SHALL BE BASED ON EXPERIMENTALLY DETERMINED WOBBLE AND CURVATURE COEFFICIENTS FROM TEST CONDUCTED BY THE POST-TENSIONING SYSTEM MANUFACTURER NOT OLDER THAN TWELVE (12) MONTHS FROM COMMENCEMENT OF THIS PROJECT. IN THE EVENT OF THIS DATA NOT BEING AVAILABLE, THE POST-TENSIONING SYSTEM MANUFACTURER SHALL CONDUCT THE NECESSARY TESTING IN THE FIELD DURING THE FIRST OCCURRENCE OF THE STRESSING OPERATINS, UNLESS OTHERWISE ACCEPTABLE TO THE ARCHITECT.

10. THE POST-TENSIONING SYSTEM MANUFACTURER SHALL SUBMIT FRICTION LOSS AND TENDON ELONGATION CALCULATIONS, STRAND MILL CERTIFICATES, ANCHORAGES TEST RESULTS, AS WELL AS WOBBLE ANDD CURVATURE COEFFICIENT DETERMINATION DATA TO SUBSTANTIATE THE METHOD OF TENDON FINAL EFFECTIVE FORCE CALCULATIONS. WHEN THE LATTER IS NOT AVAILABLE, INITIAL DETERMINATION OF STRESSED TENDON ELONGATIONS FOR THE FIRST ELEVATED CONCRETE PLACEMENT SHALL BE BASED ON WOBBLE FRICTION COEFFICIENT OF K=0.0015 AND CURVATURE COEFFICIENT m=0.07. EXPERIMENTAL DETERMINATION OF THESE COEFFICIENTS AS DESCRIBED IN THE PROJECT SPECIFICATIONS, SHALL TAKE PLACE DURING CONSTRUCTION OF THE FIRST ELEVATED CONCRETE SEGMENT. FOLLOWING ARCHITECT'S REVIEW OF THE RESULTS, TENDON ELONGATIONS FOR ALL SUBSEQUENT PLACEMENTS MUST BE RE-CALCULATED BY THE POST-TENSIONING SYSTEM MANUFACTURER AND RE-SUBMITTED TO THE ARCHITECT FOR RECORD.

11.THE POST-TENSIONING SYSTEM MANUFACTURER SHALL SUBMIT TO THE ARCHITECT FOR APPROVAL ENGINEERED AND CHECKED SHOP DRAWINGS SEALED AND SIGNED BY A PROFESSIONAL ENGINEER CURRENTLY LICENSED TO PRACTICE IN THE STATE OF ILLINOIS SHOWING, AS A MINIMUM. THE FOLLOWING:

- A. FOR SLABS, TENDON LAYOUT AND DIMENSIONS LOCATING TENDONS IN PLAN, TENDON CURVATURE AT BLOCKOUTS, ALL OPENINGS, ANCHORAGES CHAIR HEIGHTS AND LOCATIONS, ANY PLACEMENT STEEL, IF REQUIRED. EACH TENDON MUST BE UNIQUELY MARKED.
- B. FOR BEAMS/GIRDERS, TENDON PROFILE IN ELEVATION, ALL OPENINGS
- ANCHORAGES AND ANY PLACEMENT STEEL
- C. FOR ALL STRUCTURES, LOCATION OF EACH TENDON, METHOD OF TENDON SUPPORT DETAILS OF ANCHORAGE ZONE REINFORCEMENT, STRESSING POCKETS, CLOSURES,
- D. FOR ALL STRUCTURES WITH POST-TENSIONING TENDONS, ALL ANTICIPATED ELONGATIONS AT EACH STRESSING POINT AND SEQUENCE OF STRESSING AT ANCHORAGE CLUSTERS, IF ANY.

12.THE REQURED POST-TENSIONING IS QUANTIFIED ON THE DRAWINGS BY EITHER THE NUMBER OF TENDONS (BEAM AND GIRDER TENDONS AND SLAB TEMPERATURE TENDONS) OR EFFECTIVE FORCE (UNIFORMLY SPACED SLAB TENDONS). WHERE FORCE IS CALLED OUT AS Fe = XX.X k/ft, IT SHALL BE INTERPRETED AS AN AVERAGE FINAL EFFECTIVE FORCE ALONG THE STRESSING LENGTH AFTER ALL LOSSES.

13. THE POST-TENSIONING SYSTEM MANUFACTURER SHALL CALCULATE THE EFFECTIVE MINIMUM PRE-STRESSING FORCE PER TENDON AFTER ALL LOSSES ALONG THE STRESSING LENGTH IN ALL SLABS DESIGNED WITH POST-TENSIONING. FOR BEAMS AND GIRDERS, THE EFFECTIVE PRESTRESSING FORCE SHALL BE THE MINIMUM EFFECTIVE PRE-STRESSING FORCE PER TENDON AFTER ALL LOSSES FOR MULTI-SPAN BEAMS/GIRDER. FOR SINGLE SPAN BEAM/GIRDER THE EFFECTIVE PRESTRESSING FORCE PER TENDON SHALL BE THE AVERAGE PRE-STRESSING FORCE PER TENDON ALONG STRESSING LENGTH AFTER ALL LOSSES.

14.EFFECTIVE PRE-STRESSING FORCE CALCULATIONS SHALL BE BASED ON TENDON PROFILES AND PROPERTIES. CONCRETE PROPERTIES. LOCAL AVERAGE AMBIENT RELATIVE HUMIDITY, TIME OF STRESSING AND COORDINATED LOCATIONS OF CONSTRUCTION JOINTS. ALL EFFECTIVE PRE-STRESSING FORCE CALCULATIONS SHALL BE SEALED AND SIGNED BY A PROFESSIONAL ENGINEER CURRENTLY LICENSED TO PRACTICE IN THE STATE OF ILLINOIS AND SHALL BE SUBMITTED TO THE ARCHITECT FOR APPROVAL

15.THE CALCULATED FINAL EFFECTIVE FORCE PER TENDON IN SLABS (SEE ITEM 13 ABOVE) SHALL BE COMPARED AGAINST THE DESIGN PRESTRESSING FORCE PER TENDON UNDER ITEM (17.A) BELOW WITH THE LESSER OF THE TWO VALUES USED TO DETERMINE THE NUMBER OF TENDONS IN SLABS.

16.IN BEAMS AND GIRDERS, THE CALCULATED FINAL EFFECTIVE FORCE PER TENDON SHALL BE COMPARED AGAINST THE DESIGN PRESTRESSING FORCE PER TENDON UNDER ITEM (17.B) BELOW. IN THE EVENT THE FORMER IS LESS THAN THE LATTER, THE INDICATED TOTAL NUMBER OF TENDONS IN A BEAM OR GIRDER SHALL BE ADJUSTED UPWARD BY THE RATIO OF THE LARGER VALUE TO THE LESSER. NO REDUCTION IN THE NUMBER OF TENDONS WILL BE ALLOWED IN BEAMS/GIRDERS.

17.THE DESIGN FINAL EFFECTIVE FORCES PER TENDON IN THE STRUCTURE ELEMENT SHALL NOT BE LESS THAT THE FOLLOWING:

A. FOR SLABS, FINAL EFFECTIVE PRESTRESSING FORCE PER 0.5" DIAMETER TENDON SHALL NOT EXCEED 25 KIPS.

B. FOR BEAMS AND GIRDERS. THE NUMBER OF 0.5" DIAMETER TENDONS IN EACH REQUIRED IS BASED ON AN EFFECTIVE PRESTERESSING FORCE OF 26.5 KIPS PER TENDON AFTER ALL LOSSES.

#### POST-TENSIONED CONCRETE NOTES CONT

18. THE POST-TENSIONING SYSTEM MANUFACTURER SHALL SUBMIT TOO THE ARCHITECT FOR REVIEW, DETAILED PRESTRESSING PROCEDURED AND SEQUENCES AS WELL AS DETAILED CALCULATIONS TO SUBSTANTIATE THE ABOVE. ALL PRESTRESSING LOSSES SHALL BEACCOUNTED FOR IN CALCULATIONS

19. COMPLETE POST-TENSIONING PROCEDURE SHALL INCLUDE, AS A MINIMUM, THE FOLLOWING:

- A. JACKING FORCES AND JACKING PRESSURES, INCLUDING BUT NOT LIMITED TO MAXIMUM TEMPORARY JACKING FORCE AND JACKING PRESSURE: B. CERTIFIED JACK-GAGE-PUMP COMBO CALIBRATION DATA AND METHOD OF JACK IDENTIFICATION; EACH SUCH COMBO TO BE USED ON THE JOB SHALL BE CALIBRATED NO LATER THAN ONE (1) MONTH PRIOR TO ITS USE;
- D. ANTICIPATED ELONGATION OF EACH TENDON AT EACH JACKING POINT; E. METHOD OF DETERMINING ANCHOR FORCE OR FORCE REMAINING IN A TENDON
- AFTER ANCHORAGE: F. METHOD OF REMOVING AN EXCESS TENDON LENGTH AFTER ANCHORAGE:
- G. METHOD OF SEALING TENDONS AND CLOSING STRESSING POCKETS;

H. SAMPLE STRESSING RECORD.

C. METHOD OF DETERMINING THE SLACK;

20. THE CONTRACTOR SHALL SUBMIT TO THE ARCHITECT A CONCRTETE PLACEMENT SEQUENCE FOR APPROVAL. ALL CONSTRUCTION JOINT SHALL BE CLEARLY DEFINED AND DIMENSIONED.

21.ALL TENDONS SHALL BE SECURELY SUPPORTED AT INTERVALS NOT EXCEEDING 48 INCHES ON-CETER, 36 INCHES RECOMMENDED. A MINIMUM OF TWO 92) TENDONS SHALL PASS THROUGH EACH COLUMN IN EACH PRINCIPAL DIRECTION.

22.ALL OPENINGS IN POST-TENSIONED SLABS AND/OR BEAMS SHALL BE FORMED OR SLEEVED. CORING OF POST-TENSIONED BEAMS OR SLABS WILL NOT BE PERMITTED WITHOUT THE WRITTEN CONSENTS OF THE ARCHITECT. ALL OPENINGS AND/OR SLEEVES MUST BE SHOWN ON THE SHOP DRAWINGS. ANY ADDITIONAL OPENINGS NOT SHOWN ON THE APPROVED SHOP DRAWINGS WILL REQUIRE A WRITTEN APPROVAL FROM THE ARCHITECT PRIOR TO CONSTRUCTION. THE CONTRACTOR SHALL PROVIDE ADDITIONAL REINFORCEMENT AROUND ALL OPENINGS IN ACCORDANCE WITH TYPICAL DETAILS OR AS REQUIRED BY SPECIFIC DETAILS ON THE DRAWINGS.

23. THE DESIGN OF THE STRUCTURE DOES NOT INCLUDE CLOSURE STRIPS SOMETIMES REQUIRED FOR CONSTRUCTABILITY. THE ARCHITECT/ENGINEER RESERVES THE RIGHT TO MODIFY DRAWINGS BY PROVIDING CLOSURE STRIP(S) WHEN SPECIFICALLY REQUESTED BY THE CONTRACTOR FOR CONSTRUCTABILITY. COSTS ASSOCIATED WITH SUCH MODIFICATION/REVISION INCLUDING BUT NOT LIMITED TO THE DESIGN OF THE CLOSURE STRIP(S) SHALL BE THE RESPONSIBILITY OF THE CONTRACTOR.

24. MAXIMUM PERMITTED PENETRATION INTO THE POST-TENSIONED CONCRETE SLABS AND BEAMS DUE TO DRILLED-IN POST-INSTALLED INSERTS SHALL NOT EXCEED 3/4" AND 1 1/2" RESPECTIVELY. PROVIDE CAST-IN INSERTS FOR HANGING DUCTS, PIPES OR OTHER MECHANICAL EQUIPMENT WHERE POSSIBLE, AND WHERE THE SPECIFIED MAXIMUM EMBEDMENT OF A DRILLED-IN POST-INSTALLED INSERT WILL NOT PROVIDE SUFFICIENT CAPACITY.

25.PRESTRESSING FORCE TRANSFERRED TO THE STRUCTURE (DERIVED FROM THE ACTUAL TENDON ELONGATIONS PER THE STRESSING RECORD) SHALL BE APPROVED BY THE ARCHITECT BEFORE TERMINATION OF ANY TENDN ENDS OR CONCRETING THE ADJACENT PART, OR INTRODUCING A CONTINUITY OF THE STRUCTURE THAT WOULD PREVENT ANY REMEDIAL WORK TO BE PERFORMED ON CONCRETE OR TENDONS IDENTIFIED BY THE RECORD.

26.AFTER ACCCEPTANCE AND APPROVAL OF STRESSING RECORDS BY THE ARCHITECT, FOR TENDONS TO TERMINATE CUT OFF TENDON TAILS ABOUT 1/2" INSIDE THE POCKET AS SPECIFIED. SEAL TENDON TAILS WITH RUST INHIBITING TREATMENT AND POSITIVELY CONNECTED GASKETED PLASTIC CAP, AND DRY-PACK ALL POST-TENSIONING POCKETS WITH NON-SHRINK, NON-FERROUS GROUT AS SPECIFIED. THE FINAL COLOR AND FINISH OF THE POCKET INFILL IN EXPOSED AREAS SHALL MATCH THE ADJACENT CAST-IN-PLACE CONCRETE AS VERIFIED AND APPROVED BY THE ARCHITECT PRIOR TO INSTALLATION.

27.SEE SPECIFICATIONS FOR FURTHER REQUIREMENTS FOR ALL POST-TENSIONED CONCRETE WORK.

### STRUCTURAL MASONRY NOTES

1. ALL MATERIAL AND WORKMANSHIP SHALL BE IN ACOORDANCE WITH THE SPECIFICATION FOR MASONRY STRUCTURES ACI 530.1-05.

#### 2. MATERIALS:

- A. LOAD-BEARING CONCRETE MASONRY UNITS SHALL CONFORM TO ASTM C90, TYPE 1 WITH A MINIMUM UNIT COMPRESSIVE STRENGTH OF 2,150 PSI ON THE NET SECTION. B. BUILDING BRICK OR FACE BRICK SHALL CONFORM TO ASTM C216 GRADE SW WITH A MINIMUM UNIT COMPRESSIVE STRENGTH OF 3,000 PSI. C. MORTAR AND GROUT:
- a. MORTAR FOR REINFORCED AND UNREINFORCED MASONRY SHALL CONFORM TO ASTM C270, PORTLAND-LIME, TYPE N BY PROPORTION, TO ACHIEVE A MINIMUM COMPRESSIVE STRENGTH OF 1.000 PSI. b. GROUT SHALL CONFORM TO ASTM C476, TO ACHIEVE A MINIMUM COMPRESSIVE
- STRENGTH OF 2,000 PSI. D. MASONRY: COMPRESSIVE STRENGTH I'm OF ANY MASONRY SHALL BE DETERMINED
- BASED ON THE STRENGTH OF THE UNITS AND SHALL NOT BE LESS THAN 1,500 PSI. E. STEEL REINFORCING: VERTICAL AND HORIZONTAL REBAR AND SHOP FABRICATED STIRRUPS WHERE APPLICABLE FOR REINFORCED MASONRY SHALL CONFORM TO ASTM A615, GRADE 60, UNLESS NOTED OTHERWISE. MASONRY JOINT LADDER OR TRUSS REINFORCEMENT SHALL CONFORM TO ASTM A951, HOT DIP GALVANIZED, UNLESS NPOTED OTHERWISE IN THE PROJECT SPECIFICATIONS.
- 3. VERTICAL CELLS TO BE FILLED WITH GROUT SHALL BE ALIGNED TO PROVIDE A CONTINUOUS. UNOBSTRUCTED OPENING OF THE DIMENSIONS SHOWN IN TYPICAL DETAILS ON THESE DRAWINGS. CELLS WHICH CONTAIN VERTICAL REINFORCEMENT SHALL HAVE A MINIMUM OF 2"x2" CLEAR OPENING.
- 4. GROUT FOR FILLING REINFORCED OR UNREINFORCED CELLS, COURSES OR BOND BEAMS OF THE CONCRETE MASONRY SHALL BE FLUID WITH A 9" TO 11" SLUMP, AND PLACED BY ACCEPTABLE PRESSURE GROUTING PROCEDURES.
- 5. GROUT FOR FILLING REINFORCED OR UNREINFORCED CELLS SHALL BE PLACED IN MAXIMUM FOUR (4) FOOT LIFTS AND CONSOLIDATED IN PLACE BY VIBRATION OR OTHER ACCEPTABLE METHODS WHICH INSURE COMPLETE FILLING OF THE CELLS. ALL CELLS CONTAINING REINFORCING BARS AND/OR ANCHOR BOLTS SHALL BE FULLY GROUTED.
- 6. HOLLOW UNITS SHALL BE LAID WITH FULL MORTAR COVERAGE ON HORIZONTAL AND VERTICAL FACE SHELLS EXCEPT THAT WEBS SHALL ALSO BE BEDDED WHERE THEY ARE ADJACENT TO CELLS TO BE REINFORCED AND/OR FILLED WITH GROUT, IN THE STARTING COURSE ON FOOTINGS AND SOLID FOUNDATION WALLS AND IN NON-REINFORCED OR GROUTED PIERS, PILASTERS AND COLUMNS.
- 7. SOILD MASONRY UNITS WHERE REQUIRED OR OTHERWISE SELECTED BY THE CONTRACTOR FOR USE, SHALL BE LAID WITH FULL HEAD AND BED JOINTS.
- 8. POINTS OF BEARING SHALL BE ON TWO (2) COURSES OF SOLID MASONRY OR TWO (2) COURSES OF HOLLOW MASONRY GROUTED SOLID.

9. ALL CUTTING AND FITTING OF MASONRY, INCLUDING THAT REQUIRED TO ACCOMMODATE THE WORK OF OTHER TRADES, SHALL BE DONE WITH MASONRY SAWS.

10. CHASES SHALL BE BUILT INTO WALLS, NOT CUT IN. CHASES SHALL BE PLUMB AND SHALL BE A MINIMUM OF ONE (1) MASONRY UNIT LENGTH FROM JAMBS OR WALL OPENINGS. NO CHASES OTHER THAN THOSE SHOWN ON THE DRAWINGS SHALL BE CONSTRUCTED WITHOUT PRIOR REVIEW OF THE ARCHITECT.

#### 11.REINFORCED MASONRY:

- A. ALL WALLS AND PIERS SHALL HAVE HORIZONTAL JOINT REINFORCEMENT AT 16" ON-CENTER CONSISTING OF TWO (2) 9-GAGE RODS WITH 9-GAGE CROSS TIES AT 16" ON-CENTER. GALVANIZED WITH MINIMUM 1.3 OZ/FT<sup>2</sup> ZINC COATING, ASTM A153 CLASS B-3. FOR COMPOSITE OR CAVITY WALLS PROVIDE TWO (2) RODS IN C.M.U. AND ONE (1) ROD IN BUILDING BRICK OR FACE BRICK.
- B. THE MINIMUM CLEAR DISTANCE BETWEEN PARALLEL BARS EXCEPT IN COLUMN SHALL BE EQUAL TO THE NOMINAL BAR DIAMETER, BUT SHALL NOT BE LESS THAN 1
- C. VERTICAL REINFORCEMENT SHALL BE LAP SPLICED A MINIMUM OF 48 TIME BAR DIAMETER (NOT LESS THAN 2'-0") WHERE REQUIRED.
- D. ALL BASR SHALL BE COMPLETELY EMBEDDED IN MORTAR OR GROUT. ALL BARS SHALL HAVE A CLEAR COVE TO FACE OF MASONRY NOT LESS THAN:
- 2" FOR BARS LARGER THAN #5; 1 1/2" - FOR #5 BARS AND SMALLER.

12.CONTRACTOR SHALL BE RESPONSIBLE FOR PROVIDING ADEQUATE TEMPORARY BRACING AS REQUIRED DURING CONSTRUCTION TO WITHSTAND APPLICABLE LATERAL LOADS AND THE PRESSURES OF FLUID GROUT.

13. CONCRETE MASONRY SHALL BE PROTECTED FROM ABSORBING MOISTURE AND WATER WHILE AT THE PLANT, DURING SHIPMENT AND AT THE SITE DURING CONSTRUCTION.

14.ANCHORS, WALL PLUGS, ACCESSORIES AND OTHER ITEMS TO BE BUILT IN SHALL BE INSTALLED AS THE MASONRY WORK PROGRESSES. SEE ARCHITECTURAL DRAWINGS FOR ADDITIONAL DETAILS.

15. FOR LINTEL NOTES AND SCHEDULE SEE DRAWING S003.

16.SEE SPECIFICATIONS FOR ADDITIONAL REQUIREMENTS

# ANCHORAGE TO HARDENED CONCRETE

1. ANCHORAGE TO HARDENED CONCRETE SHALL INCLUDE MECHANICAL AND ADHESIVE ANCHORS OF TYPE, SIZE, NUMBER, AND SPACING AS SHOWN ON THE DRAWINGS. WHERE REQUIRED BY THE MANUFACTURERS' WRITTEN INSTRUCTIONS, PRE-DRILLED HOLES FOR SUCH ANCHORS SHALL BE CLEANED IN STRICT ACCORDANCE WITH MANUFACTURERS' REQUIREMENTS AND RESPECTIVE APPROVED ICC-ES REPORTS. ALL PREPARED HOLES SHALL BE OBSERVED BY THE OWNER'S TESTING AGENCY.

2. INSPECTION AND TESTING SHALL BE PROVIDED IN ACCORDANCE WITH THESE NOTES AND THE ICC-ES REPORTS FOR RESPECTIVE ANCHORS.

3. WHERE A SPECIFIC TYPE OF ANCHOR IS NOTED ON THE DRAWINGS, SUBSTITUTION FOR A DIFFERENT ANCHOR TYPE (INCLUDING SUBSTITUTING FOR A CAST-IN ANCHOR) SHALL NOT BE PERMITTED WITHOUT PRIOR WRITTEN APPROVAL OF THE ARCHITECT.

4. ANY POST-INSTALLED ANCHORAGE SYSTEM REGARDLESS OF THE TYPE AND THE NUMBER OF ANCHORS, IF NOT SHOWN ON THE DRAWINGS, SHALL NOT BE PERMITTED WITHOUT A REVIEW AND APPROVAL BY THE ARCHITECT

5. NO STEEL REINFORCEMENT OF ANY KINGD SHALL BE DAMAGED DURING ANCHOR INSTALLATION. ANY AND ALL SUCH OCCURRENCES SHALL BE IMMEDIATELY REPORTED TO THE ARCHITECT WHO WILL PROVIDE SPECIFIC DISPOSITION AND ISTRUCTIONS ON FURTHER ACTION.

6. REFER TO THE PROJECT SPECIFICATIONS FOR POST-INSTLALLED ANCHORS REQUIREMENTS AND APPROVED PRODUCTS. SEE ADDITIONAL NOTES BELOW REGARDING SPECIFIC REQUIREMENTS TO ANCHORS SND ANCHOR GROUPS.

#### **MECHANICAL ANCHORS**

1. UNLESS NOTED OTHERWISE ON THE DRAWINGS, MINIMUM EFFECTIVE ANCHOR EMBEDMENT DEPTH SHALL BE NOT LESS THAN 10 TIMES THE ANCHOR DIAMETER. MINIMUM EDGE DISTANCE TO THE NEAREST CONCRETE EDGE SHALL BE NOT LESS THAN 15 TIMES THE ANCHOR DIAMETER, AND MINIMUM ANCHOR SPACING SHALL BE NOT LESS THAN 12 TIMES THE ANCHOR DIAMETER.

2. STAINLESS STEEL ANCHORS SHALL BE USED AT ALL LOCATIONS SUBJECT TO WEATHER IN SERVICE AND WHERE SPECIFICALLY INDICATED ON THE DRAWINGS.

3. DEFECTIVE OR ABANDONED HOLES PREVIUOUSLY ATTEMPTED FOR POST-INSTALLED ANCHORS, SHALL BE FILLED WITH NON-SHRINK NON-METALLIC GROUT OR AN INJECTABLE ADHESIVE. IN EITHER INSTANCE, THE INFILL MATERIAL SHALL MATCH THE SURROUNDING CONCRETE COMPRESSIVE STRENGTH. NOTIFY THE ARCHITECT OF ANY AND ALL DEFECTIVE OR ABANDONED PRE-DRILLED HOLES IN WALLS, BEAMS, SLABS AND COLUMNS. SEKLECTED MEMBERS M.AY REQUIRE INFILL MATERIAL WITH A COMPRESSIVE MODULUS OF ELASTICITY MATCHING THAT OF THE SURROUNDING CONCRETE.

#### ADHESIVE ANCHORS

1. THE ADHESIVE ANCHOR SYSTEM USED FOR POST-INSTALLED ANCHORAGE TO CONCRETE SHALL CONFORM TO THE REQUIREMENTS OF ACI 355.4 "ACCEPTANCE CRITERIA FOR QUALIFICATION OF POST-INSTALLED ADHESIVE ANCHORS IN CONCRETE, AND COMMENTARY".

2. UNLESS NOTED OTHERWISE, ANCHORS USED WITH ADHESIVE ANCHORING SYSTEMS SHALL BE AS NOTED ON THE DRAWINGS. WHEN ANCHOR STEEL IS NOT NOTED, PROVIDE ANCHORS CONFORMING TO ASTM A193 GRADE B7 OR EQUIVALENT. FOR STAINLESS STEEL ANCHORS PROVIDE STEEL CONFORMING TO AISI TYPE 304 OR TYPE 316. POST-INSTALLED REINFORCING DOWELS SHALL CONFORM TO ASTM A615 GRADE 60 UNLESS NOTED OTHERSWISE.

3. UNLESS NOTED OTHERWISE ON THE DARWINGS, MINIMUM EFFCTIVE ANCHOR EMBEDMENT DEPTH SHALL BE 20 TIMES THE ANCHOR OR BAR DIAMETER, MINIMUM DISTANCE TO THE NEAREST CONCRETE EDGE SHALL BE 15 TIMES THE ANCHOR OR BAR DIAMETER, AND MINIMUM SPACING SHALL BE 12 TIMES THE ANCHOR OR BAR DIAMETER.

4. HOLES SHALL BE DRILLED WITH THE EQUIPMENT APPROVED OR RECOMMENDED BY THE ANCHORAGE SYSTEM MANUFACTURER. CORE DRILLEING OF HOLES FORMPOST-INSTALLED ANCHORAGE SHALL NOT BE PERMITTED.

5. ANCHOR HOLES SHALL BE THOROUGHLY CLEANED OF ANY LOOSE PARTICLES AND/OR DUST AS REQUIRED BY THE ADHESIVE SYSTEM MANUFACTURER PRIOR TO INJECTION OF ANY ADHESIVE.

6. TWO-PART ADHESIVES SHALL BE MIXED, APPLIED AND CURED IN STRICT ACCORDANCE WITH THE MANUFACTURER'S PUBLISHED INSTALLATION INSTRUCTIONS IN THE ICC-ES

7. SEE SPECIFICATIONS FOR ADDITIONAL REQUIREMENTS.





D. YURY X Expiration Oate 11.30-2024

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PROJECT NO: 50-24102 RWN.

Author

DRAWING TITLE: **TYPICAL SLAB** ON GRADE DETAILS

DRAWING NO: **S004** 

SCALE: N.T.S. DATE: ISSUED FOR PERMIT 06-10-2 PROJECT NO: 50-24102 RWN. CHK'D. Designer Author

V-GROOVED, TOOLED, OR 1/4" MAX, SAW-CUT AFTER CONCRETE HAS SET COMPACTED VAPOR BARRIER AS GRANULAR BACKFILL-TYPICAL CONTROL JOINT

CONSTRUCTION AND CONTROL JOINTS ARE INTERCHANGEABLE AT CONTRACTOR'S OPTION. JOINTS LOCATED AT COLUMN CENTERLINES ARE CONSIDERED OPTIMUM: HOWEVER, IT IS INTENDED THAT THE CONTRACTOR LAYOUT A PATTERN THAT WILL RESULT IN JOINTS AT XX'-X" MAXIMUM CENTER TO CENTER IN EACH DIRECTION INTENDED TO MINIMIZE CRACKING DUE TO CONCRETE DRYING SHRINKAGE AND THERMAL EFFECTS. DO NOT LOCATE CONSTRUCTION AND/OR CONTROL JOINTS BELOW MASONRY WALLS.

2' - 0"

-CONT. BOND BREAK

—2-#4 CONT.

EA. SIDE OF JT.

SAW-CUT JT.

] O. 4

SLIP SHEET OR

APPL., SEE PLAN-

SLAB-ON-GRADE JOINT DETAILS FOR S.O.G. REINFORCED W/STRUCTURAL FIBERS ONLY

1' - 0"

TYPICAL CONSTRUCTION JOINT

V-GROOVED OR TOOLED

JT., FILL W/ SEALANT-

3/4"Øx2'-0" LG.

SLIP SHEET OR

COMPACTED

GRANULAR


**BACKFILL** 

VAPOR RETARDER AS APPL., SEE PLAN-


S004 SCALE: N.T.S.

DOWELS @12"O.C.


GREASE ONE END.

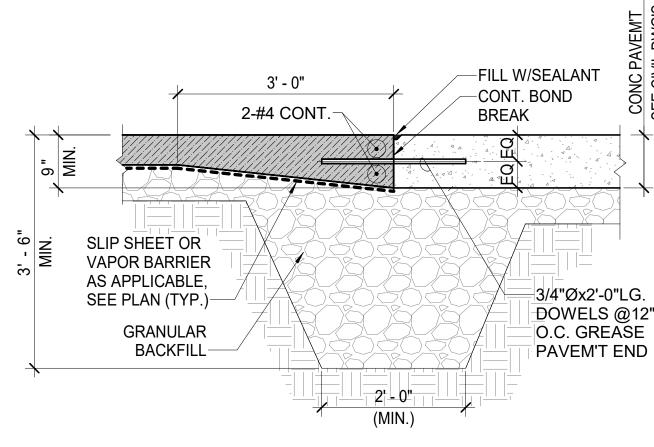

SLAB-ON-GRADE TO CONCRETE PAVEM'T 5 INTERFACE DETAIL S004 SCALE: N.T.S.

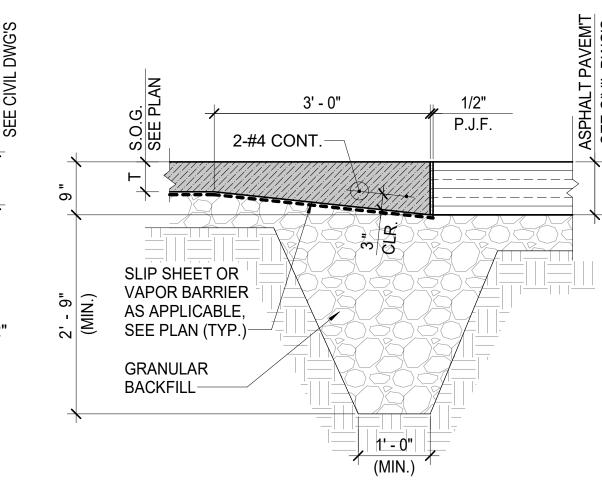


SLAB-ON-GRADE TO ASPHALT PAVEM'T 6 INTERFACE DETAIL S004 SCALE: N.T.S.

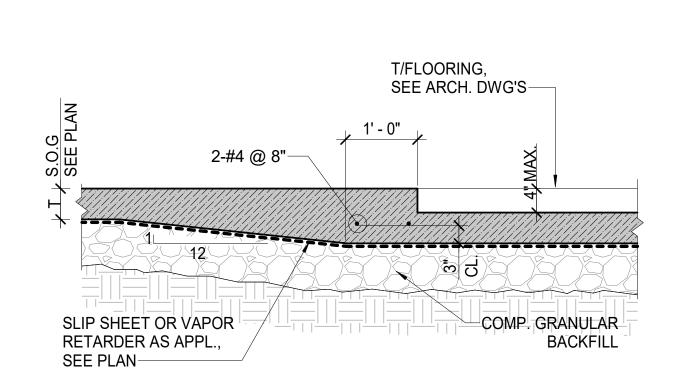


TYP. SLAB-ON-GRADE DEPRESSION DETAIL FOR 10 DEPTH ≤ 4" AWAY FROM MANSONRY WALLS


S004 SCALE: N.T.S.

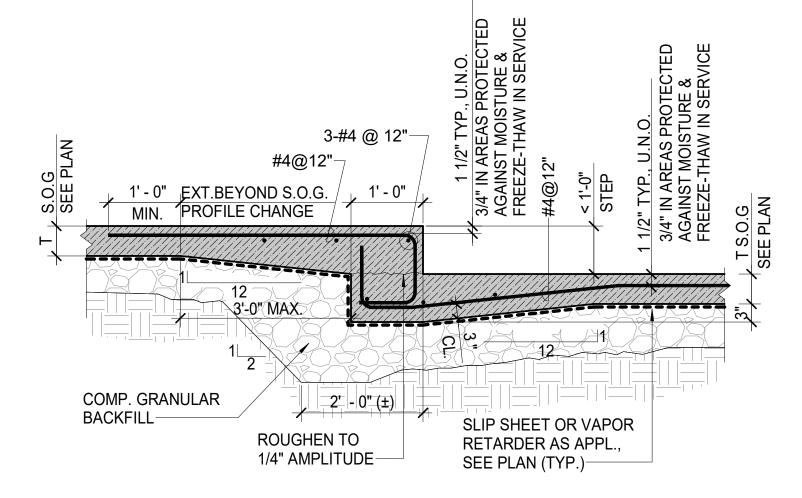


TYP. SLAB-ON-GRADE STEP DETAIL FOR DEPTH ≤ 1'-0" 11 AWAY FROM MANSONRY WALLS S004 SCALE: N.T.S.

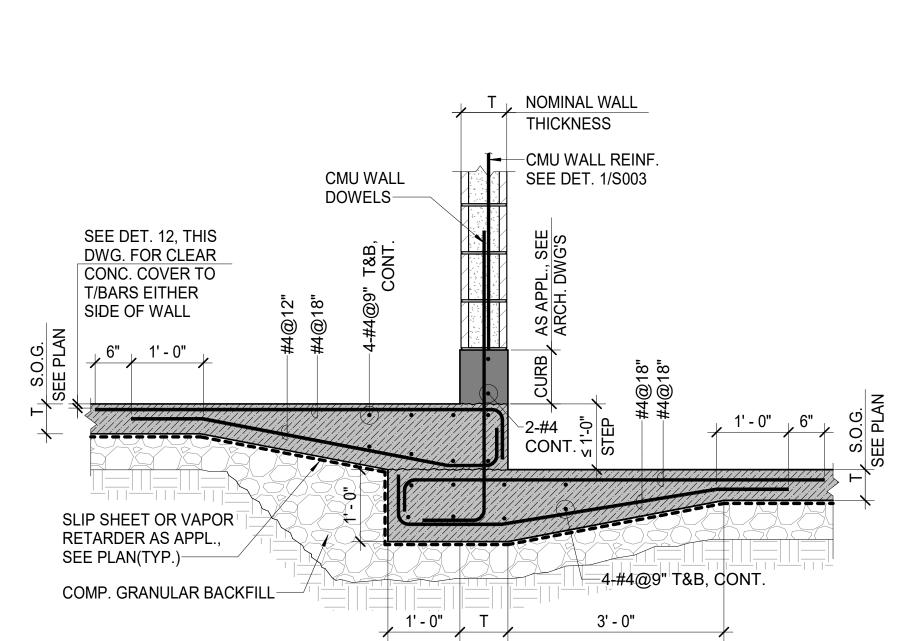

TYP. SLAB-ON-GRADE DEPRESSION DETAIL FOR 14 DEPTH ≤ 1'- 0" ADJACENT TO MASONRY WALL S004 SCALE: N.T.S.

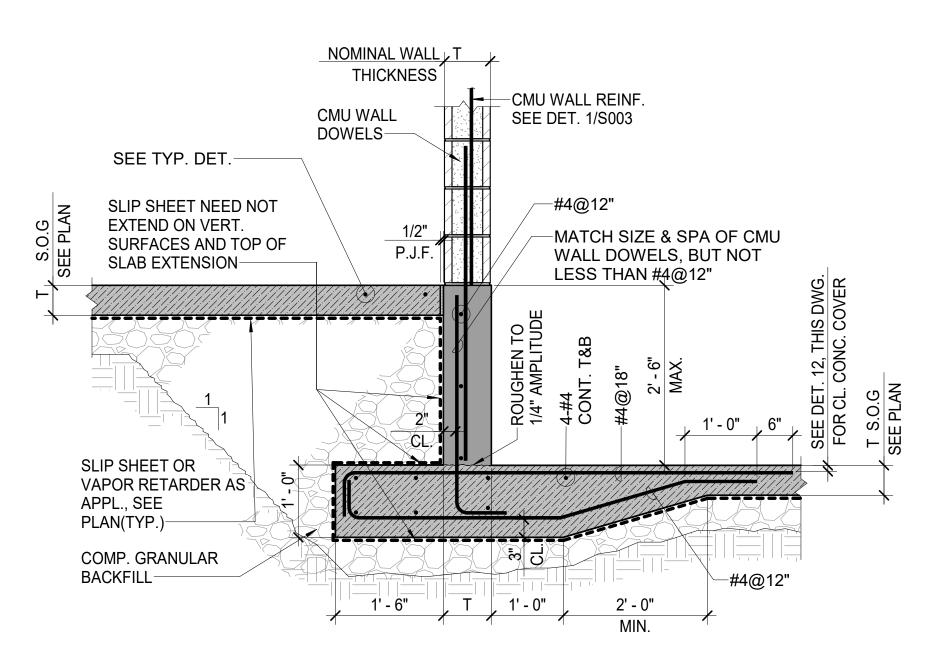

TYP. SLAB-ON-GRADE STEP DETAIL FOR DEPTH ≤ 2'-6" 15 ADJACENT TO MASONRY WALLS S004 SCALE: N.T.S.

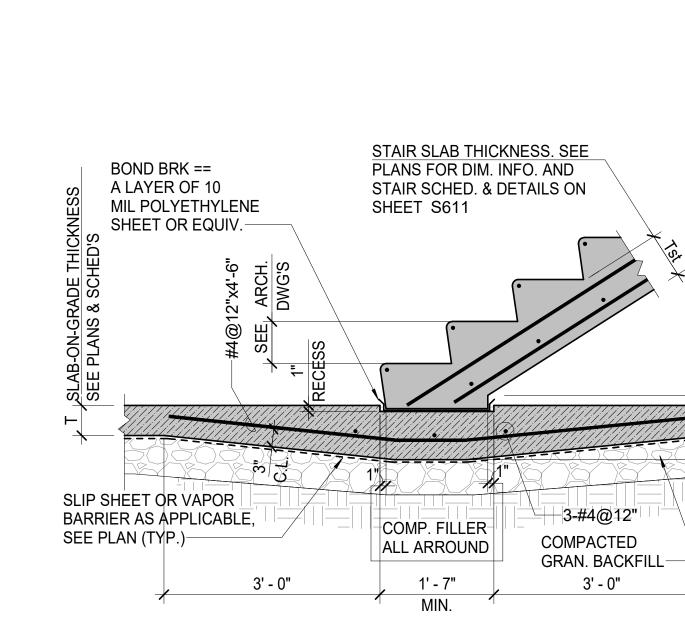

—SEE TYP. DET.

1/2" 1 3/4"

TYP. SLAB-ON-GRADE STEP DETAIL FOR DEPTH ≤ 2'-6"

-EXTEND WALL

WHERE REQ'D

SLIP SHEET NEED NOT EXTEND ON VERT.

SURFACES AND TOP OF

12 AWAY FROM MASONRY WALLS

SLAB EXTENSION-

SLIP SHEET OR VAPOR RETARDER AS

COMP. GRANULAR


APPL., SEE

PLAN(TYP.)-

**BACKFILL** 


S004 SCALE: N.T.S.

TYP. STAIR-TO-S.O.G. CONN. DETAIL FOR 16 GARAGE INTEGRAL STAIRS S004 SCALE: N.T.S.

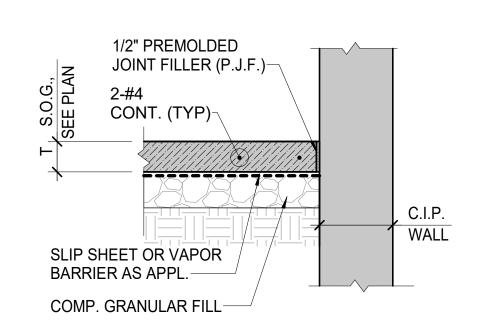


NOTE:
PROVIDE CONTINUOUS SEALANT ALONG ALL SLAB TO WALL JOINTS.

TYP. SECTION SLAB-ON-GRADE AT **3** FOUNDATION OR RETAINING WALL S004 SCALE: N.T.S.

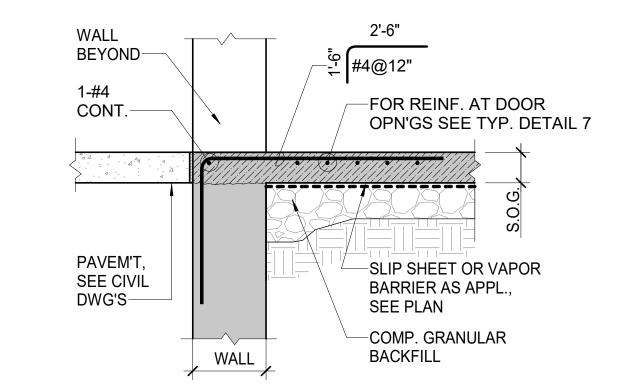


NOTE:
PROVIDE CONTINUOUS SEALANT ALONG ALL SLAB TO WALL JOINTS


TYP. SECTION -SLAB-ON-GRADE AT FOUNDATION 4 OR RETAINING WALL AT DOOR OPENING S004 SCALE: N.T.S.

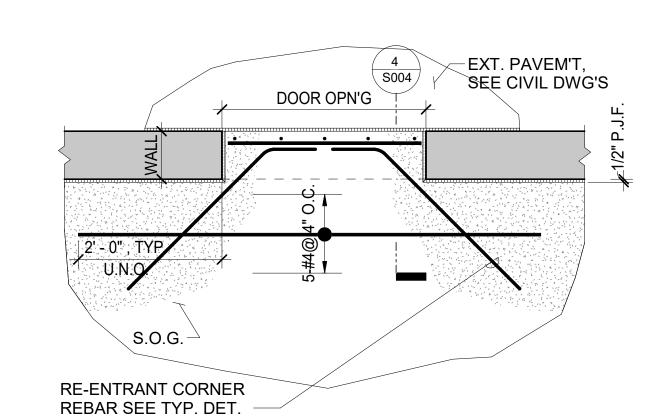

TYP. SLAB-ON-GRADE-FOUNDATION-WALL 9 INTERFACE DETAIL AT DOOR OPENING
S004 SCALE: N.T.S.

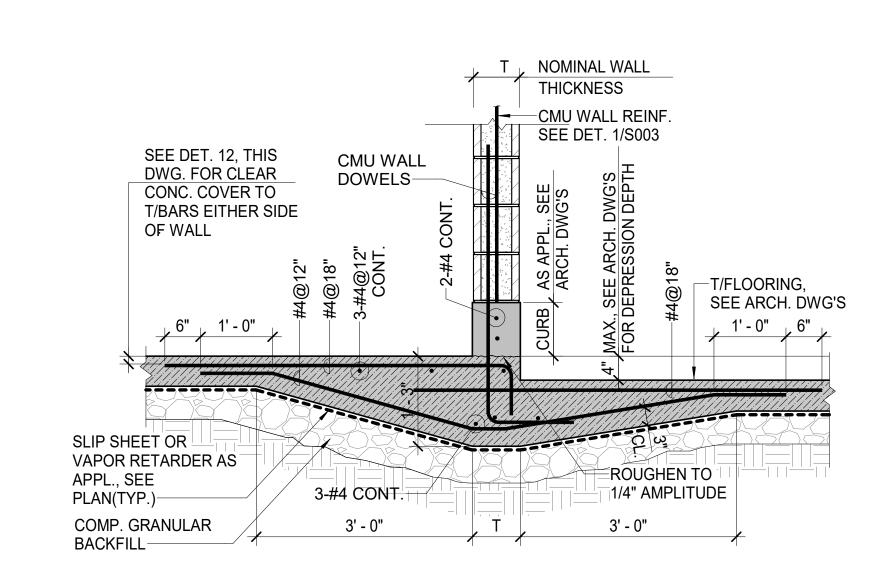

TYP. SLAB-ON-GRADE DEPRESSION DETAIL FOR DEPTH ≤ 13 4" ADJACENT TO NON-LOAD BEARING MASONRY WALL S004 SCALE: N.T.S.

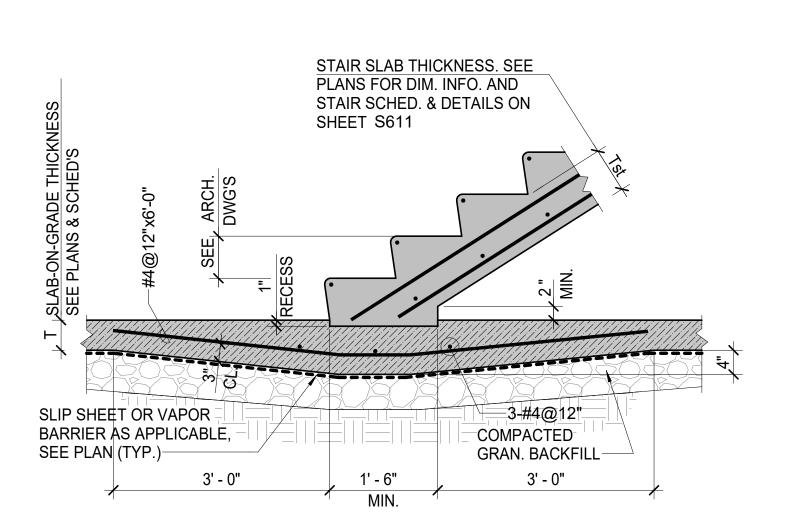

TYP. STAIR-TO-S.O.G. CONN. DETAIL FOR 17 STAIR IN ELEVATOR ENCLOSURE S004 SCALE: N.T.S.

4x1-#4(T)(E)

S.O.G.

4x1-#4(B), TYP.

NOTES: BARS TO BE MIN. 4'-6" LONG.

2-#5 INNER LAYER,

ADD'LWALL REINF.

EXTEND HOR.

REINF. FROM

SHORTER WALL-

REINF. FROM

TALLER WALL-

MATCH REBAR SIZE

NOTE: Tf2 ≥Tf1
NO TOP REINFORCEMENT

6A STEPPED FTG. DETAIL TYPE 1A

& SPA OF UPPER

FOOTING-

S005 SCALE: N.T.S.

FOR JT. SPACING SEE NOTE 17.C

LAP SPLICE 45 BAR

DIA. MIN.

BETWEEN WALL AND MAT/PAD WATERSTOP SHALL BE REQUIRED

8 TYP WALL CONSTRUCTION JOINT DETAIL

**UNDER "CONCRETE NOTES"** 

ON DWG.\_\_\_\_. LOCATE NOT

FARTHER THAN 10'-0" FROM

P.V.C. OR RUBBER W.S.

WHERE APPL.

SWELLABLE W.S

V-GROOVE EXPOSED TO

VIEW TO BE EXTENDED

S005 SCALE: N.T.S.

WHERE APPL.

OVER T/WALL

CORNER-

S005 SCALE: N.T.S.

1 JOINT DETAIL AT S.O.G.

TYPICAL INTERIOR COLUMN ISOLATION

NON-LOAD BRG. CMU WALL. FOR REINF. SEE DET

—EXT. GRADE, SEE

CIVIL DWG'S

-SIMULTANEOUS

CONT.

TO BE FROM ' OF TW FIN. GF

-ALTERNA

**HOOKS** 

BACKFILL

#4@10"-

**----**

SEE PLAN

TYP. FOUND.WALL WITH CMU

5 NON-LOAD BEARING WALL S005 SCALE: N.T.S.

MIN.



D. YURY SWETING 722-081-004519

ISSUE

NO. DESCRIPTION DATE DRAWING TITLE: **FOUNDATION** DETAILS

DRAWING NO: **S005** 

SCALE: As indicated DATE: ISSUED FOR PROJECT NO: 50-24102 RWN. CHK'D.

Designer Author

-C.I.P. CONC. COL., FOR REINF. SEE SCHEDULE RE-ENTR. CORNER REBAR #4, T&B JT., TYP. SLIP SHEET OR VAPOR RETARDER, SEE PLAN--COMP. GRAN. BACKFILL -FTG, FOR REINF SEE PLAN. SECTION TYP. COLUMN-TO-S.O.G.

3 INTERFACE S005 SCALE: N.T.S.

-S.O.G. CONTROL OR

U.N.O.

40 BAR DIA

FORM GROOVE SIM.

-HORIZ. WALL REINF.

TERMINATE EVERY

OTHER HORIZ. BAR

EITHER SIDE OF JT.

-VERT. REINF.

-WATERPROOFING

SEE ARCH. DWG'S

WHERE APPLICABLE

TO ACI 224.3R, FIG. 8.2,

CONSTRUCT.JT.

2x1-#4(T)(E)

S.O.G.-

PAVEMENT OR

EXTERIOR GRADE,

SEE CIVIL DWG'S-

S005 SCALE: N.T.S.

-S.O.G.CONTROL OR CONSTRUCT. JT.

ACI STD

1 1/2"

-FORM GROOVE SIM.

-HORIZ. WALL REINF.

TERMINATE EVERY

OTHER HORIZ. BAR

EITHER SIDE OF JT.

-VERT. REINF.

-WATERPROOFING

SEE ARCH. DWG'S

WHERE APPLICABLE

TO ACI 224.3R, FIG.

8.2, U.N.O.

2x1-#4(B), TYP.

2" GAP JT

TYPICAL EXTERIOR COLUMN ISO. JOINT

40 BAR DIA

DETAIL AT FOUND, WALL AND S.O.G.

2-#5 INNER LAYER,

EXTEND HOR.

REINF. FROM

EXTEND HOR. REINF.

FROM TALLER WALL

MATCH REBAR SIZE &

SPA OF UPPER FOOTING

UPPER OR LOWER FOOTING

6B STEPPED FTG. DETAIL TYPE 1B

NOTE: Tf2 ≥ Tf1
WITH TOP REINFORCEMENT

S005 SCALE: N.T.S.

FOR JT. SPACING SEE NOTE 17.C

UNDER "CONCRETE NOTES"

ON DWG.\_\_\_\_. LOCATE NOT

FARTHER THAN 10'-0" FROM

SUPPL. VERT. #4

WIRE TIE W.S. TO

SUPPL. VERT. BAR &

WALL VERT. REINF.-

OVER T/WALL-

V-GROOVE EXPOSED TO

VIEW TO BE EXTENDED

P.V.C. OR RUBBER W.S.

CORNER-

WHERE APPL.

MATCH SIZE & SPA THE HEAVIER OF TOP BARS IN

\$HORTER WALL-

ADD'L WALL REINF.

|TYP., U.N.O.

EXTEND HOR. REINF. FROM LAP SPLICE, SEE SCHED. IN NOTE 15 UNDEF SHORTER WALL 40 BAR DIA + + EXTEND HOR. REINF FROM TALLER WALL-≥ 1'-0" PERMISSIBLE BOT. CONFIGURATION-

7A STEPPED FTG. DETAIL TYPE 2A

/—#4 @12" EA. FACE. 

 $^{
u}$  JOINT

EQ

AND ENGINEER.

**CONSTRUCTION JOINT NOTES:** 

SECTIONS AND DETAILS.

-SEE SCHEDULE

**CENTER BARS ON** 

**CENTER LINE OF** 

CONSTRUCTION JOINTS SHALL BE DONE IN

ACCORDANCE WITH ACI 318 SECTION 6.4.

LOCATION OF CONSTRUCTION JOINTS SHALL BE APPROVED BY THE ARCHITECT

TABULATED HEREIN, WAS DESIGNED IN **ACCORDANCE WITH ACI 318 SECTION 11.7** 

. FOR FOOTING DIMENSIONS SEE PLANS,

THICKNESSES BEYOND THE TABULATED

THE ARCHITECT FOR SEPARATE DESIGN

RANGE PROVIDE JOINT LOCATIONS TO

JOINT REINFORCEMENT SHOWN

FOR JOINTS IN FOOTINGS WITH

OF REQUIRED REINFORCEMENT.

**JOINT** 

FIRST POUR | SECOND POUR

7B STEPPED FTG. DETAIL TYPE 2B

0.8 TIMES SPLICE

LENGTH PER SCHED.

Tf1

0.8 TIMES SPLICE

LENGTH PER SCHED.

<u>NOTE:</u> Tf2 ≥ Tf1 WITH TOP REINFORCEMENT

#4@12"-

#4@12"-

-EXT. GRADE. SEE

CIVIL DWG'S

→ SIMULTANEOUS

−3-#4(B) CONT.

HOOKS

LAP SPLICE, SEE SCHÉD. IN NOTE 15 UNDER

SEE PLAN

TYP. EXTERIOR FOUND.WALL

4 CROSS SECTION

S005 SCALE: N.T.S.

EXTEND HOR.

REINF. FROM

TALLER WALL

EXTEND HOR.

REINF. FROM

SHORTER WALL

PERMISSIBLE BOT

CONFIGURATION-

SEE NOTE 15 UNDER

S005 SCALE: N.T.S.

INTENTIONALLY ROUGHENED JOINT

1. LAYER REINF. FOR 0"<D<14"

3. LAYERS REINF. FOR D>28"

FOOTING CONSTRUCTION JOINT

FTG WIDTH W

INCHES, MAX.

0" TO 14"

15" TO 24"

25" TO 34"

35" TO 48"

49" TO 60"

61" TO 72"

73" TO 90"

REBAR SCHEDULE

JOINT REBAR SIZE,

LENGTH, AND

NUMBER PER LAYER

4 - #4 x 3'-0"

6 - #5 x 3'-6"

8 - #5 x 3'-6"

9 - #6 x 4'-0"

12 - #7 x 4'-6"

16 - #7 x 4'-6"

16 - #8 x 5'-0"

2. LAYERS REINF. FOR 14"<D<28"

"CONCRETE NOTES" ON DWG. CP-S002

BACKFILL


SEE NOTE 15 UNDER

U.// HIVILO O. L.C.

LENGTH PER SCHED. ON DWG. CP-S002

NOTE: Tf2 ≥Tf1 NO TOP REINFORCEMENT


S005 SCALE: N.T.S.

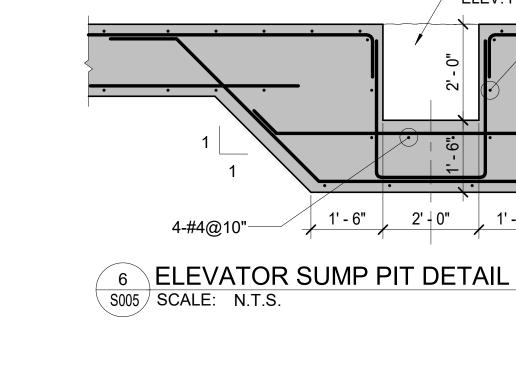

FOR WALL DETAILS WITH WATERSTOP, CONTINUATION THROUGH HEAT WELDED JOINT 9 TYP WALL CONTROL JOINT DETAIL

S005 / SCALE: N.T.S. 1st POUR 2st POUR RUBBER OR P.V.C. W.S. FOR SLAB/MAT SUBJECT TO HYDROST. PRESSURE NOT EXCEEDING HYDRAULIC HEAD **EQUIVALENT TO WGT OF MAT** FOR REBAR LAP SPLICES PLUS 2'-0" -SEE SCHEDULES ON DWG. S0002, U.N.O. FTG. OR MAT BOTTOM DIM. HORIZ. REINF. WATERPROOFING AS APPL. PARALLEL TO JOINT SEE ARCH. DWG'S-FOR FTG'S THICKER THAN 2'-0", PROVIDE HORIZ. KEYS SPACED @ 12" O.C.-

TYP. CONTINOUS FOOTING OR MAT 11 CONSTRUCTION JOINT DETAIL S005 SCALE: N.T.S.

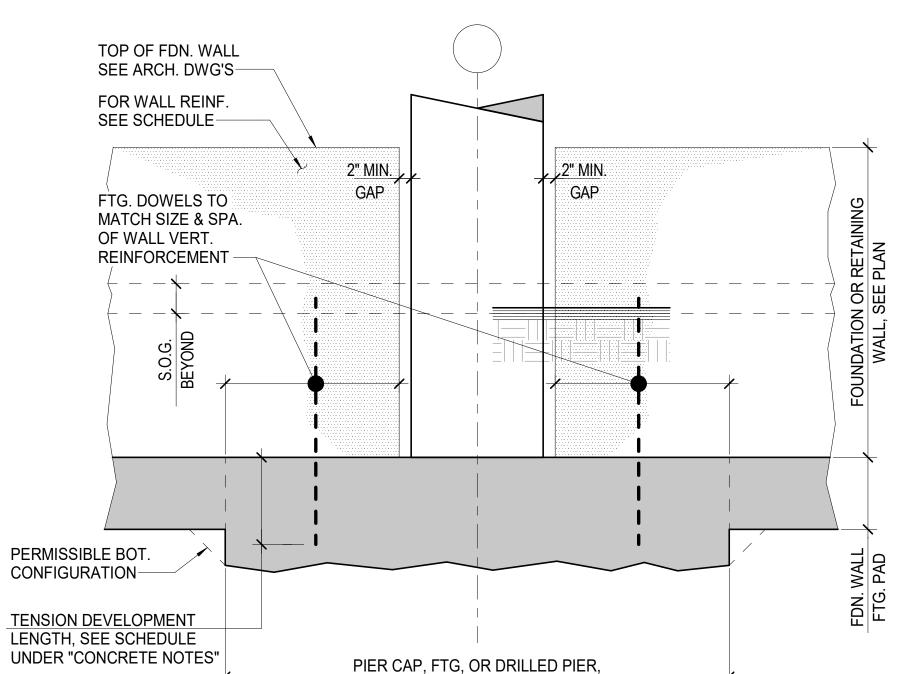

TYP. SPREAD FTG. TO FOUNDATION WALL 12 INTERFACE DETAIL 0530 S005 SCALE: N.T.S.

TYP. GRADE BEAM OR WALL FOOTING CONSTR. 13 JT DETAIL \_WITH CONTINUOUS PRIMARY REINFORCEMENT S005 SCALE: N.T.S.

EQ

SEE SCHEDULE

SEE PLAN

ISSUE

DRAWING NO:

**S006** SCALE: As indicated

DATE: ISSUED FOR PROJECT NO: 50-24102 RWN. CHK'D. Designer Author

C.I.P. CONC. COL., FOR REINF. SEE SCHEDULE-------BOT. REINF., SEE SCHEDULE, TYP.— S.O.G---FOOTING LENGTH OR WIDTH 4 TYP. SPREAD FOOTING SECTION SCALE: N.T.S. GRANULAR BACK FILL-"B" BARS-—"E" BARS -"D" BARS "E1" BARS -"C" BARS "F" BARS W/ MIN. 1'-0" BENT ENDS— DRAIN TILE, TYP. SEE CIVIL DWGS.— ROUGHENED SURFACE
TO 1/4" MIN. AMPLITUDE

2 TYPICAL CANTILEVER RETAINING WALL (TYPE B)
SCALE: N.T.S

"H" BARS----

SWELLABLE W.S.-

\_\_\_\_S.O.G

-GRANULAR BACKFILL

-"F" BARS W/MIN.

-SWELLABLE W.S.

CIVIL DWG'S

-DRAIN TILE, TYP., SEE

1'-0" BENT ENDS

-"B" BARS

-"E1" BARS

-ROUGHENED SURFACE TO 1/4" MIN. AMPLITUDE T/S.O.G. EL.
SEE ARCH. DWG'S

—"G" BARS

									RETAIN	ING WA	LL SCHE	EDULE						
					DIMENSIONS	<b>;</b>						REIN	NFORCEMENT					f'c = 4,500 PSI
WALL	WALL		Hi	W	В	Т	С	Tt	"A" BARS	"B" BARS	"C" BARS	"D" BARS	"E" BARS	"E1" BARS	"F" BARS	"G" BARS	"H" BARS	
MARK	TYPE	Hh	"FROST"	WIDTH	TOE	STEM	HEEL	FOOTING	DOWELS	VERT.	DOWELS	VERT.	HORIZ.	HORIZ.	DIAGONAL	D/ ti to	D/ (I to	REMARKS
		MAX	DEPTH					THICKNESS	I.F.	I.F.	O.F.	O.F.	E.F.	E.F.				
RW1	В	17'-3"	4'-0"	15'-3"		1'-4"	13'-11"	1'-8"	#7@10"	#7@10"	#4@18"	#4@18"	#4@12"	#4@12"	#4@18"	#7@14"	#4@11"	
RW2	В	12'-10"	4'-0"	8'-0"		1'-0"	7'-0"	1'-8"	#6@12"	#6@12"	#4@18"	#4@18"	#4@16"	#4@16"		#6@12"	#4@11"	
RW3	Α	7'-0"	4'-0"	3'-8"	1'-0"	0'-8"	2'-0"	1'-0"	#4@12"	#4@12"				#4@12"	-	#4@12"	#4@16"	
RW4	Α	7'-10"	4'-0"	4'-10"	2'-0"	0'-10"	2'-0"	1'-2"	#5@12"	#5@12"	#4@18"	#4@18"	#4@18"	#4@18"		#5@12"	#4@16"	
RW5	Α	9'-5"	4'-0"	5'-0"	1'-3"	0'-10"	2'-11"	1'-0"	#5@12"	#5@12"	#4@18"	#4@18"	#4@18"	#4@18"		#5@12"	#4@16"	
RW6	Α	14'-1"	4'-0"	10'-0"	2'-0"	1'-0"	7'-0"	1'-3"	#6@10"	#6@10"	#4@18"	#4@18"	#4@16"	#4@16"	#4@18"	#6@10"	#4@14"	
RW7	Α	17'-3"	4'-0"	14'-0"	2'-0"	1'-4"	10'-8"	1'-8"	#7@10"	#7@10"	#4@18"	#4@18"	#4@12"	#4@12"	#4@18"	#7@14"	#4@11"	
RWX	Α	XX'-X"	4'-0"	XX'-X"	X'-X"	X'-X"	X'-X"	X'-X"	#X@XX"	#X@XX"	#X@XX"	#X@XX"	#X@XX"	#X@XX"	#X@XX"	#X@XX"	#X@XX"	
																-		

NOTES:

1. PROVIDE SIMULTANEOUS BACKFILL AT TOE & HEEL SIDE UNTIL TOE SIDE BACKFILL IS EQUAL TO ELEVATION PER ARCHITECTURAL DRAWINGS.

**Exhibit G - Drawings** 

WALL EXT. WHERE APPLICABLE, EXTEND VERT. REINF. PROVIDE

"E" BARS-

"D" BARS-

"A" BARS-

"H" BARS-

S006 SCALE: N.T.S.

RWXX---RETAINING WALL MARK, SEE SCHEDULE XXX'---T/FTG. ELEVATION, SEE PLAN

ISO. 1/2" JT., TYP.


1 TYPICAL CANTILEVER RETAINING WALL TYPE A

HOR. "E" BARS-

T/S.O.G. EL.
SEE PLAN


Exhibit G

- 2. REINFORCEMENT CALLED OUT IN THE SHADED CELLS OF THIS SCHEDULE SHALL BE EPOXY-COATED. 3. FOOTING PADS FOR RETAINING WALLS, WHERE APPLICABLE, HAVE BEEN PROPORTIONED FOR MAXIMUM 3,000 PSF SOIL BEARING PRESSURE.
- 4. FOR WALL JOINTS, FOLLOW NOTES 13 AND 15 UNDER "GENERAL FOUNDATION NOTES" ON DWG. S00-01 AND NOTE 18.C. UNDER "CONCRETE NOTES" ON DWG. S00-02.

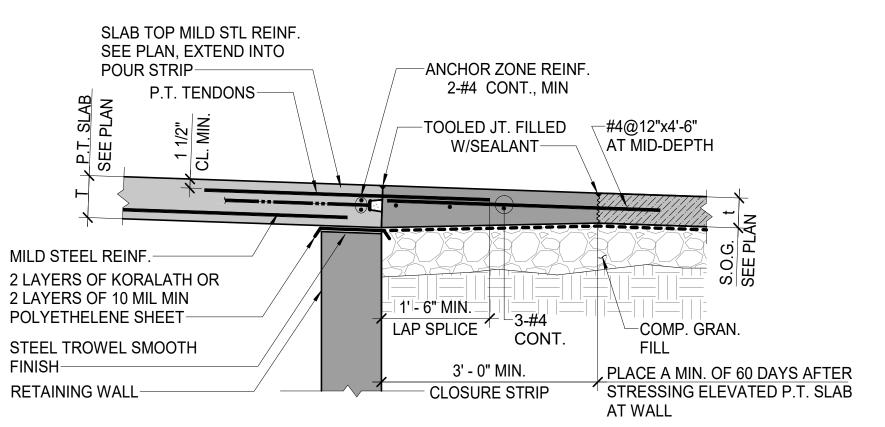


GRADE SLAB-TO-P.T. (ALT. 1) SLAB CONNECTION DETAIL

S006 SCALE: N.T.S.

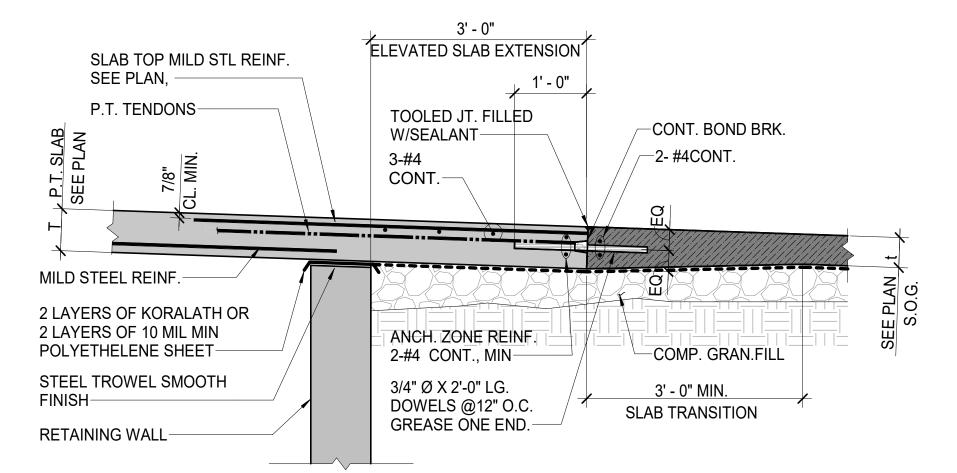

3.2 GRADE SLAB-TO-P.T. SLAB CONNECTION DETAIL (ALT. 2) S006 SCALE: N.T.S.

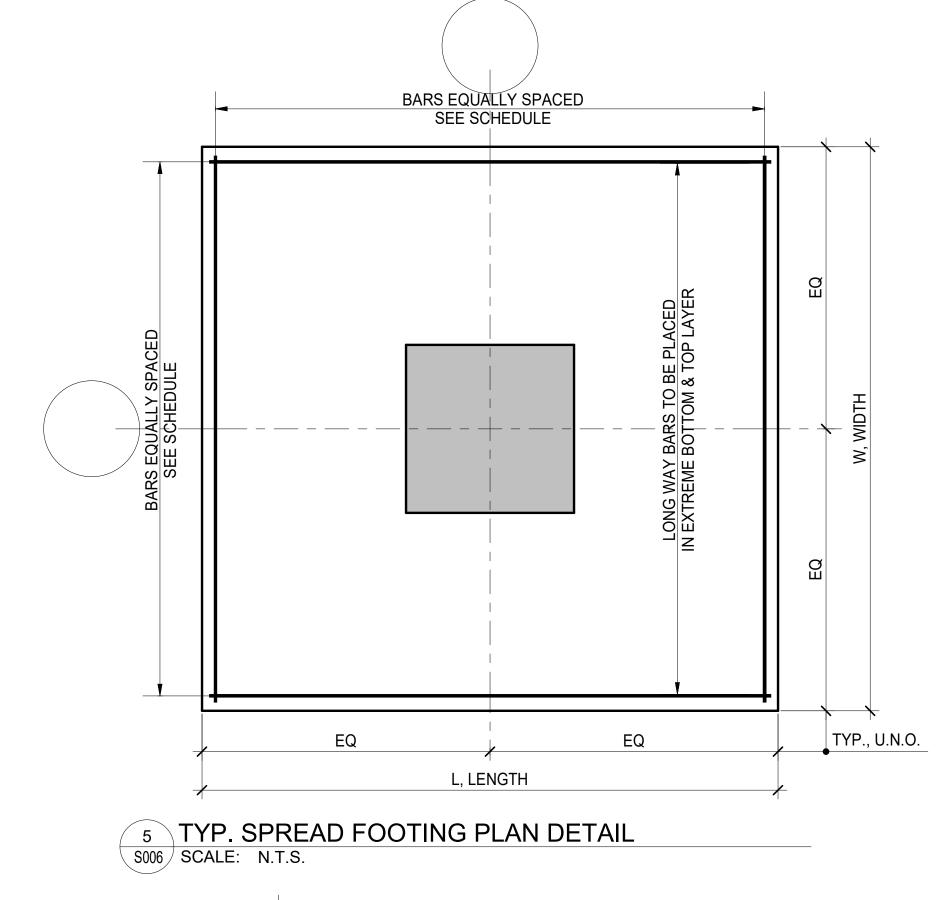

TYP., U.N.O.

L OR W

TOP REINF., WHERE

------

SCHEDULE ONLY

REQ'D BY

	ORCEMENT	TOD DEINE	OM REINF.	POTT		DIMENSIONS		
	ORCEMENT	TOP REINF	OW REINF.	ВОТТ		DIMENSIONS		FTG
REMAR	SHORT WAY	LONG WAY	SHORT WAY	LONG WAY	D	W	L	MARK
			7 - #5	7 - #5	2'-0"	4'-0"	4'-0"	F4
			10 - #5	10 - #5	2'-0"	5'-6"	5'-6"	F5.5
			11 - #5	11 - #5	2'-0"	6'-0"	6'-0"	F6
			11 - #5	11 - #5	2'-0"	6'-6"	6'-6"	F6.5
			9 - #6	9 - #6	2'-0"	7'-0"	7'-0"	F7
			10 - #6	10 - #6	2'-0"	8'-0"	8'-0"	F8
			11 - #6	11 - #6	2'-0"	8'-6"	8'-6"	F8.5
			12 - #6	12 - #6	2'-0"	10'-0"	10'-0"	F10
			10 - #7	10 - #7	2'-0"	10'-6"	10'-6"	F10.5
			10 - #7	10 - #7	2'-0"	11'-6"	11'-6"	F11.5
			13 - #8	13 - #8	2'-0"	13'-6"	13'-6"	F13.5
			11 - #6	4 - #6	2'-0"	3'-0"	9'-0"	F3/9
			15 - #6	5 - #6	2'-0"	3'-0"	12'-6"	F3/12.5
			16 - #6	7 - #6	2'-0"	4'-0"	13'-6"	F4/13.5
			25 - #6	7 - #8	2'-3"	4'-0"	18'-6"	F4/18.5
			13 - #6	6 - #6	2'-0"	4'-6"	11'-0"	F4.5/11
			11 - #6	8 - #6	2'-3"	5'-6"	8'-0"	F5.5/8
			11 - #6	8 - #6	2'-0"	6'-0"	8'-6"	F6/8.5
			24 - #6	9 - #8	2'-3"	6'-0"	17'-6"	F6/17.5
			17 - #6	12 - #6	3'-0"	6'-6"	9'-6"	F6.5/9.5
			20 - #7 X - #X	14 - #7 X - #X	4'-0" X'-X"	8'-0" X'-X"	11'-6" X'-X"	F8/11.5 FX

FXX---FOOTING MARK, SEE SCHEDULE XXX'---T/FTG. ELEVATION, SEE PLAN

NOTES:
1. ALL CONCRETE FOR COLUMN AND WALL FOOTING PADS, ELEVATOR MAT, RETAINING WALLS, AND FOUNDATIONS WALLS SHALL BE REGULAR WEIGHT AND ATTAIN A MIN. 4500 PSI COMPRESSIVE STRENGTH AT 28 DAYS, U.N.O. 2. WHERE WALL FOOTINGS ABUT COLUMN FOOTINGS, WALL FOOTING REINFORCEMENT IS INTENDED TO BE

STRAIGHT DEVELOPED IN TENSION INTO COLUMN FOOTING, U.N.O.

S007 SCALE: N.T.S.

TYP. CHAMFER DETAIL

NOTE: PROVIDE CHAMFER THUS AT ALL

EXTERIOR CORNERS, TYP., U.N.O.


S007 / SCALE: N.T.S.

-EXTERIOR FACE

2 TYP. "DRIP" DETAIL AT SLAB EDGE S007 SCALE: N.T.S.

NOTE: PROVIDE DRIP THUS AT ALL

SUPPORTED SLAB EDGES, U.N.O.

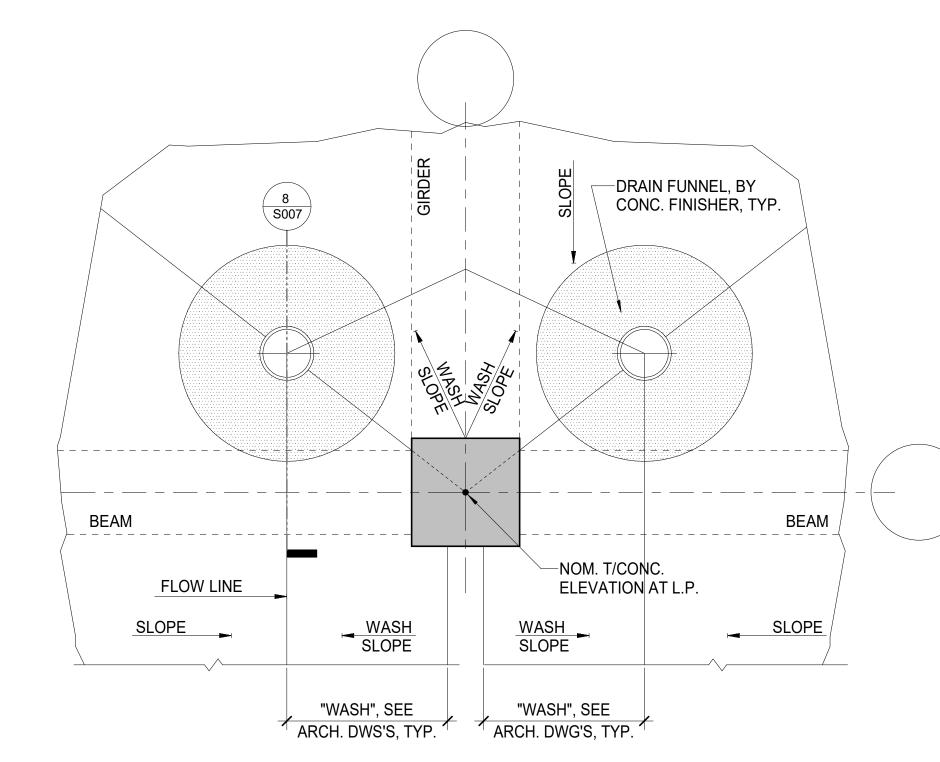


NOTES:


1. FOR PLACEMENT AND QUANTITIES OF FLOOR DRAINS, SEE ARCHITECTURAL AND PLUMBING DRAWINGS. 2. PRESENCE OF A SECOND DRAIN AT CONDITION SHOWN IN THIS PLAN - DETAIL MAY NOT BE REQUIRED. TWO DRAINS ARE SHOWN FOR SCHEMATIC PURPOSES ONLY.

PARTIAL FLOOR PLAN AT INTERIOR DRAINS WITH BEAMS AND GIRDER ROTATED 90°


S007 SCALE: N.T.S.

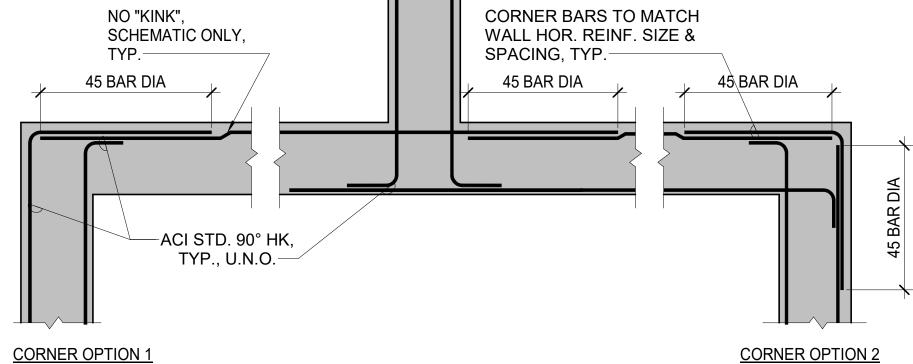


TYP DETAIL.-HORIZONTAL REINFORCEMENT AT WALL CORNERS TWO REBAR CURTAINS SHOWN

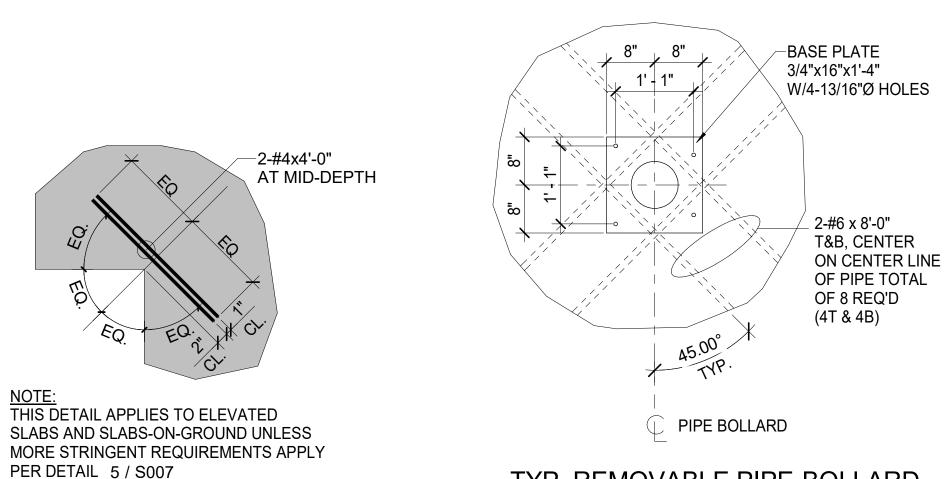

TYP. REMOVABLE PIPE-BOLLARD 4 TYP. RE-ENTRANT CORNER BARS 12 SECTION S007 SCALE: N.T.S. S007 SCALE: N.T.S.

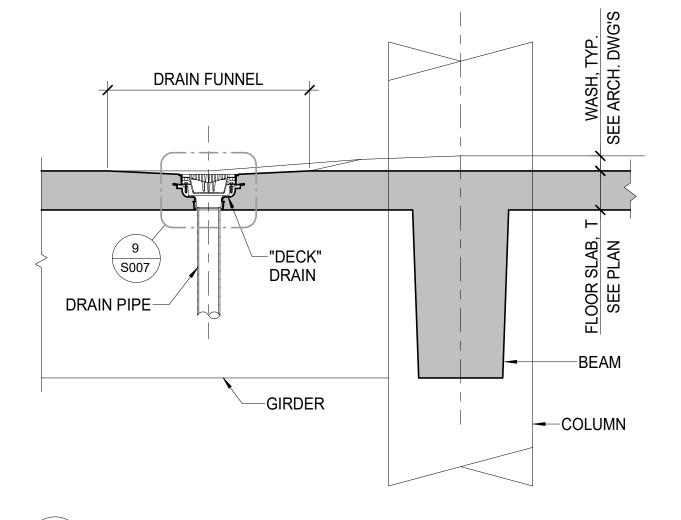

8 DRAIN SECTION S007 SCALE: N.T.S.

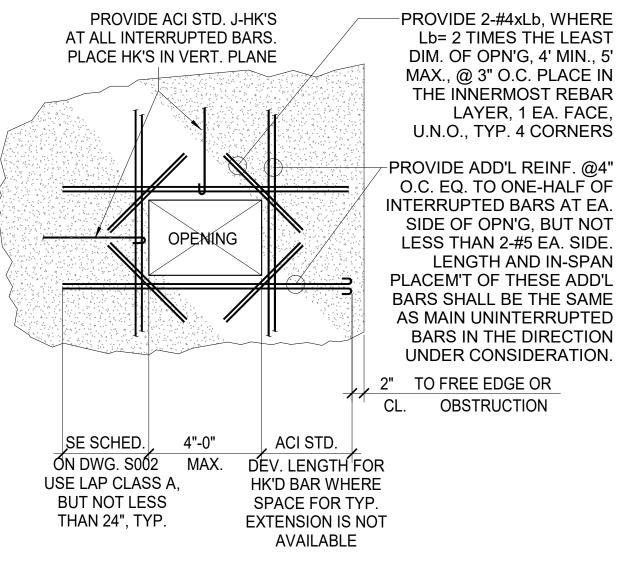

NOTE: THIS DETAIL APPLIES TO SLAB AND WALL OPNG'S, REINFORCEMENT FOR WHICH HAS NOT BEEN SPECIFICALLY DETAILED WHEN SUCH DETAILS ARE PROVIDED ON THE STRUCTURAL DWG'S. REINF. SHOWN MUST BE SUPPLEMENTED WITH DIAGONAL CORNER REINF. SHOWN IN THIS DETAIL.

LOCALIZED SLOPE TO DRAIN

PER TYPICAL DETAIL 5, THIS DRAWING.

S007 SCALE: N.T.S.

9 TYP.DECK DRAIN DETAIL

MIN. REINFORCEMENT AT SLAB OR WALL OPENINGS1 S007 SCALE: N.T.S.

PROVIDE BLOCKOUT IF B/SLAB

IS BELOW DRAIN BASE

FOR THE PURPOSES OF SLAB REINFORCING, THE FLOOR DRAIN LOCATION SHALL BE CONSIDERED A SLAB OPENING. PROVIDE ADDITIONAL REINFORCEMENT AS REQUIRED


-DRAIN ASSEMBLY (SEE

(SEE NOTE BELOW)-

DRAIN BODY

MECHANICAL DRAWINGS)

ADD'L REINF. ALL AROUND

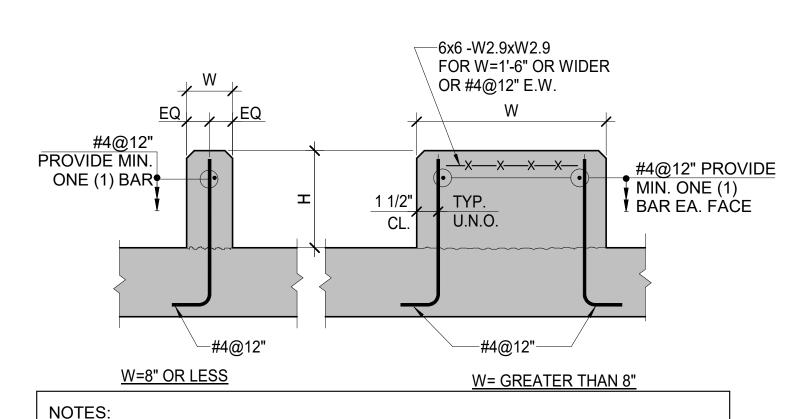


1. FOR CURB W AND H DIMENSIONS SEE ARCH. DWG'S.


- 2. MINIMUM PERMISSIBLE WIDTH W=4". 3. CURBS WITH W=1'-6" AND WIDER REQUIRE TRANSVERSE TOOLED CONTROL JOINTS SPACED AT 10'-0" MAX. O.C.
- 4. CURBS WITH WIDTHS (W) UNDER 10 FT. DO NOT REQUIRE LONGITUDINAL CONTROL JOINTS. FOR WIDER CURBS PROVIDE LONGITUDINAL TOOLED
- CONTROLS JOINTS AT 10'-0" MAX. 5. SEE TOOLED CONTROL JOINT, SEE TYPICAL DETAIL.


6 CONCRETE CURB DETAIL

S007 SCALE: N.T.S.

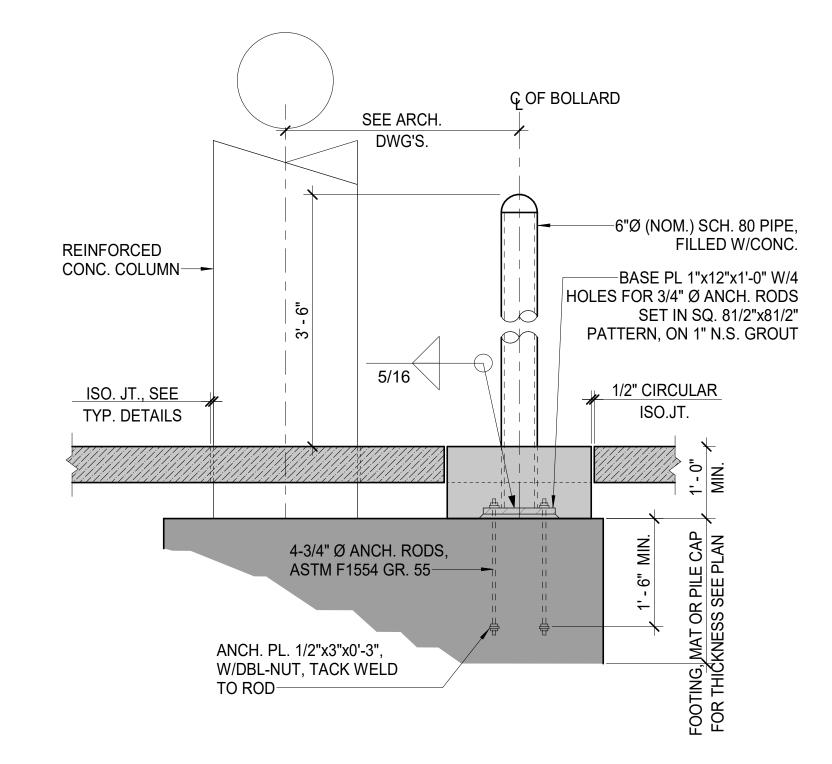

TYP PIPE-BOLLARD DETAIL AT COL. FTG OR PILE CAP 10 PASSENGER VEHICLE IMPACT RESISTANT ONLY S007 SCALE: N.T.S.

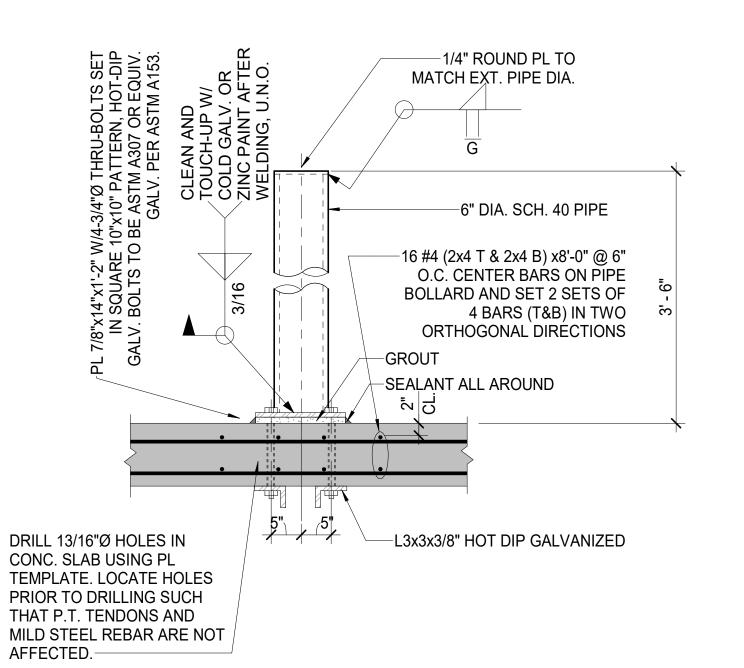


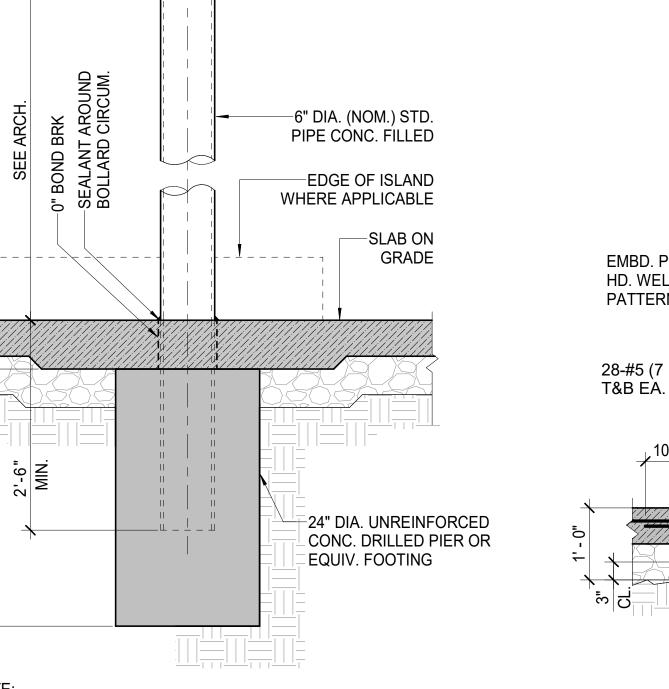

TYP. PIPE-BOLLARD IN SLAB-ON-GRADE OR PAVEMENT 12.A PASSENGER VEHICLE IMPACT RESISTANT ONLY S007 SCALE: N.T.S.

IMPACT RESISTANCE WITHOUT SLAB-ON-GRADE IN PLACE

THIS DETAIL SHALL BE DEEMED INADEQUATE FOR VEHICULAR

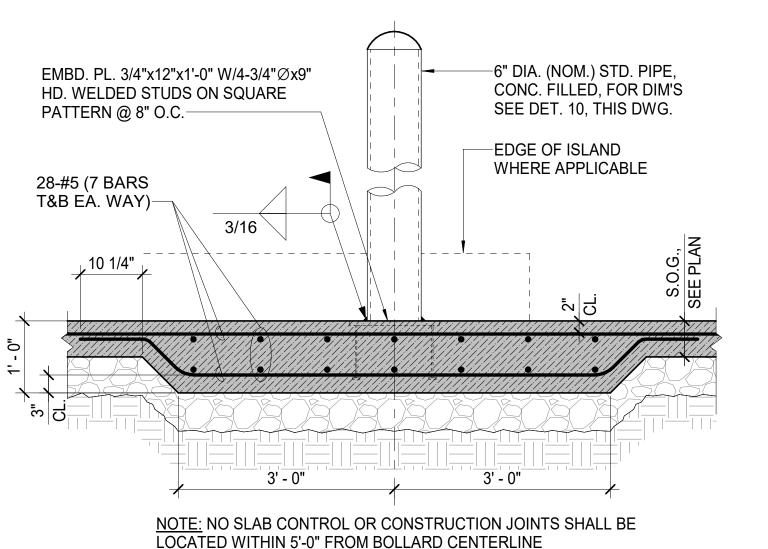

ALTERNATE PIPE-BOLLARD DETAIL ON SLAB-ON-GRADE 12.B PASSENGER VEHICLE IMPACT RESISTANT ONLY S007 SCALE: N.T.S.

WELDED STUDS SET IN SQUARE 8"x8" PATTERN, HOT-DIP GALV. MASK OFF OR REMOVE ZINC COATING WITHIN 3" OF WELDS. PROVIDE COLD GALV. COMPOUND OR ZRC PAINT FOLLOWING COMPL. OF WELDS AND CLEANUP

TYP. NON-REMOVABLE PIPE-BOLLARD DETAIL ON ELEVATED 13. SLAB\_PASSENGER VEHICLE IMPACT RESISTANT ONLY S007 SCALE: N.T.S.

-6" DIA. STD. PIPE FILLED

-4#4x8'-0" EA. WAY @

PL 5/8"x12"x1'-0" W/4-3/4"Øx51/2" HD.

W/ CONC.

14. SLAB\_PASSENGER VEHICLE IMPACT RESISTANT ONLY S007 SCALE: N.T.S.

TYP. REMOVABLE PIPE-BOLLARD DETAIL ON ELEVATED

SCALE: As indicated DATE: ISSUED FOR PROJECT NO: 50-24102 RWN. CHK'D. Designer Author

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D. YURY SWETIN, E

ISSUE

NO. DESCRIPTION DATE DRAWING TITLE: GENERAL TYPICAL DETAILS

**S007** 

## EXMITETTO DETAIL 1, THIS DRAWING

1. THIS DETAIL NEED NOT BE USED WHEN THE SUBJECT WALL IS PLACED BETWEEN INTEGRALLY BUILT INTERSECTING SIMILAR WALLS AND THE RESULTING HORIZONTAL SPAN DOES NOT EXCEED 36\*T, WHERE T IS THE NOMINAL WALL THICKNESS.

2. THE FOLLOWING INFORMATION SHALL BE USED WITH THIS DETAIL FOR REINFORCED INTERIOR MASONRY PARTITIONS WITH THE MAXIMUM WIND PRESSURE OF 32 PSF AND NOT SUBJECT TO VEHICULAR (PASSENGER CAR) IMPACT.

		MAX	IMUM CONN	IECTION SPA	ACING							
NOMINAL WALL		WALL HEIGHT (Feet)										
THICKNESS	8	9	12	15	18	20	22	24				
4"	7'-0"	-	-	-	-	-	-	-				
6"	9'-0"	$\langle \cdots \rangle$	9'-0"	8'-0"	7'-6"	-	-	-				
8"	11'-0"	<	$\longrightarrow$	11'-0"	9'-6"	9'-6"	-	-				
10"	13'-0"		$\rightarrow$	13'-0"	11'-0"	$\langle \cdot \rangle$	11'-0"	-				
12"	14'-6"			$\rightarrow$	14'-6"	12'-0"	$\left  \leftarrow \rightarrow \right $	12'-0"				

3. EXTERIOR MASONRY WALLS SUBJECT TO VEHICULAR IMPACT AND WIND LOADS IN EXCESS OF 5 PSF SHALL BE REINFORCED. TOPS OF SUCH WALLS MAY NOT BE BRACED FOR WALL HEIGHTS NOT EXCEEDING RESPECTIVE LIMITS FOR CANTILEVER WALLS IN SCHEDULES BELOW. WHEN BRACED AT TOP AND BOTTOM IN ACCORDANCE WITH DETAIL 1, THIS DRAWING, HEIGHT OF SUCH WALLS SHALL NOT EXCEED THE FOLLOWING LIMITS:

8" THICK --- 20'-0" 10" THICK --- 22'-0" 12" THICK --- 24'-0"

4. THE FOLLOWING REINFORCEMENT INFORMATION SHALL APPLY TO EXTERIOR C.M.U. WALLS SUBJECT TO WIND OR VEHICULAR (PASSENGER CAR) IMPACT AS APPLICABLE. THE MOST STRINGENT OF THE APPLICABLE CONDITIONS SHALL APPLY. LATERAL LOADS USED ARE AT STRENGTH LEVEL.


VE	EHICULAR IMPA	CT 10,000 lbs -	WALL HEIGHT,	MAX (FT)		
NOMINAL WALL	CA	NTILEVER		В	RACED	
THICKNESS, T	9	10	11	20	22	24
8"	#5@8"	-	-	#4@8"	-	-
10"	#5@16"	#5@16"	-	#5@16"	#5@16"	-
12"	#5@24"	#5@24"	#5@24"	#5@24"	#5@24"	#5@24"

NOMINAL WALL			CANTILE	VER		
THICKNESS	6	7	8	9	10	11
4"	#4@24"	-	-	-	-	-
6"	#4@48"	#4@32"	#4@24"	-	-	-
8"	#4@48"	#4@48"	#4@40"	#4@24"	-	-
10"	#4@48"	#4@48"	#4@48"	#4@40"	#4@32"	-
12"	#4@48"	#4@48"	#4@48"	#4@48"	#4@40"	#4@32

TALLER CANTILEVER WALLS NOT REFLECTED IN THESE TABLES ARE SPECIFICALLY DETAILED ON THE DRAWINGS.

	WINI	D LOAD 32	PSF - WA	LL HEIGH I	, MAX (F1)		
NOMINAL WALL				BRACED			
THICKNESS	10	12	15	18	20	22	24
4"	#4@24"	-	-	-	-	-	-
6"	#4@48"	#4@40"	#5@24"	#5@8"	-	-	-
8"	#4@48"	#4@48"	#4@40"	#4@24"	#5@16"	-	-
10"	#4@48"	#4@48"	#4@48"	#4@32"	#5@40"	#5@32"	-
12"	#4@48"	#4@48"	#4@48"	#4@40"	#4@32"	#5@40"	#5@32"

- 5. INTERIOR MASONRY PARTITIONS SUBJECT TO OBC '17 PAR. 1607.14 DESIGNED FOR LATERAL LOAD OF 5 PSF SHALL NOT EXCEED 12 FT FOR CANTILEVER ARRANGEMENT OR 24 FT FOR BRACED ARRANGEMENT. ALL SUCH PARTITIONS TALLER THAN 10 FT SHALL NOT BE LESS THAN 8" NOM. IN THICKNESS AND SHALL BE REINFORCED WITH #4@48" VERTICAL REINFORCEMENT. ADEQUACY OF THESE PARTITIONS FOR ANY ADDITIONAL LOADING NOT AVAILABLE AT THE TIME OF DESIGN SHALL BE VERIFIED BY THE ARCHITECT PRIOR TO CONSTRUCTION.
- 6. TOP OF WALL BRACING CONNECTIONS FOR EXTERIOR MASONRY WALLS SUBJECT TO VEHICULAR IMPACT AND WIND LOADS, WHEN REQUIRED, SHALL NOT BE SPACED FURTHER APART THAN 5'-0".
- 7. ALL EXTERIOR MASONRY WALLS SUBJECT TO VEHICULAR IMPACT AT PARKING AREAS OR DRIVE AISLES SHALL BE FULLY GROUTED FROM THE BEARING UP TO A HEIGHT OF 2'-8" (+/-) ABOVE FINISHED FLOOR.

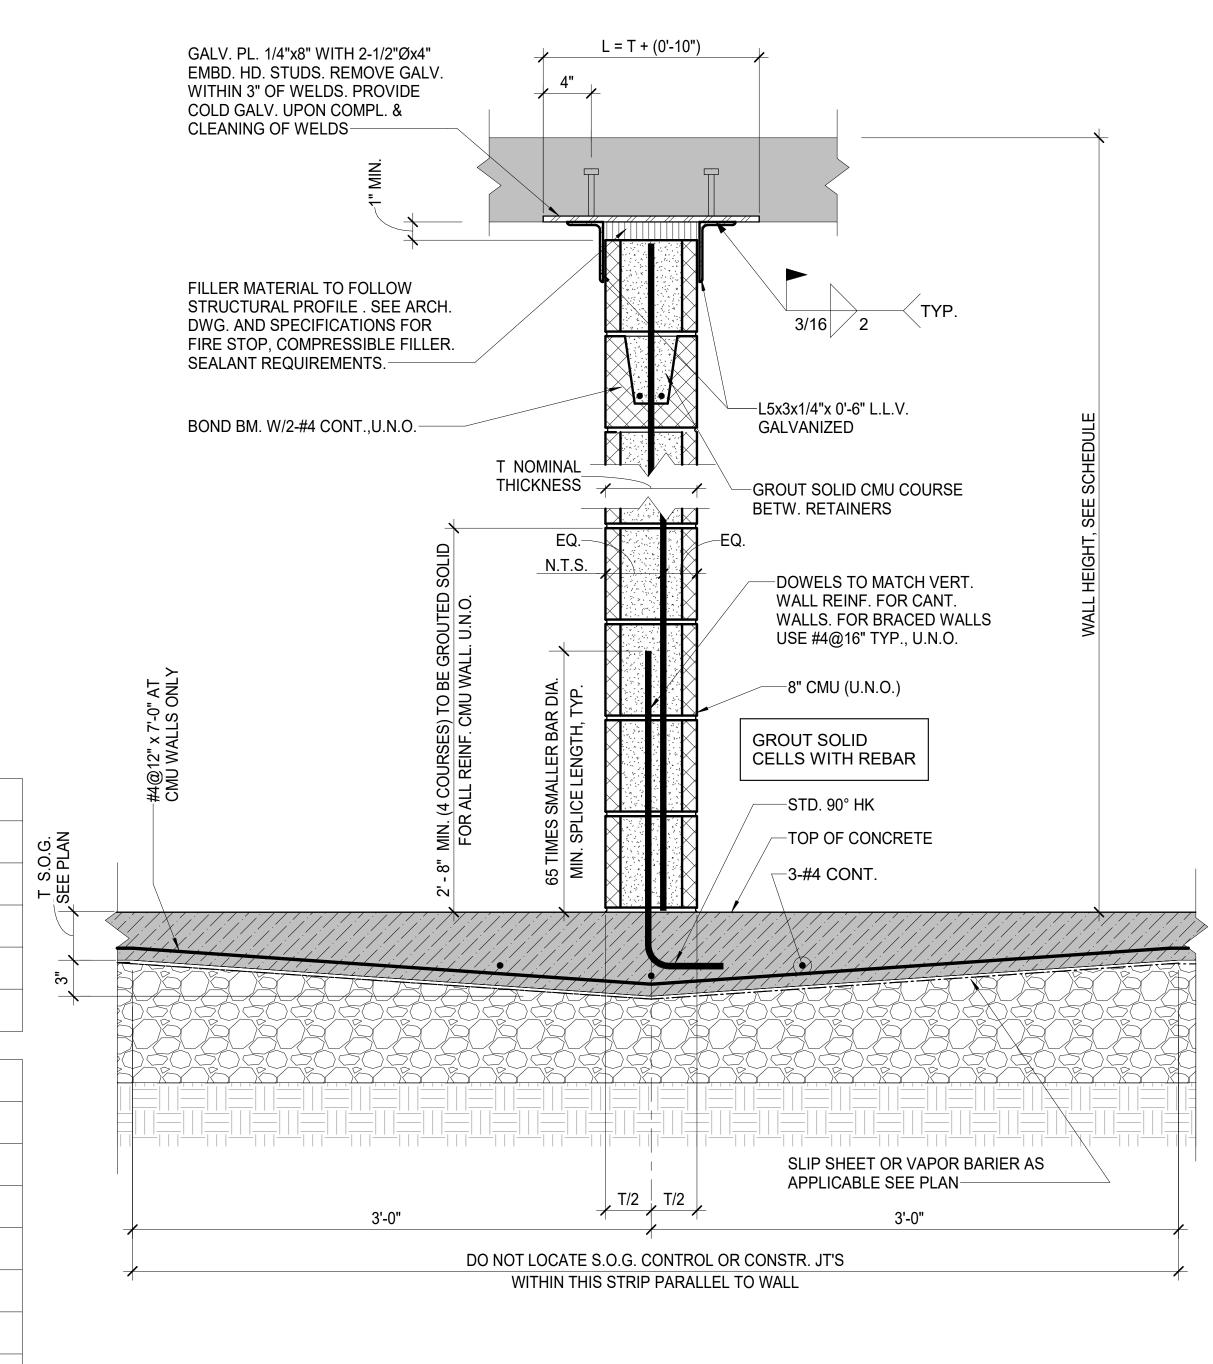

TYP. NON-LOAD BEARING CMU WALL DETAIL AT S.O.G. SLAB

-STEEL LINTEL

R.O., SEE ARCH. DWG'S

SEE SCHEDULE

**OPENING** 

-GROUT LINTEL

**BLOCK SOLID** 

-REINFORCEMENT

OPENING

R.O., SEE ARCH. DWG'S

S008 SCALE: N.T.S.

MIN. GROUTING LENGTH

SEE LINTEL NOTES

MIN. GROUTING LENGTH

BEARING DETAIL MASONRY LINTEL IN CMU

BEARING DETAIL STEEL LINTEL IN CMU

MIN.

SEE LINTEL

4 WALL\_053024

5 WALL 053024 SCALE: N.T.S.

S008 SCALE: N.T.S.

MIN. BEARING

-DOWELS TO MATCH VERT. WALL REINF. FOR CANT. WALLS. FOR BRACED WALLS USE #4@16" TYP., U.N.O. -FOR CMU WALL REINF. SEE DETAIL 1, THIS DWG. **GROUT SOLID** CELLS WITH REBAR -SLIP SHEET OR VAPOR BARIER AS FOUNDATION -APPLICABLE SEE PLAN NOTE: FOR REMAINDER OF THIS

T NOMINAL

WALL

THICKNESS

DETAIL, SEE DETAIL 1, THIS DWG. 1A TYP. CMU ON FOUNDATION WALL DETAIL S008 SCALE: N.T.S.

SEE BM SCHEDULE SILL SUPP'T L AND CONN. TO **BEAM WIDTH** CONC. BY ELEVATOR MFR., TYP., U.N.O.-T+1" < B GALV. PL. 1/4"x8" WITH 2-1/2"Øx4" EMBD. HD. STUDS @ 6" O.C. REMOVE GALV. WITHIN 3" OF MIN. WELDS. PROVIDE COLD GALV. UPON COMPL. & CLEANING OF WELDS-3/16 \ 2@4 ELEV. HOISTWAY OR SIM. CONDITION REQUIRING FLUSH INSTALLATION OF -L5x3x1/4"x 0'-6" L.L.V. RETAINER ANGLES GALVANIZED NOM. WALL THICKNESS


> NOTE: FOR REMAINDER OF THIS DETAIL, SEE DETAIL 1, THIS DWG.

OPTIONAL WALL HEAD RETAINERS CONN.

2 DETAIL\_053024 S008 SCALE: N.T.S.

> T/CONC., EL. VARIES, SEE ARCH. DWG'S

S008 SCALE: N.T.S.

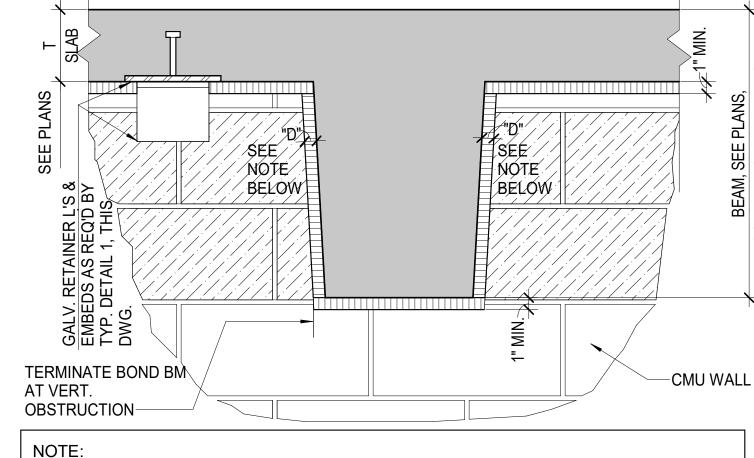

DIMENSION "D" SHALL NOT BE LESS THAN THE AMOUNT OF THE LIFETIME STRUCTURE MOVEMENT RELATIVE TO THE WALL PLUS MINIMUM THICKNESS OF FULLY COMPRESSED FILLER MATERIAL PLUS 1/4", NOR 1". CONSULT WITH ARCHITECT FOR SPECIFIC LOCATION.

PARTIAL WALL ELEVATION AT VERTICAL 3 OBSTRUCTION\_053024

#### LINTEL NOTES AND SCHEDULE

- 1. MASONRY LINTELS LISTED FOR THE RANGE OF ROUGH MASONRY OPENING IN THE SCHEDULE BELOW APPLY TO NON-LOAD BEARING WALLS ONLY. 2. LINTELS IN MASONRY WALLS SHALL BE PROVIDED FOR ALL OPENINGS AS INDICATED ON THE STRUCTURAL AND ARCHITECTURAL DRAWINGS. IN ADDITION, LINTELS ARE REQUIRED FOR ANY MECHANICAL, ELECTRICAL, OR PLUMBING OPENING IN A MASONRY WALL WITH A WIDTH GREATER THAN 12
- 3. LINTELS SHALL HAVE A MINIMUM BEARING OF 8" FOR SPANS UP TO 8'-0", AND 16" FOR SPANS GREATER THAN 8'-0". UNLESS NOTED, THEY SHALL BE OF THE SIZES LISTED BELOW.
- 4. C.M.U. OPENINGS MAY BE SPANNED WITH EITHER A STEEL LINTEL OR MASONRY LINTEL BLOCK, AT THE CONTRACTOR'S OPTION.
- 5. ALL LINTEL MEMBERS EXCEPT SINGLE ANGLES AND UNLESS NOTED OTHERWISE, SHALL BE CENTERED IN PLAN ON SUPPORTED MASONRY TO
- MINIMIZE EFFECT OR TORSION. 6. PLATE IN STEEL LINTEL SHALL BE WELDED AT BOTTOM OF RESPECTIVE STEEL SHAPE WITH 1/4" INTERMITTENT FILLET WELDS @ 12" O.C. PROVIDE CONTINUOUS 1/4"X2'-0" WELD ALONG COVER PLATE AT EITHER END ON EACH
- SIDE OF STEEL LINTEL. 7. PLATE WIDTH SHALL BE 1" LESS THAN THE ACTUAL WIDTH OF MASONRY.

CMU	SPAN	STEEL LINTEL	MASONRY LINTEL
4" WALL	4' 4' - 6' 6' - 8'	L3 1/2x3 1/2x5/16 L5x3 1/2x3/8 L6x3 1/2x3/8	
6" WALL 4" WALL	4' 4' - 6' 6' - 8'	WTx9 WT5x15 WT7x11	8" LINTEL BLOCK w/1-#4 8" LINTEL BLOCK w/2-#5 16" LINTEL BLOCK w/2-#5
8" WALL	4' 4' - 6' 6' - 8' 8' - 12'	2–L3 1/2x3 1/2x5/16 2–L5x3 1/2x3/8 2–L6x3 1/2x3/8 WT8x18 +3/8" PL	8" LINTEL BLOCK w/2-#4 16" LINTEL BLOCK w/2-#4 16" LINTEL BLOCK w/2-#5 8"+16" LINTEL BLOCK w/2-#5 EA
10" WALL	4' 4' - 6' 6' - 8' 8' - 12'	2–L3 1/2x3 1/2x5/16 2–L4x3x3/8 WT8x18 +3/8" PL WT8x24 +3/8" PL	8" LINTEL BLOCK w/2-#4 16" LINTEL BLOCK w/2-#4 16" LINTEL BLOCK w/2-#5 8"+16" LINTEL BLOCK w/2-#5 EA
12" WALL	4' 4' - 6' 6' - 8' 8' - 12'	3-L3 1/2x3 1/2x5/16 3-L5x3 1/2x3/8 W8x24 +3/8" PL W12x26 +3/8" PL	8" LINTEL BLOCK w/2-#4 16" LINTEL BLOCK w/2-#4 16" LINTEL BLOCK w/2-#5 8"+16" LINTEL BLOCK w/2-#5 EA.
CAVITY	8' 8' - 12'	W8x24 +3/8" PL W12x26 +3/8" PL	



5. EXP. JT. OR CONTROL JT. STRIP. ADHERE TO ONE

LEGEND FOR DETAILS 6 THROUGH 9, THIS DWG.:

3. HORIZONTAL REINF. IN BOND BEAMS, WHERE

2. VERTICAL REBAR SCHEDULED. PROVIDE MIN. OF 2 IN GROUTED ADJ. CELLS AT DISCONT. ENDS AND

1. STRUCTURAL C.M.U.

S008 SCALE: N.T.S.

CORNERS.


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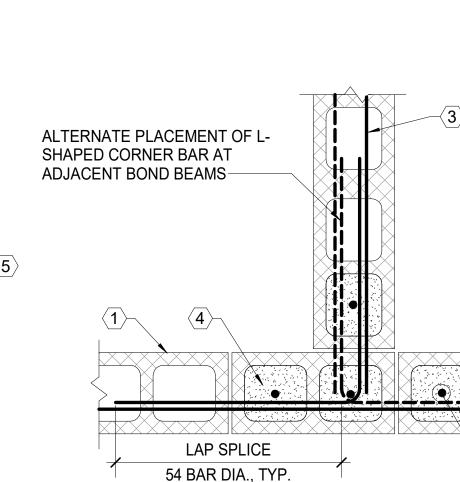
4. GROUT

TYP. DETAIL. DISCONT. 6 END OF CMU WALL 053024

DISCONT. WALLS TYPICAL DETAIL

8 CMU WALL CORNER S008 SCALE: N.T.S.



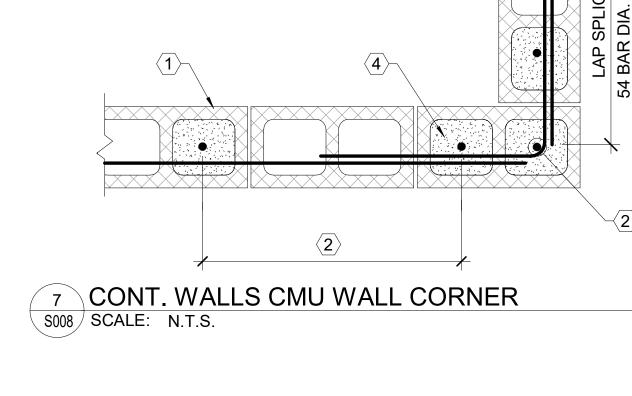

9 TYPICAL DETAIL CMU WALL INTERSECTION S008 SCALE: N.T.S.

ISSUE

NO. DESCRIPTION DATE DRAWING TITLE: **TYPICAL MASONRY DETAILS** 

DRAWING NO: **S008** 


SCALE: As indicated DATE: ISSUED FOR PERMIT 06-10-2 PROJECT NO: 50-24102

RWN. CHK'D. Designer Author Checker





NICWN F. DUNDFF TARRING OFF

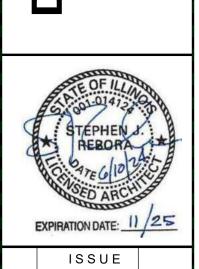

NO. DESCRIPTION DATE

DRAWING TITLE:
FOUNDATION
AND GRADE
LEVEL PLAN

DRAWING NO:

SCALE: 1/8" = 1'-0"

DATE: ISSUED FOR
PERMIT 06-10-24
PROJECT NO: 50-24102

DES. RWN. CHK'D.
Designer Author Checker





ISSUE


NO. DESCRIPTION DATE DRAWING TITLE:
SECTIONS AND DETAILS

DRAWING NO:

SCALE: As indicated DATE: ISSUED FOR
PERMIT 06-10-24
PROJECT NO: 50-24102

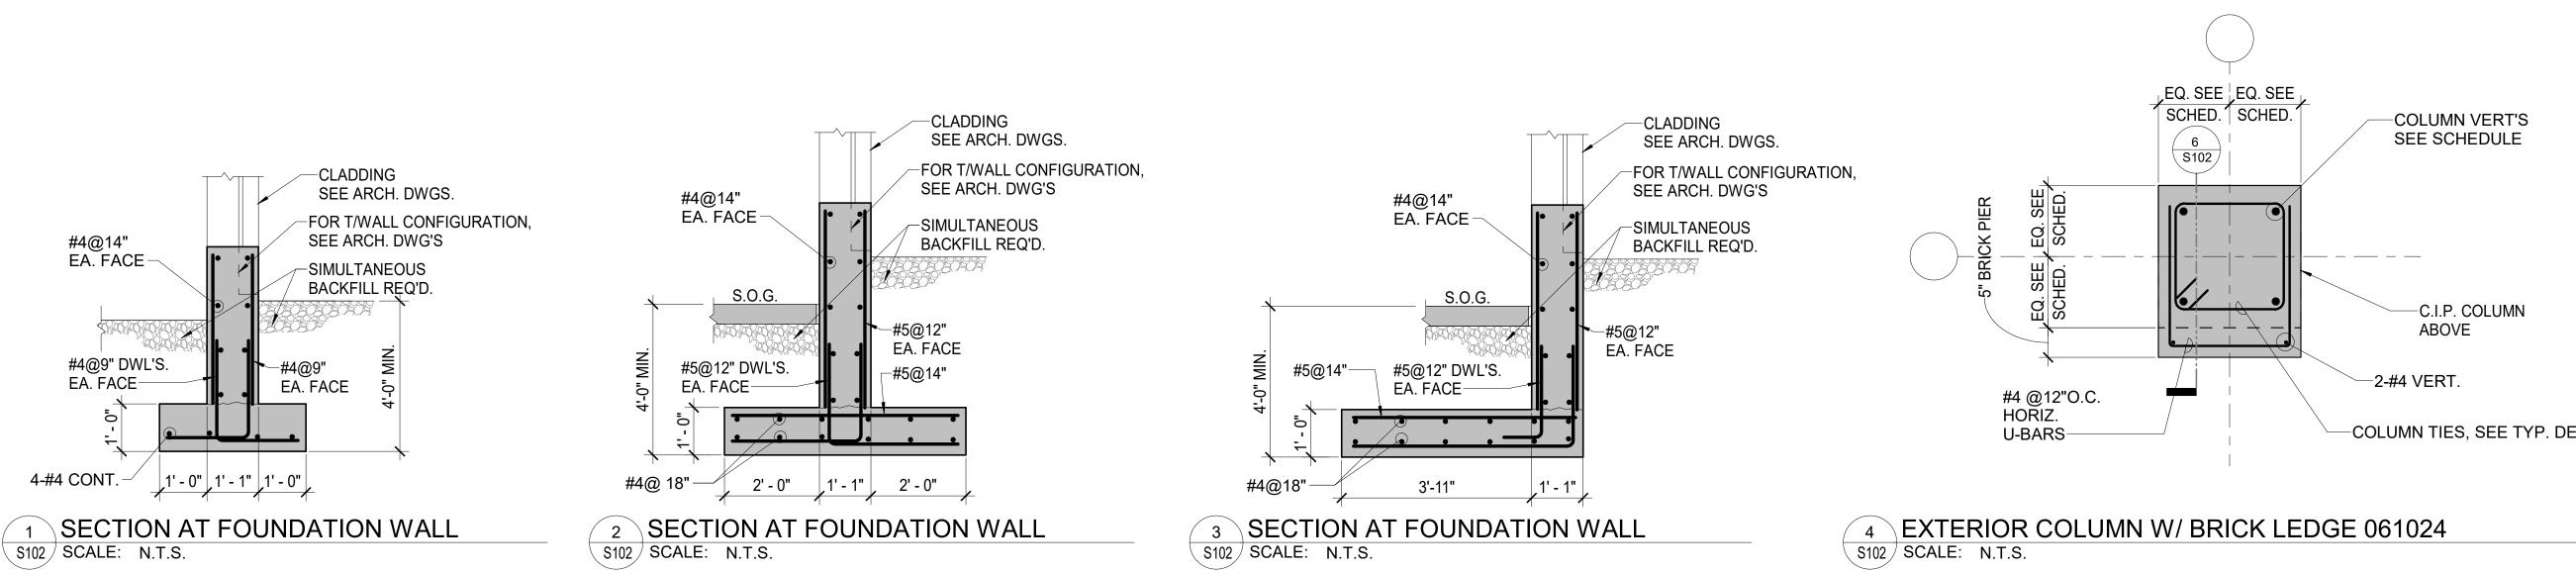


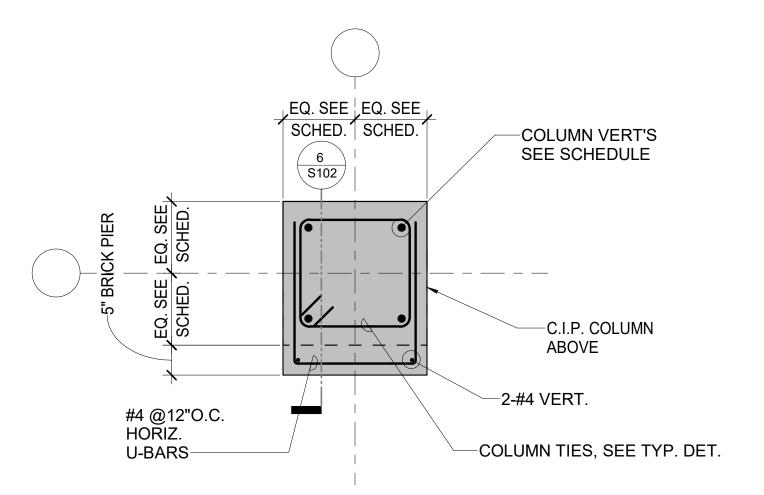

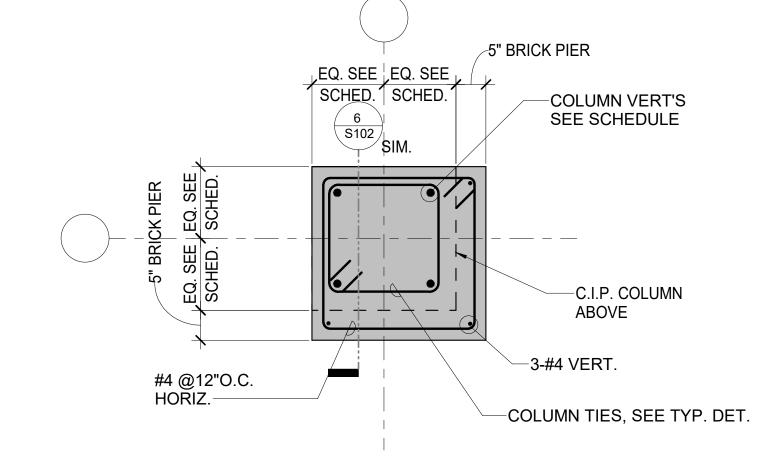




5 CORNER COLUMN W/ BRICK LEDGE 061024 01 SCALE: N.T.S.

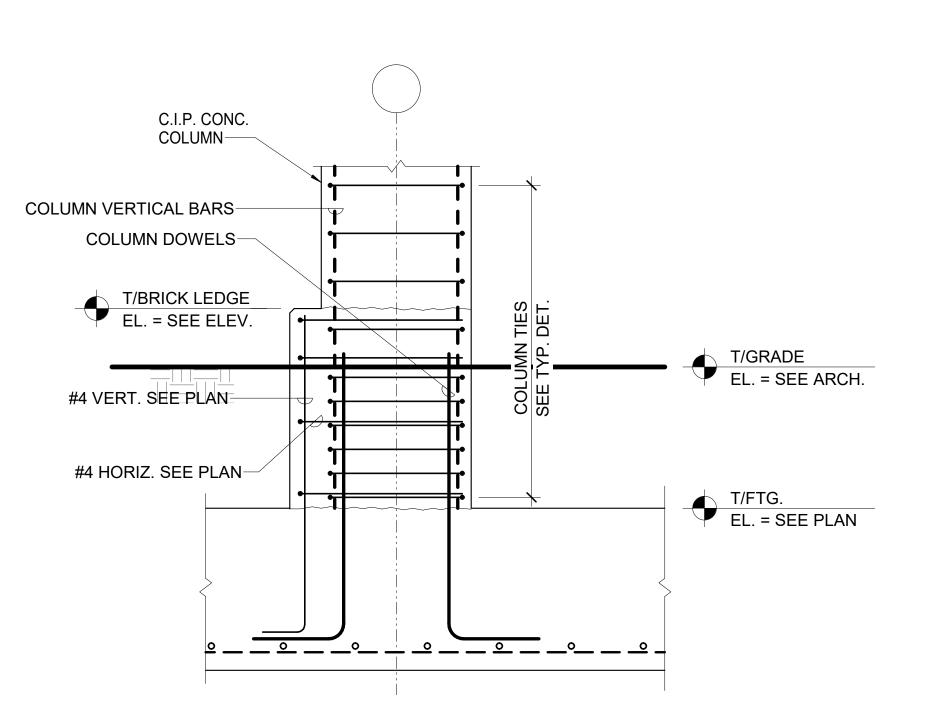


6 SECTION - COLUMN W/ BRICK LEDGE 061024 SCALE: N.T.S.

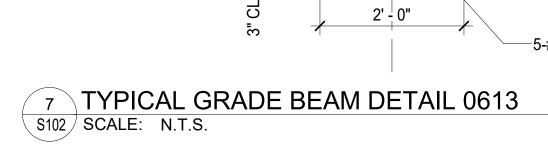

B/FTG. EL.

CL H-PILE, FTG. & GR. BM.—

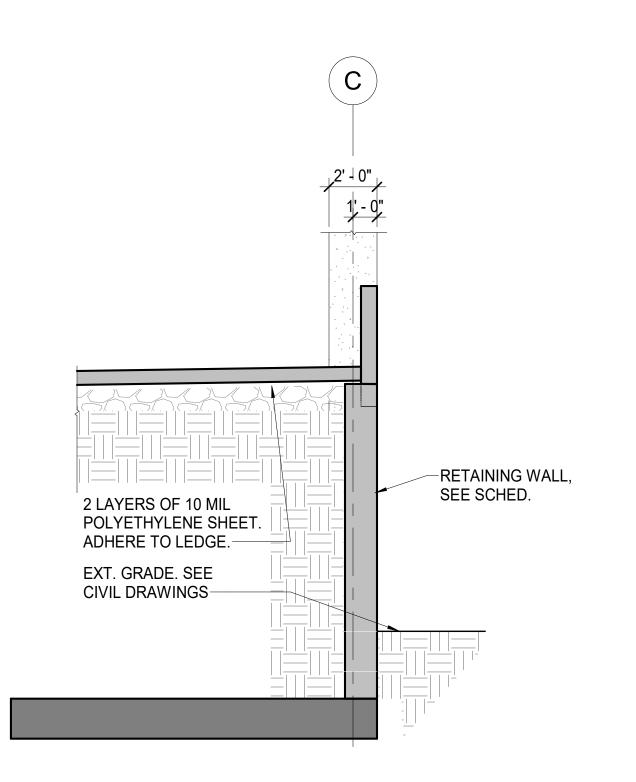

8 Detail 1 S102 SCALE: 1/4" = 1'-0"

─3-#6 EA. FACE

-#4@8" STIRRUPS

**S102** 

1A #4 @ 14"; CONT. BARS (1+1A) MAY BE USED AT CONTR. OPTION

2 #4 @ 16"

3 #4 @ 12" x 6'-0"

4 #4 @ 12"

4A #4 @ 12"; CONT. BARS (4+4A) MAY BE USED AT CONTR. OPTION

5 | #5 @ 22"; H/PINS AT CRASH WALLS

**BOTTOM REBAR** 

11 #4 @ 14"


12 #4 @ 16"

13 #4 @ 14" x 23'-0"

13 #4 @ 14" x 16'-0"

**SHEET NOTES:** 

- 1. ALL POST TENSIONED PARKING STRUCTURE ELEVATED SLAB SHALL BE 7" THICK, U.N.O.
- 2. EXTEND AND LAP TOP AND BOTTOM BARS IN ZONES SPECIFICALLY DESIGNATED. SPLICE TOP BARS OVER MID-SPAN AND BOTTOM BARS OVER BEAMS. SEE SECTION.
- 3. MINIMUM (2) MAIN SLAB OR BEAM/GIRDER TENDONS SHALL PASS THROUGH ANY COLUMN.
- 4. PROVIDE A TOTAL OF NINE (X) 1/2 INCH DIAMETER TEMPERATURE TENDONS, EVENLY SPACED WITHIN THE DESIGNATED WIDTH OF SLAB, AT ALL TYPICAL BAYS, U.N.O. IN INSTANCES WHERE OTHER QUANTITY OF SUCH TENDONS IS CALLED OUT, SPACE EVENLY WITHIN THE DESIGNATED WIDTH OF SLAB.
- 5. ALL HOOKS SHOWN IN PLAN SHALL BE STANDARD HOOKS PER ACI 318 OR ACI SP-066, U.N.O.
- 6. LENGTHS OF HOOKED BARS SHOWN ON THESE DRAWINGS DO NOT INCLUDE HOOKS.
- 7. ALL COLUMNS ARE CENTERED ON GRID LINES U.N.O.
- 8. SPACING OF SLAB TENDONS OR GROUPS OF TENDONS SHALL NOT EXCEED 4'-0".
- 9. FOR PURPOSES OF INTERPRETATION OF REINFORCEMENT SHOWN IN SCHEDULE, ALL BEAMS SHOWN IN PLANS ARE MARKED AT LEFT END OR LEFT-HAND SIDE OF SPAN.
- 10. DAMAGED EPOXY COATING SHALL BE REPAIRED WITH SPECIFIED TOUCH-UP MATERIALS AND IN ACCORDANCE WITH MATERIAL MANUFACTURER'S INSTRUCTIONS.
- 11. WITHIN THE SHADED AREA REFERENCED TO THIS NOTE, PROVIDE CONTINUOUS TOP AND BOTTOM MILD STEEL REINFORCEMENT IN LIEU OF SHORT BAR ARRANGEMENT PER TYPICAL DETAILS 4 AND 5 ON DRAWING S303. SPLICE TOP BARS AT MID-SPAN AND BOTTOM BARS AT BEAM CENTERLINES WITH CLASS "B" TENSION LAP SPLICE. REFER TO NOTE 13 UNDER "CONCRETE NOTES" ON DRAWING S002 FOR LAP SPLICE TABULATION FOR UNCOATED AND COATED BARS. IN ADDITION, PROVIDE 2-#5(E) TOP AND BOTTOM CONTINUOUS BARS ALONG EDGE OF SLAB ON EACH SIDE OF COLUMN GRID B AND ALONG EXTERIOR EDGES OF SLAB AT COLUMN GRIDS A AND C.
- 12. AT ALL LOCATIONS WHERE VEHICULAR BARRIER/CRASH WALL OCCURS, EDGE OF SLAB IS TO REMAIN SHORED UNTIL CRASH WALL CONCRETE HAS REACHED 28-DAY COMPRESSIVE STRENGTH.

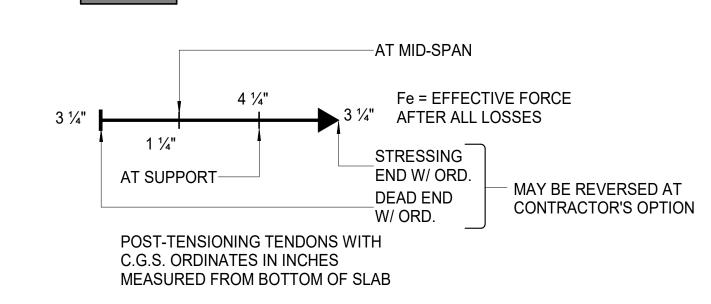

6" THICK PT CONCRETE SLAB

PBXX = BEAM MARK - SEE SCHED. ON DWG. PGXX = GIRDER MARK


**PLAN LEGEND** 

NO. DESCRIPTION DATE DRAWING TITLE: **LEVEL 2** FRAMING PLAN

DRAWING NO:

**S201** 

SCALE: As indicated PERMIT 06-10-24 PROJECT NO: 50-24102

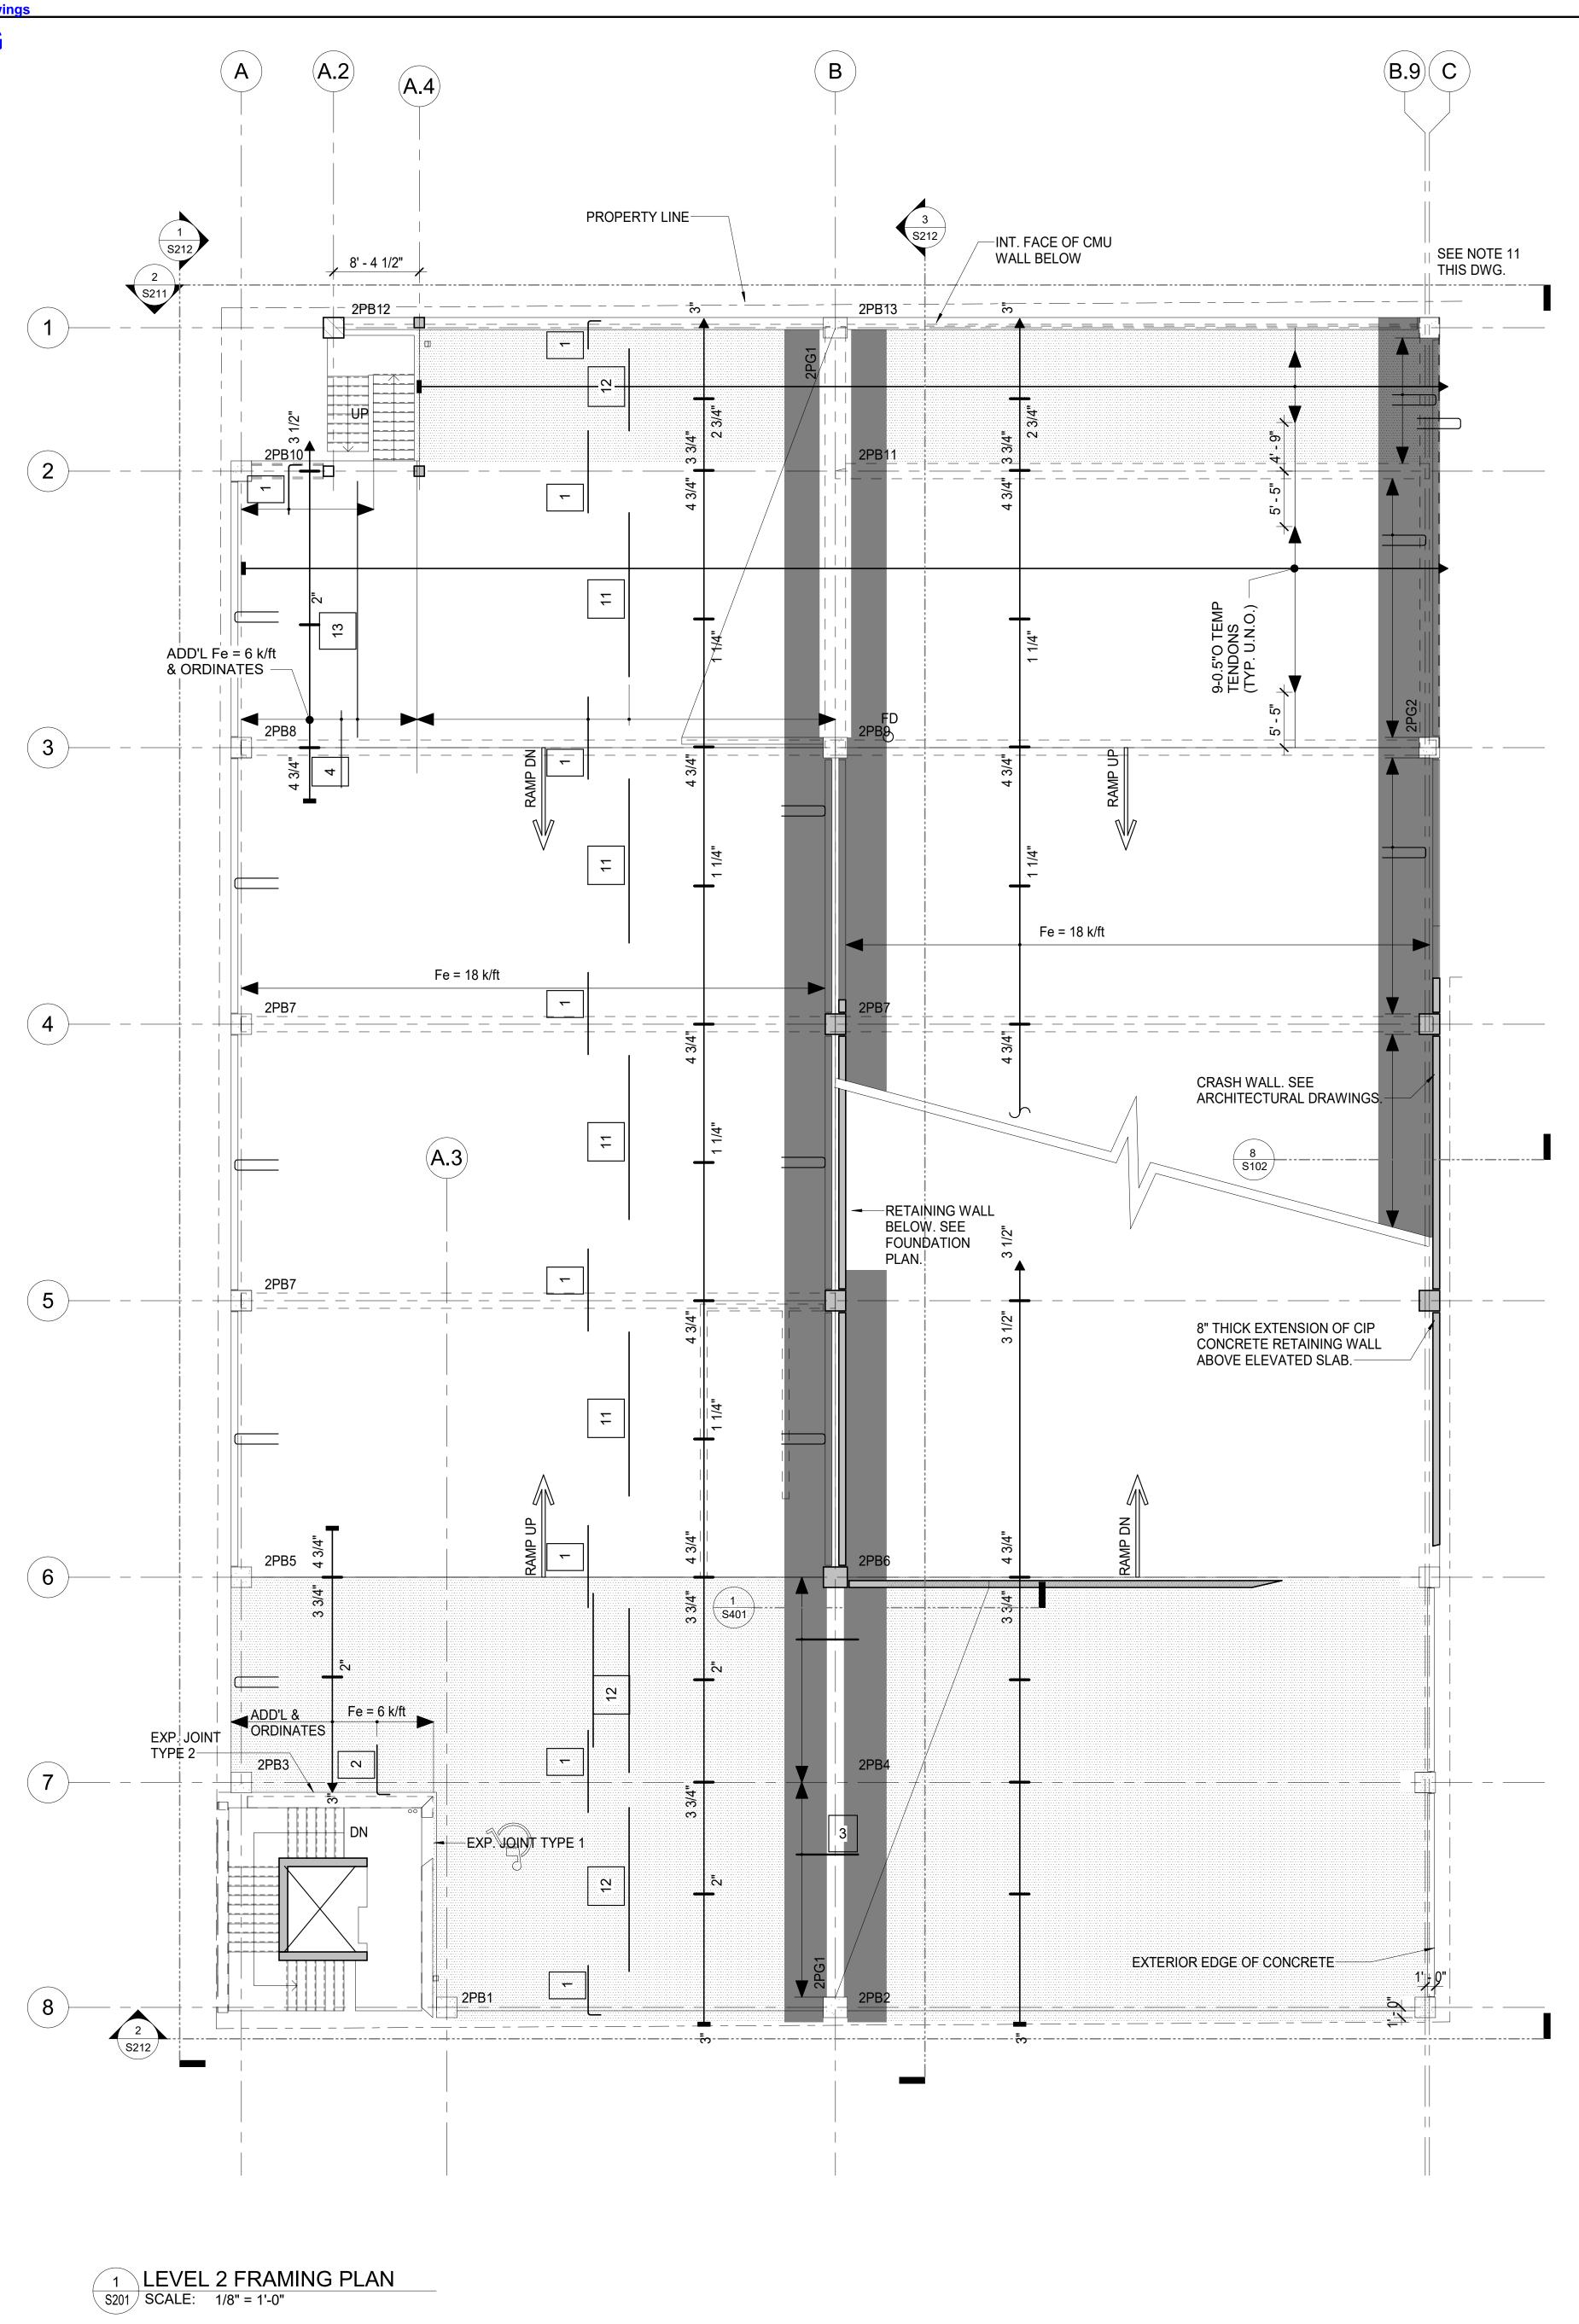


ISSUE

NO. DESCRIPTION DATE DRAWING TITLE:
LEVEL 3
FRAMING PLAN

DRAWING NO:

**S202** 


SCALE: 1/8" = 1'-0" DATE: ISSUED FOR
PERMIT 06-10-24
PROJECT NO: 50-24102 DES. RWN. CHK'D.
Designer Author Checker

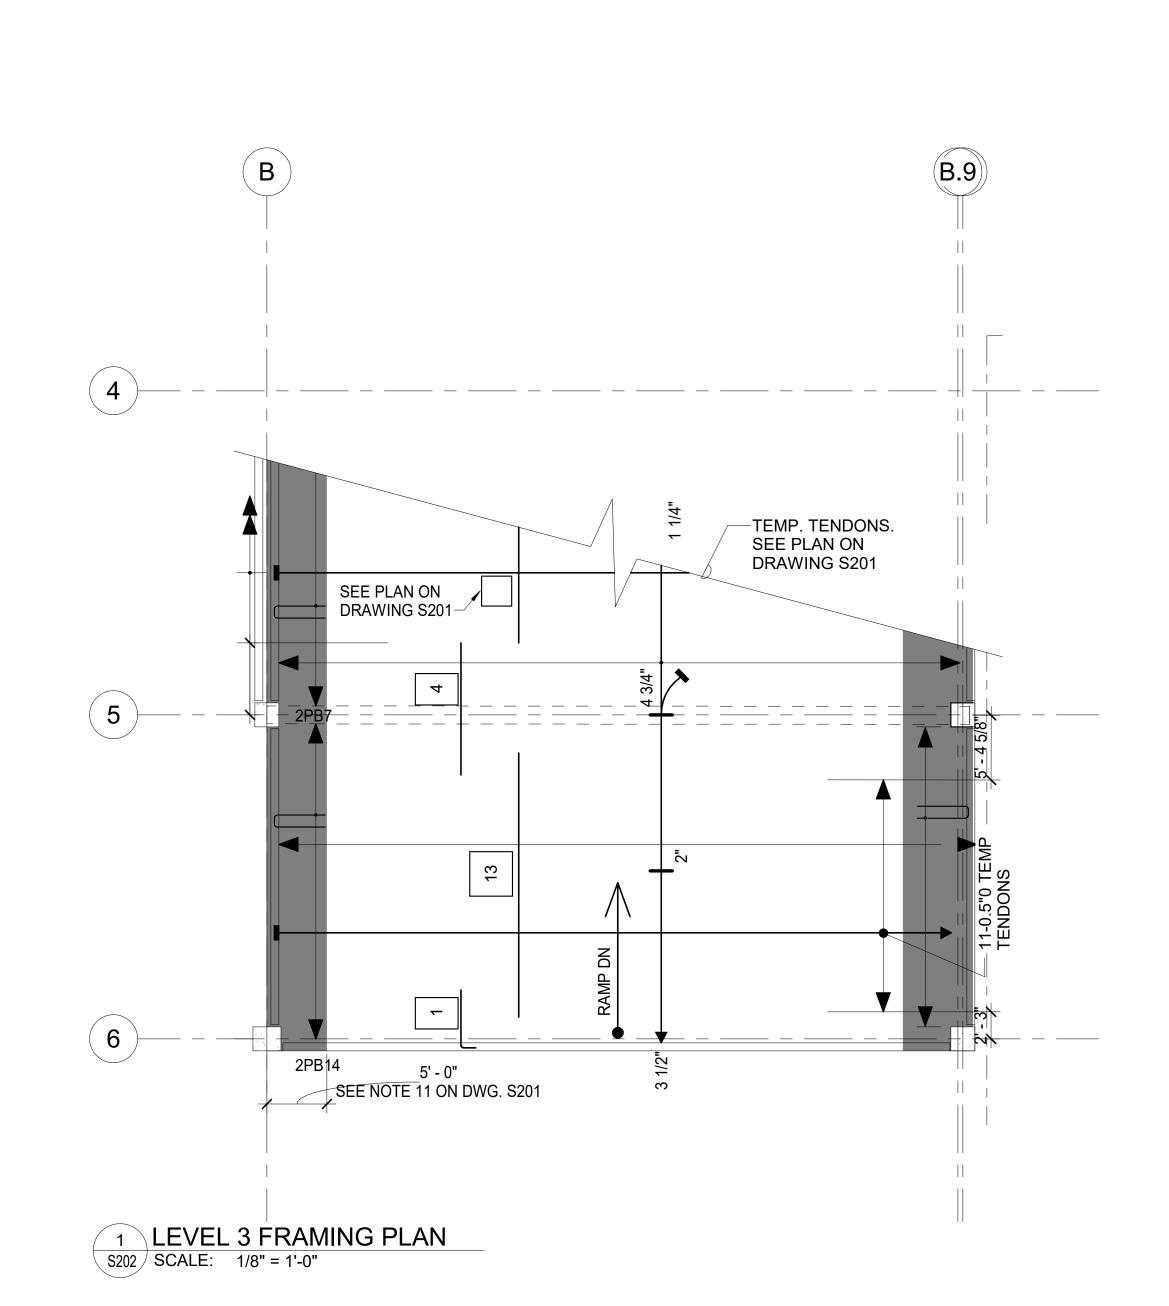


NO. DESCRIPTION DATE DRAWING TITLE:
SKELETAL
ELEVATIONS

> DRAWING NO: **S211**

SCALE: 1/8" = 1'-0" DATE: ISSUED FOR
PERMIT 06-10-24
PROJECT NO: 50-24102 DES. RWN. CHK'D. Designer Author Checker

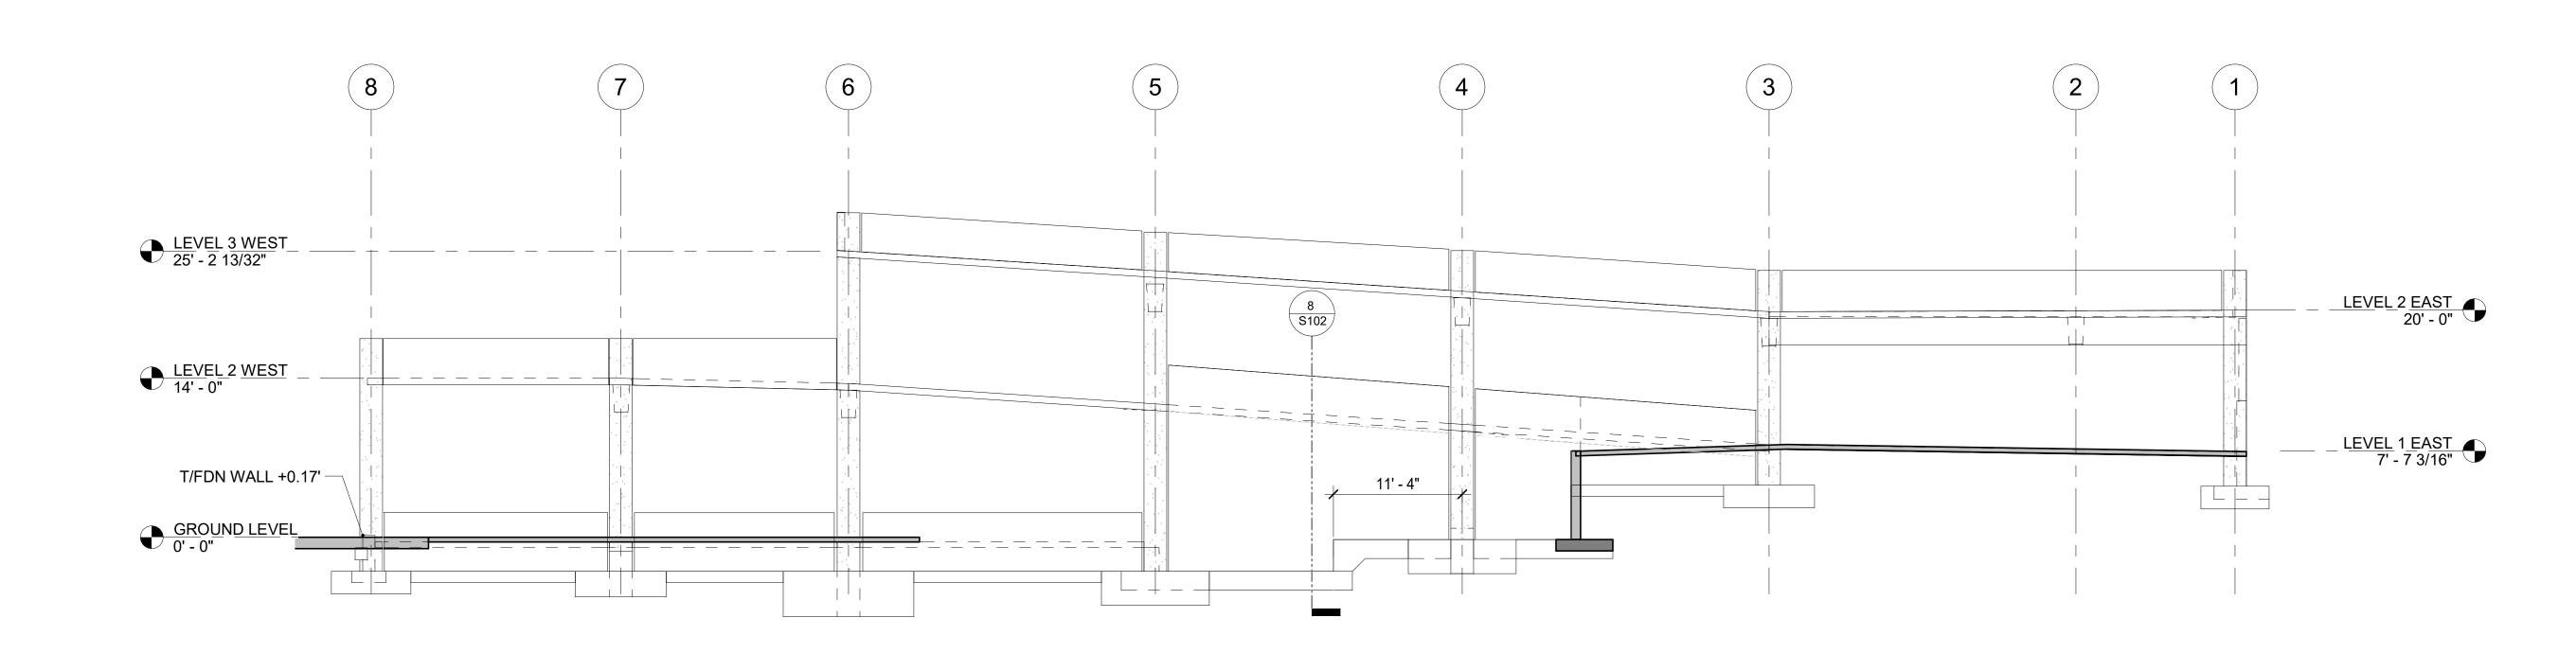

1 SOUTH SKELETAL ELEVATION
S211 SCALE: 1/8" = 1'-0"

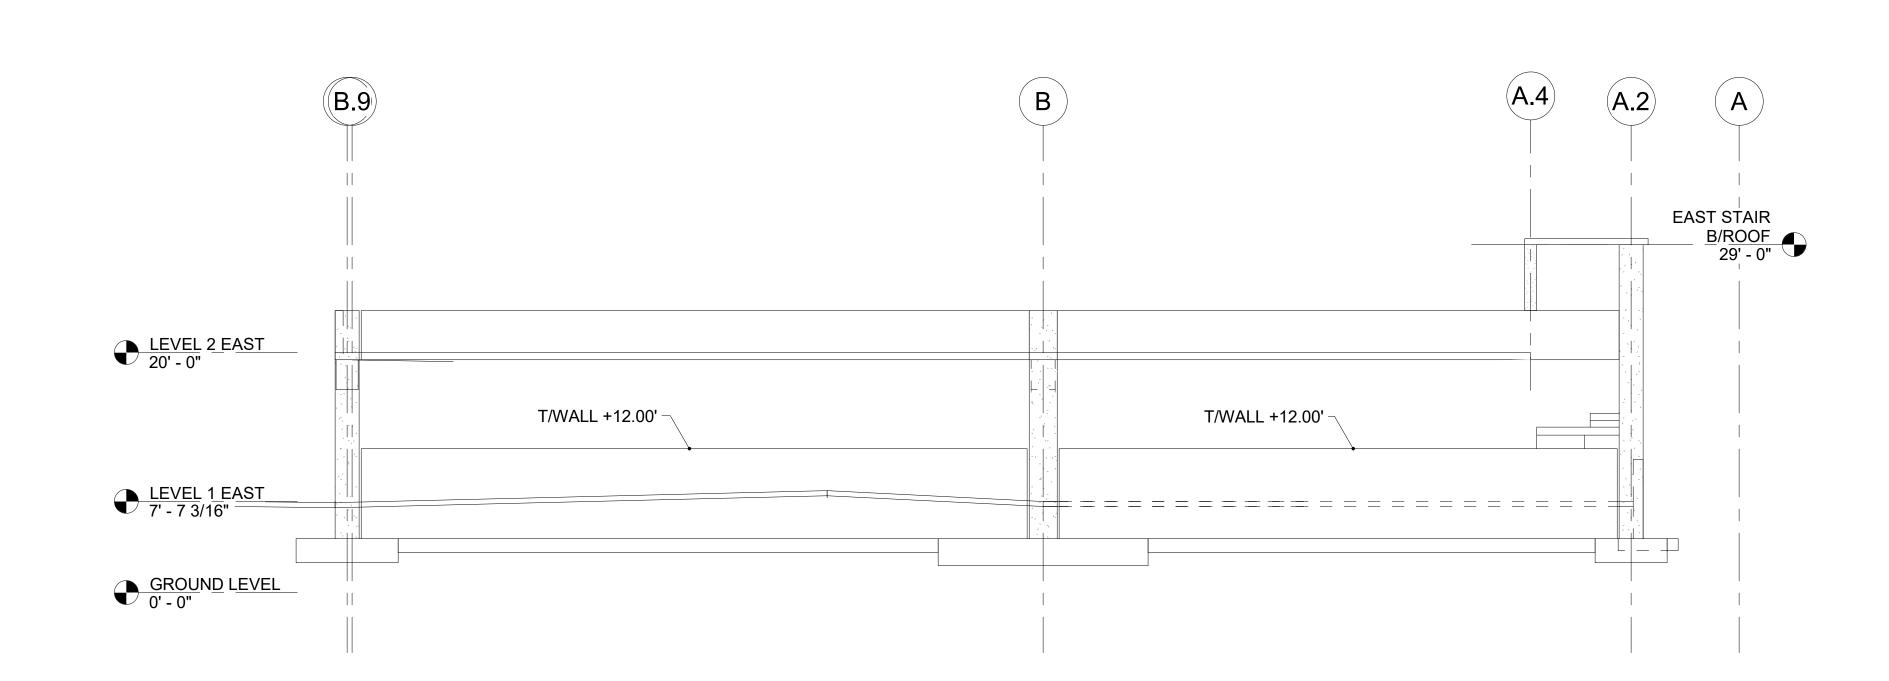


2 EAST SKELETAL ELEVATION
S211 SCALE: 1/8" = 1'-0"

NO. DESCRIPTION DATE DRAWING TITLE:


SKELETAL ELEVATIONS


DRAWING NO: **S212** 

SCALE: 1/8" = 1'-0" DATE: ISSUED FOR
PERMIT 06-10-24
PROJECT NO: 50-24102 DES. RWN. CHK'D. Designer Author Checker

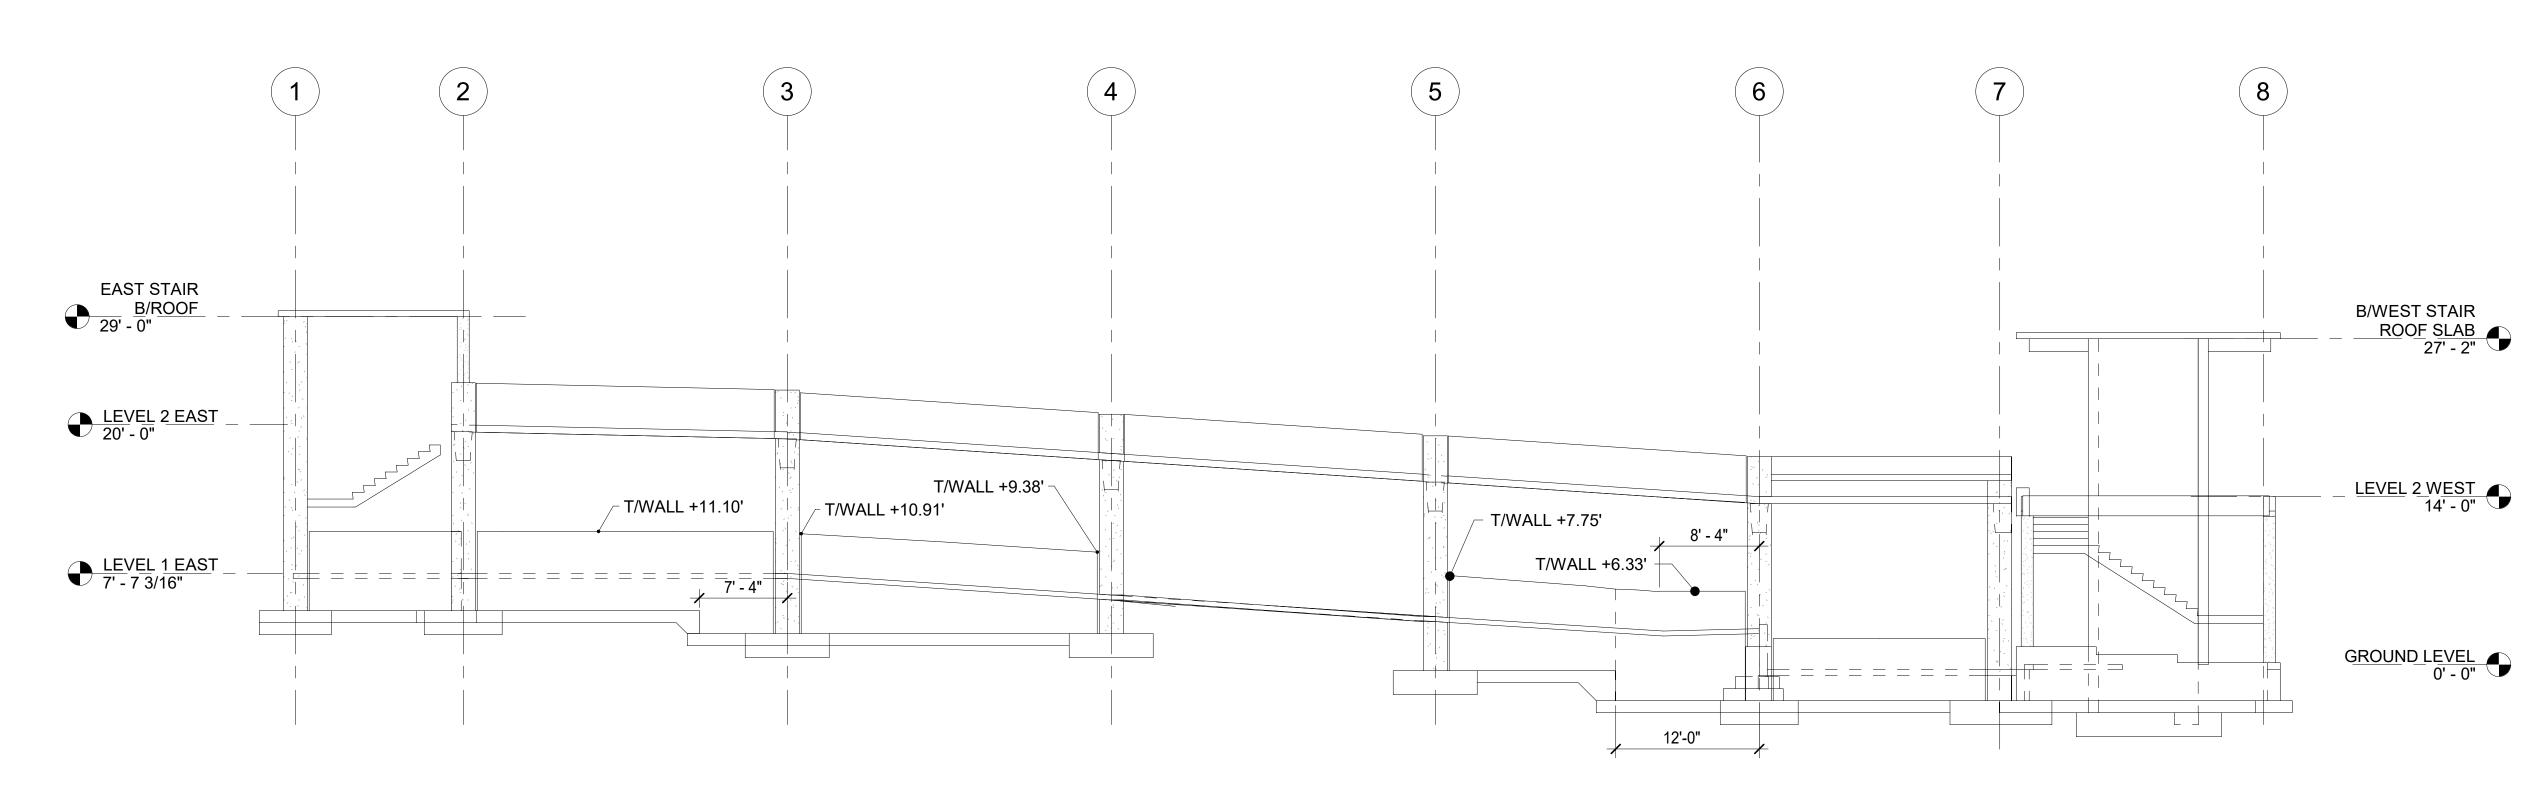

# North Skeletal Elevation S212 SCALE: 1/8" = 1'-0"

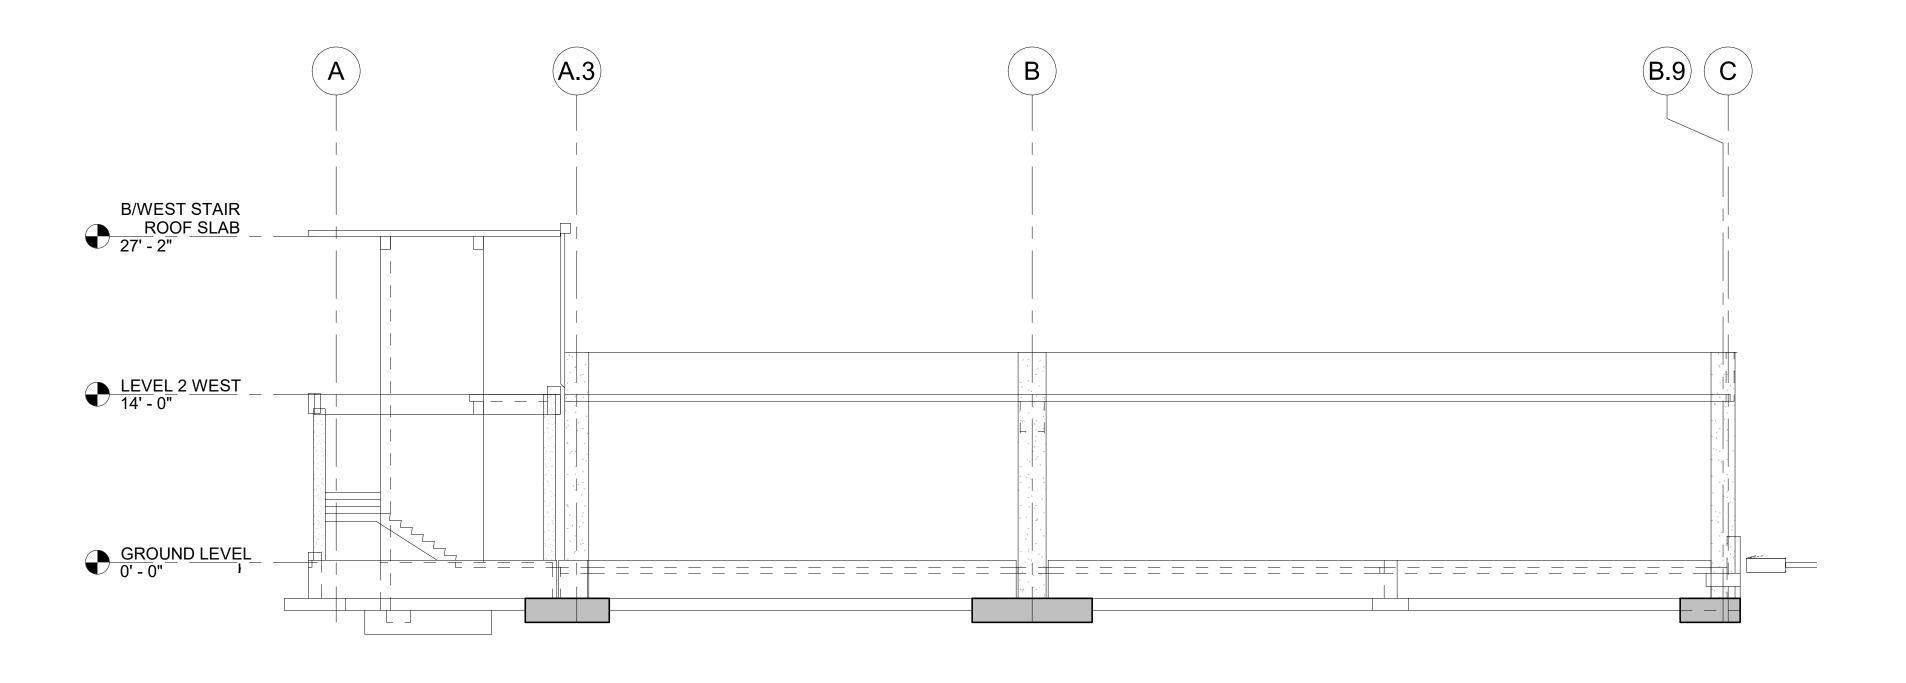

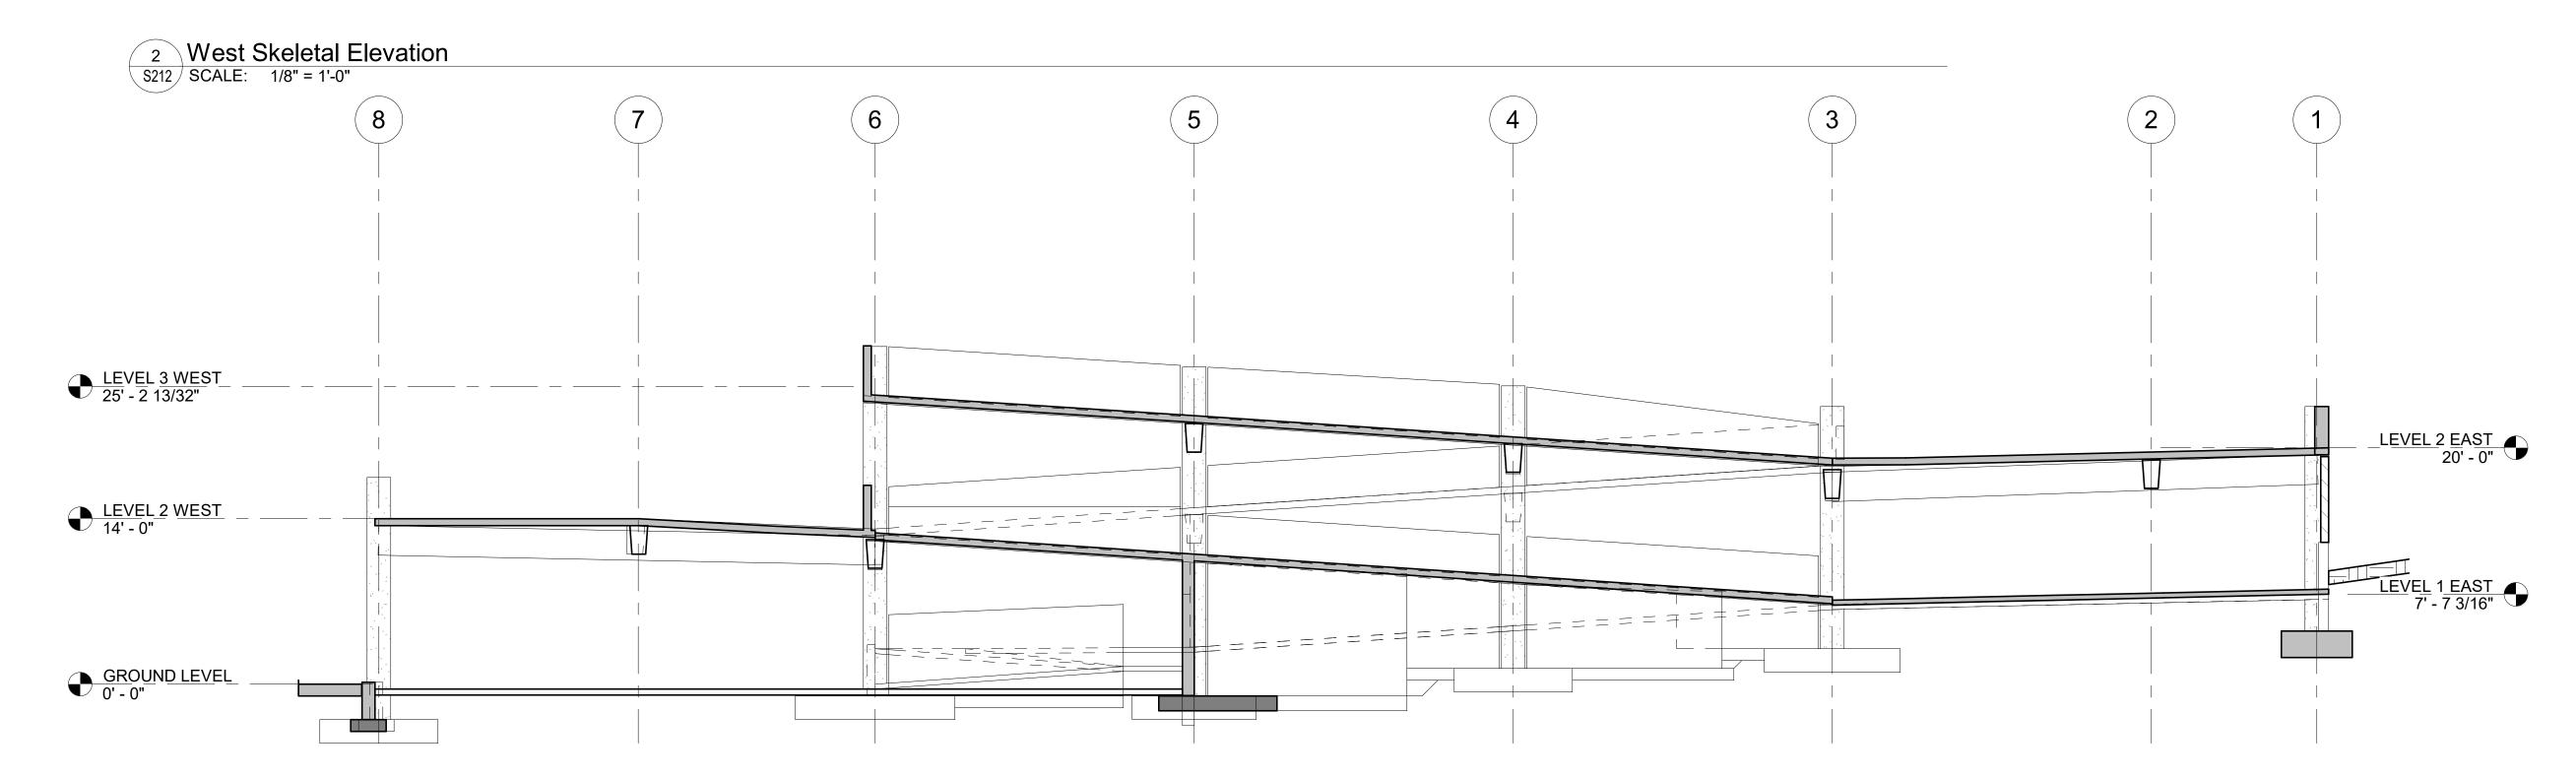


#	DESCRIPTION	REMARKS		
1	END CAP	IF FABRICATED AT SHOP, WEDGES, CAP,		
2	MONOWEDGES	AND SLEEVE WILL BE ASSEMBLED TIGHT		
3	ANCHORAGE	TO ANCHOR		
4	PROTECTION SLEEVE	APPLY ADDITIONAL P.T. GREASE PRIOR TO SLIDING SLEEVE		
5	TENDON	GREASED AND SHEATHED STRAND		
6	GROMMET	PLASTIC POCKET FORMER		
7	SEALING GASKET	SHOP INSTALLED RUBBER PLUG		
8	SPLIT SEALING GASKET	FIELD INSTALLED RUBBER PLUG		
9	STRAND	UNSHEATHED GREASED STRAND IN PROTECTION SLEEVE		

**ASSEMBLY NOTES** 


- 1. LOCATE ANCHOR AT BULKHEAD PER PROJECT PLANS. 2. FOR STRESSING END TENDONS: INSTALL GROMMET FLUSH
- BETWEEN BULKHEAD AND ANCHOR FOR TIGHT SEAL 3. APPLY ADDITIONAL PT GREASE, THEN SLIDE PROTECTION SLEEVE TIGHT AGAINST ANCHOR, LEAVE NO BARE STRAND EXPOSED, TAPE IF NECESSARY.
- 4. AFTER CONCRETE PLACEMENT, AT TIME OF STRESSING, REMOVE GROMMET AND INSERT WEDGES.
- 5. AFTER STRESSING, CUT STRAND TO WITHIN 1/8" OF END CAP. 6. GREASE END CAP AND INSERT TIGHT AGAINST ANCHOR. 7. PATCH STRESSING POCKET PER PROJECT REQUIREMENTS.

2ND POUR 1ST POUR -END OR "GREASE" INTERMEDIATE ANCHOR PLASTIC CAP TO CAP W/ GASKET -PROTECTION ALLOW STRAND PASS THROUGH  $\stackrel{\bigstar}{=}$  ANCHOR ZONE REINF. SLEEVE 2-#4 MIN., BY P.T. -GROMMET ¬SPLIT PLASTIC SYSTEM MFR., TYP. GOMMET SHEATHING-(POCKET FORMER) **TENDON** UNSHEATHED GREASED -SEALING - ANCHORS TYP., SUPP'T. REBAR-STRAND WITHIN GASKET SLEEVE U.N.O. PROTECTION SLEEVE-SUPP'T. CHAIRS-SHEATH/SLEEVE OVERLAP, MIN. STRESSING END INTERMEDIATE **DEAD END** ANCHOR \_\_\_ANCHOR ANCHOR

VINIFORMLY SPACED TENDONS IN CORROSIVE ENVIRONMENT S301 SCALE: N.T.S.

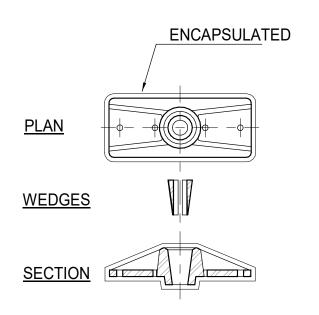


TYP. MONOSTRAND 3 ANCHOR CASTING S301 / SCALE: N.T.S.

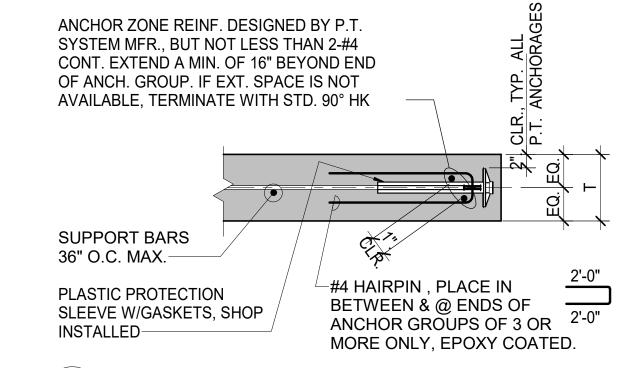

4 TYP. DEAD END ANCHOR DETAIL S301 SCALE: N.T.S.


1 FULLY ENCAPSULATED POST-TENSIONING SYSTEM COMPONENTS S301 SCALE: N.T.S.

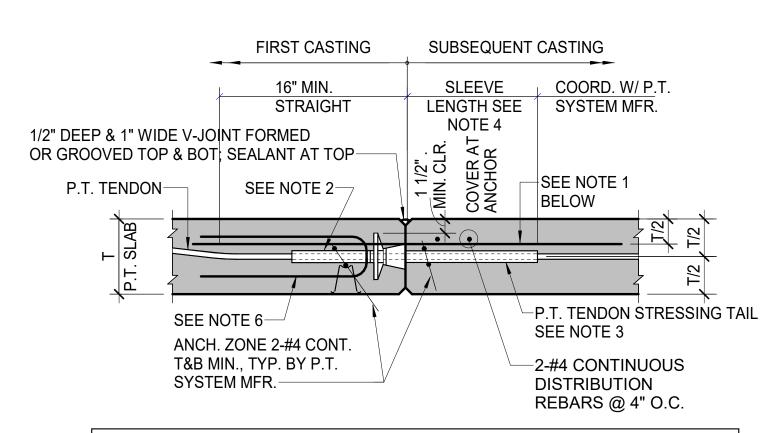


NOTES: . PLACE #4 x 4'-0" LONG REINF. BAR @ 2'-0" O.C. THROUGH CONSTR. JOINT LEVEL WITH PT TENDONS, CENTERED ON JOINT.

- APPLY ADDITIONAL PT GREASE THEN SLIDE AND SEAL PROTECTIVE SLEEVE OVER EXPOSED STRAND PRIOR TO CONCRETING. AFTER CONCRETE PLACEMENT, JUST EXPOSED STRAND PRIOR TO CONCRETING. AFTER CONCRETE PLACEMENT
- 3. APPLY PT GREASE INSIDE SLEEVE THEN SLIDE AND SEAL PROTECTIVE SLEEVE OVER EXPOSED STRAND AFTER STRESSING.
- SLEEVE LENGTH = ELONGATION AT INTERMEDIATE STRESSING END PLUS 12" MIN.
- 5. IF SUBSEQUENT POUR IS DELAYED MORE THAN 14 DAYS, CONSULT ARCHITECT FOR ADDITIONAL REBAR REQUIREMENTS.
- FOR #4 HAIRPINS, SEE DETAIL 4 & 6 THIS SHEET.


#### CONSTRUCTION JOINT WITH INTERMEDIATE STRESSING S301 SCALE: N.T.S.

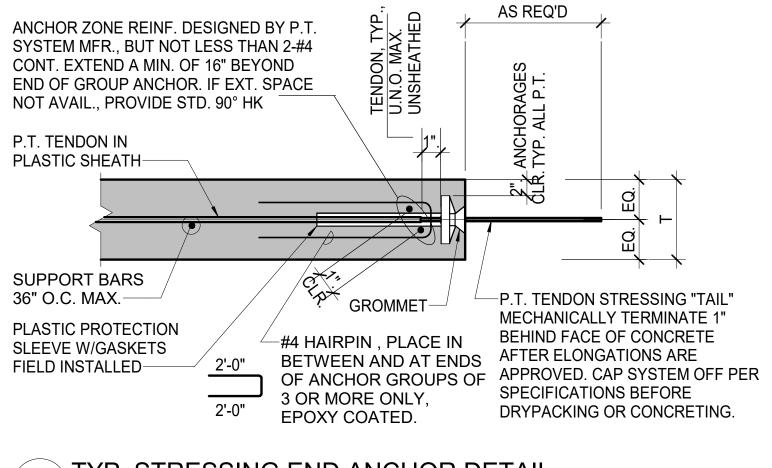


6 TYP. STRESSING END ANCHOR DETAIL S301 SCALE: N.T.S.

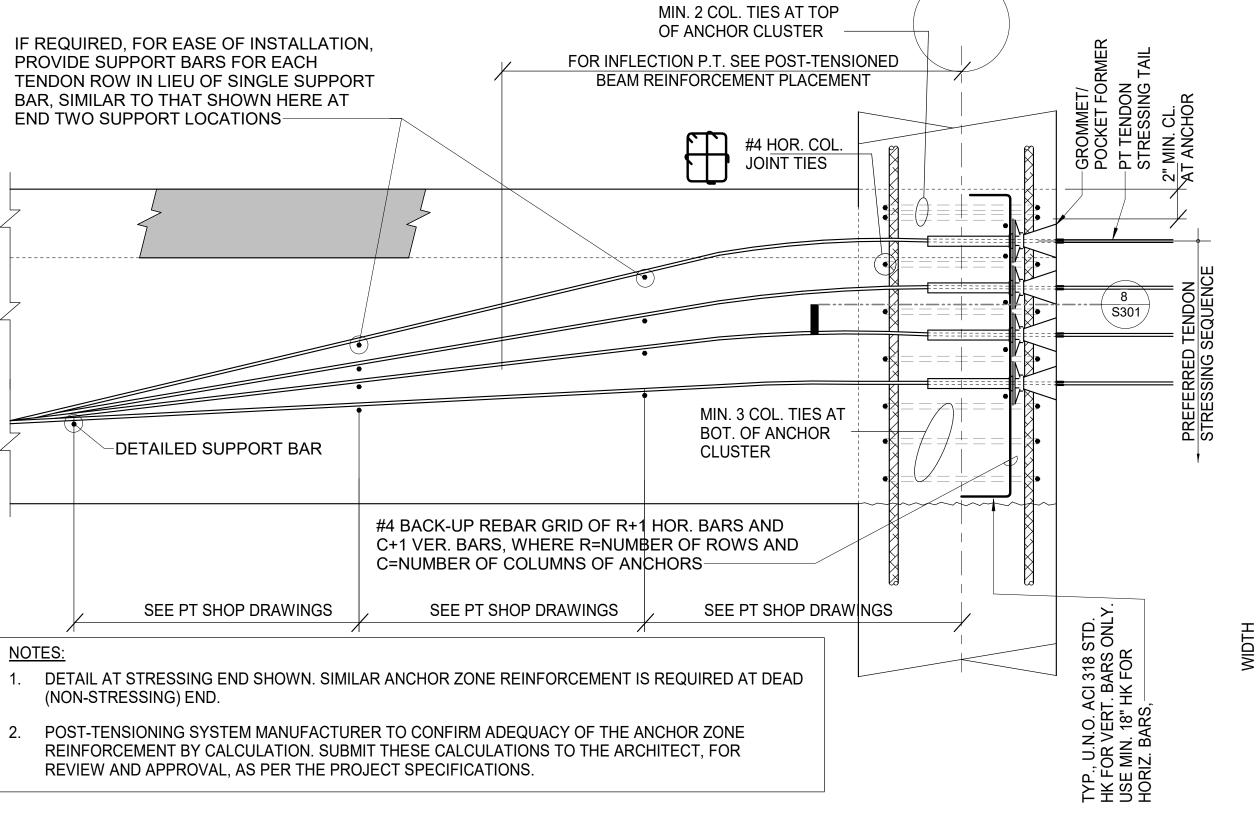


7 ANCHORAGE ZONE REINFORCEMENT IN BEAMS S301 SCALE: N.T.S.

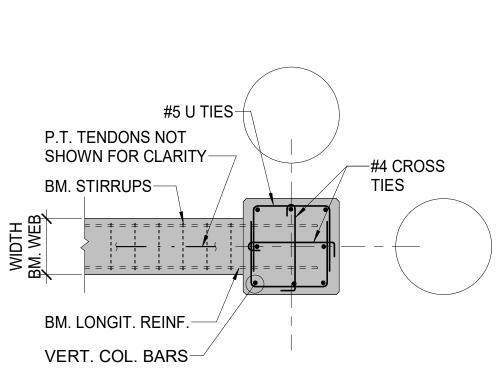


8 PLAN/SECTION AT BM.-COL. JT ALTERNATE JOINT TIE DETAIL

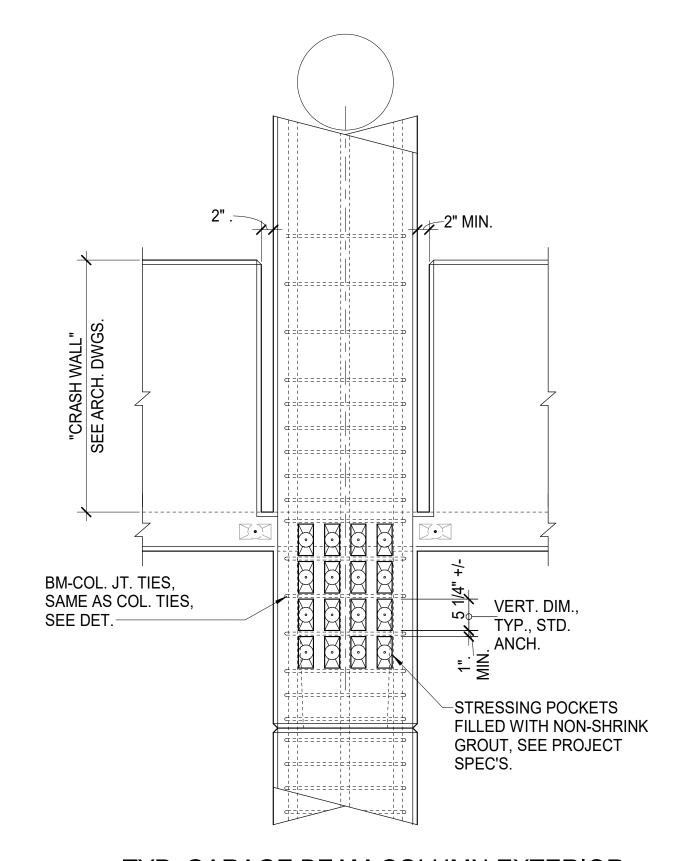


TYP. GARAGE BEAM-COLUMN EXTERIOR 9 JOINT S301 SCALE: N.T.S.

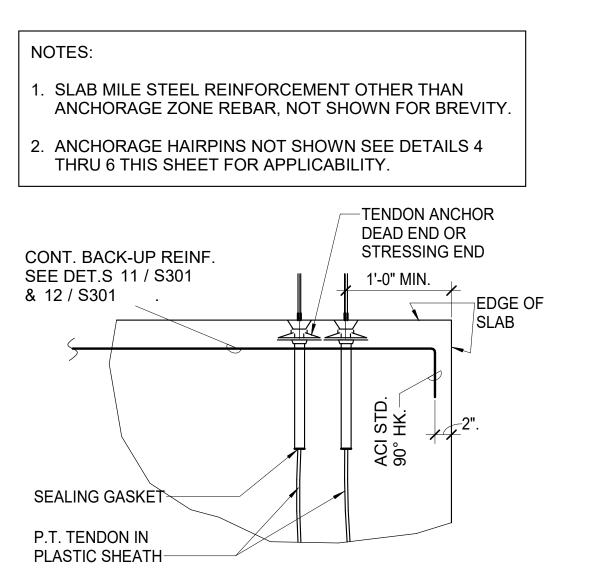




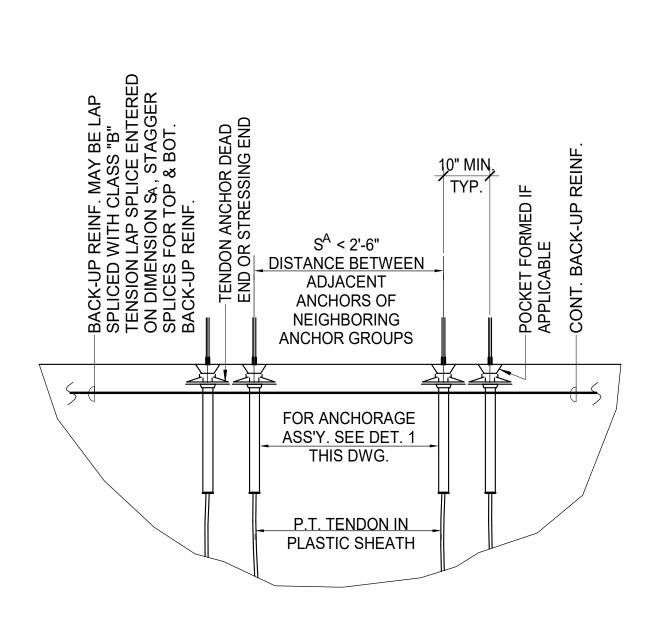

TYP. P.T. SLAB ANCHORAGE PLAN DETAIL WITH 11 CLOSE SPACING OF ANCHORS S301 SCALE: N.T.S.

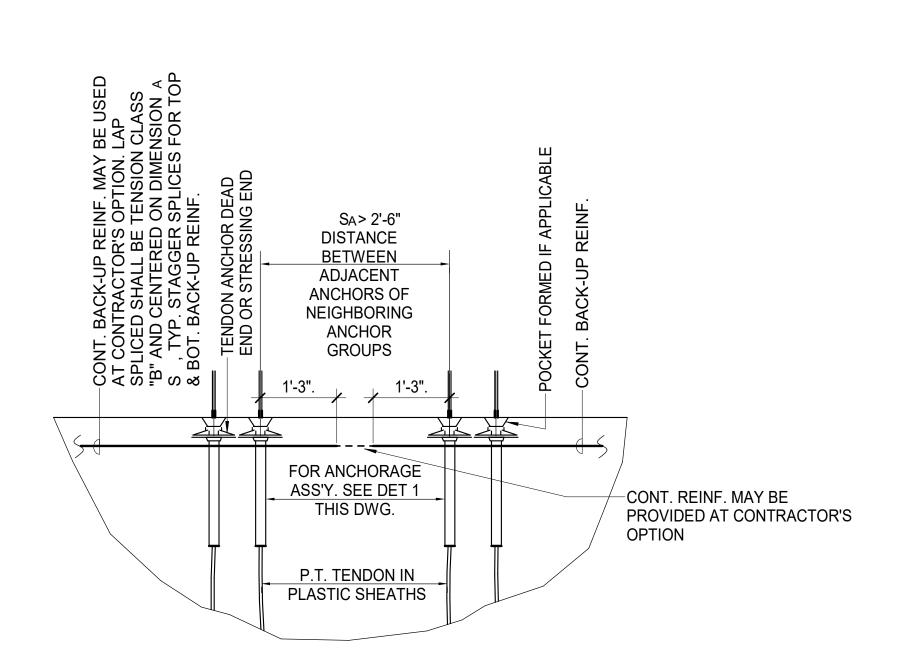

TYP. P.T. SLAB ANCHORAGE PLAN DETAIL WITH 12 WIDE SPACING OF ANCHORS S301 SCALE: N.T.S.

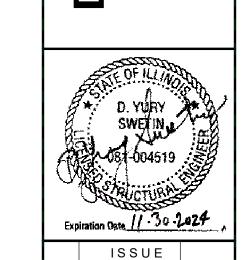

NO. DESCRIPTION DATE DRAWING TITLE:

POST-TENSIONING FRAMING **DETAILS** 

DRAWING NO: **S301** 

SCALE: As indicated DATE: ISSUED FOR PERMIT 06-10-2 PROJECT NO: 50-24102 RWN. CHK'D.


L, SEE PLAN

-4"x4"MAX. SLEEVE,

2" GAP **BETWEEN TENDONS** 


AT TENDON GROUP IN-PLAN TURNS FROM THE MAIN SPAN DIRECTION SUCH THAT A TANGENT TO THIS DIRECTION IS GREATER THE 1:12, MAINTAIN A MINIMUM REQUIRED CLEAR GAP AT A LINE BI-SECTING THE OBTUSE ANGLE FORMED BY THAT TANGENT



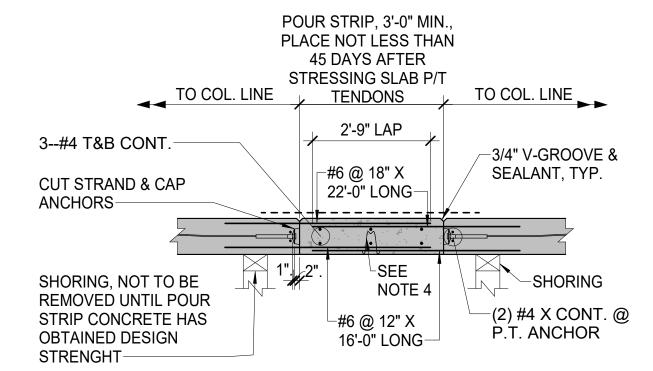

3. EPOXY COAT ALL REBAR.

5. PROVIDE CONTINUOUS STRIP OF TRAFFIC TOPPING, EXTENDING A MINIMUM OF 3'-0" BEYOND EACH SIDE OF SLAB OPENING. 19 POUR STRIP TYPICAL SECTION S302 SCALE: N.T.S.

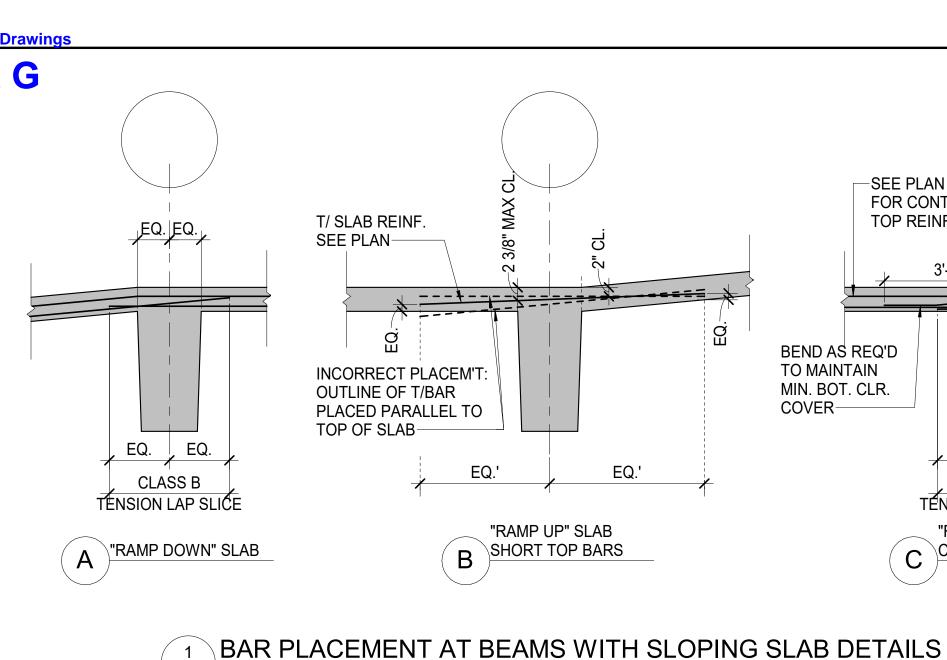

€ BM. & COL. U.N.O.

SCHEDULE GIRDER

-SCHEDULE GIRDER

TOP REINF.

TOP REINF.

-GIRDER P.T

**TENDONS** 

-C.I.P. CONC.

**COLUMN BELOW** 

1 1/2" CLR.

CRASH WALL—

S302 SCALE: N.T.S.

CLASS B

TEN LAP SPLICE

S302 SCALE: N.T.S.

6 SECTION AT TYPICAL GIRDER

-3/4" CHAMFER

-#5 HAIRPIN

**FOLLOW SLOPE** 

1. CRASH WALL SHALL NOT BE POURED MONOLITHICALLY WITH FLOOR SLAB

3. FOR ADDITIONAL REINFORCING, SEE NOTES ON THE FRAMING PLAN.

2. PROVIDE CONTINUOUS SEALANT ALONG ALL SLAB TO CRASH WALL JOINTS.

4. PROVIDE 2" GAP MIN. BETWEEN ENDS OF CRASH WALL & ADJACENT COLUMNS

-SLAB TEMP.

TENDON

OF WASH ON ARCH. DWG'S

TYP., U.N.O.

-#4@12<sub>.</sub>

3'-0" WASH

WHERE SHOWN

10 TYPICAL CRASH WALL REINFORCEMENT

ANCHORAGES-

#4 @ 24" TOP & BOTTOM TIED TO


**THROUGH** 

DEAD END ANCHORAGES

STAGGERED AND PLACED

HORIZONTAL IN SLAB-


**TENDON** 

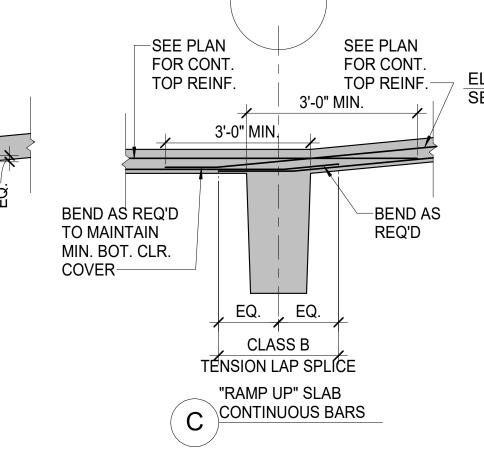

**GIRDER TOP** 


MILD STL.


REINF.

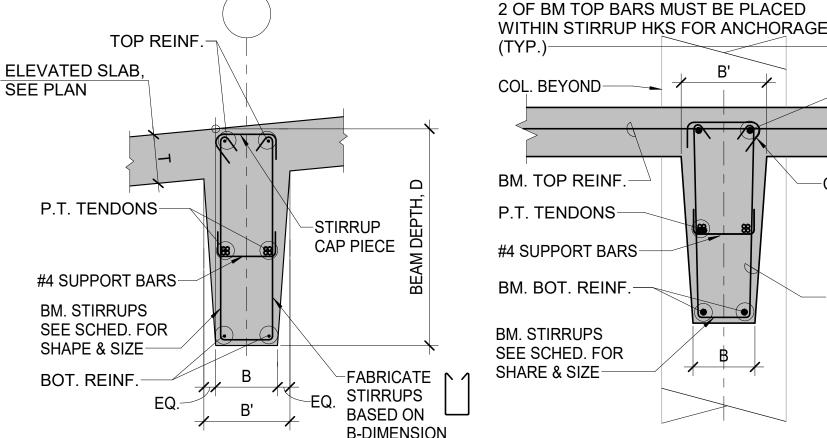

**BEAM P.T** 

**TENDONS** 

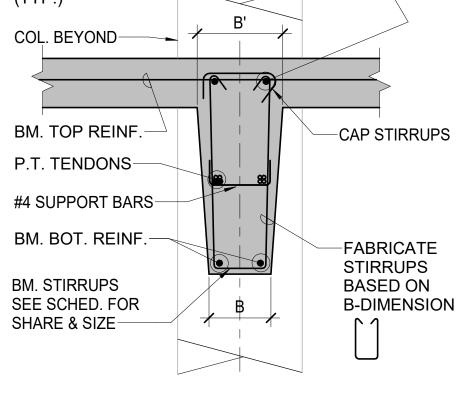

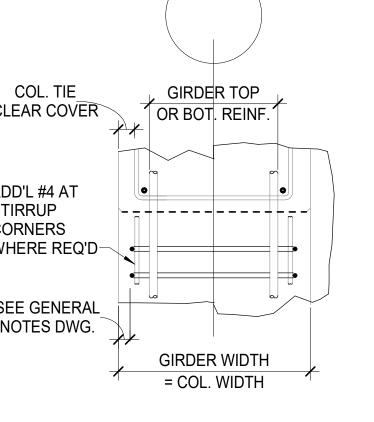



BEAM TENDONS & TENDON

SUPP'T REINF. NOT SHOWN

IF BEAM IS NOT POURED

SEALANT ALONG SLAB TO

UPTURNED BEAM JOINT.

SLAB TOP REINF. HOOK INTO

**UPTURNED BEAM-**

SLAB BOT. REINF

DRAPE OVER BM.

S302 SCALE: N.T.S.


BOT. BARS-

**TENDONS** 

PROVIDE CONTINUOUS

MONOLITHICALLY WITH SLAB,

FOR CLARITY

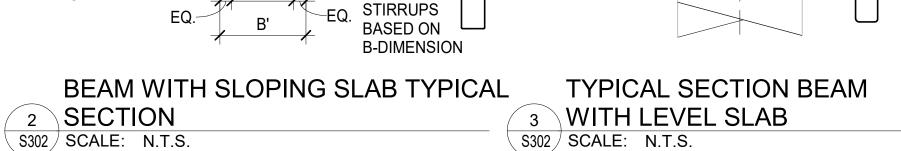

N.T.S.



**TERMINATE COL** 

AT ROOF LEVEL

PER ARCH DWG-

T/CONC. AT

SECTION DETAIL

S302 SCALE: N.T.S.

NOTE:

SEE BM SCHED

THAN 24 HOURS FOLLOWING RÉSPECTIVE SLAB POUR

CONSTRUCTION JOINT BETWEEN TOP OF SLAB AND WEB AT THE

UPTURNED BEAM MAY BE USED AT CONTRACTOR'S OPTION PROVIDED


COMPLETED AND APPROVED (2) WEB CONCRETE IS PLACED NO LATER

TYPICAL UPTURNED BEAM REINFORCEMENT

1) SLAB IS SHORED UNTIL STRESSING OF THE UPTURNED BEAM IS

H.P., SEE ARCH. DWG'S-


AT T/COL. EL.

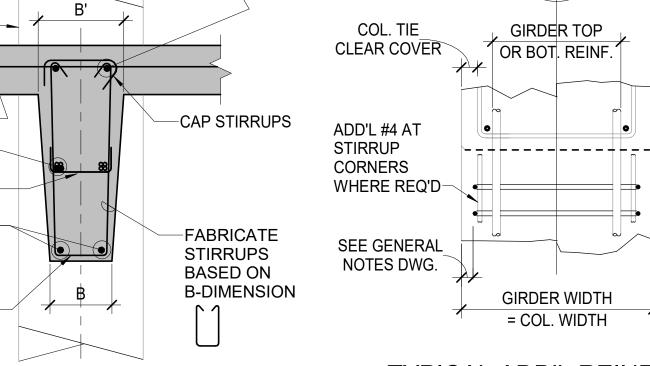


PROVIDE 1/2" MAX.

SLOPE PER ARCH.




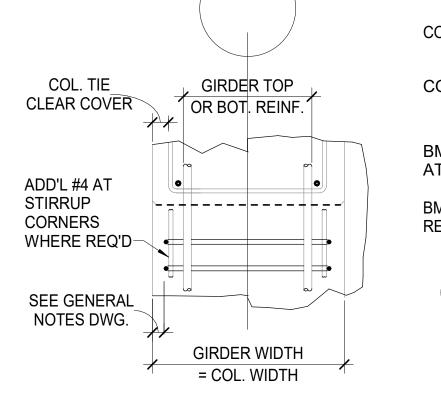

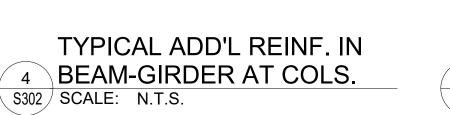

SEÉ BM SCHED

PLAN DETAIL

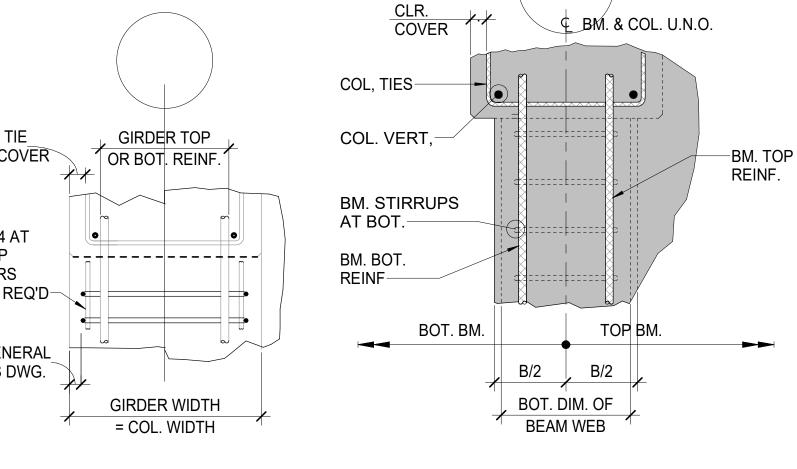



CONT. "DRIP",

TYPICAL UPTURNED BEAM

3'-0" T

& B TYP.

36".

1. ALL OPENINGS LARGER THAN 12"

SHALL BE TRIMMED AS SHOWN

REBAR SHOWN ON PLANS

3. THESE REQ'S. ARE MINIMUM


**UNLESS SHOWN OTHERWISE** 

2. THESE BARS ARE IN ADDITION TO

ELSEWHERE IN THESE DOCUMENTS

9 REINFORCEMENT DETAIL


SEE ARCH. DWG'S

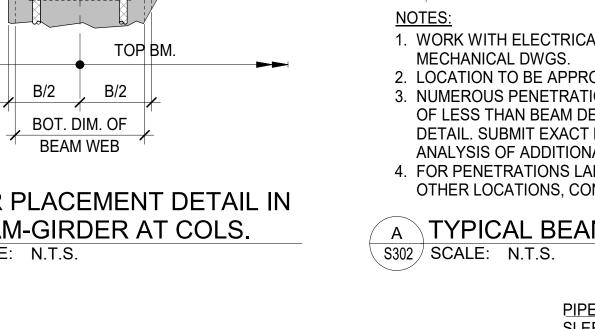

−NOM. 3-#4


B. NUMEROUS SMALL PENETRATIONS SPACED WITH CLEAR DISTANCES LESS THAN SLEEVE DIAMETER OR 6", NHICHEVER IS GREATER, SHALL BE TREATED AS SINGLE PENETRATION DEFINED BY TANGENT LINES DRAWN ON THE EXTERIOR OF ADJACENT SLEEVES.



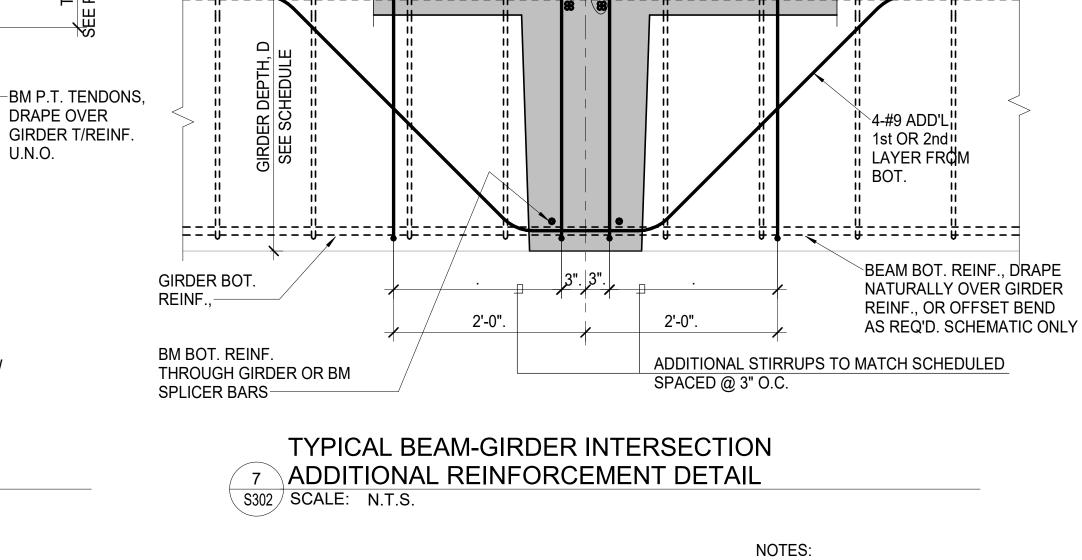

**BEAM TOP MILD** 

STL. REINF.-

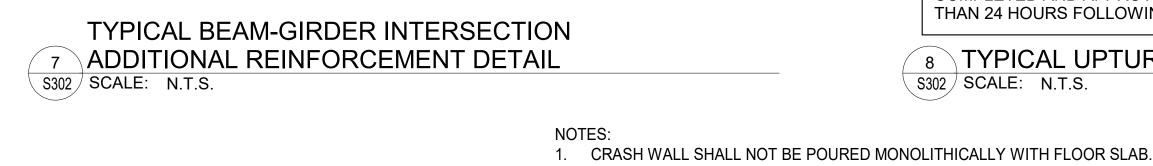

-#5 HAIRPINS

-CRASH WALL

REINF. (TYP.)


P.T. SLAB-


11 FOR CRASH WALL


MANUFACTURER.

S302 SCALE: N.T.S.


REINFORCEMENT IN SLAB

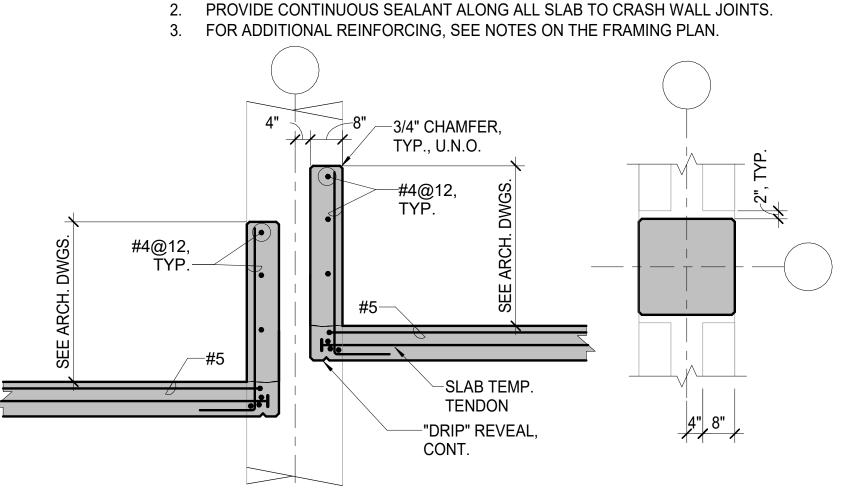

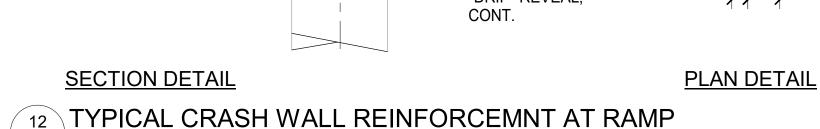


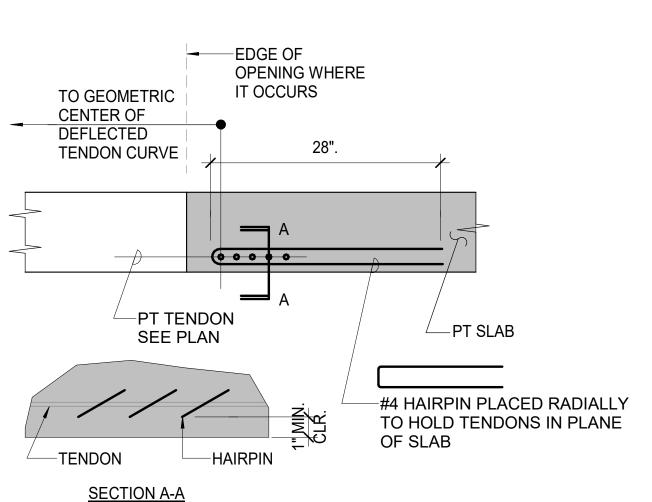



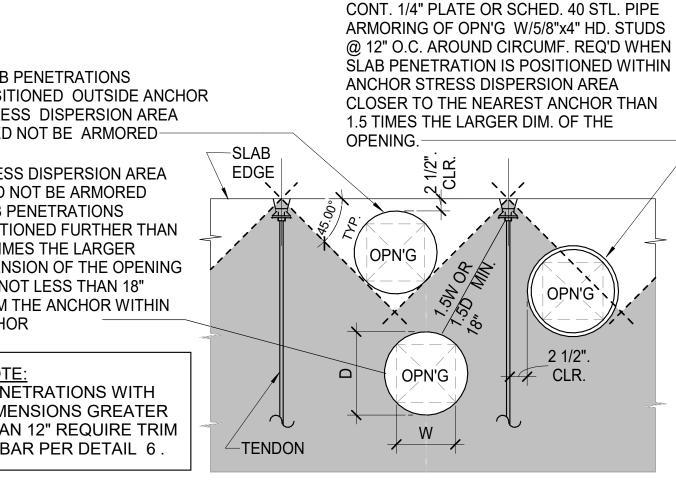

NCHOR		+	\\\\\\\\\\\\\\\\\\\\\\\\\\\\\\\\\\\\\\	**************************************	0.4/01	
NOTE: PENETRATIONS WITH DIMENSIONS GREATER THAN 12" REQUIRE TRIM REBAR PER DETAIL 6.	TEND	) ON	OPN'G W		_2 1/2". CLR.	

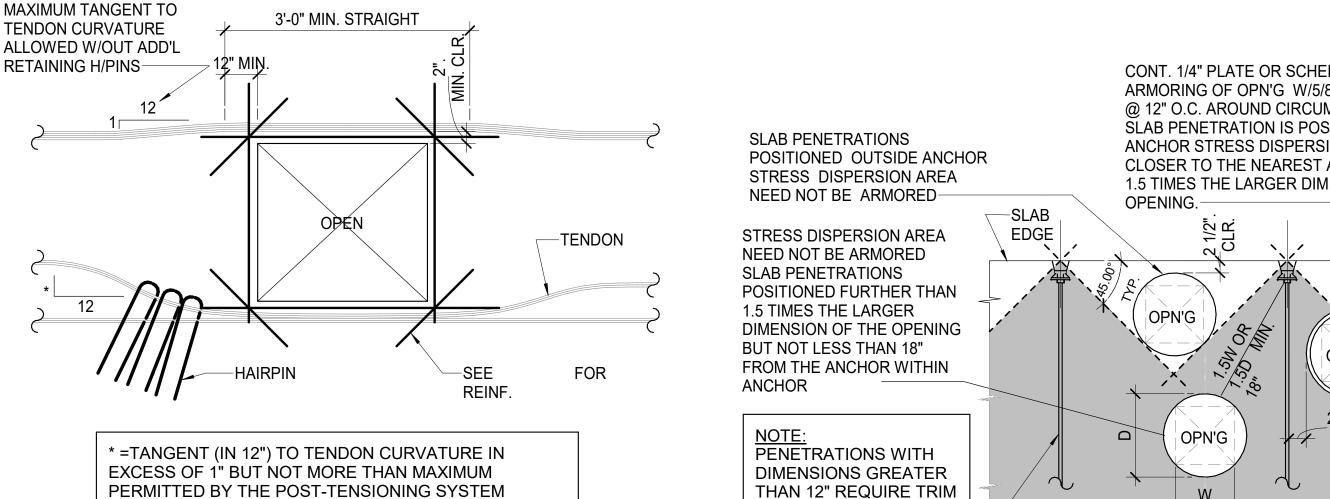

S302 SCALE: N.T.S.

16 PLAN AT TYPICAL HAIRPIN AT TENDON TURNS 17 OPENINGS AT P.T. ANCHORAGE S302 SCALE: N.T.S.

18 TRIM BARS FOR OPENINGS AT SLAB EDGE S302 SCALE: N.T.S.

1 #5 T & B, EA. SIDE

2 #5 T & B, EA. SIDE

1. AT POUR STRIP, USE STRUCTURAL FIBER REINFORCED CONCRETE, SEE SPECS. 2. AT TOP OF POUR STRIP, PROVIDE 3/4" DEEP TOOLED JOINTS, FILLED WITH SEALANT. IN TRANSVERSE DIRECTION AT 4'-0" O.C.

4. TOP AND BOTTOM BARS IN POUR STRIP TO BE CHAIRED DURING PLACEMENT.

**DETAILS** DRAWING NO: **S302** 

Ш

D. YURY SWETIN

ISSUE

NO. DESCRIPTION DATE **DRAWING TITLE: POST-TENSIONING FRAMING** 

SCALE: As indicated DATE: ISSUED FOR ROJECT NO: 50-24102 RWN. CM

**SECTION** 

S302 SCALE: N.T.S.

**SUPPORT** BARS-

<u>PLAN</u>

S302 SCALE: N.T.S.

15 PLACEMENT OF ADDED TENDON

S302 SCALE: N.T.S.

HORIZONTAL

CHAIRS @ 3'-0" O.C. MAX.

MAX. DIMENSION

12" TO 18"

18" TO 2'-6"

2'-6" & LARGER

SLAB EDGE

REINFORCING

1 #5 EA. SIDE

SLAB SPAN Le

NOTE: SHADED AREAS SHOWN ON PLANS

SLAB SPAN Le

**IDENTIFY LOCATIONS REQUIRING** CONTINUOUS REINFORCEMENT.

THIS DWG.

(D

D. YURY SWETIN 722-081-004519


NO. DESCRIPTION DATE DRAWING TITLE: POST-TENSIONING

ISSUE

**FRAMING DETAILS** DRAWING NO:

**S303** 

SCALE: As indicated DATE: ISSUED FOR PROJECT NO: 50-24102 RWN. СМ

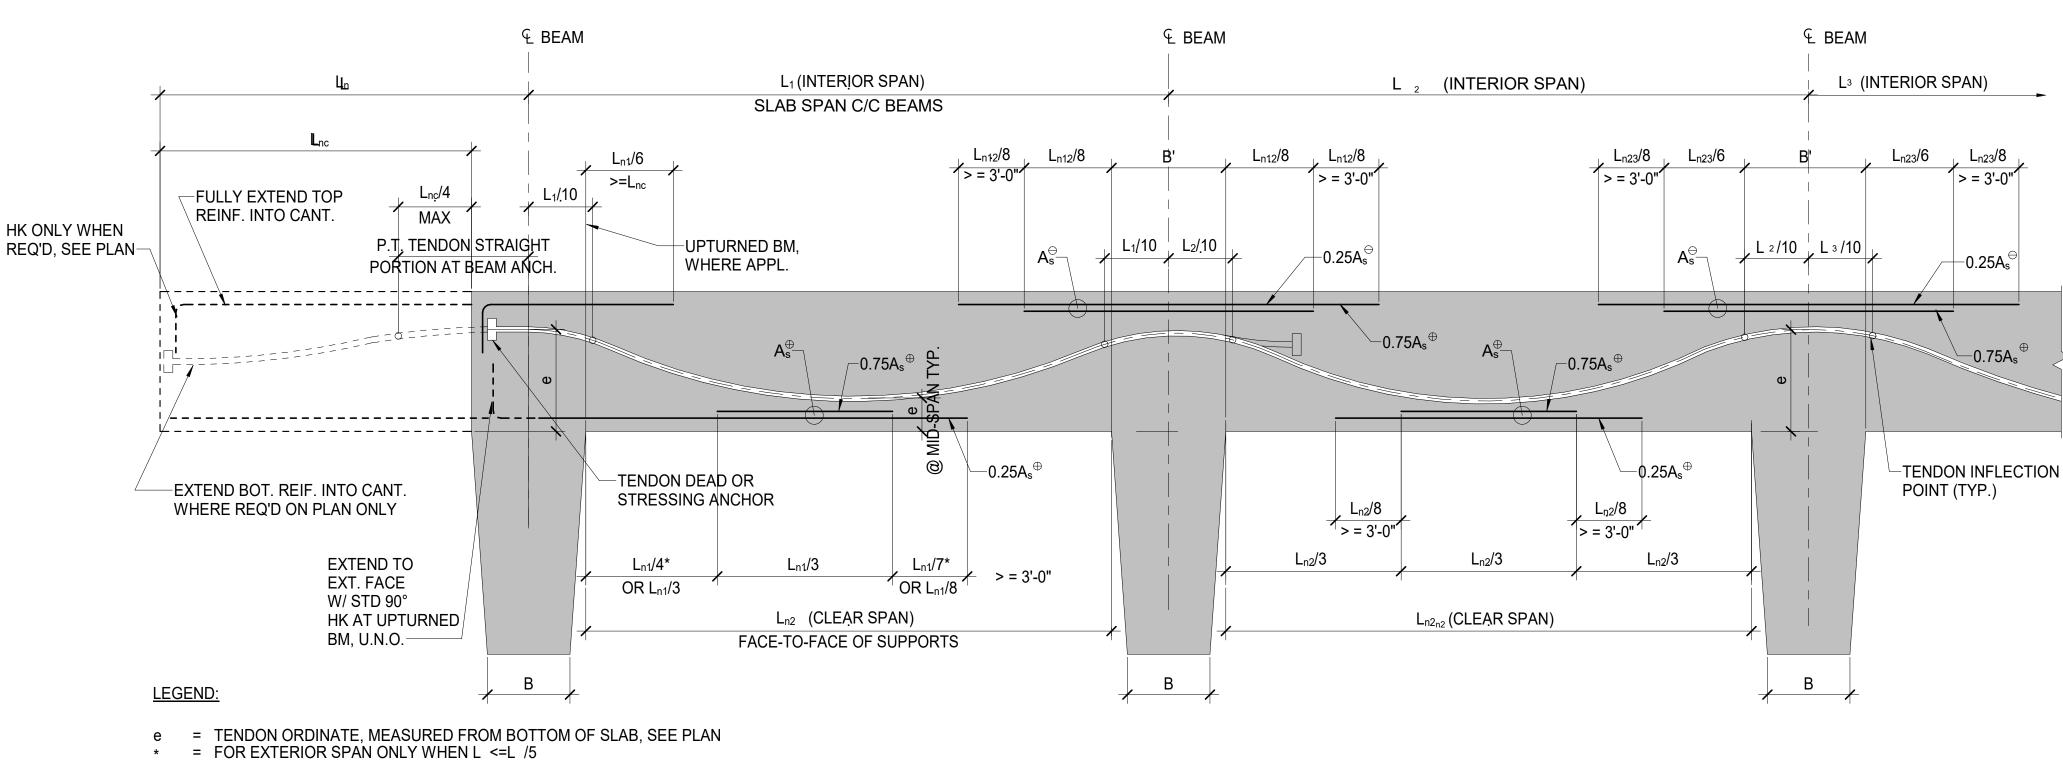

 $L_{n12}$  = LARGER OF  $L_{n1}$  &  $L_{n2}$ 


 $L_{n23}$  = LARGER OF  $L_{n2}$  &  $L_{n3}$ 

A<sub>s</sub> = POSITIVE (BOTTOM) REINFORCEMENT, SEE PLAN  $A_s^{\ominus}$  = NEGATIVE (TOP) REINFORCEMENT, SEE PLAN

FOR LEGEND SEE DETAIL 1 ABOVE

S303 SCALE: N.T.S.

SHORT BAR BETWEEN CONT. BARS PLACEMENT DIAGRAM (U.N.O.) 1 POST-TENSIONED ONE-WAY SLAB TENDON & MILD REINF.

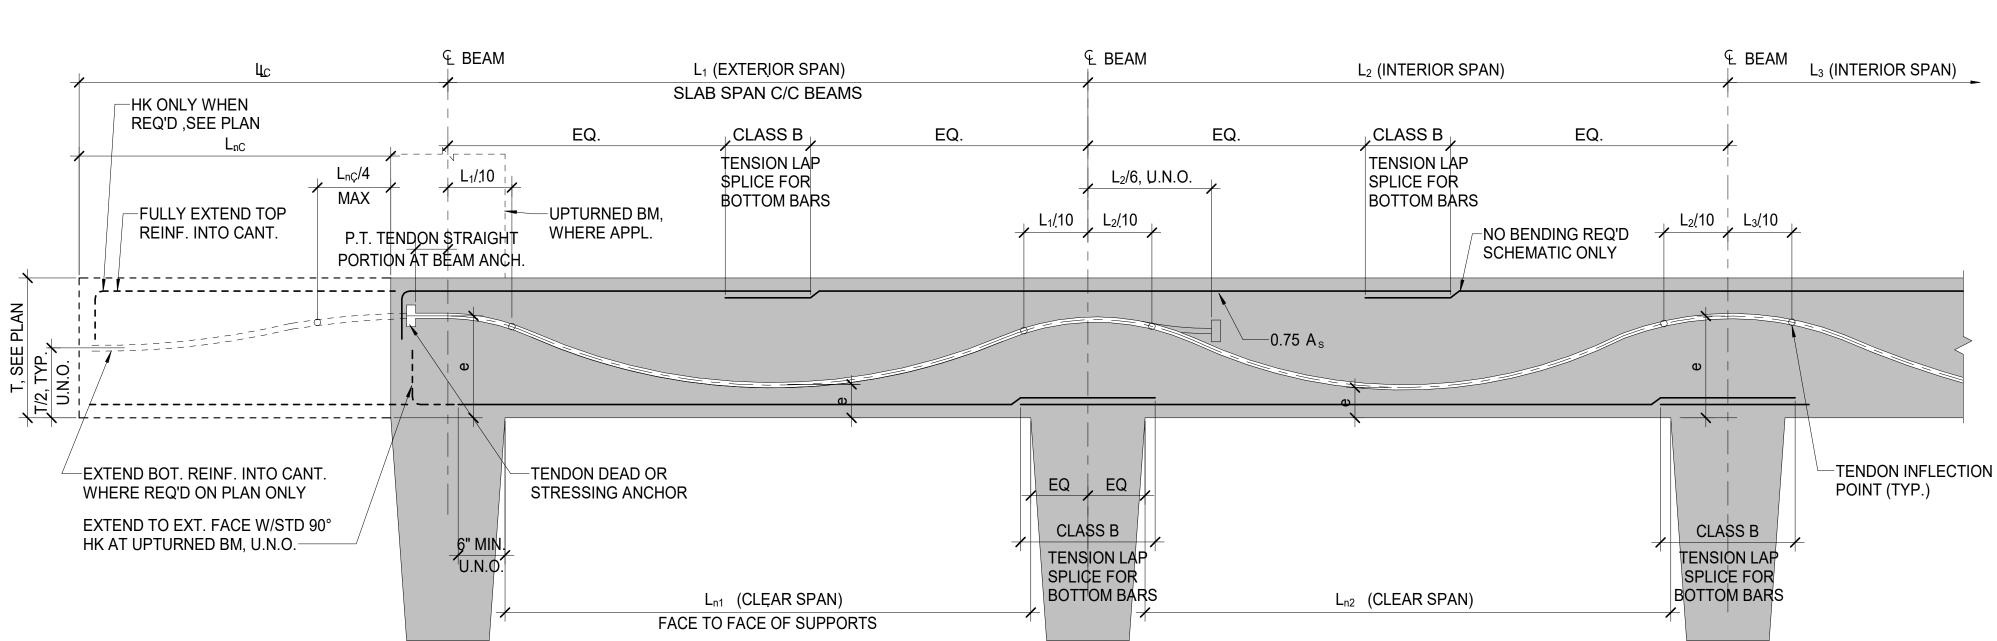

LONG (CONTINUOS) BAR PLACEMENT DIAGRAM (U.N.O.) POST-TENSIONED ONE-WAY SLAB TENDON & MILD REINF.

S303 SCALE: N.T.S.

TEMP. TENDONS, PLACE ON TOP OF MAIN TENDONS, CHIAR FOR INDIV. TENDON OR TEMP. TENDONS, PLACE ON TOP OF MAIN TENDONS, TYP. TYP. UNIFORMLY DISTORT. WITHIN BUNDLE TO PROVIDE REQ'D PROFILE-UNIFORMLY DOSTR. WITHIN AREAS DESIGNATED ON PLAN AREAS DESIGNATED ON PLAN <sup>Q</sup>BEAM <sup>Q</sup>BEAM SEE PLAN SEE PLAN SEE PLAN SEE PLAN STABILIZER BAR SLAB TOP REINF FOR TYPE OF BM STIRRUPS -SLAB TOP REINF. SEE MB SCHEDULE STANDARD THK-SPACE\SUPPT'S / SPACE SUPPT'S @ 3'-0" MAX O.C./ @ 3'-0" MAX O.C. **CONTRACTOR NOTE:** -SUPPORT BAR & BAR CHAIR, AS REQ'D SUPPORTS FOR P.T. TENDONS AND -SLAB BOLSTER FOR MILD MILD REINFORCEMENT MUST BE REINFORCEM'T. FOR TENDON SLAB BOLSTER FOR MILD COORDINATED SUCH THAT NO ORDINATES ABOVE REINFORCEM'T & TENDONS. INTERFERENCE EXISTS BETWEEN FOT TENDON ORDINATES ABOVE THE TWO, AND CLEAR COVER AND SPACER BAR ON T/BOT MILD MILD STL. REINF. PLACE SPACER TENDON PROFILE ARE NOT REINF. PLACE TO PROVIDE BARS AS REQ'D. COMPROMISED. ANY DEVIATION REQ'D TENDON PROFILE REQUIRED FOR FIT UP MUST BE APPROVED BY THE ENGINEER.

S303 SCALE: N.T.S. **COLUMN FOR COLUMN FOR** COLUMN FOR SUPP'T SUPP'T SUPP'T L<sub>C</sub>, SEE PLAN L<sub>1</sub>, SEE PLAN L2, (SEE PLAN) CANTILEVER, WHERE APPL  $L_2/2$ L<sub>1</sub>/2 L<sub>1</sub>/2  $L_2/2$ /5, BUT NOT LESS THAN L FOR CANTILEVER BACKSPAN LARGER OF LARGER OF -DEAD END ANCHORS FOR ADDITIONAL EXTERIOR L<sub>1</sub>/5 & L<sub>2</sub>/5 L<sub>1</sub>/5 & L<sub>2</sub>/5  $L_{\rm C}/10$   $L_{\rm 1}/20$ SPAN TENDONS, WHERE TENDON PROFILE L<sub>1</sub>/20 | L<sub>2</sub>/20 | | L/2/**20** | L/3/**20** APPL., SEE NOTE 4 BELOW INFLECTION POINTS −2\_ #6X12'-0" +HK @ 12" EA. #4 BACK-UP REBAR FACE EXTERIOR SPAN -SEE BARS CONT., SEE GRID, SEE SEC. 8/S-005--EXTEND SIDE, T&B SCHED. SPLICE W/CLASS B ONLY, EXTERIOR SUPP'I REINF. FROM ADJ. TENSION LAP AT MID-SPAN \SPAN, U.N.O. LOCATE ANCHORS WITH SIDE BARS ONLY **CLEAR DISTANCE OF 6"** TO SIDE OF BEAM-<del>|</del>}-|-|++----ADD'L H/PINS 2 PER EACH ROW OF ANCHORS PLACED AT CANT. BEAM SIDES-HK ONLY WHEN REQ'D BY BM. SCHED. 4-#4 ADD'L 🖸 NOTE 2 EQ EQ STIRRUPS @3" O.C.-4" MAX. 2xD 2xD STIRRUPS @ 12" O.C., U.N.O. FOR 2xD SIZE & SHAPE SEE SCHEDULE STIRRUPS. SEE SCHEDULE STIRRUPS, SEE SCHEDULE SPAN, FACE-TO-FACE OF SUPPORTS (TYP.) SPAN, FACE-TO-FACE OF SUPPORTS (TYP.)

SLAB SPAN Li

· - <del>- - - - - - - - -</del> - -

\_\_\_\_

\_\_\_\_

\_\_\_\_

SLAB SPAN Li

S303 SCALE: N.T.S.

Li /2

SLAB SPAN Li

\_\_\_\_

SLAB SPAN Li

U.N.O.

SHADED AREAS SHOWN ON PLANS IDENTIFY

LOCATIONS REQUIRING CONTINUOUS REINFORCEMENT

Li /2

CLASS B TENSION

LAP SPLICE

Li/2

0", U.N.O

SEE PLAN

4 TYP. SLAB BOTTOM BAR ARRANGEMENT PLAN VIEW

0", U.N.O. SEE PLAN

5 TYP. SLAB TOP BAR ARRANGEMENT PLAN VIEW

NOTES:

1. AT LOCATIONS REFERRED TO THIS NOTE, PROVIDE ACI 318 CLASS B TENSION LAP SPLICE BASED ON SMALLER DIAMETER OF BARS BEING SPLICES, SEE DWG S-001. 2. FOR INTERMEDIATE AND SPECIAL MOMENT FRAMES ONLY, AS DEFINED IN THE DESIGN CRITERIA FOR THE PROJECT ON DRAWING S001. WITHIN SPACE INDICATED PROVIDE HOOPS OF SIZE AND SPACING PER BEAM SCHEDULE. CLOSED STIRRUPS CONSISTING OF ACI STANDARD TYPE S3 U-STIRRUP CAPPED WITH TYPE T9 TIES AND ALTERNATING 135°

AND 90° SEISMIC HOOKS SHALL BE PERMITTED SCHEDULE ONLY ONCE, FROM EITHER SIDE UNLESS ADDITIONAL BARS ARE TO BE INSTALLED AND PROPERLY DEVELOPED BEYOND RESPECTIVE FACE OF SUPPORT.

3. WHEN TOP OR BOTTOM BARS EXTEND THROUGH JOINT, THEY ARE CALLED OUT ON THE 4. WHERE REQUIRED BY SCHEDULE, PROVIDE ADDITIONAL EXTERIOR SPAN TENDONS ANCHORED AT L /6 OF THE ADJACENT SPAN NEAREST COMMON SUPPORT. PLACE DEAD END ANCHORS AT C.G.S. OF THE TENDON GROUP PROFILE.

T<sub>R</sub> == TOP MIDDLE B<sub>R</sub> == BOTTOM RIGHT TENDON GROUP PROFILE LEGEND

MILD STEEL REINF. LEGEND

 $T_L = TOP LEFT$   $B_L = BOTTOM LEFT$ 

T<sub>M</sub> == TOP MIDDLE B<sub>M</sub> == BOTTOM MIDDLE

= TENDON PROFILE INFLECTION POINT \*\* TENDON PROFILE ORDINATE A, B, OR C, SCHEDULE (EACH END OF SPAN AND MID-SPAN)

A TENDON GROUP C.G.S. DIMENSION, SEE SCHEDULE (L<sub>N</sub>) SPAN FOR WHICH C.G.S. ORDINATE IS LISTED

6 POST-TENSIONED BEAM/GIRDER REINF. PLACEMENT S303 SCALE: N.T.S.

3 PLACEMENT DIAGRAM S303 SCALE: N.T.S.

### **Exhibit G**

		DIMEN	SIONS	SKETCH OF	NUMBER		TENDON PROFILE					REINFO	PRCEMENT				IORIZONTAL MILD S	TEEL BAR DIAGRAN	1
ИARK	WIDT	H (IN)	DEPTH (IN)	CROSS	OF 0.5" DIA		(INCHES)		TO	OP BARS	вот	TOM BARS	SIDE BARS EA. FACE			STIRRUPS	LEFT SUPPORT	RIGHT SUPPORT	REMARKS
	В	B'	D	SECTION	TENDONS	Α	В	С	TL	T <sub>M</sub> T <sub>R</sub>	BL	B <sub>M</sub> B <sub>R</sub>	U.N.O.	SIZE	TYPE	SPACING EA. END, U.N.O.	Q Q	SUFFORT P	
2PB1	15	15	52		5	24	21 1/2	48	2-#9	2-#5 2-#9	2-#6	2-#9 2-#6	3-#4	#4		1@2, 12@6, BAL@12		<del></del>	
2PB2	15	15	52		5	48	11	24	-	2-#5 2-#9	-	2-#9 2-#6	3-#4	#4		1@2, 12@6, BAL@12			
2PB3	18	18	37	5	13	27	4	33	3-#10	2-#5 3-#10	2-#6	2-#9 2-#6	-	#4		1@2, 12@6, BAL@12			
2PB4	16	18	37	5	13	33	4	27	-	2-#5 3-#10	-	2-#9 2-#6	-	#4		1@2, 12@6, BAL@12			
2PB5	16	18	37	5	13	27	4	33	3-#10	2-#5 3-#10	2-#6	2-#9 2-#6	-	#4		1@2, 12@6, BAL@12			
2PB6	16	18	37		13	33	4	27	-	2-#5 3-#10	-	2-#9 2-#6	-	#4		1@2, 12@6, BAL@12			
2PB7	16	18	37		18	25 5/8	4	25 5/8	3-#10	2-#5 3-#10	2-#6	2-#9 2-#6	-	#4		1@2, 12@6, BAL@12			
2PB8	16	18	37		16	26 1/2	4	33	3-#10	2-#5 3-#10	2-#6	2-#9 2-#6	-	#4		1@2, 12@6, BAL@12			
2PB9	16	18	37		16	33	4	26 1/2	-	2-#5 3-#10	-	2-#9 2-#6	-	#4		1@2, 12@6, BAL@12			
PB10	16	18	37	5	13	27	4	33	2-#10	2-#5 3-#10	2-#6	2-#10 2-#6	-	#4		1@2, 12@6, BAL@12			
PB11	16	18	37		13	33	4	27	-	2-#5 2-#10	-	2-#10 2-#6	-	#4		1@2, 12@6, BAL@12			
PB12	15	15	52		5	37	11	48	2-#9	2-#5 2-#9	2-#6	2-#9 2-#6	3-#4	#4		1@2, 12@6, BAL@12			
PB13	15	15	52		5	48	11	37	-	2-#5 2-#9	-	2-#9 2-#6	3-#4	#4		1@2, 12@6, BAL@12			
PB14	15	15	52		6	37	11	37	2-#9	2-#5 2-#9	2-#6	2-#9 2-#6	3-#4	#4		1@2, 12@6, BAL@12			
2PG1	24	24	37		32	22 1/2	4	22 1/2	3-#10	3-#10 3-#10	3-#10	3-#10 3-#10	-	#4		1@2, 12@6, BAL@12			FOR ADD'L GIRDER REINF. SEE TYPIC BEAM-GIRDER INTERSECTION DET.
PG2	22	22	37		12	21 1/4	4	21 1/4	2-#10	2-#10 2-#10	2-#9	2-#9 2-#9	_	#4		1@2, 12@6, BAL@12			FOR ADD'L GIRDER REINF. SEE TYPIC BEAM-GIRDER INTERSECTION DET.

### **DRAWING NOTES:**

1. REFER TO THE FOLLOWING TABLE FOR REFERENCE DRAWINGS:

ITEM	DRAWING NO.
GENERAL NOTES	, ,
P.T. BEAM AND SLAB TYPICAL DETAILS	
POST-TENSIONED BEAM SCHEDULE	THIS DWG.
GENERAL P.T. TYPICAL DETAILS	, ,
T/CONCRETE FLOOR ELEVATIONS	SEE ARCH. DWG'S
COLUMN SCHEDULE AND DETAILS	,

- 2. BEAM MARKS SHOWN IN PLAN HAVE BEEN PLACED AT RESPECTIVE BEAMS LEFT ENDS.
- 3. ANCHORAGES FOR ADDITIONAL TENDONS (SO NOTED ON DRAWINGS) SHALL BE LOCATED AT THE QUARTER POINT OF THE ADJACENT SPAN AND AT THE CENTER OF GRAVITY OF THE BEAM CROSS-SECTION. PROVIDE BACK-UP REINFORCEMENT AS REQ'D BY TYPICAL DETAILS.
- 4. TO ALLEVIATE CONGESTION AT INTERIOR BEAM AND COLUMN INTERSECTION, THE BEAM BOTTOM REINFORCEMENT MAY BE PLACED IN TWO LAYERS. TOP REINFORCEMENT MUST BE IN ONE LAYER UNLESS NOTED OTHERWISE. BEAM TOP LONGITUDINAL BARS MAY BE PLACED IN SLAB ON EITHER SIDE OF BEAM WEB WITHIN A DISTANCE OF 1.50 TIMES THE SLAB THICKNESS CLEAR, EITHER SIDE. HOWEVER, A MINIMUM OF TWO (2) BARS MUST BE PLACED WITHIN THE BEAM-COLUMN JOINT. EXTEND ALL TOP BARS INTO ADJOINING SLAB IF POSSIBLE.
- 5. FOR TYP. BEAM PENETRATIONS SEE DETAIL . THE CONTRACTOR SHALL COORDINATE EXACT LOCATION AND SIZE OF OPENING WITH OTHER DISCIPLINES REQUIRING PENETRATIONS AS SHOWN ON THE RESPECTIVE SUB-CONTRACTOR'S SHOP DRAWINGS. CONSULT THE ARCHITECT IF THE SIZE OF THE REQUIRED OPENING EXCEEDS THE LIMITS IN THE ABOVE DETAIL. SPECIAL DESIGN MODIFICATIONS MAY BE REQUIRED.
- 6. ALL P.T. TENDON AND MILD STEEL REBAR SHOP DRAWINGS MUST SHOW GRID DESIGNATION AND GRID DIMENSIONS IN ACCORDANCE WITH THE CONTRACT DOCUMENTS. FAILURE TO IDENTIFY GRIDS SHALL BE A CAUSE FOR DRAWING REJECTION.
- 7. P.T. DETAILS OF BEAM TENDON ANCHORAGES MUST BE COORDINATED WITH COLUMN SCHEDULE AND RESPECTIVE REBAR PATTERNS TO FACILITATE ANCHORAGE INSTALLATIONS.
- 8. DETAIL GIRDER SHEAR REINFORCEMENT BASED ON GIRDER SECTION VERTICAL DIMENSION PER SCHEDULE LESS ONE AND ONE-HALF INCH. GIRDERS ARE MARKED AS "PGXX" IN THE SCHEDULE.
- 9. ALL BEAM AND GIRDER TENDON GROUP PROFILES SHALL BE BASED ON SMOOTH PARABOLIC REVERSE CURVATURE CONFIGURATIONS WITH INFLECTION POINTS. ALSO SEE "POST-TENSIONED CONCRETE NOTES" ON GENERAL NOTES DRAWINGS.
- 10. FOR OPEN STIRRUPS IN THE SCHEDULE ABOVE (ACI STANDARD PATTERNS S1 THROUGH S9, AS SKETCHED IN THE SCHEDULE) PROVIDE SAME SIZE CAP PER ACI STANDARD BEND TYPE T9 PLACED OVER STIRRUPS WITHIN THE LENGTH EQUAL TWO TIMES THE DEPTH OF BEAM OR GIRDER FROM EACH END U.N.O. PLACE SAME CAP PIECES WITHIN THE REMAINING LENGTH OF CLEAR SPAN SPACED AT 48 INCHES ON CENTER, MAXIMUM. ADJACENT CAP PIECES SHALL BE SET WITH 135° HOOKS ALTERNATING PLACEMENT ON EACH SIDE OF BEAM OR GIRDER.



ING STRUCTURE

VILLAGE OF EAST DUNDEE

D. YURY
SWETIN
SWETIN
Expiration Oste // 30-224
ISSUE

NO. DESCRIPTION DATE

DRAWING TITLE:

POST-TENSIONED

BEAM


SCHEDULE

DRAWING NO:

SCALE: N.T.S.

DATE: ISSUED FOR
PERMIT 06-10-24
PROJECT NO: 50-24102

S. RWN. CHK'D. signer Author Checke

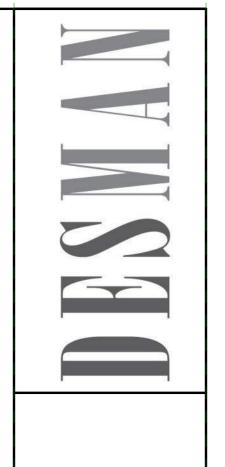




ISSUE

NO. DESCRIPTION DATE DRAWING TITLE:
SECTIONS AND
DETAILS

DRAWING NO:

SCALE: As indicated DATE: ISSUED FOR
PERMIT 06-10-24
PROJECT NO: 50-24102

**S401** 

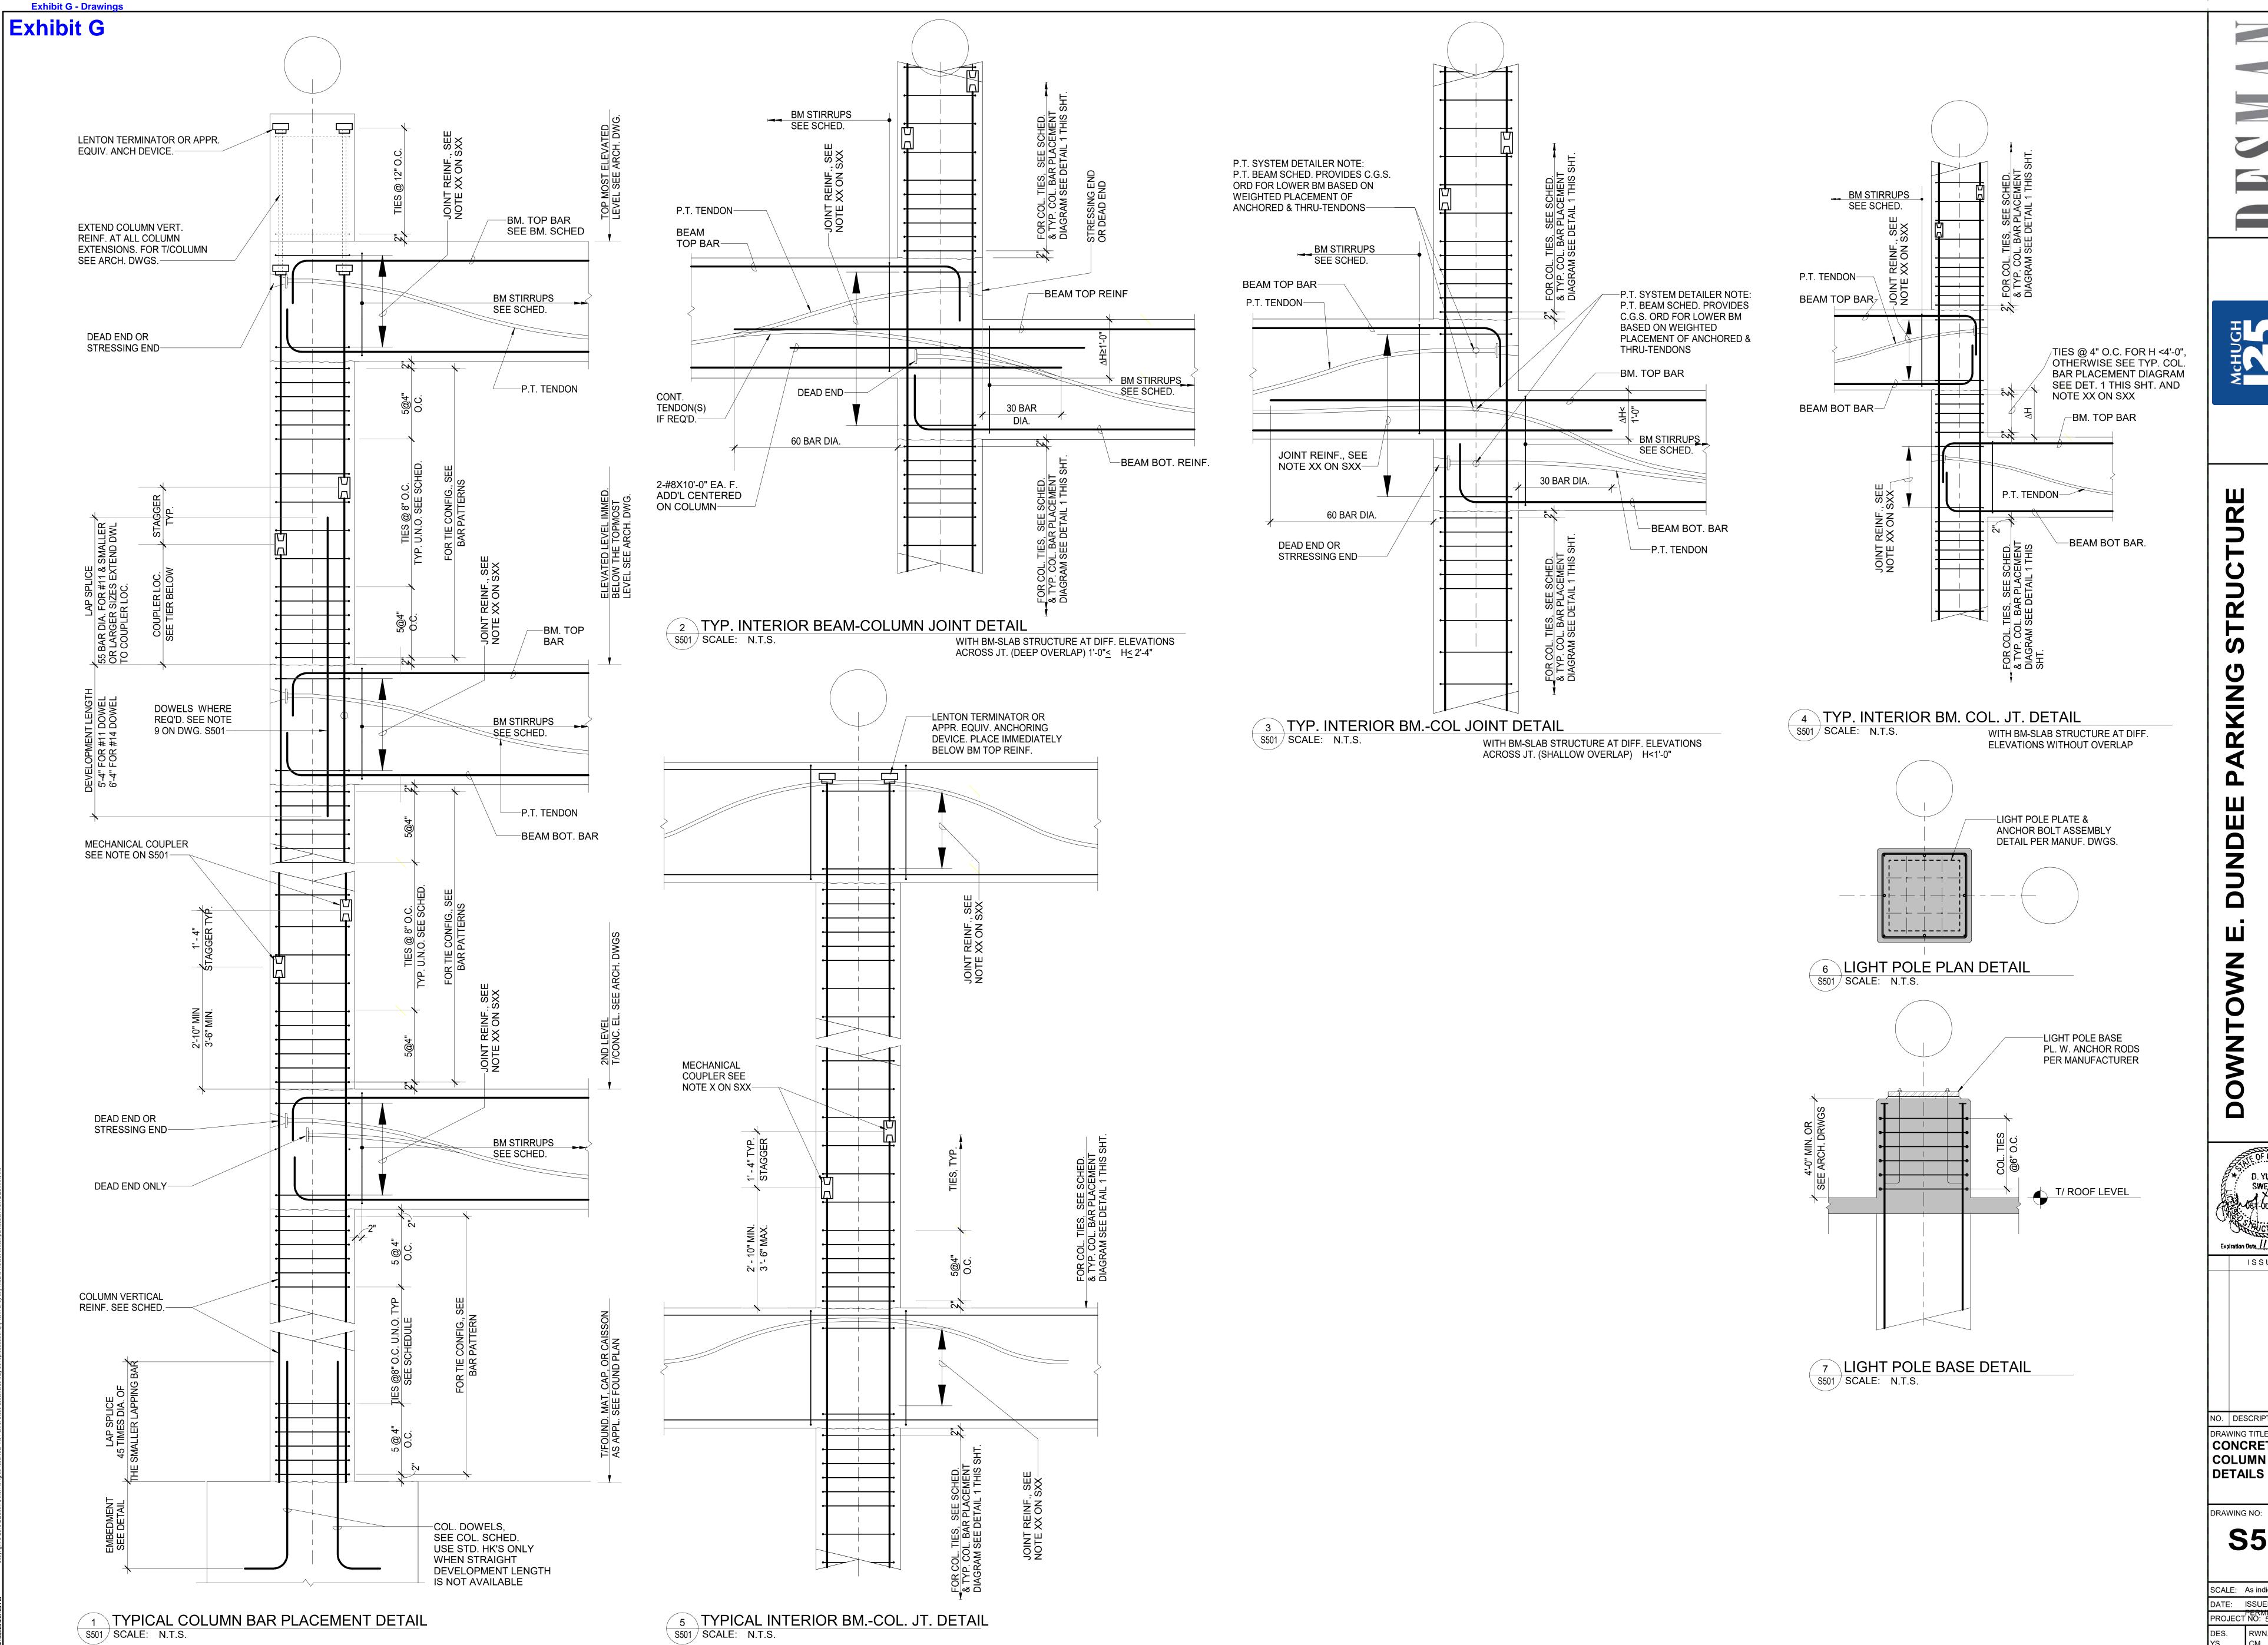



D. YURY SWETIN

ISSUE

NO. DESCRIPTION DATE DRAWING TITLE: CONCRETE COLUMN DETAILS

**S501** 

SCALE: As indicated DATE: ISSUED FOR PERMIT 06-10-20 PROJECT NO: 50-24102 RWN. CHK'D. CM JR

## GARAGE REINFORCED CONCRETE COLUMN SCHEDULE

COLUMN MARKS-COLUMNLINEB Group6 Group3 Group2 Group7 Group5 Group4 B-7 **FLOOR** LEVEL 3W SIZE: 28x24 SIZE: 24x24 SIZE: 24x24 F'c=5 KSI F'c=5 KSI TYPE-2 F'c=5 KSI TYPE-2 12-#11 VERT 8-#14 VERT. #4 TIES #4 TIES 8-#14 VERT. @8" O.C. SIZE: 28x24 F'c=5 KSI TYPE-2 8-#11 VERT. LEVEL 2W F'c=5 KSI #4 TIES SIZE: 24x24 SIZE: 28x24 SIZE: 28x24 8-#14 VERT

F'c=5 KSI TYPE-2

8-#14 VERT

#4 TIES @8" O.C. #4 TIES

@8" O.C.

F'c=5 KSI

12-#11 VERT.

TYPE-3

#4 TIES

12-#11

Group1

**FLOOR** 

LEVEL 2E

T/FND. EL

B-1

SIZE: 28x24

8-#11 VERT

F'c=5 KSI

TYPE-2

#4 TIES

# D. YURY SWETIN

7121-081-004519 ISSUE

NO. DESCRIPTION DATE DRAWING TITLE: GARAGE COLUMN

**SCHEDULE** 

DRAWING NO:

**S502** 

SCALE: N.T.S. DATE: ISSUED FOR PROJECT NO: 50-24102 RWN.

GARAGE REINFORCED CONCRETE COLUMN SCHEDULE COLUMN MARKS-COLUMNLINEA Group3 Group2 Group1 Group8 Group 7 Group5 Group4 A.3-8 A-7 A-2 A-1 **FLOOR FLOOR** LEVEL 2E SIZE: 24x24 SIZE: 24x24 SIZE: 24x24 F'c=5 KSI F'c=5 KSI F'c=5 KSI TYPE-2 TYPE-2 TYPE-2 8-#11 VERT 8-#11 VERT 8-#11 VERT LEVEL 2W F'c=5 KSI #4 TIES #4 TIES #4 TIES TYPE-2 @8" O.C. SIZE: 24x24 SIZE: 24x24 SIZE: 24x24 8-#11 VERT F'c=5 KSI F'c=5 KSI F'c=5 KSI F'c=5 KSI #4 TIES TYPE-2 TYPE-2 TYPE-2 @8" O.C. 8-#11 VERT. 8-#11 VERT 8-#11 VERT T/FND. EL #4 TIES #4 TIES #4 TIES @8" O.C. @8" O.C. @8" O.C. T/FND. EL COLUMN DOWELS, COLUMN ORIENTATION FOR BRICK LEDGE, FOR BRICK LEDGE, FOR BRICK LEDGE, **REMARKS** SEE DET. 4 / S102 SEE DET. 5 / S102 SEE DET. 5 / S102

REMARKS SEE DET. 5 / S102 -#4 ANCHOR **BAR AT JOINT** -ADD'L JOINT TIES SEE NOTE 8 THIS DWG. 4 VERTICAL BARS

F'c=5 KSI

12-#11 VERT.

TYPE-3


#4 TIES


@8" O.C.


12-#11

T/FND. EL

ORIENTATION

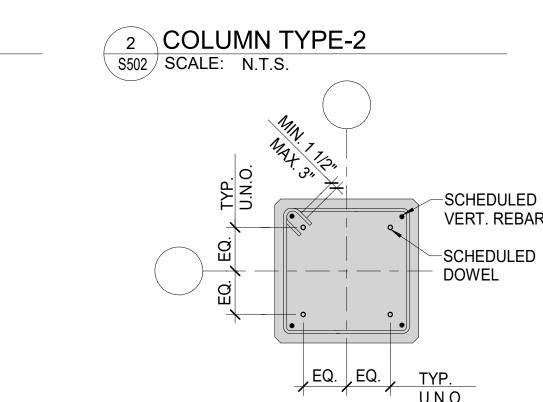

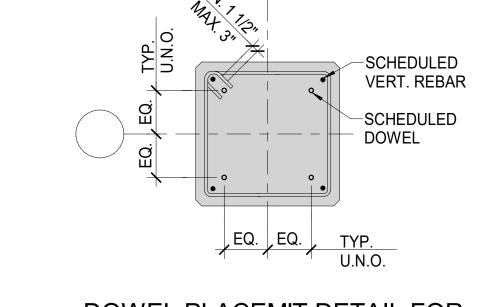

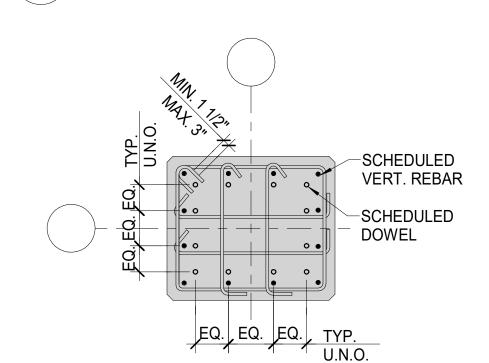

DOWEL PLACEM'T DETAIL FOR 6 TYPE-3 S502 SCALE: N.T.S.

3 COLUMN TYPE-3

S502 SCALE: N.T.S.

-SCHEDULED VERT. REBAR -SCHEDULED

DOWEL PLACEM'T DETAIL FOR 5 TYPE-2 S502 SCALE: N.T.S.

FOR BRICK LEDGE

8 VERTICAL BARS

S502 SCALE: N.T.S.

DOWEL PLACEM'T DETAIL FOR 4 TYPE-1 S502 SCALE: N.T.S.

EXTEND VERT. REINF. FROM TIER BELOW. SIZE TO MATCH, U.N.O. REFER TO TYP. DET. x/xx

@8" O.C. SIZE: 24x24 SIZE: 24x24 SIZE: 24x24 SIZE: 24x24 8-#11 VERT F'c=5 KSI F'c=5 KSI F'c=5 KSI F'c=5 KSI #4 TIES TYPE-2 TYPE-2 TYPE-2 TYPE-2 @8" O.C. 8-#11 VERT 8-#11 VERT 8-#11 VERT 8-#11 VERT #4 TIES #4 TIES #4 TIES #4 TIES @8" O.C. @8" O.C. @8" O.C. T/FND. EL COLUMN ORIENTATION FOR BRICK LEDGE, REMARKS SEE DET. 5 / S102

SIZE: 24x24

8-#11 VERT.

#4 TIES @8" O.C.

F'c=5 KSI TYPE-2

Group7 Group8 Group5 Group4 Group3 C-3

COLUMN MARKS-COLUMNLINE C

GARAGE REINFORCED CONCRETE COLUMN SCHEDULE

Group2

C-2

SIZE: 24x24

F'c=5 KSI

8-#11 VERT

TYPE-2

#4 TIES

SIZE: 24x24

F'c=5 KSI

TYPE-2

Group1

**FLOOR** 

LEVEL 2E

T/FND. EL

C-1

SIZE: 24x24

F'c=5 KSI

8-#11 VERT

TYPE-2

#4 TIES

@8" O.C.

LEVEL 3W LEVEL 2W

**FLOOR** 

8. FOR BEAM-COLUMN JOINTS OF THE PARKING STRUCTURE FRAME, PROVIDE JOINT REINFORCEMENT

**COLUMN TYPICAL DETAIL AND SCHEDULE NOTES** 

REQUIREMENTS NOT INDICATED HEREIN BELOW.

AND SCHEDULED COLUMN TIES BELOW ANCHORAGE ZONE SPACED AT 4 INCHES ON-CENTER 10. USE THESE NOTES TOGETHER WITH TYPICAL DETAILS AND COLUMN SCHEDULE INFORMATION HEREIN ABOVE FOR COLUMN REINFORCING DETAILING. COLUMN DETAILING SHALL FOLLOW

1. ALL COLUMNS ARE CENTERED ON COLUMN GRID LINES UNLESS OTHERWISE NOTED.

3. REFER TO COLUMN SCHEDULE NOTES ON COLUMN SCHEDULE DWG. FOR SPECIFIC DETAILING

6. IN ALL INSTANCES, VERTICAL REINFORCEMENT FROM COLUMN SEGMENT BELOW JOINT SHALI

5. SEE ARCHITECTURAL DRAWINGS FOR LIGHT POLE SUPPORT COLUMNS AND DETAILS. COORDINATE

2. FOR COLUMN ORIENTATION SEE PLANS AND COLUMN SCHEDULE

PRINCIPLES AND TYPICAL GRAPHICAL STANDARDS OF ACI SP-66 DETAILING MANUAL. LATEST 11. ALL FLOOR ELEVATIONS INDICATED IN THESE SCHEDULES ARE EITHER SCHEMATIC OR NOMINAL 12. ALL COLUMN TIES SHALL BE PER ACI 315, LATEST EDITION. STANDARD 90 OR 135 DEG. HOOKS SHALL

NOTED OTHERWISE. 13. CLEAR COVER TO COLUMN TIES, EXPOSED TO WEATHER, FOR PARKING STRUCTURE SHALL BE 2 INCHES UNLESS NOTED OTHERWISE.

14. TOP AND BOTTOM ELEVATION OF EACH TIER OF ANY COLUMN SHALL BE DETERMINED BY THE DETAILER USING ARCHITECTURAL AND STRUCTURAL PLANS, NOTES, AND DETAILS. THESE ELEVATIONS WILL VARY FROM COLUMN TO COLUMN EVEN IF THEY HAVE BEEN GROUPED INTO A SINGLE COLUMN IN THE SCHEDULE HEREIN ABOVE.

15. SPACING OF TYPICAL COLUMN TIES INDICATED IN THE SCHEDULE IS MAXIMUM FOR A SPECIFIC SEGMENT INDICATED AND MAY REQUIRE REDUCTION BASED ON TYPICAL DETAILS. OF PARTICULAR IMPORTANCE MAY BE COLUMN SEGMENTS BETWEEN BEAMS SUPPORTING RAMPS ON THE OPPOSITE SIDES OF A GIVEN COLUMN AND FRAMED INTO OPPOSITE FACES OF THE SAME COLUMN. SHORT SEGMENTS THUS FORMED SHALL BE PROVIDED WITH TIES @ 4" O.C. UNLESS NOTED OTHERWISE.

LEGEND:

ISSUE


ISSUE FOR PERMIT

**S601** 

SCALE: 3/4" = 1'-0"

PROJECT NO: 50-24102

DES. RWN. CHK'D
YS MBT YS RWN. CHK'D. YS

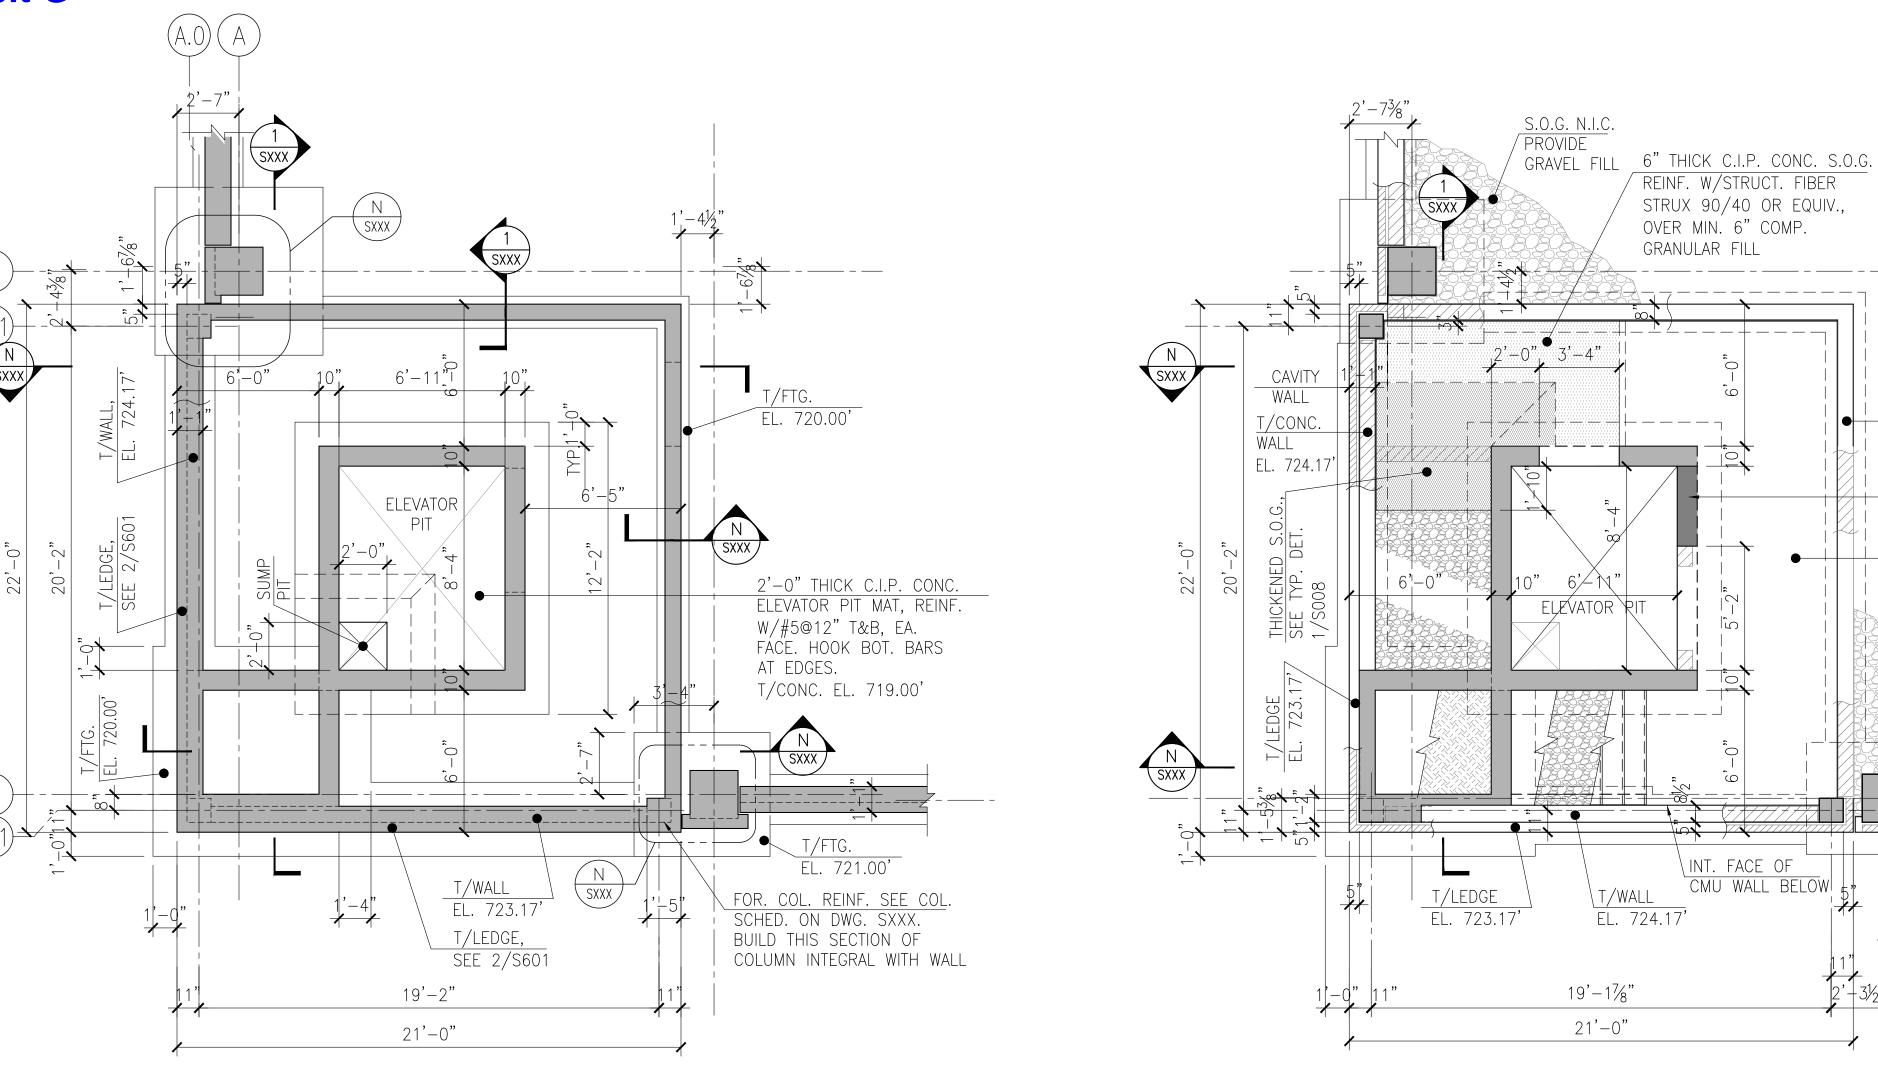



T/WALL EL. 723.17'

CONSTRUCT AFTER ELEVATOR
CAB IS IN PLACE. SEE ELEV.


5" THICK C.I.P. CONC. S.O.G.

S.O.G. N.I.C. PROVIDE GRAVEL FILL

REINF. W/STRUCT. FIBER


STRUX 90/40 OR EQUIV., OVER MIN. 6" COMP.

GRANULAR FILL

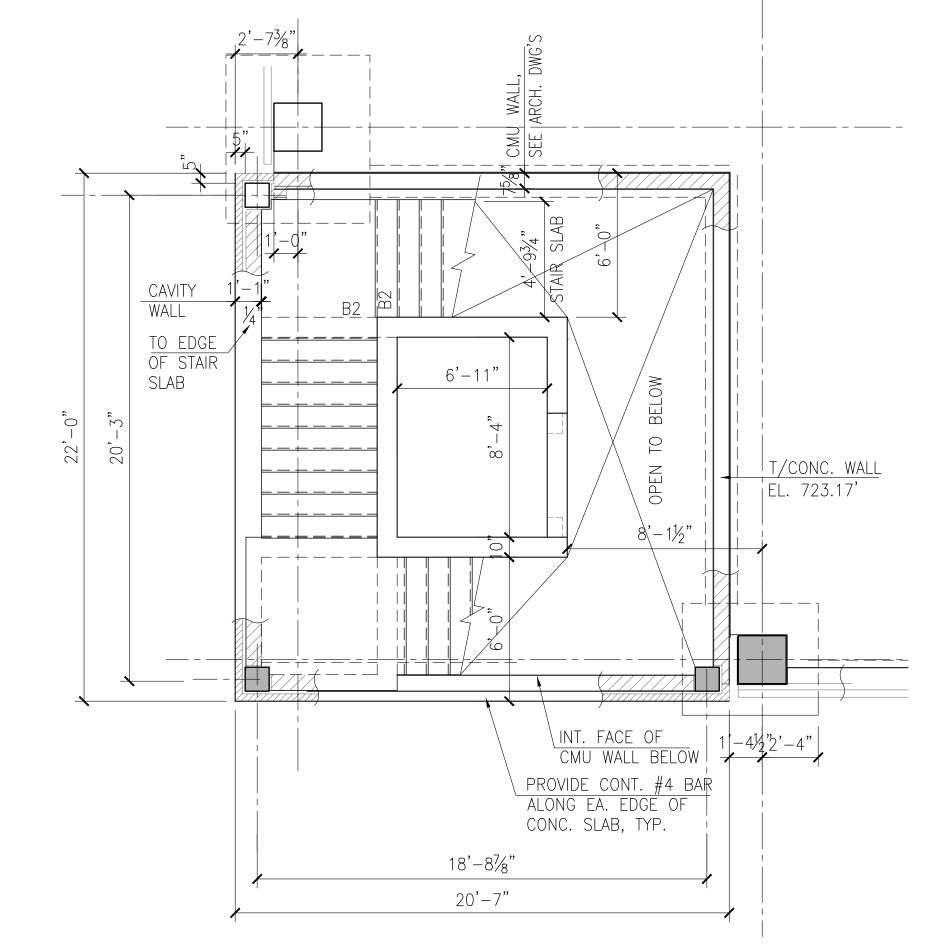


WEST STAIR PLAN - LANDING LEVEL PLAN
SCALE: 1/4" = 1'-0"



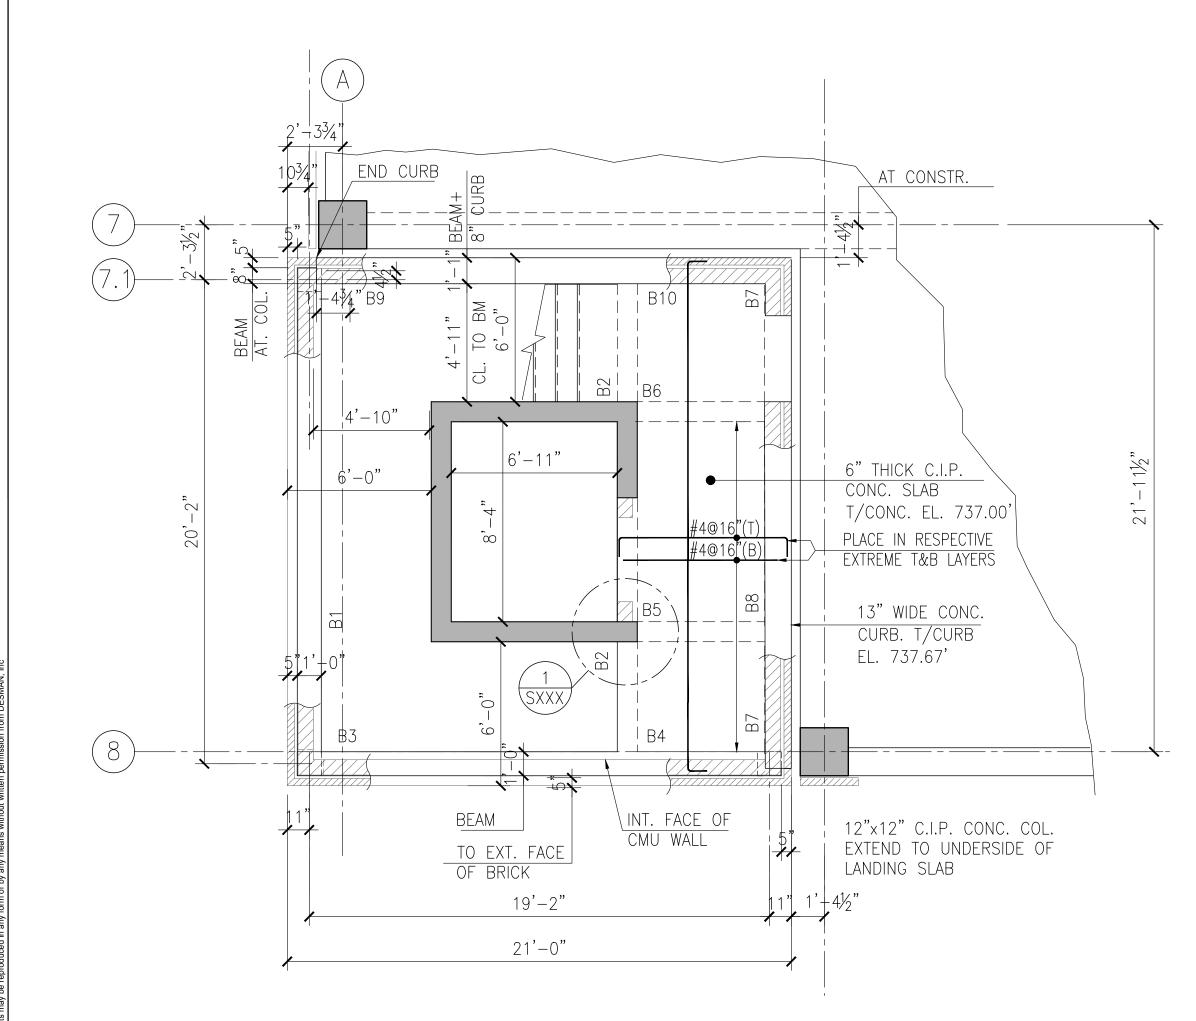

WEST STAIR PLAN - TOP FRAMING PLAN
SCALE: 1/4" = 1'-0"

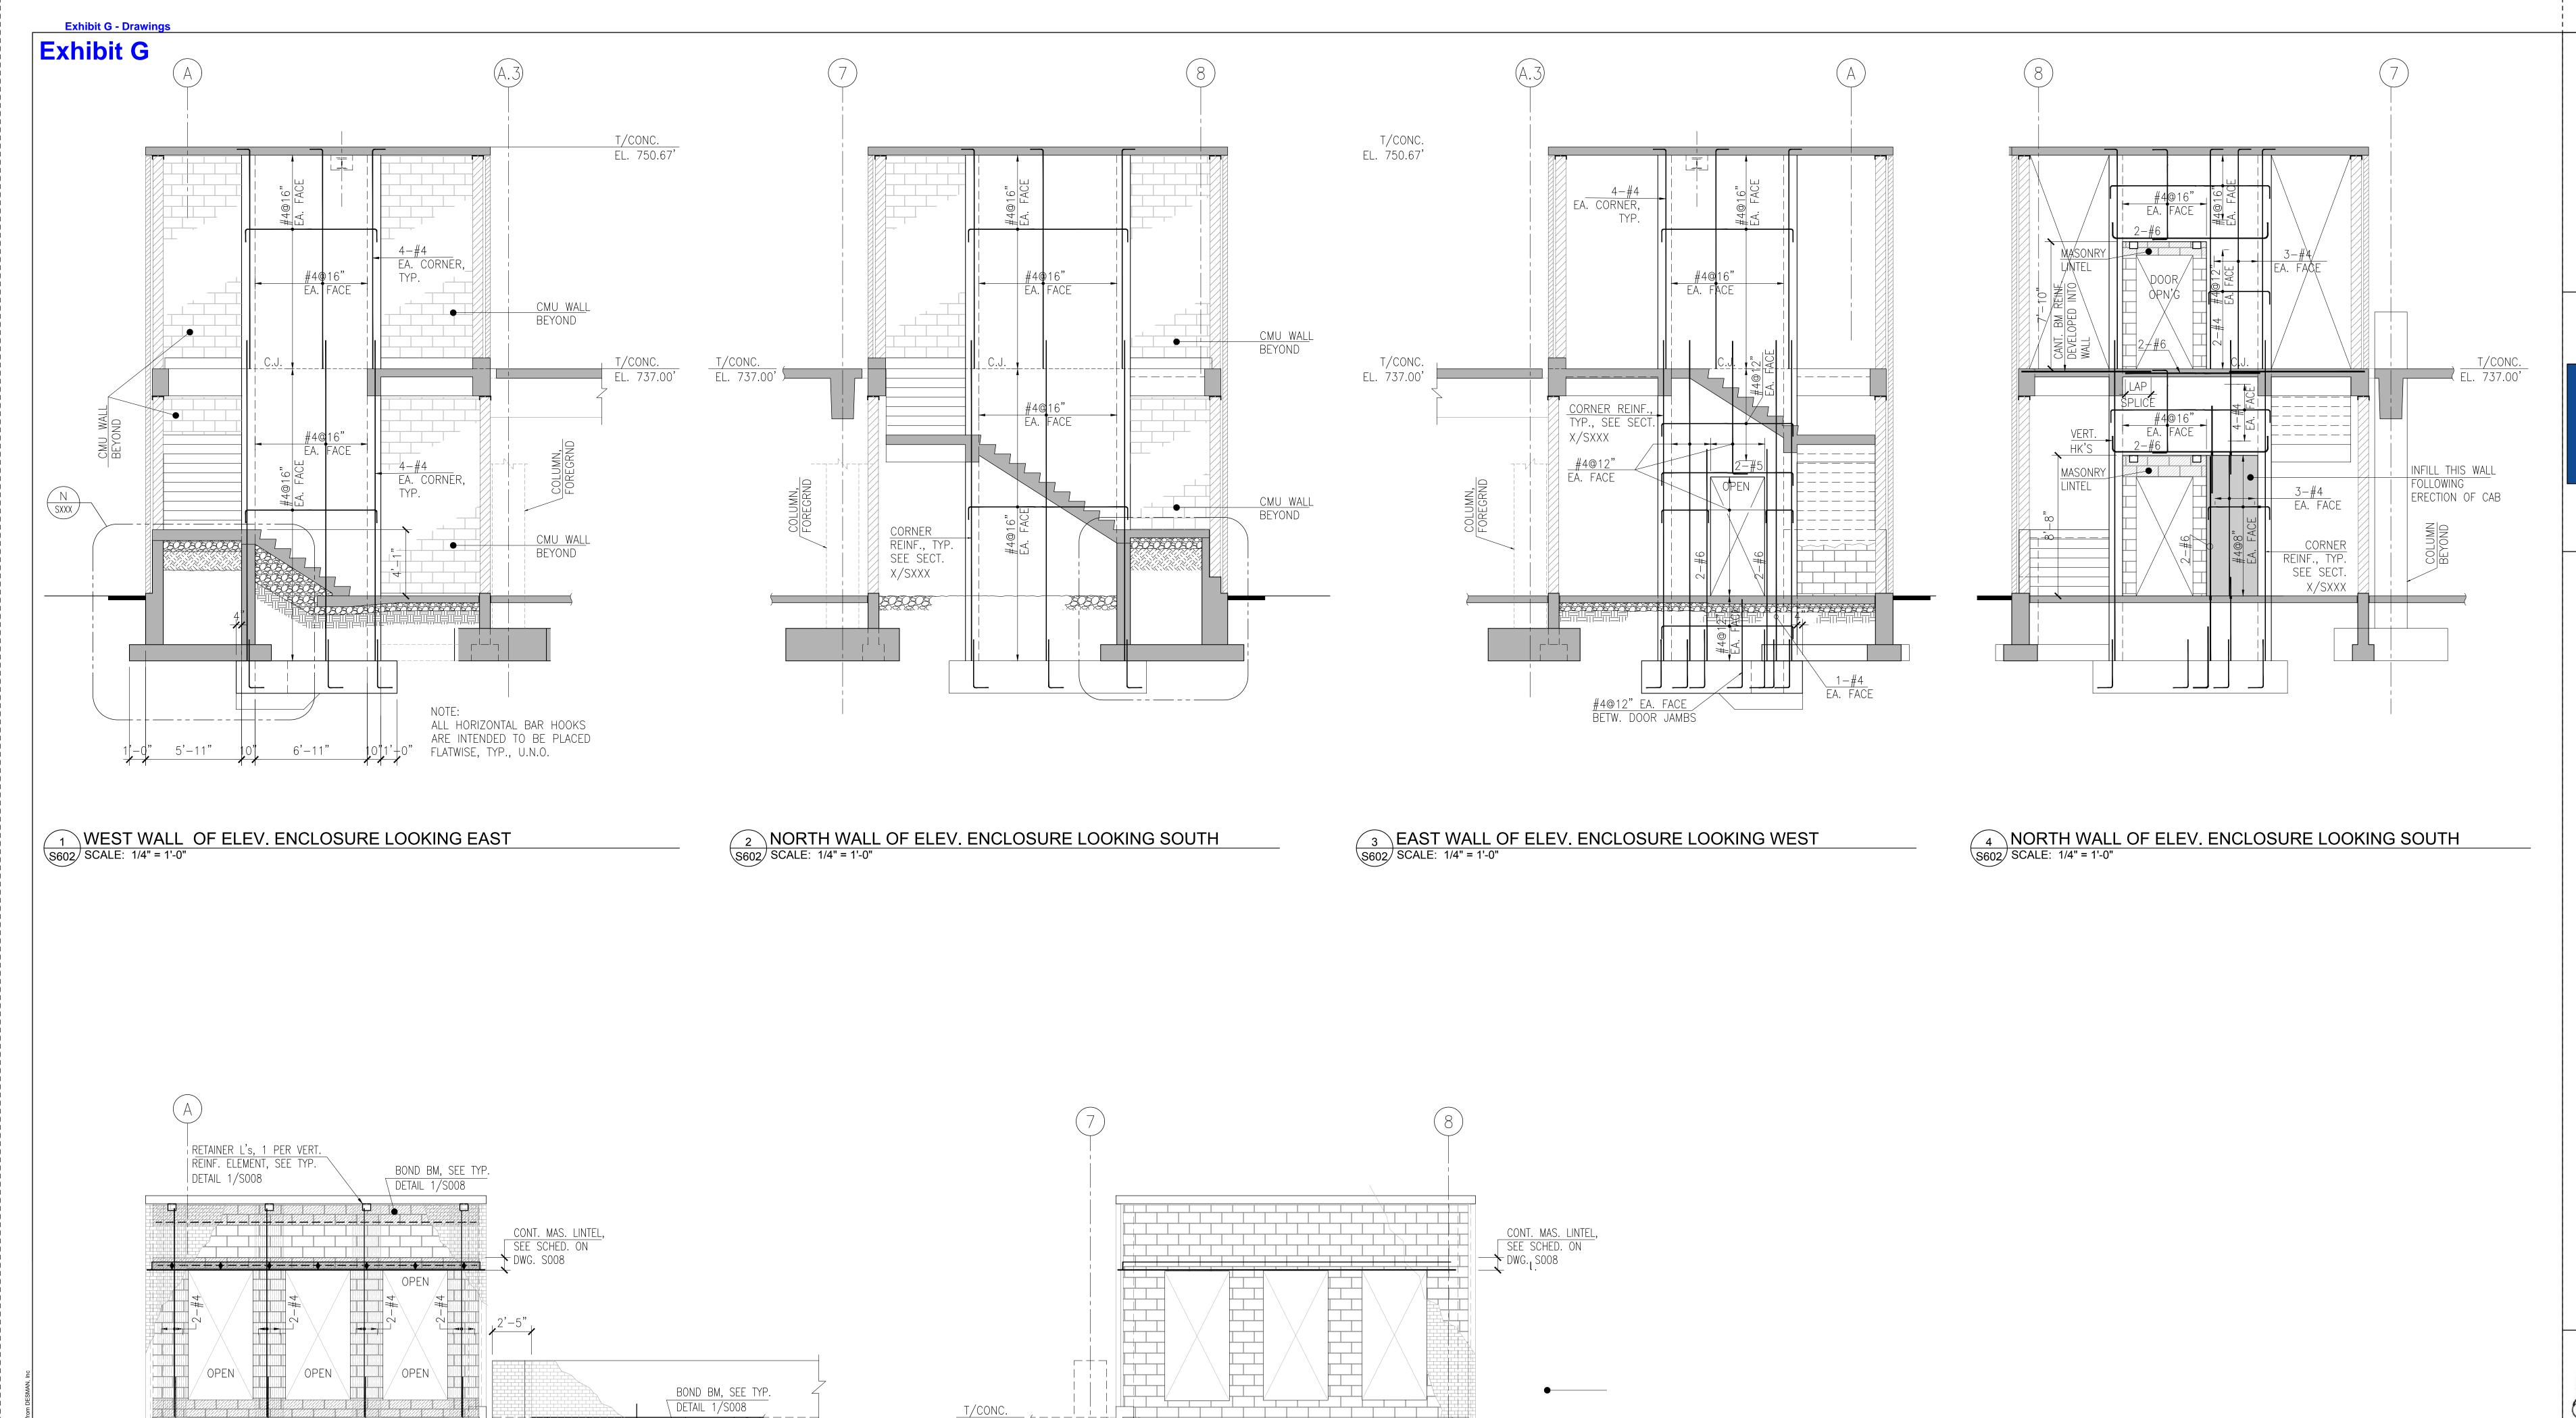

CMU WALL BEYOND

<u>\_\_\_\_\_</u>

WEST STAIR ENCLOSURE

NORTH ELEVATION LOOKING SOUTH
S602 SCALE: 1/4" = 1'-0"

MASONRY LINTEL, SEE SCHED.

3'-0"

WEST STAIR ENCLOSURE

1 WEST ELEVATION LOOKING EAST
S602 SCALE: 1/4" = 1'-0"

ISSUE ISSUE FOR PERMIT

NO. DESCRIPTION DATE

DRAWING TITLE:

ENLARGED STAIR SECTIONS

DRAWING NO:

**S602** 

RWN. CHK'D. MBT YS

SCALE: 3/4" = 1'-0" PROJECT NO: 50-24102

DES. RWN. CHK'D
YS MBT YS



ISSUE

NO. DESCRIPTION DATE
DRAWING TITLE:
FOUNDATION
SECTION AND
DETAILS

DRAWING NO:

\$603


SCALE: 3/4" = 1'-0"

DATE: 05/30/24

PROJECT NO: 50-24102

DES. RWN. CHK'D. YS

MBT YS

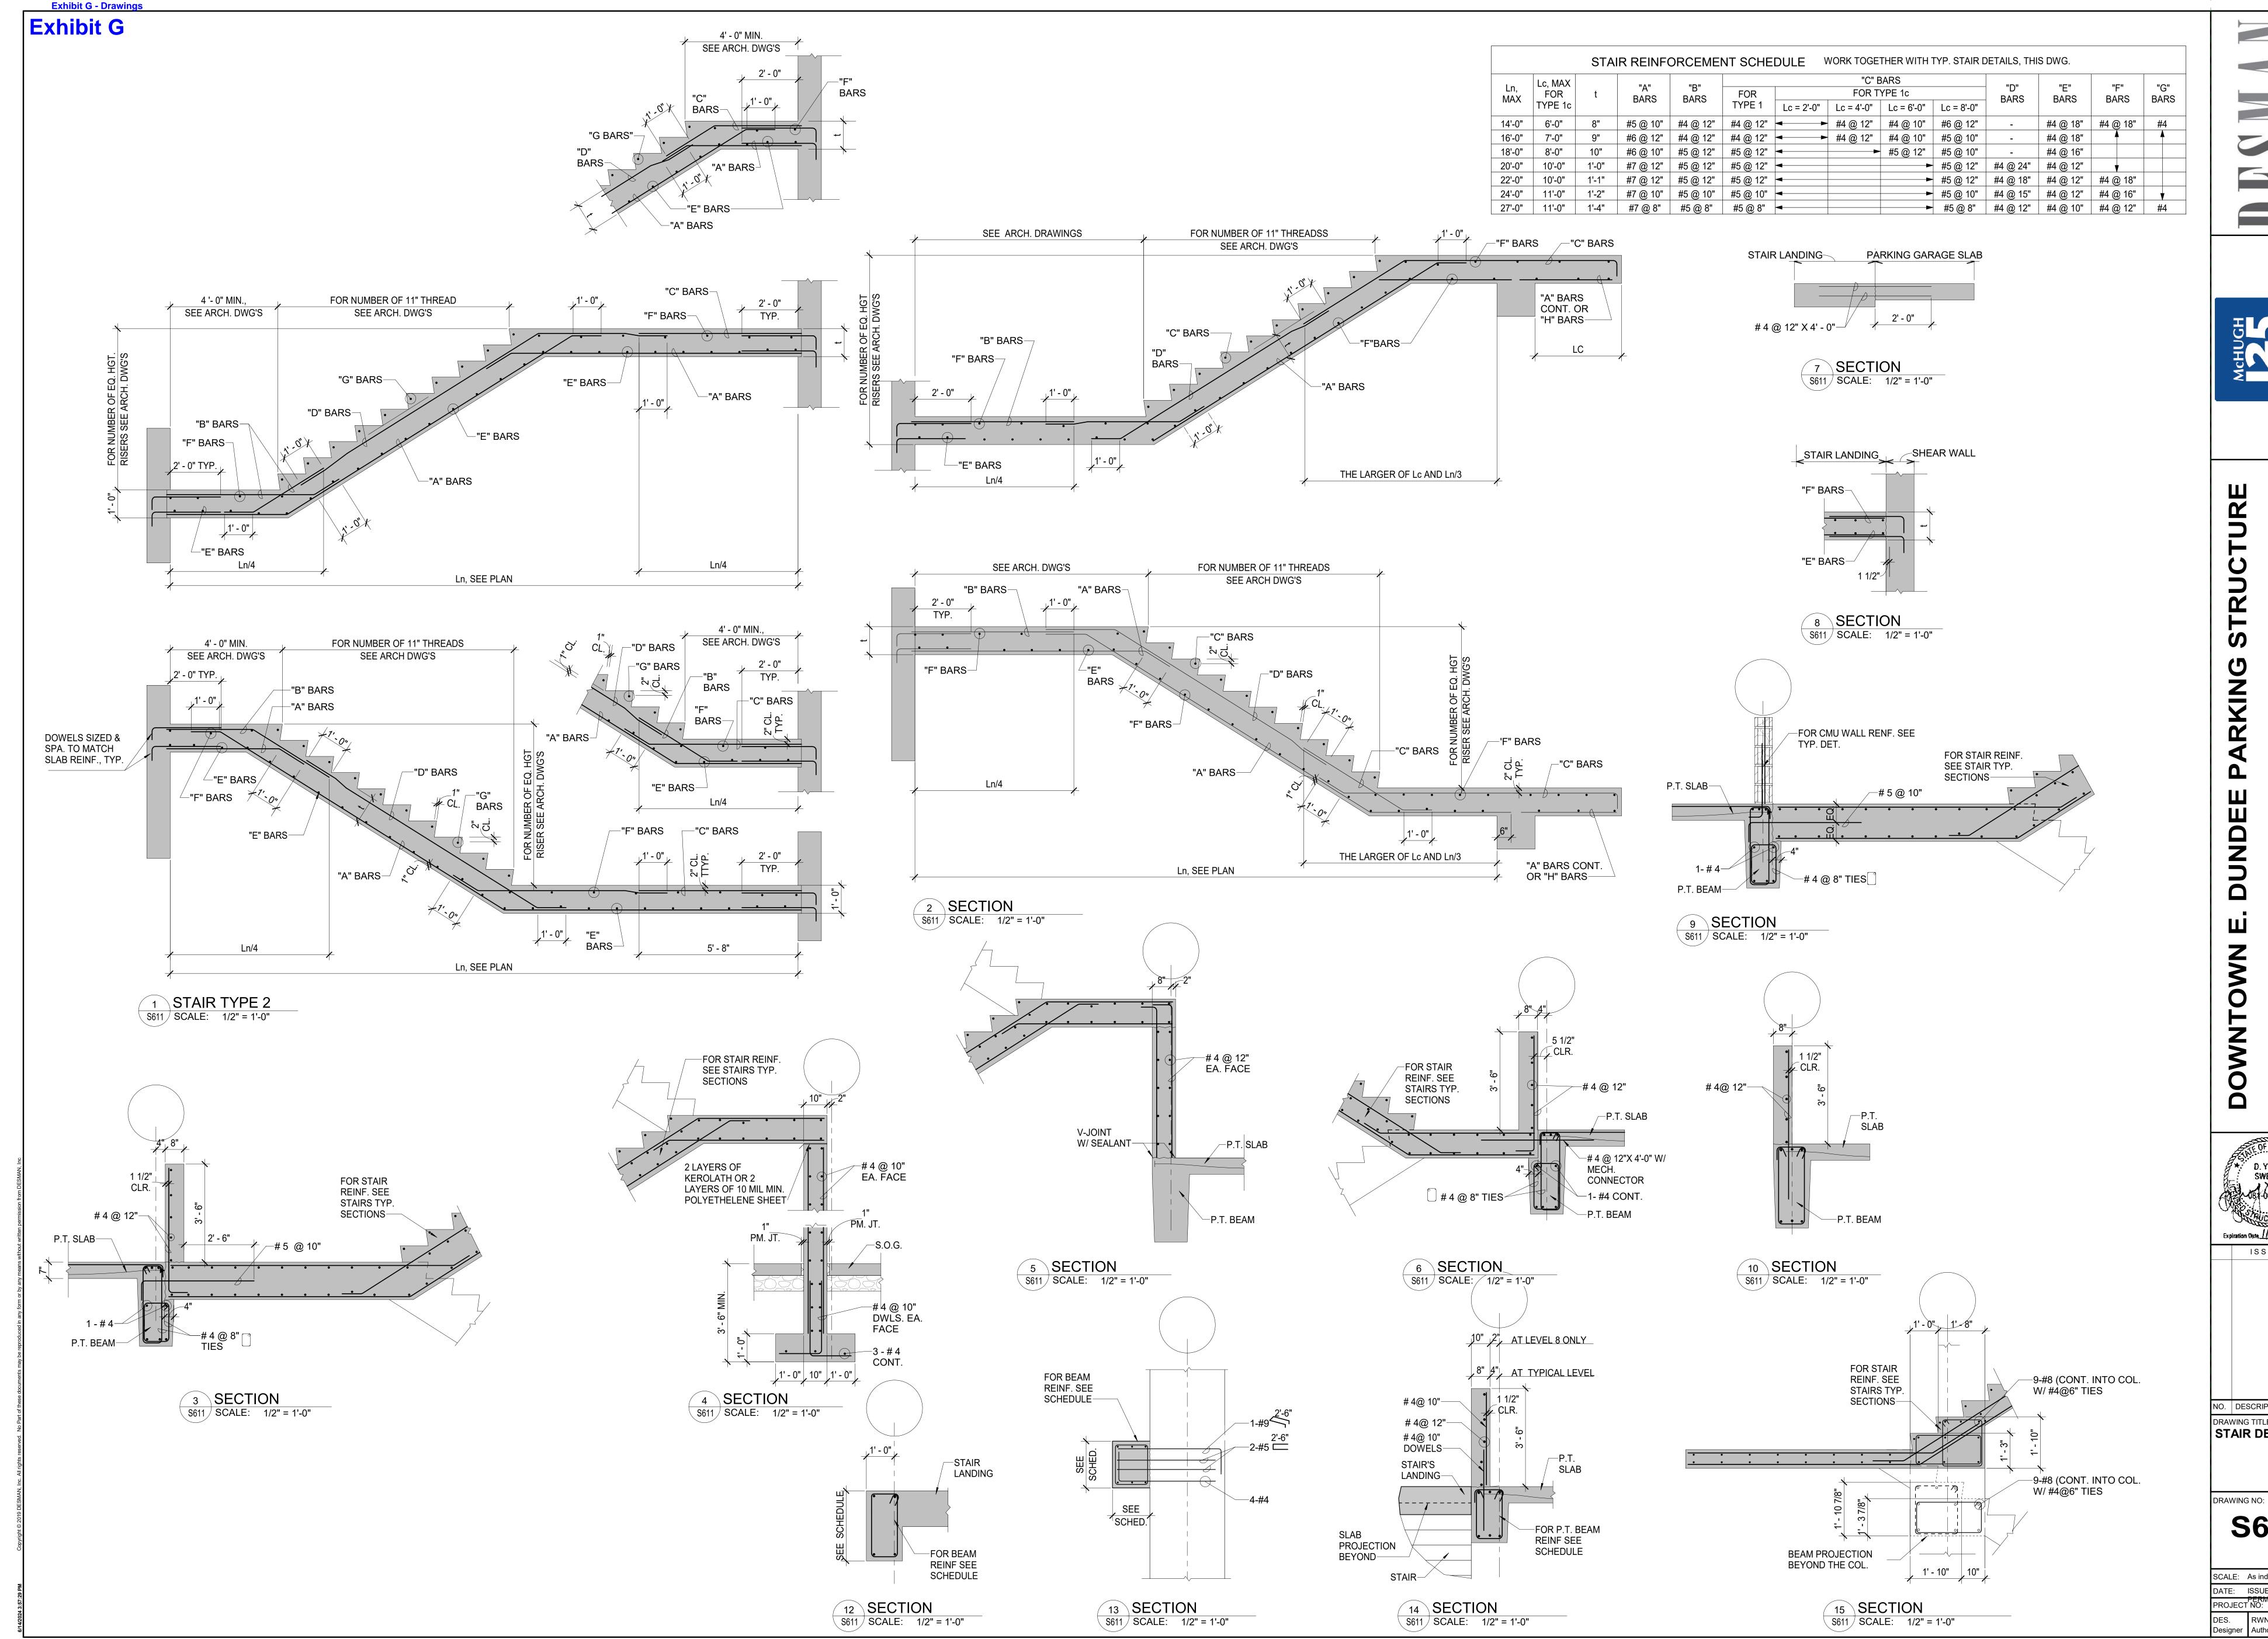

4



ISSUE NO. DESCRIPTION DATE DRAWING TITLE:

STAIR DETAILS

**S611** 


SCALE: As indicated DATE: ISSUED FOR PERMIT 06-10-20 PROJECT NO: 50-24102 DES. RWN. CHK'D. Designer Author Checker

DRAWING NO: **S621** 


SCALE: 3/4" = 1'-0" PROJECT NO: 50-24102

DES. RWN. CHK'D
YS MBT YS RWN. CHK'D. YS


	,						-1:						STIRRUPS, SEE SCHEDULE  STIRRUPS, SEE SCHEDULE  STIRRUPS, SI
MARK	SHAPE	DIMENSIONS WIDTH DEPTH W, IN D, IN	TOP LEFT	F O R C E		SIDE, EA. FACE	12.2-1	S T   R	R U P S SPA. EA. END, U.N.O.	PLACEM'   FACE/   LEFT   SUPP'T	T DIAGRAM  FACE/ RIGHT SUPP'T	REMARKS	SMALLER BAR CLASS B TENSION LAP  L12/3  L12/3  30 BAR SMALL SMALL CLASS B TENSION LAP  CLASS B  CLASS B
B1		12 20	2-#6	2-#6	2-#6	1-#4	#4		1@2",6@8", BAL@12"	<b>_</b>			2"   SPLICE   SF
B2		10 20	2-#7	2-#6	CONT.	2-#5	1		1@2", BAL@5"			CANTILEVER BM. LEFT END REBAR TO FULLY DEVELOP INTO WALL IN TENSION	
ВЗ		12 20	2-#6	2-#6	CONT.	2-#4			1@2", BAL@8"			EXTEND T&B REINF. THRU RIGHT SUPP'T & LAP SPLICE AT MID—SPAN OF B4	
B4		12 20	CONT.	CONT.	CONT.	2-#4			1@2", BAL@8"			T&B REINF. CONT. FROM ADJ. SPAN. SEE REMARKS AT B3. CONT. REINF. PERMITTED	
B5		10 20	2-#7	2-#6	CONT.	2-#4			1@2", BAL@8"			CANTILEVER BM. LEFT END REBAR TO FULLY DEVELOP INTO WALL IN TENSION	CLASS B TENSION LAP  SPLICE FOR MIN 0.25As  STIRRUP SUP
В6		10 20	3-#7	2-#6	CONT.	2-#4			1@2", BAL@8"			CANTILEVER BM. LEFT END REBAR TO FULLY DEVELOP INTO WALL IN TENSION	DIT NOT LESS THAN 2   HALL   MIN., TIP., U
В7		13 20	2-#6	2-#6	CONT.	2-#5			1@2", BAL@5"			<del>-</del>	L <sub>1</sub> END CLEAR SPAN L <sub>2</sub> INTERIOR C
В8		13 20	CONT.	2-#6	CONT.	2-#5			1@2", BAL@5"	<del> </del> <u>-</u>	<u>+</u>	SEE SECT. X/SXXX FOR CURB @ T/BM SEE DETAIL D/SXXX FOR INTERFACE WITH	BM
В9		13 20	2-#6 +1-#4	2-#6	2-#7	1-#4			1@2", BAL@7"		-#4	COL. @ T/LEFT. PROVIDE ADD'L #4 FOR STIRRUP SUPP'T	
B10		13 20	CONT.	2-#6	2-#7	1-#4			1@2", BAL@7"				PLACEMENT DIAGRAM. CONT.  PROVIDED AT CONTRACTOR'S  2. ALL BEAMS HAVE BEEN MARK
			7.										TVD_DAD_DLACEMENT_DLACDAM_EOD_CONVENTIONAL

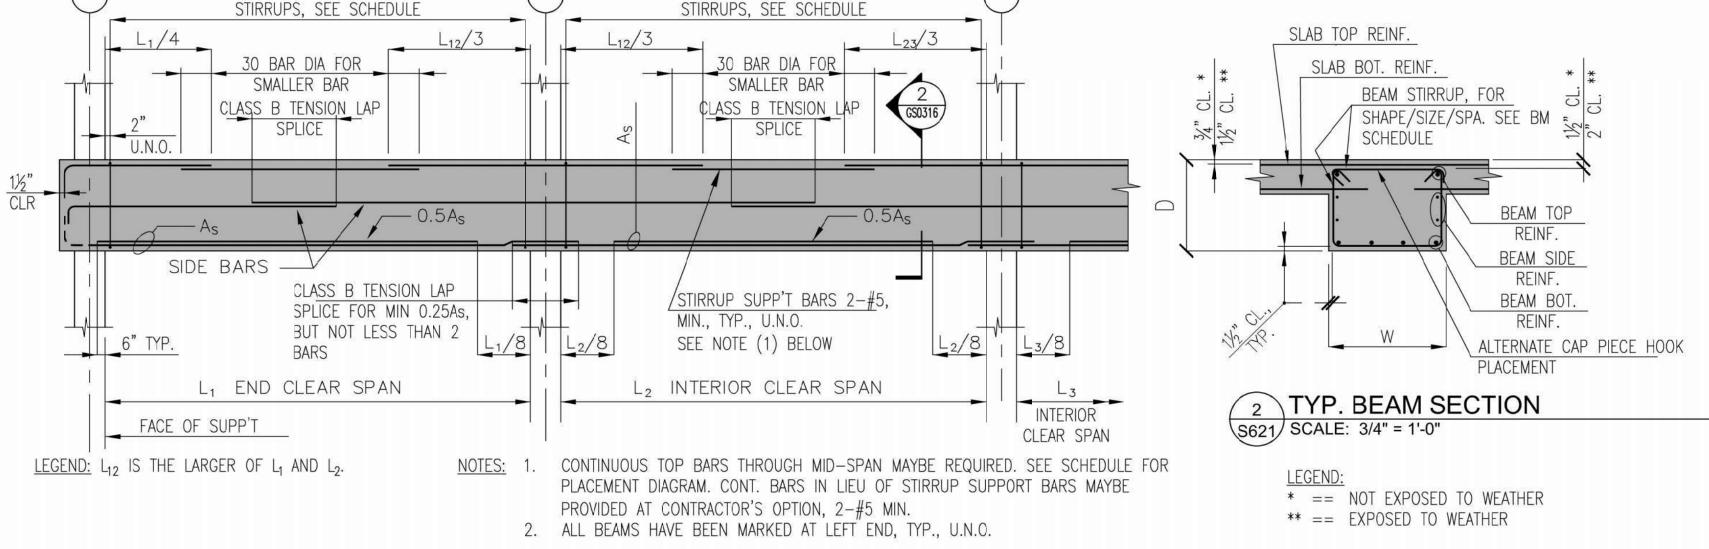


TYP. BAR PLACEMENT DIAGRAM FOR CONVENTIONALLY REINFORCED 1 CONCRETE BEAMS
S621 SCALE: NONE

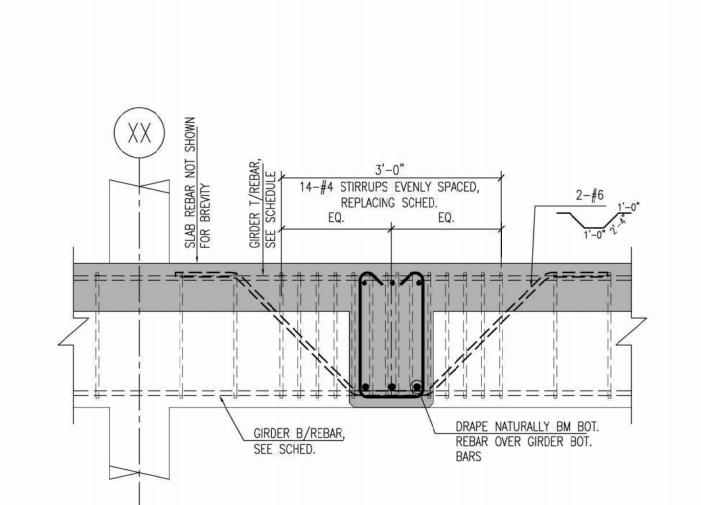

DEFLECTION - BEAM/GIRDER 3 INTERFACE S621 SCALE: 1/4" = 1'-0"

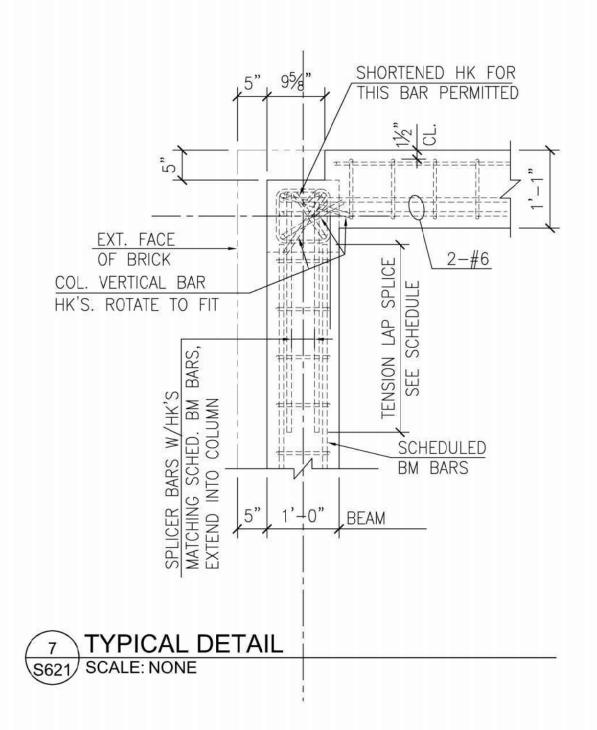

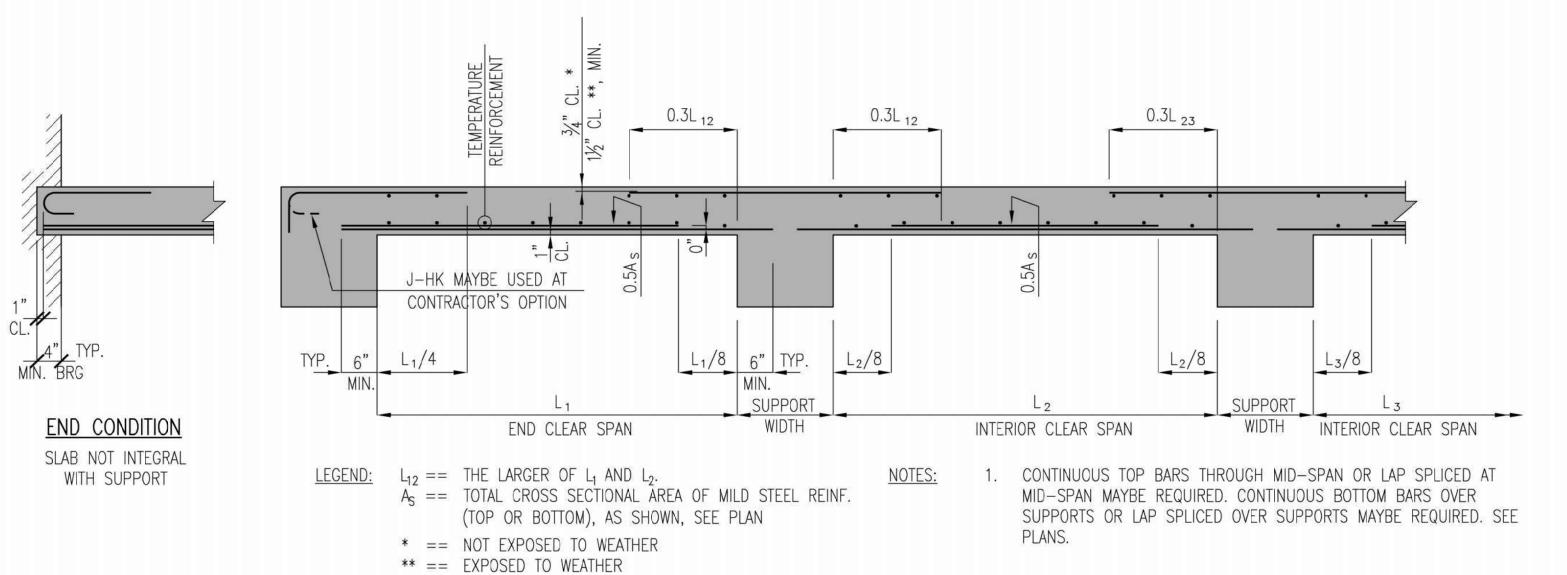


TYP. BAR PLACEMENT DIAGRAM FOR CONVENTIONALLY REINFORCED 4 ONE-WAY CONCRETE SLABS
SCALE: NONE

4-#4 VERT., TYP. EA. CORNER

5 TYPICAL DETAIL SCALE: NONE

PLACE E-W BEAM REINF. IN RESPECTIVE INNER LAYERS AND ADJUST STIRRUP DEPTH

ACCORDINGLY

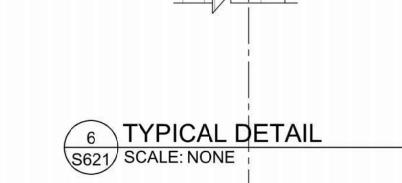

ISSUE

ISSUE FOR 06-10-24 PERMIT

### **Exhibit H - Allowance and Contingencies**



ALLOWANCE INCLUDED IN PROPOSAL	
Concealed conditions allowance for removal of unforeseen obstructions on	
site.	\$ 20,000
Dewatering - allowance	\$ 5,000
Caststone / metal panels, non-insulated cornice / coping @ northeast stairs	
and northwest stairs towers + west and partial south - supply & install	
allowance	\$ 124,000
Decorative overhang corbels @ northwest stairs towers + west - supply &	
install allowance	\$ 55,500
Interior & exterior signage allowance	\$ 10,000
ComEd underground relocation - allowance	\$ 96,993
TOTAL	\$ 311,493
CONTRACTOR CONTINGENCY	\$ 167,335

### **Exhibit I - Alternates**



ALTERNATE PRICING	
ADD OPTION: Furnish and install face brick on the north side of columns, at	
the north building elevation along Hill St.	\$ 18,656
ADD OPTION: Furnish and install two electric vehicle charging stations	
(infrastructure for two charging stations included in base bid)	\$ 20,000

### Exhibit J - Submittal Log

#	Submittal Description	Specification Section
1	Face Brick Samples	042000
2	Cornice Color & Material Samples	042000
3	Corbel Color & Material Samples	061000
4	Garage Screening Color & Material Samples	057016
5	Storefront Window Color Samples	084113
8	Door Hardware Product Data	087100
6	Exterior Paint Color Samples	099100
7	Interior Paint Color Samples	099100
9	Signage Shop Drawings & Samples	101400
10	Awning Material & Color Samples	107313

### Memorandum

**To:** Village President and Board of Trustees

**From:** Franco Bottalico, Assistant to the Village Administrator

**Subject:** Ordinance Authorizing Easements Related to Parking Garage

**Date:** July 15, 2024

=ERST= DUNDEE

### **Action Requested:**

Staff recommends Village Board approval of an ordinance authorizing execution and recording of easement agreements for permanent public utility and drainage easements and temporary construction easements agreements at locations adjacent to the proposed parking garage at 304 Hill St.

### **Summary:**

Should the Board authorize staff to proceed with the construction of the parking garage at the July 15, 2024, Village Board meeting via the Design-Builder Contract Amendment agenda item, staff has worked with the neighboring properties for temporary construction easements and permanent storm water utility easements that would be needed for the construction. The easement agreements are as follows:

Property Address	Temporary Construction	6' Permanent Storm Water
	Easements	Utility Easement
308 Hill Street	Yes	Yes
107 N. Van Buren Street	Yes	Yes
311 Jackson Street	Yes	No
102 N. River Street	Yes	No
104-106 N. River Street	Yes	No

The parking garage design-builder contractor, James McHugh Construction Co. ("McHugh") and their engineering firm, Pinnacle Engineering Group of East Dundee, have design the north east side of the parking garage site to include a swale that drains south into a manhole located on the east side of the Jackson Street surface parking lot. Because of that, a permanent storm water utility easement was necessary to be negotiated with the property owners (residences) in order for the parking garage project to proceed.

Additionally, McHugh requested a temporary 10-ft. construction easement for their contractors to access, drive, and remove existing trees and brush on the residents' properties until May of 2025.

Due to the removal of mature vegetation and the construction of a parking garage and surface lot next to existing residential, staff has negotiated with the property owners for Village provided considerations. The Village-provided considerations include one-time payment for their cooperation and landscape screening restoration, and the construction of a privacy, low-maintenance vinyl fence along the east side of the Jackson Street surface lot in the spring of 2025. The fence would be located on village property and be village-owned.

With regards to the businesses to the southwest of the parking garage site, there will be a minimal temporary construction easement on their properties until May of 2025. An approximate 3.5' construction easement to the north of the dental office, and an approximate half-foot construction easement to the east of the dental office, martial arts establishment, and River Street Tavern.

### **Attachment:**

Ordinance

ORDINANCE NO. 24
------------------

### AN ORDINANCE APPROVING AND AUTHORIZING EXECUTION AND RECORDING OF EASEMENT AGREEMENTS FOR PERMANENT PUBLIC UTILITY AND DRAINAGE EASEMENTS AND TEMPORARY CONSTRUCTION EASEMENT AGREEMENTS

(107 N. Van Buren Street, 308 Hill Street, 311 Jackson Street, 102 N. River Street, 104-106 N. River Street)

**WHEREAS**, the Village of East Dundee (the "*Village*") is a duly organized and validly existing home-rule municipality created in accordance with the Constitution of the State of Illinois of 1970 and the laws of the State; and

**WHEREAS**, the Village recently acquired title to the parcel of real estate commonly known as 304 Hill Street and 309 Jackson Street, East Dundee, Illinois (the "Village Property"), and is in the process of constructing a parking garage and related improvements on the Village Property (the "Garage Project"); and

**WHEREAS**, the Village requires certain permanent easements and temporary construction easements to construct, operate, and maintain certain stormwater and sewer improvements (the "*Improvements*") and for temporary construction staging, and other construction-related purposes; and

**WHEREAS**, portions of the Improvements and temporary staging areas are located on privately owned properties commonly known as 107 N. Van Buren Street, 308 Hill Street, 311 Jackson Street, 102 N. River Street, 104-106 N. River Street (collectively, the *"Properties"*); and

WHEREAS, the Village desires to enter into easement agreements ("Easement Agreements") with the owners of the Properties (collectively, the "Owners") pursuant to which the Owners agree to grant permanent easements and temporary construction easements, as applicable, across portions of the Properties to the Village for the construction and maintenance of the Improvements and temporary construction purposes (collectively, the "Easement Agreements"); and

**WHEREAS**, the Village President and Board of Trustees have reviewed the Easement Agreements and have determined that it is in the best interest of the Village to enter into the Easement Agreements with the Owners.

**NOW, THEREFORE, BE IT ORDAINED** by the President and Board of Trustees of the Village of East Dundee, Kane and Cook Counties, Illinois, as follows:

<u>SECTION 1</u>: Recitals. The above recitals are incorporated herein and made a part of this Ordinance.

SECTION 2: Approval of Easement Agreements. The Easement Agreements with the Owners are hereby approved in substantially the form attached to this Ordinance as **Group Exhibit A**, and in a final form approved by the Village Administrator.

SECTION 3: Authorization to Execute and Record Easement Agreements. The President and Board of Trustees hereby authorizes and directs the Village Administrator to execute and the Village Clerk to attest, on behalf of the Village, the final Easement Agreements and directs the Village Clerk, on behalf of the Village, to record the executed Easement Agreements at the Kane County Recorder of Deeds, following their execution and delivery to the Village Clerk by the Owners.

<u>SECTION 4</u>: <u>Effective Date</u>. This Ordinance shall be in full force and effect following its passage and approval in the manner provided by law.

PASSED THIS day o	f, 2024 pursuant to a roll call vote as follows:
AYES: NAYS: ABSENT: ABSTAIN:	
APPROVED THIS da	ay of, 2024.
ATTEST:	Jeffrey Lynam, Village President
Katherine Diehl, Village Clerk	

### GROUP EXHIBIT A EASEMENT AGREEMENTS

PREPARED BY AND AFTER RECORDING RETURN TO: Lisa Starcevich Elrod Friedman LLP 325 North LaSalle Street Suite 450 Chicago, IL 60654

### TEMPORARY CONSTRUCTION EASEMENT AGREEMENT (102 N. River Street, East Dundee, IL)

THIS TEMPORARY CONSTRUCTION EASEMENT AGREEMENT (the "Agreement") is dated as of this \_\_\_\_\_\_ day of \_\_\_\_\_\_ 2024 (the "Effective Date"), by and between the VILLAGE OF EAST DUNDEE, an Illinois home-rule municipal corporation (the "Village"), and 102 RIVER STREET LLC, an Illinois limited liability company ("Owner"), which hereinafter may be referred together as the "Parties" or individually as a "Party."

WHEREAS, Owner is the sole fee simple owner of certain real property situated at 102 N. River Street, East Dundee, County of Kane, State of Illinois, which real estate is legally described in *Exhibit A* attached hereto, and by this reference, made a part hereof (the "*Subject Property*"); and

WHEREAS, the Village recently acquired title to the parcel of real estate adjacent to the Subject Property, commonly known as 304 Hill Street and 309 Jackson Street, East Dundee, Illinois (the "Village Property"), and is in the process of constructing a parking garage and related improvements on the Village Property (the "Garage Project"); and

**WHEREAS**, the Village requires a temporary construction easement in, on, upon, over, and across a portion of the Subject Property for access to the Village Property, and for construction staging, and other construction-related purposes as the Village reasonably deems necessary or desirable in connection with the Garage Project; and

**WHEREAS**, Owner has agreed to grant to the Village a temporary construction easement on the Subject Property pursuant to the terms and conditions set forth in this Agreement.

**NOW, THEREFORE,** in consideration of the mutual covenants and agreements set forth herein and under the Village's home rule powers, the Parties hereto agree as follows:

1. **RECITALS.** The foregoing recitals are incorporated herein by reference as though

fully set forth.

- 2. **TEMPORARY CONSTRUCTION EASEMENT** Owner grants, conveys, warrants, and dedicates to the Village a temporary easement upon, under, that portion of the Subject Property depicted on *Exhibit B* attached hereto (the "*Temporary Easement Premises*"), together with all reasonable rights of ingress and egress over, along, across, and upon the Subject Property for use by the Village, its general contractor and subcontractors for construction staging, and other construction-related purposes as the Village reasonably deems necessary or desirable in connection with the Garage Project, subject to the terms and conditions of this Agreement (the "*Temporary Easement*"). The Temporary Easement Premises is approximately 0.64 feet wide and runs along the eastern boundary of the Subject Property. Owner reserves the right of access to and use of the Temporary Easement Premises in any manner not inconsistent with the rights granted to the Village under this Agreement.
- 3. <u>TERM OF TEMPORARY EASEMENT</u>. The Temporary Easement is for a term commencing on the Effective Date and expiring on May 31, 2025 (the "*Term*"). The Term may be extended by written notice from the Village to Owner, for a reasonable time if the Village is in compliance with the provisions of this Agreement at the time of expiration.
- 4. **LIENS.** The Village will not permit or suffer any lien to be imposed upon or to accrue against Owner, the Subject Property or the Temporary Easement Premises. The Village will indemnify, defend and hold harmless Owner from and against any liens and encumbrances arising out of any labor or services performed by or at the direction of, or materials furnished to, the Village or any parties claiming by, through or under the Village. In the event that any such lien will arise or accrue against the Owner, the Subject Property or the Temporary Easement Premises, the Village will promptly cause such lien to be released of record by payment thereof or posting a bond in a form and amount which is reasonably satisfactory to Owner.
- 5. <u>INDEMNIFICATION.</u> The Village agrees to indemnify, defend and save Owner harmless from and against any and all liabilities, claims, losses, or demands for personal injury or property damage arising out of or caused by any act or omission of the Village, any of its contractors or subcontractors, anyone directly or indirectly employed or engaged by any of them, or anyone for whose acts any of them may be liable, arising from the Village's exercise or use of the easement rights granted under this Agreement.
- 6. **INSURANCE.** The Village will maintain, and will require any of its contractors to maintain liability insurance in reasonable amounts, and with reputable companies, to protect Owner and the Village against claims arising directly or indirectly out of or in connection with the Village's use of the Temporary Easement Premises or Subject Property pursuant to this Agreement.
- 7. COVENANTS RUNNING WITH THE LAND. The easement and rights granted in this Agreement, the restrictions imposed by this Agreement, and the agreements and covenants contained in this Agreement will be easements, rights, restrictions, agreements and covenants running with the land, will be recorded against the Subject Property and will be binding upon and inure to the benefit of Owner and the Village and their respective heirs, executors, administrators, successors, assigns, agents, licensees, invitees, and representatives, including, without limitation, all subsequent owners of the Subject Property, or any portion thereof, and all persons claiming under them.

- 8. **ASSIGNMENT OF RIGHTS.** Owner agrees that the Village may assign its rights or delegate its duties under this Agreement to any assignee: (a) who is reasonably competent to exercise the rights granted herein and the obligations imposed herein; and (b) who makes adequate assurances to the Owners that any activity performed pursuant to such assignment or delegation will be conducted in a good and workmanlike manner; and (c) who otherwise attests in writing to comply with the terms of this Agreement. Notwithstanding any such assignment, the Village will not be released from its obligations under Section 5 of this Agreement.
- 9. **NO WAIVER OF TORT IMMUNITY**. Nothing contained in this Agreement will constitute a waiver by the Village of any right, privilege or defense which it has under statutory or common law, included but not limited to the Illinois Governmental and Governmental Employees Tort Immunity Act, 745 ILCS 10.
- 10. **ENTIRE AGREEMENT/AMENDMENT**. This instrument contains the entire agreement between the Parties relating to the rights granted herein and the obligations herein assumed. This Agreement may be modified, amended or annulled only by the written agreement of Owner and the Village.
- 11. **EXHIBITS**. Exhibits A and B attached to this Agreement are incorporated herein and made a part hereof by this reference.
- 12. **SEVERABILITY**. Invalidation by judgment or court order of any one or more of the covenants or restrictions contained herein will in no way affect any other provisions which will remain in full force and effect.
- 13. <u>CAPTIONS AND PARAGRAPH HEADINGS</u>. Captions and paragraph headings are for convenience only and are not a part of this Agreement and will not be used in construing it.
- 14. <u>NOTICES.</u> All notices provided for herein will be served upon the Parties by personal delivery, overnight courier or Certified United States mail, return receipt requested, at the following locations, or at such other location or locations as the Parties may from time to time designate in writing:

### Notice to the Village:

Village of East Dundee Attn: Village Administrator 120 Barrington Avenue East Dundee, Illinois 60118

### **Notice to Owner:**

102 River Street LLC Attn: Steve Straub 12N345 Coombs Road Elgin, Illinois 60124

Notices will be deemed given when received by the Party to whom it was sent.

15. **NO THIRD PARTY BENEFICIARIES**. This Agreement is entered into solely for the benefit of the Parties, and nothing in this Agreement is intended, either expressly or impliedly,

to provide any right or benefit of any kind whatsoever to any person and entity who is not a party to this Agreement or to acknowledge, establish, or impose any legal duty to any third party.

**IN WITNESS WHEREOF**, the Parties hereto have caused this instrument to be executed on the date first above written.

### **OWNER:**

**102 RIVER STREET LLC**, an Illinois limited liability company

Steve Straub, Manager

**VILLAGE:** 

**VILLAGE OF EAST DUNDEE:** 

By: 4080

	ACKNOWLEDGMENTS
	STATE OF ILLINOIS )
	COUNTY OF KANE )
Fra	This instrument was acknowledged before me on
	SEAL
	My Commission expires: 3/33/37  OFFICIAL SEAL FRANCO BOTTALICO NOTARY PUBLIC. STATE OF ILLINOIS MY COMMISSION EXPIRES: 03:23/2027
	STATE OF ILLINOIS )
	COUNTY OF KANE )
	This instrument was acknowledged before me on July 9, 2024, by Steve Straub known to me to be the Manager of 102 River Street LLC and the person whose name is subscribed to the foregoing instrument and who did acknowledge that he executed the above instrument voluntarily and as his free act and deed.
	Mary a. Comes lay Signature of Notary
	My Commission expires: January 31, 2028  OFFICIAL SEAL MARY A COMISKEY Notary Public, State of Illinois Commission No. 986376 My Commission Expires January 31, 2028

### **EXHIBIT A**


### **Legal Description of the Subject Property**

THE SOUTH HALF OF LOT 6 (EXCEPT THE WEST 30 FEET THEREOF) AND THE SOUTH HALF OF LOT 7 IN BLOCK 2 OF EAST DUNDEE, IN THE SOUTHWEST 1/4 OF SECTION 23, TOWNSHIP 42 NORTH, RANGE 8 EAST OF THE THIRD PRINCIPAL MERIDIAN, IN THE VILLAGE OF EAST DUNDEE, KANE COUNTY, ILLINOIS.

Commonly known as 102 N. River Street, East Dundee, Illinois. PIN: 03-23-320-005

EXHIBIT B

DEPICTION OF TEMPORARY CONSTRUCTION EASEMENT

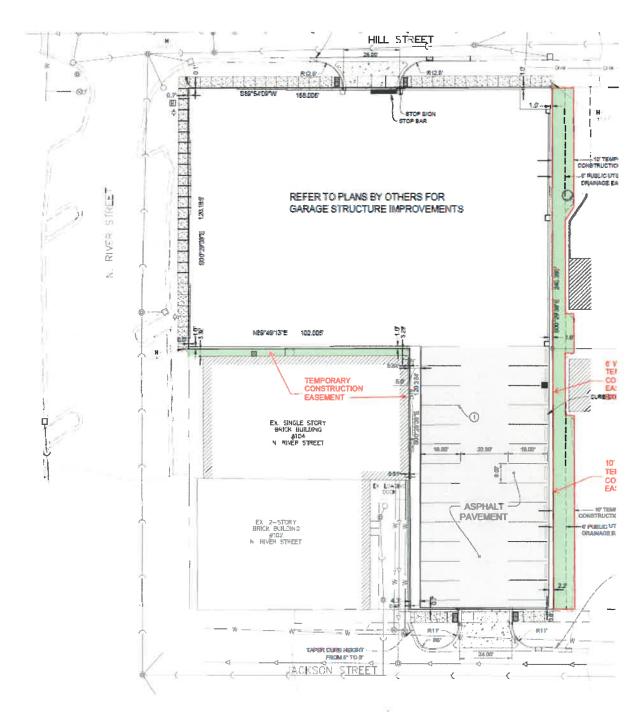

PREPARED BY AND AFTER RECORDING RETURN TO:

Lisa Starcevich Elrod Friedman LLP 325 North LaSalle Street Suite 450 Chicago, IL 60654

### TEMPORARY CONSTRUCTION EASEMENT AGREEMENT (104-106 N. River Street, East Dundee, IL)

THIS TEMPORARY CONSTRUCTION EASEMENT AGREEMENT (the "Agreement") is dated as of this \_\_\_\_\_\_ day of \_\_\_\_\_\_\_ 2024 (the "Effective Date"), by and between the VILLAGE OF EAST DUNDEE, an Illinois home-rule municipal corporation (the "Village"), and DESAI AND DAUGHTERS LLC, an Illinois limited liability company ("Owner"), which hereinafter may be referred together as the "Parties" or individually as a "Party."

**WHEREAS,** Owner is the sole fee simple owner of certain real property situated at 104-106 N. River Street, East Dundee, County of Kane, State of Illinois, which real estate is legally described in *Exhibit A* attached hereto, and by this reference, made a part hereof (the "*Subject Property*"); and

**WHEREAS**, the Village recently acquired title to the parcel of real estate adjacent to the Subject Property, commonly known as 304 Hill Street and 309 Jackson Street, East Dundee, Illinois (the "Village Property"), and is in the process of constructing a parking garage and related improvements on the Village Property (the "Garage Project"); and

**WHEREAS**, the Village requires a temporary construction easement in, on, upon, over, and across a portion of the Subject Property for access to the Village Property, and for construction staging, and other construction-related purposes as the Village reasonably deems necessary or desirable in connection with the Garage Project; and

**WHEREAS**, Owner has agreed to grant to the Village a temporary construction easement on the Subject Property pursuant to the terms and conditions set forth in this Agreement.

**NOW, THEREFORE,** in consideration of the mutual covenants and agreements set forth herein and under the Village's home rule powers, the Parties hereto agree as follows:

1. **RECITALS.** The foregoing recitals are incorporated herein by reference as though

fully set forth.

- 2. **TEMPORARY CONSTRUCTION EASEMENT** Owner grants, conveys, warrants, and dedicates to the Village a temporary easement upon, under, that portion of the Subject Property depicted on **Exhibit B** attached hereto (the "**Temporary Easement Premises**"), together with all reasonable rights of ingress and egress over, along, across, and upon the Subject Property for use by the Village, its general contractor and subcontractors for construction staging, and other construction-related purposes as the Village reasonably deems necessary or desirable in connection with the Garage Project, subject to the terms and conditions of this Agreement (the "**Temporary Easement**"). The Temporary Easement Premises is approximately 3.32 feet wide along the northern boundary of the Subject Property and 0.64' feet wide along the eastern boundary of the Subject Property. Owner reserves the right of access to and use of the Temporary Easement Premises in any manner not inconsistent with the rights granted to the Village under this Agreement. Upon termination of the Term (as hereinafter defined), Village, or its successor or assigns, hereby agrees to return the Temporary Easement Premises to substantially the same condition as of the Effective Date.
- 3. <u>TERM OF TEMPORARY EASEMENT</u>. The Temporary Easement is for a term commencing on the Effective Date and expiring on May 31, 2025 (the "*Term*"). The Term may be extended by mutual agreement by the Parties.
- 4. **LIENS.** The Village will not permit or suffer any lien to be imposed upon or to accrue against Owner, the Subject Property or the Temporary Easement Premises. The Village will indemnify, defend and hold harmless Owner from and against any liens and encumbrances arising out of any labor or services performed by or at the direction of, or materials furnished to, the Village or any parties claiming by, through or under the Village. In the event that any such lien will arise or accrue against the Owner, the Subject Property or the Temporary Easement Premises, the Village will promptly cause such lien to be released of record by payment thereof or posting a bond in a form and amount which is reasonably satisfactory to Owner.
- 5. <u>INDEMNIFICATION.</u> The Village agrees to indemnify, appear, defend and save Owner harmless from and against any and all liabilities, claims, losses, judgments, demands, and costs (including reasonable attorneys' fees and court costs actually incurred) for personal injury or property damage arising out of or caused by any act or omission of the Village, any of its contractors or subcontractors, anyone directly or indirectly employed or engaged by any of them, or anyone for whose acts any of them may be liable, arising from the Village's exercise or use of the easement rights granted under this Agreement. Village expressly understands and agrees that any insurance policies required by this Agreement shall in no way limit the responsibility to indemnify, keep and save harmless and defend Owner, as herein provided.
- 6. **INSURANCE.** The Village will maintain, and will require any of its contractors to maintain liability insurance in reasonable amounts, and with reputable companies, to protect Owner and the Village against claims arising directly or indirectly out of or in connection with the Village's use of the Temporary Easement Premises or Subject Property pursuant to this Agreement.
- 7. COVENANTS RUNNING WITH THE LAND. The easement and rights granted in this Agreement, the restrictions imposed by this Agreement, and the agreements and covenants contained in this Agreement will be easements, rights, restrictions, agreements and covenants running with the land, will be recorded against the Subject Property and will be binding upon and inure to the benefit of Owner and the Village and their respective heirs, executors, administrators, successors, assigns, agents, licensees, invitees, and representatives, including, without

limitation, all subsequent owners of the Subject Property, or any portion thereof, and all persons claiming under them.

- 8. **ASSIGNMENT OF RIGHTS.** Owner agrees that the Village may assign its rights or delegate its duties under this Agreement to any assignee: (a) who is reasonably competent to exercise the rights granted herein and the obligations imposed herein; and (b) who makes adequate assurances to the Owners that any activity performed pursuant to such assignment or delegation will be conducted in a good and workmanlike manner; and (c) who otherwise attests in writing to comply with the terms of this Agreement. Notwithstanding any such assignment, the Village will not be released from its obligations under Section 5 of this Agreement.
- 9. **NO WAIVER OF TORT IMMUNITY**. Nothing contained in this Agreement will constitute a waiver by the Village of any right, privilege or defense which it has under statutory or common law, included but not limited to the Illinois Local Governmental and Governmental Employees Tort Immunity Act, 745 ILCS 10.
- 10. **ENTIRE AGREEMENT/AMENDMENT**. This instrument contains the entire agreement between the Parties relating to the rights granted herein and the obligations herein assumed. This Agreement may be modified, amended or annulled only by the written agreement of Owner and the Village.
- 11. **EXHIBITS**. Exhibits A and B attached to this Agreement are incorporated herein and made a part hereof by this reference.
- 12. **SEVERABILITY.** Invalidation by judgment or court order of any one or more of the covenants or restrictions contained herein will in no way affect any other provisions which will remain in full force and effect.
- 13. <u>CAPTIONS AND PARAGRAPH HEADINGS</u>. Captions and paragraph headings are for convenience only and are not a part of this Agreement and will not be used in construing it.
- 14. **NOTICES.** All notices provided for herein will be served upon the Parties by personal delivery, overnight courier or Certified United States mail, return receipt requested, at the following locations, or at such other location or locations as the Parties may from time to time designate in writing:

### Notice to the Village:

Village of East Dundee Attn: Village Administrator 120 Barrington Avenue East Dundee, Illinois 60118

### **Notice to Owner:**

Desai and Daughters LLC Attn: Amish Desai 1323 Caribou Trail Carol Stream, Illinois 60188

Notices will be deemed given when received by the Party to whom it was sent.

15. **NO THIRD PARTY BENEFICIARIES**. This Agreement is entered into solely for the benefit of the Parties, and nothing in this Agreement is intended, either expressly or impliedly, to provide any right or benefit of any kind whatsoever to any person and entity who is not a party to this Agreement or to acknowledge, establish, or impose any legal duty to any third party.

**IN WITNESS WHEREOF,** the Parties hereto have caused this instrument to be executed on the date first above written.

**OWNER:** 

**DESAI AND DAUGHTERS LLC**, an Illinois limited liability company

Amish Desai, Manager

**VILLAGE:** 

**VILLAGE OF EAST DUNDEE:** 

By: Will

<u>ACKNOWLEDGMENTS</u>	
STATE OF ILLINOIS )	
COUNTY OF KANE )	
This instrument was acknowledged from the state of the st	before me on, 2024, by, 2024, by, 2024, by, the Village Clerk of said municipal corporation.
Signatu	re of Notary
SEAL	
My Commission agricus 3/23	/27
My Commission expires: 5/ 23/	OFFICIAL SEAL FRANCO BOTTALICO NOTARY PUBLIC, STATE OF ILLINOIS MY COMMISSION EXPIRES: 03/23/2027
STATE OF ILLINOIS )	
COUNTY OF KANE )	
and the person whose name is subscrib	before me on
Signatur	re of Notary
SEAL	
My Commission expires: 3/23/	27
	OFFICIAL SEAL

OFFICIAL SEAL FRANCO BOTTALICO NOTARY PUBLIC, STATE OF ILLINOIS MY COMMISSION EXPIRES: 03/23/2027

### **EXHIBIT A**


### **Legal Description of the Subject Property**

THE NORTH ½ OF LOT 6 (EXCEPT THE WEST 30 FEET) AND THE NORTH ½ OF LOT 7 IN BLOCK 2 OF EAST DUNDEE, IN THE VILLAGE OF EAST DUNDEE, KANE COUNTY, ILLINOIS.

Commonly known as 104-106 N. River Street, East Dundee, Illinois 60118 PIN: 03-23-320-004

EXHIBIT B

DEPICTION OF TEMPORARY CONSTRUCTION EASEMENT

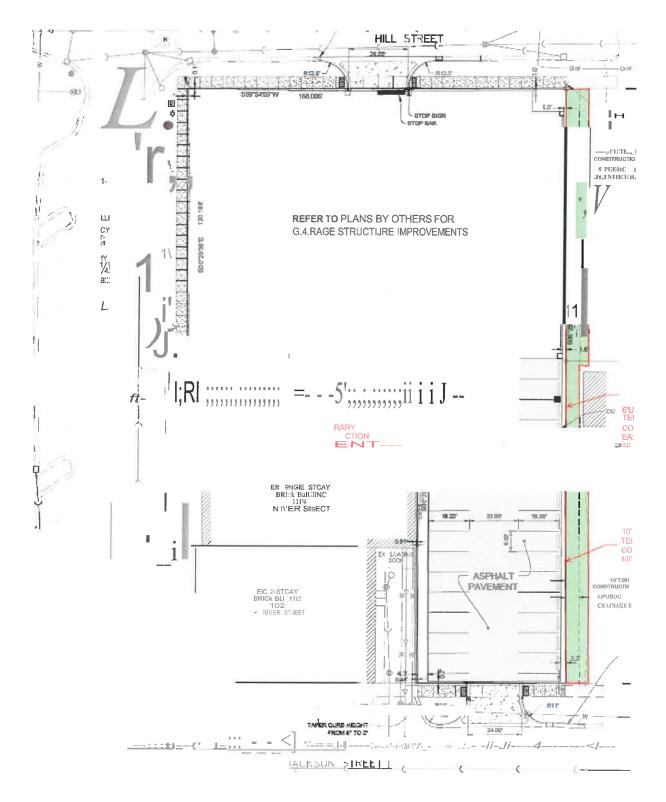

PREPARED BY AND
AFTER RECORDING
RETURN TO:
Lisa Starcevich
Elrod Friedman LLP
325 North LaSalle Street
Suite 450
Chicago, IL 60654

### NON-EXCLUSIVE PERMANENT PUBLIC UTILITY AND DRAINAGE EASEMENT AND TEMPORARY CONSTRUCTION EASEMENT AGREEMENT (107 N. Van Buren, East Dundee, IL)

THIS NON-EXCLUSIVE PERMANENT PUBLIC UTILITY AND DRAINAGE EASEMENT AND TEMPORARY CONSTRUCTION EASEMENT AGREEMENT (the "Agreement") is dated as of this \_\_\_\_\_\_\_\_ day of \_\_\_\_\_\_\_\_\_ 2024 (the "Effective Date"), by and between the VILLAGE OF EAST DUNDEE, an Illinois home-rule municipal corporation (the "Village"), and JOHN MICHAEL BEASELY AND MARY JO BEASLEY (collectively, "Owner"), which hereinafter may be referred together as the "Parties" or individually as a "Party."

WHEREAS, Owner is the sole fee simple owner of certain real property situated at 107 N. Van Buren, East Dundee, County of Kane, State of Illinois, which real estate is legally described in *Exhibit A* attached hereto, and by this reference, made a part hereof (the "Subject Property"); and

**WHEREAS**, the Village recently acquired title to the parcel of real estate adjacent to the Subject Property, commonly known as 304 Hill Street and 309 Jackson Street, East Dundee, Illinois (the "Village Property"), and is in the process of constructing a parking garage and related improvements on the Village Property (the "Garage Project"); and

**WHEREAS**, the Village requires a permanent easement and use of that portion of the Subject Property, as depicted on *Exhibit B*, in order to construct, operate, and maintain certain stormwater and sewer improvements on the Subject Property; and

WHEREAS, the Village also requires a temporary construction easement in, on, upon, over, and across a portion of the Subject Property for access to the Village Property, and for construction staging, and other construction-related purposes as the Village reasonably deems necessary or desirable in connection with the Garage Project; and

WHEREAS, Owner has agreed to grant the easements to the Village and to permit the

Village's construction, operation, and maintenance of stormwater improvements and appurtenances on the Subject Property pursuant to the terms and conditions set forth in this Agreement.

**NOW, THEREFORE,** in consideration of the mutual covenants and agreements set forth herein and under the Village's home rule powers, the Parties hereto agree as follows:

- 1. **RECITALS.** The foregoing recitals are incorporated herein by reference as though fully set forth.
- 2. **GRANT AND USE OF PERMANENT EASEMENT.** Owner grants, conveys, warrants, and dedicates to the Village a 6' wide perpetual, non-exclusive easement upon, under, and across that portion of the Subject Property depicted on **Exhibit B**, attached hereto, and by this reference, made a part hereof (the "**Permanent Easement Premises**") to survey, construct, install, operate, use, maintain, own, test, inspect, repair, and remove and replace certain stormwater and storm sewer improvements, drainage and swales, together with manholes and such other related facilities, attachments, and equipment (the "**Facilities**") and all reasonable rights of ingress and egress over, along, across, and upon the Subject Property necessary for the exercise of the rights granted herein. The Village will retain sole ownership of the Facilities.
- 3. <u>TEMPORARY CONSTRUCTION EASEMENT</u> Owner grants, conveys, warrants, and dedicates to the Village a non-exclusive, temporary construction easement upon, under, that portion of the Subject Property depicted on *Exhibit C* (the "*Temporary Easement Premises*"), together with all reasonable rights of ingress and egress over, along, across, and upon the Subject Property necessary for construction staging, and other construction-related purposes as the Village reasonably deems necessary or desirable in connection with the Garage Project. The Temporary Easement will automatically terminate on May 31, 2025 ("*Temporary Easement Term*"); provided, however that the Temporary Easement Term may be extended by written notice from the Village to Owner, for a reasonable time if the Village is in compliance with the provisions of this Agreement at the time of expiration.

The Permanent Easement Premises and Temporary Easement Premises are referred to collectively as the "*Easement Premises*."

- 4. **EASEMENT CONDITIONS**. The grant of easements and ancillary rights given to the Village under this Agreement will be subject to the following conditions:
  - (a) Owner reserves the right of access to and use of the Easement Premises in any manner not inconsistent with the rights granted to the Village under this Agreement, including but not limited to the right to install landscaping, gardens, shrubs and fencing on the Easement Premises that do not then or later conflict with the Facilities or the easement rights granted hereunder;
  - (b) The Village will notify Owner prior to commencement of any excavation, construction, repair, maintenance or other work or activity on the Easement Premises. The Parties will reasonably cooperate with respect to the commencement, timing, and location of such work or activity so as to avoid any interference with the Owner's use of the Subject Property or the Easement Premises:

- (c) All construction or other work or activity by any entity within the Easement Premises will be performed in a safe and sound manner and in accordance with all applicable federal, state and local laws;
- (d) The Village will clear the Easement Premises prior to and during installation of the Facilities, including removal of existing trees and shrubbery. The Village will be responsible for the payment of all costs associated with any work or activity performed on the Easement Premises pursuant to the grant of easement set forth in Paragraph 2 above;
- (e) The Village will construct a 6' vinyl privacy screening fence on the Village Property along the surface lot on the east side of the Village Property after the expiration of the Temporary Easement Term;
- (f) The Village will apply for fence variances necessary to increase the height of the vinyl privacy screening fence being installed on the Village Property as set forth in subsection (e) above to 8'; and
- (g) In consideration of the grant of easements set forth in this Agreement, the Village agrees to pay Owner \$5,000.00 within 90 days of the Effective Date of this Agreement for Owner to use to install a fence, trees or shrubs as desired by Owner for screening purposes after the expiration of the Temporary Easement Term. Such installation shall be in compliance with Section 4(a) above and with all applicable laws and ordinances. The Village will have no restoration or repair obligations in connection with the Easement Premises and the Village is not responsible for restoring, repairing, or replacing any shrubs or trees in the Easement Premises.
- 5. MAINTENANCE AND REPAIR OF FACILITIES. The Village will maintain the Facilities in good working order and repair, and in compliance with applicable federal, state and local law. In the event that Owner determines that the Village is not in compliance with the terms of this Paragraph 5, Owner will provide the Village written notice of said non-compliance. Upon receipt of said written notice, the Village will have 30 days to commence reasonable measures to cure said non-compliance. Notwithstanding the above 30-day cure period, the Village will take immediate action to cure said non-compliance in the case of an emergency likely to cause immediate harm, damage or danger to surrounding property or to the public or private health, safety or welfare. In the event the Village fails to commence reasonable measures to cure said non-compliance at the expiration of the periods set forth herein, or otherwise exhibits an unwillingness to cure said non-compliance, Owner will have the right, but not the obligation, to take all steps necessary to bring the Facilities into good working order and repair and in compliance with all applicable federal, state and local laws, and the Village will be responsible for all reasonable costs and expenses incurred by Owner in connection with same, including reasonable attorneys' fees.
- 6. <u>LIENS</u>. The Village will not permit or suffer any lien to be imposed upon or to accrue against Owner, the Subject Property or the Easement Premises. The Village will indemnify, defend and hold harmless Owner from and against any liens and encumbrances arising out of any labor or services performed by or at the direction of, or materials furnished to, the Village or any parties claiming by, through or under the Village. In the event that any such lien will arise or accrue against the Owner, the Subject Property or the Easement Premises, the Village will

promptly cause such lien to be released of record by payment thereof or posting a bond in a form and amount which is reasonably satisfactory to Owner.

- 7. <u>INDEMNIFICATION.</u> The Village agrees to indemnify, defend and save Owner harmless from and against any and all liabilities, claims, losses, or demands for personal injury or property damage arising out of or caused by any act or omission of the Village, any of its contractors or subcontractors, anyone directly or indirectly employed or engaged by any of them, or anyone for whose acts any of them may be liable, arising from the Village's conduct of the Easement Activities or exercise or use of the easement rights granted under this Agreement.
- 8. **INSURANCE.** The Village will maintain, and will require any of its contractors hired to perform any work on the Easement Premises, to maintain liability insurance in reasonable amounts, and with reputable companies, to protect Owner and the Village against claims arising directly or indirectly out of or in connection with the Village's conduct of the Easement Activities or use of the Easement Premises or Subject Property pursuant to this Agreement. The Village will name, or cause any contractor hired to perform any work on the Easement Premises to name, Owner, as an additional insured and upon request will provide to Owner a copy of a Certificate of Insurance evidencing this coverage.
- 9. **TERM.** Except as specifically set forth in Paragraph 3 above, this Agreement will be in full force and effect for so long as the Facilities are required for purposes of stormwater and storm sewer services.
- 10. <u>ADDITIONAL EASEMENTS</u>. Owner reserves the right to use the Easement Premises in any manner that will not prevent or interfere in any way with the exercise by the Village of the rights granted herein; provided, however, that Owner must not damage, destroy, or permanently or temporarily improve or obstruct the Easement Premises or cause any improvements or obstructions to be constructed on the Easement Premises that would impair the exercise by the Village of the rights granted in this Agreement, including without limitation, fences, bridges, piers, trees and other vegetation and underground sprinkler systems, which would obstruct the free-flowing drainage of the Easement Property or obstruct access to the Facilities, without the express prior written consent of the Village Administrator.
- 11. **COVENANTS RUNNING WITH THE LAND**. The easements and rights granted in this Agreement, the restrictions imposed by this Agreement, and the agreements and covenants contained in this Agreement will be easements, rights, restrictions, agreements and covenants running with the land, will be recorded against the Subject Property and will be binding upon and inure to the benefit of Owner and the Village and their respective heirs, executors, administrators, successors, assigns, agents, licensees, invitees, and representatives, including, without limitation, all subsequent owners of the Subject Property, or any portion thereof, and all persons claiming under them. If any of the easements, rights, restrictions, agreements, or covenants created by this Agreement would otherwise be unlawful or void for violation of (a) the rule against perpetuities or some analogous statutory provision, (b) the rule restricting restraints on alienation, or (c) any other statutory or common law rules imposing time limits, then such easements, rights, restrictions, agreements or covenants will continue only until 21 years after the death of the last survivor of the now living lawful descendants of J.B. Pritzker, current Governor of the State of Illinois.
- 12. <u>ASSIGNMENT OF RIGHTS</u>. Owner agrees that the Village may assign its rights or delegate its duties under this Agreement to any assignee: (a) who is reasonably competent to exercise the rights granted herein and the obligations imposed herein; and (b) who makes

adequate assurances to the Owners that any activity performed pursuant to such assignment or delegation will be conducted in a good and workmanlike manner; and (c) who otherwise attests in writing to comply with the terms of this Agreement. Notwithstanding any such assignment, the Village will not be released from its obligations under Section 7 of this Agreement.

- 13. NO WAIVER OF TORT IMMUNITY. Nothing contained in this Agreement will constitute a waiver by the Village of any right, privilege or defense which it has under statutory or common law, included but not limited to the Illinois Governmental and Governmental Employees Tort Immunity Act, 745 ILCS 10.
- 14. <u>ENTIRE AGREEMENT/AMENDMENT</u>. This instrument contains the entire agreement between the Parties relating to the rights granted herein and the obligations herein assumed. This Agreement may be modified, amended or annulled only by the written agreement of Owner and the Village.
- 15. **EXHIBITS**. Exhibits A and B attached to this Agreement are incorporated herein and made a part hereof by this reference.
- 16. <u>SEVERABILITY</u>. Invalidation by judgment or court order of any one or more of the covenants or restrictions contained herein will in no way affect any other provisions which will remain in full force and effect.
- 17. **CAPTIONS AND PARAGRAPH HEADINGS**. Captions and paragraph headings are for convenience only and are not a part of this Agreement and will not be used in construing it.
- 18. **NOTICES.** All notices provided for herein will be served upon the Parties by personal delivery, overnight courier or Certified United States mail, return receipt requested, at the following locations, or at such other location or locations as the Parties may from time to time designate in writing:

#### Notice to the Village:

Village of East Dundee Attn: Village Administrator 120 Barrington Avenue East Dundee, Illinois 60118

#### **Notice to Owner:**

John Michael & Mary Jo Beasley 107 N. Van Buren East Dundee. IL 60018

Notices will be deemed given when received by the Party to whom it was sent.

19. **NO THIRD PARTY BENEFICIARIES**. This Agreement is entered into solely for the benefit of the Parties, and nothing in this Agreement is intended, either expressly or impliedly, to provide any right or benefit of any kind whatsoever to any person and entity who is not a party to this Agreement or to acknowledge, establish, or impose any legal duty to any third party.

**IN WITNESS WHEREOF**, the Parties hereto have caused this instrument to be executed on the date first above written.

**OWNER:** 

John Michael Beasley

Mary Jo Beasley

**VILLAGE:** 

**VILLAGE OF EAST DUNDEE:** 

Ву: 928

	ACKNOWLEDGMENTS				
	STATE OF ILLINOIS )				
	COUNTY OF KANE )				
Fran	This instrument was acknowledged before me on				
	SEAL				
	My Commission expires: March 33, 263-7  OFFICIAL SEAL  FRANCO BOTTALICO  NOTARY PUBLIC, STATE OF ILLINOIS  MY COMMISSION EXPIRES: 03/23/2027				
	STATE OF ILLINOIS ) COUNTY OF KANE )				
	This instrument was acknowledged before me on				
	Signature of Notary				
	SEAL  My Commission expires:  March 23, 2027  MY COMMISSION EXPIRES: 03/23/2027				

# **EXHIBIT A**

# Legal Description of the Subject Property

THE NORTHERLY HALF OF LOTS 9 AND 10 IN BLOCK 2 OF EAST DUNDEE, IN THE VILLAGE OF EAST DUNDEE, KANE COUNTY, ILLINOIS.

Commonly known as 107 N. Van Buren, East Dundee, Illinois.

PIN: 03-23-320-007-0000

# EXHIBIT B DEPICTION OF PERMANENT EASEMENT PREMISES


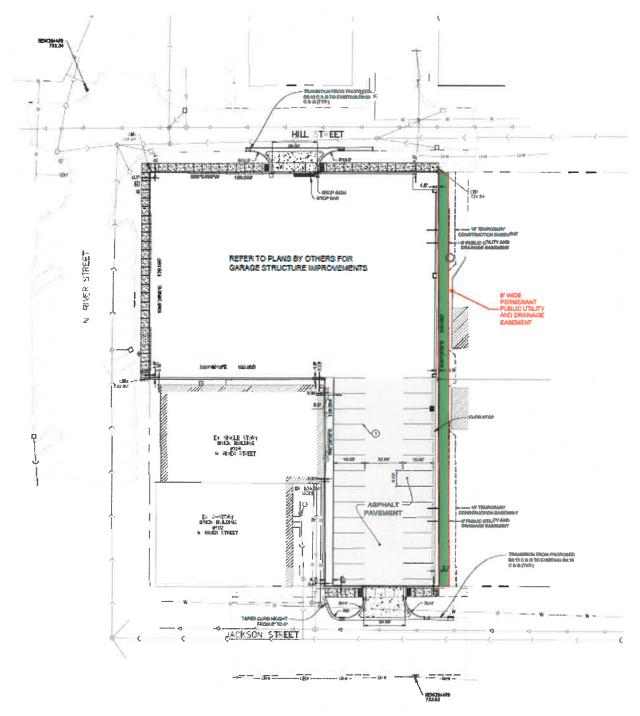


EXHIBIT C
DEPICTION OF TEMPORARY EASEMENT PREMISES

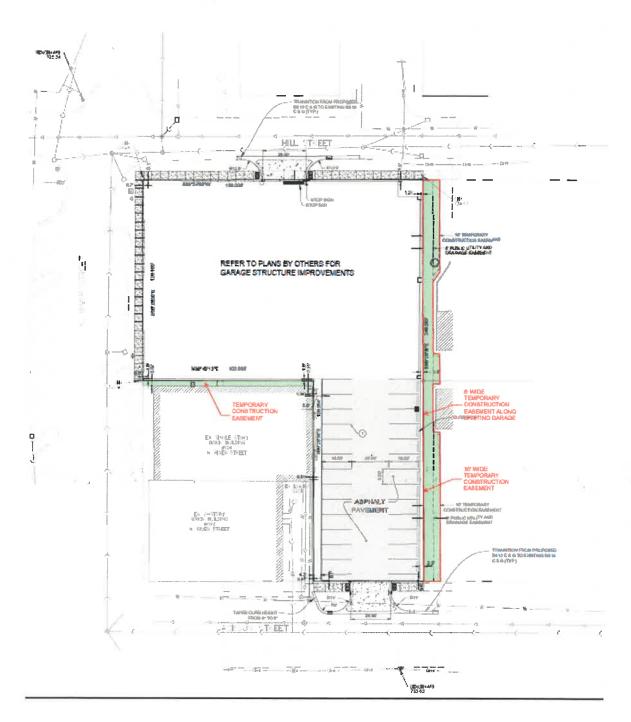

PREPARED BY AND AFTER RECORDING RETURN TO: Lisa Starcevich Elrod Friedman LLP 325 North LaSalle Street Suite 450 Chicago, IL 60654

# NON-EXCLUSIVE PERMANENT PUBLIC UTILITY AND DRAINAGE EASEMENT AND TEMPORARY CONSTRUCTION EASEMENT AGREEMENT (308 Hill Street, East Dundee, IL)

WHEREAS, Owner is the sole fee simple owner of certain real property situated at 308 Hill Street, East Dundee, County of Kane, State of Illinois, which real estate is legally described in *Exhibit A* attached hereto, and by this reference, made a part hereof (the "*Subject Property*"); and

WHEREAS, the Village recently acquired title to the parcel of real estate adjacent to the Subject Property, commonly known as 304 Hill Street and 309 Jackson Street, East Dundee, Illinois (the "Village Property"), and is in the process of constructing a parking garage and related improvements on the Village Property (the "Garage Project"); and

**WHEREAS**, the Village requires a permanent easement and use of that portion of the Subject Property, as depicted on *Exhibit B*, in order to construct, operate, and maintain certain stormwater and sewer improvements on the Subject Property; and

WHEREAS, the Village also requires a temporary construction easement in, on, upon, over, and across a portion of the Subject Property for access to the Village Property, and for construction staging, and other construction-related purposes as the Village reasonably deems necessary or desirable in connection with the Garage Project; and

WHEREAS, Owner has agreed to grant the easements to the Village and to permit the

Village's construction, operation, and maintenance of stormwater improvements and appurtenances on the Subject Property pursuant to the terms and conditions set forth in this Agreement.

NOW, THEREFORE, in consideration of the mutual covenants and agreements set forth herein and under the Village's home rule powers, the Parties hereto agree as follows:

- 1. <u>RECITALS.</u> The foregoing recitals are incorporated herein by reference as though fully set forth.
- 2. **GRANT AND USE OF PERMANENT EASEMENT.** Owner grants, conveys, warrants, and dedicates to the Village a 6' wide perpetual, non-exclusive easement upon, under, and across that portion of the Subject Property depicted on *Exhibit B*, attached hereto, and by this reference, made a part hereof (the "*Permanent Easement Premises*") to survey, construct, install, operate, use, maintain, own, test, inspect, repair, and remove and replace certain stormwater and storm sewer improvements, drainage and swales, together with manholes and such other related facilities, attachments, and equipment (the "*Facilities*") and all reasonable rights of ingress and egress over, along, across, and upon the Subject Property necessary for the exercise of the rights granted herein.
- 3. <u>TEMPORARY CONSTRUCTION EASEMENT</u> Owner grants, conveys, warrants, and dedicates to the Village a non-exclusive, temporary construction easement upon, under, that portion of the Subject Property depicted on *Exhibit C* (the "*Temporary Easement Premises*"), together with all reasonable rights of ingress and egress over, along, across, and upon the Subject Property necessary for construction staging, and other construction-related purposes as the Village reasonably deems necessary or desirable in connection with the Garage Project and removal of the Additional Trees (as defined in Section 4(d) below). The Temporary Easement will automatically terminate on May 31, 2025 ("*Temporary Easement Term*"); provided, however that the Temporary Easement Term may be extended by written notice from the Village to Owner, for a reasonable time if the Village is in compliance with the provisions of this Agreement at the time of expiration.

The Permanent Easement Premises and Temporary Easement Premises are referred to collectively as the "Easement Premises."

- 4. **EASEMENT CONDITIONS**. The grant of easements and ancillary rights given to the Village under this Agreement will be subject to the following conditions:
  - (a) Owner reserves the right of access to and use of the Easement Premises in any manner not inconsistent with the rights granted to the Village under this Agreement, including but not limited to the right to install landscaping, gardens, shrubs and fencing on the Easement Premises that do not then or later conflict with the Facilities or the easement rights granted hereunder;
  - (b) The Village will notify Owner prior to commencement of any excavation, construction, repair, maintenance or other work or activity on the Easement Premises. The Parties will reasonably cooperate with respect to the commencement, timing, and location of such work or activity so as to avoid any interference with the Owner's use of the Subject Property or the Easement

#### Premises;

- (c) All construction or other work or activity by any entity within the Easement Premises will be performed in a safe and sound manner and in accordance with all applicable federal, state and local laws;
- (d) The Village will clear the Easement Premises prior to and during installation of the Facilities, including removal of existing trees and shrubbery in the Easement Premises and removal of two additional trees on the Subject Property (not in the Easement Area) as depicted on *Exhibit D* attached hereto (the "Additional Trees"). The Village will be responsible for the payment of all costs associated with any work or activity performed on the Easement Premises pursuant to the grant of easement set forth in Paragraph 2 above; and
- (e) In consideration of the grant of easements set forth in this Agreement, the Village agrees to pay Owner \$9,000.00 within 90 days of the Effective Date of this Agreement for Owner to use to install a fence, trees or shrubs as desired by Owner for screening purposes after the expiration of the Temporary Easement Term. Such installation shall be in compliance with Section 4(a) above and with all applicable laws and ordinances. The Village will have no restoration or repair obligations in connection with the Easement Premises and the Village is not responsible for restoring, repairing, or replacing any shrubs or trees (including the Additional Trees) on the Subject Property or in the Easement Premises.
- MAINTENANCE AND REPAIR OF FACILITIES. The Village will maintain the Facilities in good working order and repair, and in compliance with applicable federal, state and local law. In the event that Owner determines that the Village is not in compliance with the terms of this Paragraph 5, Owner will provide the Village written notice of said non-compliance. Upon receipt of said written notice, the Village will have 30 days to commence reasonable measures to cure said non-compliance. Notwithstanding the above 30-day cure period, the Village will take immediate action to cure said non-compliance in the case of an emergency likely to cause immediate harm, damage or danger to surrounding property or to the public or private health, safety or welfare. In the event the Village fails to commence reasonable measures to cure said non-compliance at the expiration of the periods set forth herein, or otherwise exhibits an unwillingness to cure said non-compliance, Owner will have the right, but not the obligation, to take all steps necessary to bring the Facilities into good working order and repair and in compliance with all applicable federal, state and local laws, and the Village will be responsible for all reasonable costs and expenses incurred by Owner in connection with same, including reasonable attorneys' fees.
- 6. <u>LIENS.</u> The Village will not permit or suffer any lien to be imposed upon or to accrue against Owner, the Subject Property or the Easement Premises. The Village will indemnify, defend and hold harmless Owner from and against any liens and encumbrances arising out of any labor or services performed by or at the direction of, or materials furnished to, the Village or any parties claiming by, through or under the Village. In the event that any such lien will arise or accrue against the Owner, the Subject Property or the Easement Premises, the Village will promptly cause such lien to be released of record by payment thereof or posting a bond in a form and amount which is reasonably satisfactory to Owner.
- 7. **INDEMNIFICATION.** The Village agrees to indemnify, defend and save Owner harmless from and against any and all liabilities, claims, losses, or demands for personal injury or property

damage arising out of or caused by any act or omission of the Village, any of its contractors or subcontractors, anyone directly or indirectly employed or engaged by any of them, or anyone for whose acts any of them may be liable, arising from the Village's conduct of the Easement Activities or exercise or use of the easement rights granted under this Agreement.

- 8. <u>INSURANCE</u>. The Village will maintain, and will require any of its contractors hired to perform any work on the Easement Premises, to maintain liability insurance in reasonable amounts, and with reputable companies, to protect Owner and the Village against claims arising directly or indirectly out of or in connection with the Village's conduct of the Easement Activities or use of the Easement Premises or Subject Property pursuant to this Agreement. The Village will name, or cause any contractor hired to perform any work on the Easement Premises to name, Owner, as an additional insured and upon request will provide to Owner a copy of a Certificate of Insurance evidencing this coverage.
- 9. <u>TERM.</u> Except as specifically set forth in Paragraph 3 above, this Agreement will be in full force and effect for so long as the Facilities are required for purposes of stormwater and storm sewer services.
- 10. <u>ADDITIONAL EASEMENTS</u>. Owner reserves the right to use the Easement Premises in any manner that will not prevent or interfere in any way with the exercise by the Village of the rights granted herein; provided, however, that Owner must not damage, destroy, or permanently or temporarily improve or obstruct the Easement Premises or cause any improvements or obstructions to be constructed on the Easement Premises that would impair the exercise by the Village of the rights granted in this Agreement, including without limitation, fences, bridges, piers, trees and other vegetation and underground sprinkler systems, which would obstruct the free-flowing drainage of the Easement Property or obstruct access to the Facilities, without the express prior written consent of the Village Administrator.
- 11. COVENANTS RUNNING WITH THE LAND. The easements and rights granted in this Agreement, the restrictions imposed by this Agreement, and the agreements and covenants contained in this Agreement will be easements, rights, restrictions, agreements and covenants running with the land, will be recorded against the Subject Property and will be binding upon and inure to the benefit of Owner and the Village and their respective heirs, executors, administrators, successors, assigns, agents, licensees, invitees, and representatives, including, without limitation, all subsequent owners of the Subject Property, or any portion thereof, and all persons claiming under them. If any of the easements, rights, restrictions, agreements, or covenants created by this Agreement would otherwise be unlawful or void for violation of (a) the rule against perpetuities or some analogous statutory provision, (b) the rule restricting restraints on alienation, or (c) any other statutory or common law rules imposing time limits, then such easements, rights, restrictions, agreements or covenants will continue only until 21 years after the death of the last survivor of the now living lawful descendants of J.B. Pritzker, current Governor of the State of Illinois.
- 12. <u>ASSIGNMENT OF RIGHTS</u>. Owner agrees that the Village may assign its rights or delegate its duties under this Agreement to any assignee: (a) who is reasonably competent to exercise the rights granted herein and the obligations imposed herein; and (b) who makes adequate assurances to the Owners that any activity performed pursuant to such assignment or delegation will be conducted in a good and workmanlike manner; and (c) who otherwise attests in writing to comply with the terms of this Agreement. Notwithstanding any such assignment, the Village will not be released from its obligations under Section 7 of this Agreement.

- 13. No WAIVER OF TORT IMMUNITY. Nothing contained in this Agreement will constitute a waiver by the Village of any right, privilege or defense which it has under statutory or common law, included but not limited to the Illinois Governmental and Governmental Employees Tort Immunity Act, 745 ILCS 10.
  - 14. <u>ENTIRE AGREEMENT/AMENDMENT</u>. This instrument contains the entire agreement between the Parties relating to the rights granted herein and the obligations herein assumed. This Agreement may be modified, amended or annulled only by the written agreement of Owner and the Village.
  - 15. **EXHIBITS.** Exhibits A through D attached to this Agreement are incorporated herein and made a part hereof by this reference.
- 16. <u>SEVERABILITY</u>. Invalidation by judgment or court order of any one or more of the covenants or restrictions contained herein will in no way affect any other provisions which will remain in full force and effect.
- 17. <u>CAPTIONS AND PARAGRAPH HEADINGS</u>. Captions and paragraph headings are for convenience only and are not a part of this Agreement and will not be used in construing it.
- 18. <u>NOTICES.</u> All notices provided for herein will be served upon the Parties by personal delivery, overnight courier or Certified United States mail, return receipt requested, at the following locations, or at such other location or locations as the Parties may from time to time designate in writing:

#### Notice to the Village:

Village of East Dundee Attn: Village Administrator 120 Barrington Avenue East Dundee, Illinois 60118

#### **Notice to Owner:**

Patrick O'Neil Property Group LLC Hill Attn: Patrick Sakolari 221 E. Chicago Street, #9 Elgin, Illinois 60120

Notices will be deemed given when received by the Party to whom it was sent.

19. **NO THIRD PARTY BENEFICIARIES.** This Agreement is entered into solely for the benefit of the Parties, and nothing in this Agreement is intended, either expressly or impliedly, to provide any right or benefit of any kind whatsoever to any person and entity who is not a party to this Agreement or to acknowledge, establish, or impose any legal duty to any third party.

IN WITNESS WHEREOF, the Parties hereto have caused this instrument to be executed on the date first above written.

OWNER:

PATRICK O'NEIL PROPERTY GROUP LLC HILL,

An Illinois limited liability company

Michelle Sakolari, Manager

**VILLAGE:** 

**VILLAGE OF EAST DUNDEE:** 

By: WX

	ACKNOWLEDGMENTS
	STATE OF ILLINOIS )
	COUNTY OF KANE )
Franco	This instrument was acknowledged before me on July (1, 2024, by Markettalia) acknowledged before me on Markettalia of the VILLAGE OF EAST DUNDEE, an Illinois municipal corporation.  Signature of Notary
	SEAL
	My Commission expires: 3/33/27  OFFICIAL SEAL FRANCO BOTTALICO NOTARY PUBLIC, STATE OF ILLINOIS MY COMMISSION EXPIRES: 03/23/2027
	STATE OF ILLINOIS )
	COUNTY OF KANE )
	This instrument was acknowledged before me on
	Anaukey A. Colombia OFFICIAL SEAL ANOUSONE S EAKIN NOTARY PUBLIC - STATE OF ILLINOIS MY COMMISSION EXPIRES 08.28 2024
	SEAL CA A 1 A TAIL
	My Commission expires: 8/38/3024

# **EXHIBIT A**

# Legal Description of the Subject Property

LOT 2 IN BLOCK 2 IN EAST DUNDEE, ON THE EAST SIDE OF FOX RIVER, IN KANE COUNTY, ILLINOIS.

Commonly known as 308 Hill Street, East Dundee, Illinois.

PIN: 03-23-320-002



EXHIBIT B

DEPICTION OF PERMANENT EASEMENT PREMISES

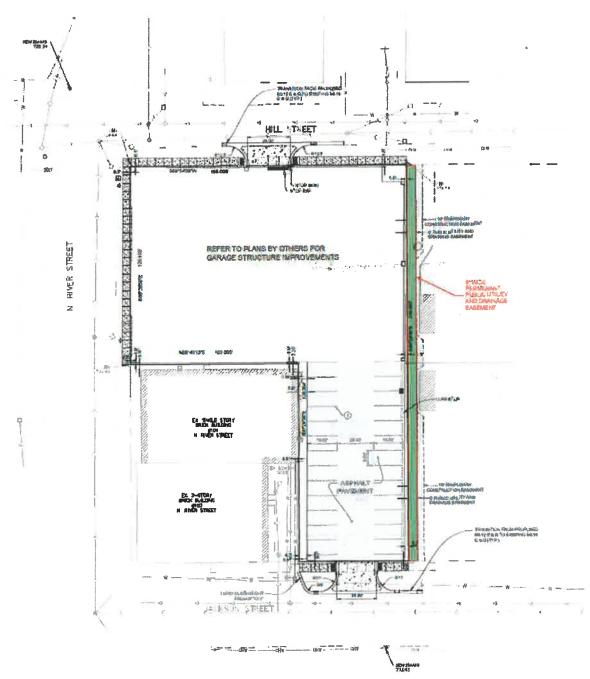


EXHIBIT C
DEPICTION OF TEMPORARY EASEMENT PREMISES

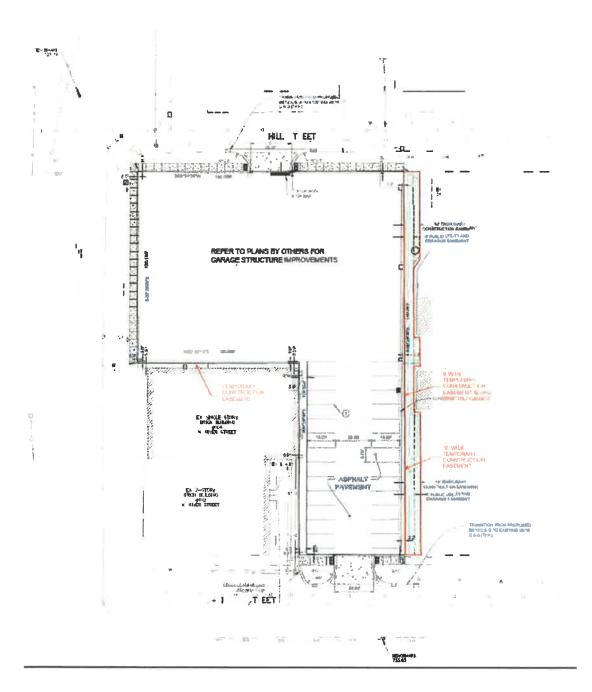


EXHIBIT D

ADDITIONALTREES ON SUBJECT PROPERTY TO BE REMOVED BY VILLAGE



# **MORTGAGEE'S CONSENT**

COUNTY OF KANE	) )SS
COUNTY OFKANE	)
above Non-Exclusive Permanent Construction Easement Agreement, Recorder of Deeds in Kane County, 2024K017923, it hereby consents to Utility and Drainage Easement and hereby subordinate its mortgage inte Illinois for the purposes and uses stated	at as a mortgagee of the real property legally described in the Public Utility and Drainage Easement and Temporary, which is under a mortgage recorded in the Office of the Illinois on May 29, 2024 and recorded as document number the granting of the above Non-Exclusive Permanent Public Temporary Construction Easement Agreement and does trest in the Easement Premises to the Village of East Dunder atted in the above grant of easements document.
Dated at	TLLINO 15, this May of JULY,
FOR MORTGAGEE:  // // // // // // // // // // // // //	SUP BANK, SSR
STATE OF) SS COUNTY OF _KANE)	
CERTIFY that Michael W 131 Senial Vice Presidents Con SSB, are known to me to be the sam Consent, appeared before me this da	and for said County, in the State aforesaid, DO HEREBY  (title) and  (title) of TBK Bank, he persons whose names are subscribed to the Mortgagee's ay in person and acknowledged that they signed, sealed their free and voluntary act, for the uses and purposes
	eal this <u>lith</u> day of <u>hely</u> , 2024.
Anayone S. Eato	_
Notary Public Commission Expires: _ 8/38/302	OFFICIAL SEAL ANOUSONE S EAKIN NOTARY PUBLIC - STATE OF ILLINOIS MY COMMISSION EXPIRES 08/28/2024

PREPARED BY AND AFTER RECORDING RETURN TO:

Lisa Starcevich Elrod Friedman LLP 325 North LaSalle Street Suite 450 Chicago, IL 60654



# TEMPORARY CONSTRUCTION EASEMENT AGREEMENT (311 Jackson Street, East Dundee, IL)

THIS TEMPORARY CONSTRUCTION EASEMENT AGREEMENT (the "Agreement") is dated as of this \_\_\_\_\_ day of \_\_\_\_\_ 2024 (the "Effective Date"), by and between the VILLAGE OF EAST DUNDEE, an Illinois home-rule municipal corporation (the "Village"), and the Brook B. Marshall Grantor Trust dated December 20, 2020 ("Owner"), which hereinafter may be referred together as the "Parties" or individually as a "Party."

WHEREAS, Owner is the sole fee simple owner of certain real property situated at 311 Jackson Street, East Dundee, County of Kane, State of Illinois, which real estate is legally described in *Exhibit A* attached hereto, and by this reference, made a part hereof (the "Subject Property"); and

**WHEREAS**, the Village recently acquired title to the parcel of real estate adjacent to the Subject Property, commonly known as 304 Hill Street and 309 Jackson Street, East Dundee, Illinois (the "Village Property"), and is in the process of constructing a parking garage and related improvements on the Village Property (the "Garage Project"); and

**WHEREAS**, the Village also requires a temporary construction easement in, on, upon, over, and across a portion of the Subject Property for access to the Village Property, and for construction staging, and other construction-related purposes as the Village reasonably deems necessary or desirable in connection with the Garage Project; and

WHEREAS, Owner has agreed to grant the temporary construction easement to the Village pursuant to the terms and conditions set forth in this Agreement.

**NOW, THEREFORE,** in consideration of the mutual covenants and agreements set forth herein and under the Village's home rule powers, the Parties hereto agree as follows:

 <u>RECITALS.</u> The foregoing recitals are incorporated herein by reference as though fully set forth.

- 2. <u>TEMPORARY CONSTRUCTION EASEMENT</u> Owner grants, conveys, warrants, and dedicates to the Village a 10' wide non-exclusive, temporary construction easement upon, under, that portion of the Subject Property depicted on *Exhibit B* (the "*Temporary Easement Premises*"), together with all reasonable rights of ingress and egress over, along, across, and upon the Subject Property necessary for construction staging, and other construction-related purposes as the Village reasonably deems necessary or desirable in connection with the Garage Project. The Temporary Easement will automatically terminate on May 31, 2025 ("*Temporary Easement Term*"); provided, however that the Temporary Easement Term may be extended by written notice from the Village to Owner, for a reasonable time if the Village is in compliance with the provisions of this Agreement at the time of expiration.
- 3. **EASEMENT CONDITIONS.** The grant of easements and ancillary rights given to the Village under this Agreement will be subject to the following conditions:
  - (a) Owner reserves the right of access to and use of the Temporary Easement Premises in any manner not inconsistent with the rights granted to the Village under this Agreement, including but not limited to the right to install landscaping, gardens, shrubs and fencing on the Temporary Easement Premises that do not then or later conflict with the easement rights granted hereunder;
  - (b) The Village will notify Owner prior to commencement of any construction, repair, maintenance or other work or activity on the Temporary Easement Premises. The Parties will reasonably cooperate with respect to the commencement, timing, and location of such work or activity so as to avoid any interference with the Owner's use of the Subject Property or the Temporary Easement Premises;
  - (c) All construction or other work or activity by any entity within the Temporary Easement Premises will be performed in a safe and sound manner and in accordance with all applicable federal, state and local laws;
  - (d) The Village will clear the Temporary Easement Premises, including removal of existing trees and shrubbery. The Village will be responsible for the payment of all costs associated with any work or activity performed on the Temporary Easement Premises pursuant to the grant of easement set forth in Paragraph 2 above;
  - (e) The Village will construct a 6' vinyl privacy screening fence on the Village Property along the surface lot on the east side of the Village Property after the expiration of the Temporary Easement Term;
  - (f) The Village will apply for fence variances necessary to increase the height of the vinyl privacy screening fence being installed on the Village Property as set forth in subsection (e) above to 8'; and
  - (g) In consideration of the grant of easement set forth in this Agreement, the Village agrees to pay Owner \$5,000.00 within 90 days of the Effective Date of this Agreement for Owner to use to install a fence, trees or shrubs as desired by Owner for screening purposes after the expiration of the Temporary Easement Term. Such installation shall be in compliance with Section 3(a) above and with all

applicable laws and ordinances. The Village will have no restoration or repair obligations in connection with the Temporary Easement Premises and the Village is not responsible for restoring, repairing, or replacing any shrubs or trees in the Temporary Easement Premises.

- 4. <u>LIENS</u>. The Village will not permit or suffer any lien to be imposed upon or to accrue against Owner, the Subject Property or the Temporary Easement Premises. The Village will indemnify, defend and hold harmless Owner from and against any liens and encumbrances arising out of any labor or services performed by or at the direction of, or materials furnished to, the Village or any parties claiming by, through or under the Village. In the event that any such lien will arise or accrue against the Owner, the Subject Property or the Temporary Easement Premises, the Village will promptly cause such lien to be released of record by payment thereof or posting a bond in a form and amount which is reasonably satisfactory to Owner.
- 5. <u>INDEMNIFICATION.</u> The Village agrees to indemnify, defend and save Owner harmless from and against any and all liabilities, claims, losses, or demands for personal injury or property damage arising out of or caused by any act or omission of the Village, any of its contractors or subcontractors, anyone directly or indirectly employed or engaged by any of them, or anyone for whose acts any of them may be liable, arising from the Village's exercise or use of the easement rights granted under this Agreement.
- 6. **INSURANCE.** The Village will maintain, and will require any of its contractors hired to perform any work on the Temporary Easement Premises, to maintain liability insurance in reasonable amounts, and with reputable companies, to protect Owner and the Village against claims arising directly or indirectly out of or in connection with the Village's use of the Temporary Easement Premises or Subject Property pursuant to this Agreement. The Village will name, or cause any contractor hired to perform any work on the Easement Premises to name, Owner, as an additional insured and upon request will provide to Owner a copy of a Certificate of Insurance evidencing this coverage.
- 7. ADDITIONAL EASEMENTS. Owner reserves the right to use the Temporary Easement Premises in any manner that will not prevent or interfere in any way with the exercise by the Village of the rights granted herein; provided, however, that Owner must not damage, destroy, or permanently or temporarily improve or obstruct the Temporary Easement Premises or cause any improvements or obstructions to be constructed on the Temporary Easement Premises that would impair the exercise by the Village of the rights granted in this Agreement, without the express prior written consent of the Village Administrator.
- 8. COVENANTS RUNNING WITH THE LAND. The easement and rights granted in this Agreement, the restrictions imposed by this Agreement, and the agreements and covenants contained in this Agreement will be easements, rights, restrictions, agreements and covenants running with the land, will be recorded against the Subject Property and will be binding upon and inure to the benefit of Owner and the Village and their respective heirs, executors, administrators, successors, assigns, agents, licensees, invitees, and representatives, including, without limitation, all subsequent owners of the Subject Property, or any portion thereof, and all persons claiming under them. If any of the easements, rights, restrictions, agreements, or covenants created by this Agreement would otherwise be unlawful or void for violation of (a) the rule against perpetuities or some analogous statutory provision, (b) the rule restricting restraints on alienation, or (c) any other statutory or common law rules imposing time limits, then such easements, rights, restrictions, agreements or covenants will continue only until 21 years after the death of the last

survivor of the now living lawful descendants of J.B. Pritzker, current Governor of the State of Illinois.

- 9. ASSIGNMENT OF RIGHTS. Owner agrees that the Village may assign its rights or delegate its duties under this Agreement to any assignee: (a) who is reasonably competent to exercise the rights granted herein and the obligations imposed herein; and (b) who makes adequate assurances to the Owners that any activity performed pursuant to such assignment or delegation will be conducted in a good and workmanlike manner; and (c) who otherwise attests in writing to comply with the terms of this Agreement. Notwithstanding any such assignment, the Village will not be released from its obligations under Section 5 of this Agreement.
- 10. NO WAIVER OF TORT IMMUNITY. Nothing contained in this Agreement will constitute a waiver by the Village of any right, privilege or defense which it has under statutory or common law, included but not limited to the Illinois Governmental and Governmental Employees Tort Immunity Act, 745 ILCS 10.
- 11. ENTIRE AGREEMENT/AMENDMENT. This instrument contains the entire agreement between the Parties relating to the rights granted herein and the obligations herein assumed. This Agreement may be modified, amended or annulled only by the written agreement of Owner and the Village.
- 12. **EXHIBITS**. Exhibits A and B attached to this Agreement are incorporated herein and made a part hereof by this reference.
- SEVERABILITY. Invalidation by judgment or court order of any one or more of the covenants or restrictions contained herein will in no way affect any other provisions which will remain in full force and effect.
- 14. CAPTIONS AND PARAGRAPH HEADINGS. Captions and paragraph headings are for convenience only and are not a part of this Agreement and will not be used in construing it.
- NOTICES. All notices provided for herein will be served upon the Parties by personal delivery, overnight courier or Certified United States mail, return receipt requested, at the following locations, or at such other location or locations as the Parties may from time to time designate in writina:

Notice to the Village:

Village of East Dundee Attn: Village Administrator 120 Barrington Avenue East Dundee, Illinois 60118

Notice to Owner:

Notices will be deemed given when received by the Party to whom it was sent.

Notice to Owner:

Brook B. Marshall, Trustee

Brook B. Marshall Grantor Trust dated 12/20/20

Brook B. Marshall Grantor Trust dated 12/20/20

5078 N. 83 Street

Fountain Hills, AZ 85263

Scottsdale, AZ 85250-7302

16. **NO THIRD PARTY BENEFICIARIES**. This Agreement is entered into solely for the benefit of the Parties, and nothing in this Agreement is intended, either expressly or impliedly, to provide any right or benefit of any kind whatsoever to any person and entity who is not a party to this Agreement or to acknowledge, establish, or impose any legal duty to any third party.

**IN WITNESS WHEREOF**, the Parties hereto have caused this instrument to be executed on the date first above written.

OWNER: BROOK B. MARSHALLGRANTOR TRUST DATED DECEMBER 20, 2020

Brook B. Marshall, Trustee

VILLAGE:

**VILLAGE OF EAST DUNDEE:** 

By: US

<u>ACKNOWLEDGMENTS</u>			
STATE OF ILLINOIS )			
COUNTY OF KANE )			
This instrument was acknowledged before me on, 2024, by France Bottalico, Asst. to Village As of the VILLAGE OF EAST DUNDEE, an Illinois municipal corporation.  Signature of Notary			
SEAL			
My Commission expires: 3/33/27  OFFICIAL SEAL FRANCO BOTTALICO NOTARY PUBLIC, STATE OF ILLINOIS MY COMMISSION EXPIRES: 03/23/2027			
STATE OF ILLINOIS ) COUNTY OF KANE )			
This instrument was acknowledged before me on, 2024, by Brook B. Marshall known to me to be the Trustee of the BROOK B. MARSHALL GRANTOR TRUST DATED DECEMBER 20, 2020 and the person whose name is subscribed to the foregoing instrument and who did acknowledge that they executed the above instrument voluntarily and as their free act and deed.			
Signature of Notary			
SEAL			
My Commission expires: 3/23/27			
FRANCO BOTTALICO NOTARY PUBLIC, STATE OF ILLINOIS MY COMMISSION EXPIRES: 03/23/2027			

# **EXHIBIT A**


# Legal Description of the Subject Property

THE SOUTHERLY HALF OF LOTS 9 AND 10 IN BLOCK 2 OF EAST DUNDEE, IN THE VILLAGE OF EAST DUNDEE, KANE COUNTY, ILLINOIS.

Commonly known as 311 Jackson Street, East Dundee, Illinois.

PIN: 03-23-320-008

# EXHIBIT B DEPICTION OF TEMPORARY EASEMENT PREMISES

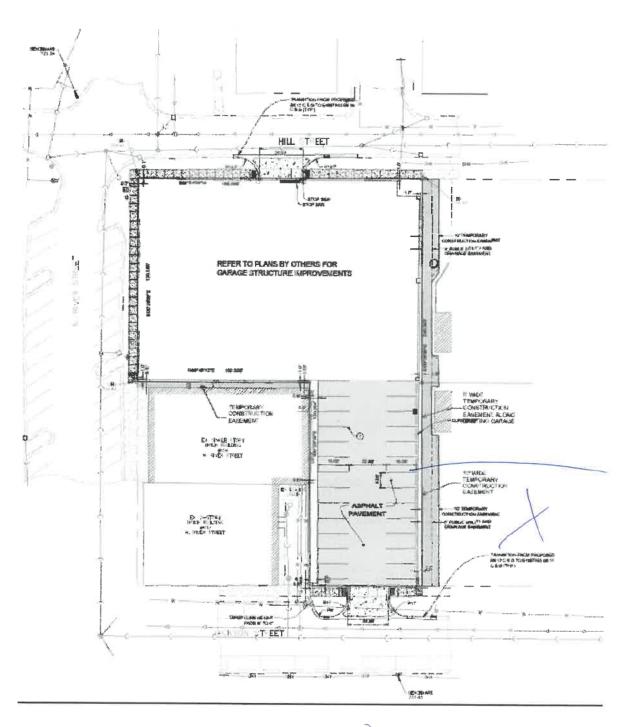

#### Memorandum

**To:** Village President and Board of Trustees

From: Brandiss J. West, Finance & Administrative Services Director

**Subject:** Personnel Manual Amendment - Holidays

**Date:** July 9, 2024

#### **Action Requested**

Staff recommends Village Board approval of an ordinance amending the employee personnel manual regarding holidays to add Juneteenth and Columbus Day, both federally recognized holidays, to the Village's observed Holidays.

### **Background and Summary**

Staff is recommending that the paid holidays granted to full-time employees be amended to include Juneteeth and Columbus Day. In order to accommodate this change, the personnel manual needs to be amended for non-union employees. The Village will discuss this amendment with the union Public Works and Police Department employees as well, which may be formalized in a forthcoming contract renewal with Local 150 (Public Works) and MAP (Police).

### **Attachments**

Ordinance



# ORDINANCE NUMBER 24 - \_\_\_

# AN ORDINANCE OF THE VILLAGE OF EAST DUNDEE, COOK AND KANE COUNTIES, ILLINOIS, AMENDING THE EMPLOYEE PERSONNEL MANUAL REGARDING HOLIDAYS

**WHEREAS**, the Village of East Dundee ("Village") is a home rule unit of local government pursuant to Section 6 of Article VII of the Constitution of the State of Illinois, and has the authority to exercise any power and perform any function pertaining to its government and affairs; and

**WHEREAS**, the Village desires to maintain policies and procedures by which employees of the Village are employed to ensure that all employees are treated in a manner consistent with all applicable employment laws and regulations and that those policies and procedures are provided to employees in a clear and consistent manner; and

**WHEREAS**, the President and Board of Trustees of the Village previously adopted a formal policy manual ("Personnel Manual") in order to further the Village's goal as stated herein; and

**WHEREAS**, the Personnel Manual is adopted by reference in Title III, Administration; Chapter 34, Village Policies; Section 34.20, Personnel Policy of the Village Code; and

**WHEREAS**, the President and Board of Trustees of the Village of East Dundee have determined that it is in the best interests of the Village that the Personnel Manual be amended to amend the Holidays contained in the Personnel Manual, Section 11.1 by adding two additional holidays, Juneteenth and Columbus Day, as follows:

#### 11.1 Holidays

All employees who have full-time employment status shall receive time off and be paid for the following holidays:

New Year's Day
Martin Luther King, Jr Day
Memorial Day
Juneteenth
Independence Day
Labor Day

Columbus Day
Veteran's Day
Thanksgiving Day
Day after Thanksgiving
Christmas Eve
Christmas Day

NOW THEREFORE BE IT ORDAINED BY THE VILLAGE PRESIDENT AND BOARD OF TRUSTEES OF THE VILLAGE OF EAST DUNDEE, COOK AND KANE COUNTIES, ILLINOIS, AS FOLLOWS:

**SECTION 1: Incorporation.** That the recitals above shall be and are hereby incorporated in this Section 1 as if restated herein.

**SECTION 2: Amendment to Personnel Manual.** The Village Administrator is hereby authorized and directed to undertake any and all actions as may be required to implement this amendment to the Employee Personnel Manual.

**SECTION 3: Conflict.** In the event there is a conflict between the Employee Personnel Manual and any collective bargaining agreement, personnel services contract or Federal or State law, the terms and conditions of that contract or law shall prevail. In all other cases, the Employee Personnel Manual shall prevail.

**SECTION 4: Continuation.** That all provisions of the Village Code and Personnel Manual not amended herein shall remain in full force and effect.

**SECTION 5: Repeal.** All prior ordinances or resolutions related to the employment policies of the Village or inconsistent with the provisions of this ordinance are hereby repealed.

**SECTION 6:** Effect. That this Ordinance shall be in full force and effect upon its adoption, approval and publication in pamphlet form as provided by law.

ADOPTED this _	day of	, 2024 բ	oursuant to a roll call vote as follows:
AYES:	· · · · · · · · · · · · · · · · · · ·		
NAYES:			
	me this da		
	Jeffrey	Lynam, Vill	age President
ATTEST:			
Katherine Diehl, Village	Clerk		
Published in pamphlet to of the Village President			, 2024, under the authority
Recorded in the Village	records on		, 2024.

### Memorandum

**To:** Village Board of Trustees

From: Jeff Lynam, Village President

**Subject:** Appointments to the Police Commission & the Depot Council

**Date:** July 15, 2024

### **Action Requested:**

The Village President requests Village Board Advice and Consent to an Appointment to the Police Commission & Depot Council.

#### **Summary:**

This item was presented to the Board during the June 24, 2024 special Village Board meeting. A motion was made to postpone until the July 15, 2024 Village Board meeting to further discuss.

Village President Lynam submits for advice and consent the following regular appointments:

Police Commission:

Name	Term Expiration
Scott Cox (as a replacement	July 15, 2027
for Craig Martin)	

# Depot Council:

Name	Term Expiration
Kim Brunner	July 15, 2027
Peggy Scarpelli	July 15, 2027

