

Ω.	AZ	AZIMUTH
CHECKED	BK	BACK
뿦	æ	BASELINE
O	BRG	BEARING
	Ç	CENTERLI
z	CS	CURVE TO
AM,	Φ	SUPERELE
DRAFTED BY_S. BEAMAN	EQ	EQUALITY
v,	EXT	EXTERNAL
	HCL	HORIZONT
3≺	HSD	HEADLIGH
0	L	LENGTH (
ΤE	LS	LENGTH (
₹AF	LVC	LENGTH (
E E	E	CENTER (
	M	MAIN LIN
z I	PC	POINT OF POINT OF
×	PI	POINT OF
AC	POL	POINT ON
畾	PSD	PASSING
٩	PT	POINT OF
_	PVC	POINT OF POINT OF POINT OF
à	PVI	POINT OF
ED.	PVT	POINT OF
ESTIMATED BY A. BLACKMON	R	RADIUS
Ê	SC	SPIRAL T
ES	SSD	STOPPING
	ST	SPIRAL T
Z	STA	STATION
A. BLACKMON	T	TANGENT
ACI	TGL	THEORETI
圗	TS	TANGENT
٩	VC	VERTICAL
ВY		T0P00
СНЕСКЕВ ВУ	ABBR.	DESCRIP
Š	BB	воттом (
E	ВС	BOTTOM (
	В0	воттом (
<u> </u>	CAP	CORRUGAT
	СВ	CATCH BA
RESU.	CIP	CAST IRO
~		

ALIGNMENT

BLACKMON

P. PRESUTTI
MANAGER_
JOB
W. McCORMICK
∞'

	TTIIJOO
	٥
Wellsua	VOLVEDOLON
	3
USER	

1/6/2022	WellsDA	
		DATE/TIME = 1/6/2022 USER = WellsDA

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	C
HOS 1914	10111000-11
0350	7

PRES		CIP	CAST IRON PIPE
품		© STRM	CENTERLINE OF STREAM
ا ئە		CMP	CORRUGATED METAL PIPE
		CP	CONCRETE PIPE
ВҮ		CSP	CORRUGATED STEEL PIPE
ED		CULV	CULVERT
DESIGNED		DIA	DIAMETER
ESI		DMH	DRAINAGE MANHOLE
		DS	DRAINAGE STRUCTURE PIPE
		D'XING	DITCH CROSSING
=l		EHW	EXTREME HIGH WATER
PRESUTTI		EL	ELEVATION
ES		ELEV	ELEVATION
		ELW	EXTREME LOW WATER
انه		ES	END SECTION
		HW	HEADWALL
MANAGER		INV	INVERT
NAC		MH	MANHOLE
Μ		MHW	MEAN HIGH WATER
JOB		OHW	ORDINARY HIGH WATER
7		OLW	ORDINARY LOW WATER
		RCP	REINFORCED CONCRETE PIPE
送		SICPP	SMOOTH INTERIOR CORRUGATED POLYETHYLENE PIPE
RMI		TB	TOP OF BANK (STREAM)
McCORMICK		TC	TOP OF CURB
ĕ		TG	TOP OF GRATE
≥		VCP	VITRIFIED CLAY PIPE
ايم			.
VISOR.	l		
>	ı		

ALIONALITY WILDOCE AND OCT						011211120	
ABBR.	DESCRIPTION	ABBR.	DESCRIPTION	ON		ABBR.	DESCRIPTION
AH	AHEAD	ABUT	ABUTMENT			Е	ELECTRIC
AZ	AZIMUTH	AOBE		AS ORDERED BY ENGINEER		EMH	ELECTRIC MANHOLE
BK	BACK	ASPH				G	GAS
B.	BASELINE	BDY				GP	GUY POLE
BRG	BEARING	BLDG				GSB	GAS SERVICE BOX (HOUSE LINE)
C	CENTERLINE	BM				GV	GAS VALVE (MAIN LINE)
cs	CURVE TO SPIRAL	CC				HYD	HYDRANT
e	SUPERELEVATION RATE (CROSS SLOPE)	CONC		CENTER		LP	LIGHT POLE
EQ	EQUALITY	CONST		ON .		LPG	LOW PRESSURE GAS
EXT	EXTERNAL	CR				PP	POWER POLE
HCL	HORIZONTAL CONTROL LINE	D				SA	SANITARY SEWER
HSD	HEADLIGHT SIGHT DISTANCE	DM				SMH	SANITARY MANHOLE
L	LENGTH OF CIRCULAR CURVE	DWY		SONEMENT		ST	STORM SEWER
LS	LENGTH OF SPIRAL	EP		VEMENT		Ţ	TELEPHONE
LVC	LENGTH OF VERTICAL CURVE	ES				TCB	TRAFFIC CONTROL BOX
E	CENTER CORRECTION OF VERTICAL CURVE	FEE				TELBOX	TELEPHONE BOX
M.	MAIN LINE	FEE WO/A		ITION WITHOUT ACCESS	-	TEL P	TELEPHONE POLE
PC PC	POINT OF CURVATURE	FP FP			-	TMH	TELEPHONE MANHOLE
PI	POINT OF INTERSECTION	FD			 	CTV	CABLE TELEVISION
POL	POINT ON LINE	FL	FENCE LINE			W	WATER
PSD	PASSING SIGHT DISTANCE	GAR				WSB	WATER SERVICE BOX (HOUSE LINE)
PT	POINT OF TANGENT	GR				WV	WATER VALVE (MAIN LINE)
PVC	POINT OF VERTICAL CURVE	HO				" "	
PVI	POINT OF VERTICAL CORVE	HWY					SUBSURFACE EXPLORATION
PVT	POINT OF VERTICAL INTERSECTION POINT OF VERTICAL TANGENT	IP		D IDON DIDE		ADDD	DESCRIPTION
R	RADIUS			R IRUN PIPE		ABBR.	DESCRIPTION
SC	SPIRAL TO CURVE	MB MON				REPI	LACE ABBREVIATION "AB" WITH:
SSD	STOPPING SIGHT DISTANCE	N&W		ACUED		AH	HAND AUGER
ST	SPIRAL TO TANGENT					CP	CONE PENTROMETER
STA	STATION	0G 0/H		KOUND		DA	21/4 INCHES CASED DRILL HOLE
T	TANGENT LENGTH					DM	DRILLING MUD
TGL	THEORETICAL GRADE LINE	P				DN	4 INCHES CASED DRILL HOLE
TS	TANGENT TO SPIRAL	PAV'T		FACENENT		FH	HOLLOW FLIGHT AUGER
VC	VERTICAL CURVE	PE PE				PA	POWER AUGER
₩		PED POLE				PH	PROBE
	TOPOGRAPHY (DRAINAGE)	<u>P</u>		INE		PT	PERCOLATION TEST HOLE
4000	DECORIDATION	POR				RP	1 INCH SAMPLER (RETRACTABLE PLUG)
ABBR.	DESCRIPTION	RR				141	TO BE DEFINED AT THE TIME OF EXPLORATION
BB	BOTTOM OF BANK (STREAM)	RTE		AV	-	SP	SEISMIC POINT
BC	BOTTOM OF CURB	ROW RW			—— 	TP	TEST PIT
В0	BOTTOM OF OPENING						
CAP	CORRUGATED ALUMINUM PIPE	SH		WAI		WDDKF AT	ATION "C" IN CATEGORIES: DN. AND FH WITH:
СВ	CATCH BASIN	SHLDR SPK					<u> </u>
CIP	CAST IRON PIPE	SPK				В	BRIDGE
© STRM	CENTERLINE OF STREAM	STK				С	CUT
CMP	CORRUGATED METAL PIPE		STAKE		D	DAM	
CP	CONCRETE PIPE	STY	STORY		F	FILL	
CSP	CORRUGATED STEEL PIPE	SW	SIDEWALK		K	CULVERT	
CULV	CULVERT	TE	TEMPORARY EASEMENT TEMPORARY OCCUPANCY			W	WALL
DIA	DIAMETER	TO				Х	TO BE USED IF ONE OF THE ABOVE CANNOT BE DEFINED AT THE TIME THE EXPLORATION
DMH	DRAINAGE MANHOLE	U/G		טו			BE DEFINED AT THE TIME THE EXPLORATION IS MADE
DS	DRAINAGE STRUCTURE PIPE	ww	WING WALL				10 HINDE
D'XING	DITCH CROSSING	_					
EHW	EXTREME HIGH WATER	7	STANDARD	ITEM PAYMENT UNIT:	EQUIVA	N FNT	
<u> </u>	EL ELLATION	¬ ।	CIANDAND	TIEM INTIMENT ONLY	L GOTAN	1221	

TOPOGRAPHY (MISCELLANEOUS)

	STANDARD Symbol (Plans)	ITEM PAYMENT UNIT: ESTIMATE OF QUANTITIES SHEET	EQUIVALENT NOMENCLATURE: (SPECS/PROPOSAL)
Ī	н	-	INCHES
	,	LF	LINEAR FEET
	mi	MI	MILES
	f†²	SF	SQUARE FEET
	YD ²	SY	SQUARE YARD
	AC	AC	ACRES
	YD ³	CY	CUBIC YARD
	GAL	GAL	GALLON
	lb	LB	POUND
	TON	TON	TON

SHEET NUMBER	DESCRIPTION		DRAWING NUMBER
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8	GENERAL NOTES		GN-01
9 - 13	WORK ZONE TRAFFIC CONTROL		WZTC-01 TO WZTC-5
14 - 17	SURVEY & ALIGNMENT		SA-01 TO SA-04
18	MAINTENANCE JURISDICTION	MJ-01	
19 - 21	MISCELLANEOUS TABLES		MT-01 TO MT-03
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37 - 47	EROSION CONTROL PLAN		EC-01 TO EC-11
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STANDARD SHEETS:

UTILITIES

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NO.	DESCRIPTION	BY	DATE	

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CITY OF DUNKIRK

PROJECT NAME

LAKE SHORE DRIVE

DRAWING TITLE

INDEX AND ABBREVIATIONS



V D:	SCALE	DATE
You Dig	NONE	DECEMBER 2021
ays afely	P.I.N. 5763.53	FEDERAL AID PROJECT NO.
•	SHEET NO.	DRAWING NO.
	2 of 94	IN-01

1/6/2022	WellsDA	
DATE/TIME =	USER =	

A	LIGNMEN	Γ	LA	NDSCAPI	Ε	R	OADWAY		TRA	FIC WORK	ZONE
STYLE	NAME	DESCRIPTION	STYLE	NAME	DESCRIPTION	STYLE	NAME	DESCRIPTION		TWZBT_P	BARRIER, TEMPORARY
	AC	CONTROL (CENTERLINE)	~~~~~	LABL	AREA, BRUSH LINE	сz	RCZ_P	CLEAR ZONE		TWZBTWL_P	BARRIER, TEMPORARY, W/ WARNING LIGHTS
	AD_P	DETOUR	\\\\\\\\\\\\\\\\\\\\\\\\\\\\\\\\\\\\\\	LAHR	AREA, HEDGE ROW		RG	GUIDE RAIL, MISCELLANEOUS		TWZCD_P	CHANNELIZING DEVICE
	AT_P	TRANSITION CONTROL	~~~~~~	LAPB	AREA, PLANTING BED		RGB	GUIDE RAIL, BOX BEAM	111111111	TWZPMRC_P	PAVEMENT MARKING REMOVAL OR COVERING
	BRIDGE			LAWA	AREA, WOODED AREA OUTLINE		RGBM	GUIDE RAIL, BOX BEAM, MEDIAN		UTILITIE	S
	BR	RAIL		LAWE	AREA, WATERS EDGE		RGC	GUIDE RAIL, CABLE	STYLE	NAME	DESCRIPTION
	BSHT	SHEET PILING		LCUT_P	CUT LIMIT		RGCB	GUIDE RAIL, CONCRETE BARRIER	——————————————————————————————————————	UC	CONDUIT, UNDERGROUND
	CONTROL			LFILL_P	FILL LIMIT	0 0	RGP_P	GUIDE POST	———]c[———	UCH	CONDUIT, HANGING
	СВ	BASELINE		LFNC	FENCE	——————————————————————————————————————	RGW	GUIDE RAIL, W BEAM	0C	UCO	CONDUIT, OVERHEAD
	CBPR	BASELINE, PROJECTION	*********	LTRC	TREE ROW, CONIFEROUS		RGWM	GUIDE RAIL, W BEAM, MEDIAN	——————————————————————————————————————	UE	ELECTRIC LINE, UNDERGROUND ELECTRIC LINE, HANGING
	DRAINAGE		000000000000000	LTRD	TREE ROW, DECIDUOUS		RPB	PARKING BUMPER	——————————————————————————————————————	UEO	ELECTRIC LINE, OVERHEAD
ST	DCP	CULVERT PIPE	I I	LWH	WALL, H PILE	O	RRC	RAIL ROAD, CATENARY		UET0	ELECTRIC TRANSMISSION, OVERHEAD
——sr→ ——	DCP_P	CULVERT PIPE (DIR)		LWR	WALL, RETAINING		RRER	RAIL ROAD, 3RD RAIL	× × × ×	UESS	ELECTRIC, SUBSTATIONS
<u> </u>	DDG_P	DITCH. GRASS LINED		LWS	WALL, STONE		RRPLS_P	RAIL, PHOTO, LARGE SCALE	——— F0 ———	UF0	FIBER OPTIC, UNDERGROUND
<u> I </u>			ROW	MAPPI	NG		+]F0[UFOH	FIBER OPTIC, HANGING
*	DDP_P	DITCH, PAVED INVERT		MDL	DEED LINE		RRPSS	RAIL, PHOTO, SMALL SCALE		UF00	FIBER OPTIC, OVERHEAD
***	DDS_P	DITCH, STONE LINED	- ——— PE ——— -	MEE	EASEMENT, EXISTING		RRS	RUMBLE STRIP	G	UG	GAS, UNDERGROUND
		<u> </u>	- —— PE —— -	MEP_P	EASEMENT, PERMANENT	 	RRSLS_P	RAIL, SURVEY, LARGE SCALE	———] <i>G</i> [———	UGH	GAS, HANGING
	DFL_P	FLOW LINE	- ——— APE ——— -	MEPA_P	EASEMENT, PERMANENT, APPROX.	+++++	RRSSS	RAIL, SURVEY, SMALL SCALE	OG	UGO	GAS, OVERHEAD
110 >	DSSD	SLOTTED DRAIN	- —— TE —— -	MET_P	EASEMENT, TEMPORARY		SIGNS		IC	UIC	INFORM CABLE, UNDERGROUND
	DUD_P	UNDERDRAIN	- ——ATE—— -	META_P	EASEMENT, TEMPORARY, APPROX.	*========	SBLB	BILLBOARDS] <i>IC</i> [UICH	INFORM CABLE, HANGING
ENV	IRONMEN'		—— FEE ——	MF_P	FEE ACQUISITION, W/ ACCESS	⊕ ⊕ ⊕	SM	MULTIPLE POST	o	UO	OIL LINE, UNDERGROUND
	EBLHS	BALE, STRAW	AFEE	MFA_P	FEE ACQUISITION, APPROXIMATE		SS0	STRUCTURE, OVERHEAD]o[UOH	OIL LINE, HANGING
	ECT	CURTAIN, TURBIDITY		MFS_P	FEE ACQUISITION, SHAPE		SSOC	STRUCTURE, OVHD. CANTILEVER	€	UPBP	POLE, BRACE, PUSH BRACE
	EDMC	DAM, COFFER	FEE W/OA	MFW0A_P	FEE ACQUISITION, W/O ACCESS	S	TRIPING		>	UPGW	POLE, GUY WIRE
	EDMEC_P	DAM, EARTHEN CHECK		MHA	HISTORICAL, ACQUISITION		STB*	BROKEN LINE	SA	USA	SANITARY SEWER, UNDERGROUND
	EDMGSC_F	DAM, GRAVEL BAG/SAND BAG CHECK	- —— нв —— -	МНВ	HIGHWAY BOUNDARY		STDB*	DOUBLE BROKEN LINE	———]SA[———	USAH	SANITARY SEWER, HANGING
		BAG CHECK	- ——— AHB ——— -	MHBA	HIGHWAY BOUNDARY, APPROX.		STDL*	DOTTED LINE LONG	SAF	USAF	SANITARY SEWER, FORCE MAIN, UGND
	EDMPC_P	DAM, PREFABRICATED CHECK		MHBW	HWY BOUNDARY, FACE OF WALL		STDS*	DOTTED LINE SHORT]SAF[USAFH	SANITARY SEWER, FORCE MAIN, HANG
	EDMSC_P	DAM, STONE CHECK	——————————————————————————————————————	MHBWOA	HIGHWAY BOUNDARY, W/O ACCESS		STFB*	FULL BARRIER LINE	— т —	UT	TELEPHONE, UNDERGROUND
IAI IAI	EFNS	FENCE, SILT		MJC	JURISDICTION, CITY		STH*	HATCH LINE]T[UTH	TELEPHONE, HANGING
- × ~ -	EFNSV	FENCE, SILT & VEGETATION		MJCY	JURISDICTION, COUNTY		STPB*	PARTIAL BARRIER LINE	OT	UT0	TELEPHONE, OVERHEAD
	EFNV	FENCE, VEGETATION		MJHD	JURISDICTION, HISTORIC DISTRICT		STRCT	ROUNDABOUT, CAT TRACKS		UTV	CABLE TV, UNDERGROUND
AA	EWAA_P	WETLAND, ADJACENT AREA		MJLL	JURIS., (GREAT, MILITARY) LOT LINE	****	STRYL	ROUNDABOUT, YIELD LINE]CTV[UTVH	CABLE TV, HANGING
FW-	EWF	WETLAND, FEDERAL		MJN	JURISDICTION, NATION		STSB	STOP BAR	OCTV	UTV0	CABLE TV, OVERHEAD
FW SW	EWFS	WETLAND, FEDERAL & STATE		MJPB	JURISDICTION, PUBLIC LANDS		STSE*	SOLID, EDGE	UU	UUU	UNKNOWN, UNDERGROUND
	EWM	WETLAND, MITIGATION AREA		MJS	JURISDICTION, STATE		STXL	X WALK, LADDER LINE] <i>uu</i> [UUH	UNKNOWN, HANGING
SW	EWS	WETLAND, STATE		MJT	JURISDICTION, TOWN		CTVLD	V WALK LADDED DAD LIVE	OUU	UUO	UNKNOWN, OVERHEAD
	1 - 113	"ETENIO, STATE		MJV	JURISDICTION, VILLAGE		STXLB	X WALK, LADDER BAR LINE	w	UW	WATER LINE, UNDERGROUND
				MPL	PROPERTY LOT LINE	TD.4EE	10 001	* = W (WHITE) OR Y (YELLOW)]w[UWH	WATER LINE, HANGING
			——————————————————————————————————————	MPLA	PROPERTY LOT LINE, APPROX.		IC CON			UWO	WATER LINE, OVERHEAD
			——————————————————————————————————————	MSL	SUB LOT LINE		TCSW	SIGNAL, SPAN WIRE		,	

- 1. THE LEGEND ILLUSTRATES MAPPING FEATURES (EXISTING AND PROPOSED).
- FEATURES ARE SHOWN AS EITHER LINEAR (ROADWAY GUIDERAIL, ROADWAY SIDEWALK, UTILITY LINES, ETC.) OR POINT (SIGN, UTILITY POLE, ETC.).
- 3. FEATURES SHOWN ON THE LEGEND AS EXISTING FEATURES ALSO HAVE CORRESPONDING PROPOSED FEATURES.
- PROPOSED FEATURE SYMBOLOGY IS IDENTICAL TO EXISTING FEATURE SYMBOLOGY EXCLUDING LINE WEIGHT. LINE WEIGHT FOR PROPOSED FEATURES IS THICKER (0.015 in ON B SIZE DRAWINGS).
- 5. MAPPING FEATURES NOT INCLUDED ON THE LEGEND SHEET DO NOT HAVE A UNIQUE SYMBOLOGY (SUCH AS THE PAVEMENT EDGE, PAVEMENT EDGE OF TRAVEL WAY) AND SHOULD BE LABELED ON THE PLANS.
- 6. FEATURES SHOWN AT THE HEAVIER WEIGHT ARE PROPOSED ONLY AND DO NOT HAVE CORRESPONDING EXISTING FEATURES.



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CITY OF DUNKIRK

PROJECT NAME

LAKE SHORE DRIVE

DRAWING TITLE

LEGEND LINE SYMBOLOGY

SCALE	DATE		
NONE	DECEMBER 2021		
P.I.N. 5763.53	FEDERAL AID PROJECT NO.		
SHEET NO.	DRAWING NO.		
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CPH

CPSM

CPSV

POINT, HORIZ, PHOTOGRAMMETRY

POINT, SURVEY MARKER, PERM

POINT, VERT., PHOTOGRAMMETRY

ALIGNMENT DRAINAGE ITS ROW MAPPING SIGNS DESCRIPTION CELL NAME DESCRIPTION CELL NAME DESCRIPTION **CELL** NAME DESCRIPTION CELL NAME DESCRIPTION CELL NAME \otimes CENTER OF CURVATURE ACC TANT NTFNNAS (I)MDL1P DEED LINE, TYPE : SINGLE POST SINGLE POST, PROPOSED S_P **ACOGO** 2 TRUCTURE, RECTANGULAR TASCTS ACCOU. SPEED/COUNT SNSR.S MDL2P DEED LINE, TYPE 2 P CURVE TO SPIRAL SB_P BACK TO BACK, PROPOSED ACS TCARPAD CABINET & PAD (3) MDL3P DEED LINE, TYPE 3 TRUCTURE, INVERT Δ ADPI_P DETOUR, POINT OF INTERSECT. (4) DELINEATORS ICCTV CCTV SITE MDL4P DEED LINE, TYPE 4 SDEL TRUCTURE, MANHOLE 0 ADPL_F DETOUR, POINT ON LINE)CDPD(TCDPD CDPD TRANSCEIVER (5) MDL5F DEED LINE, TYPE 5 SPM PARKING METER TRUCTURE, MANHOLE 0 EQUATION **AEQN ICELLT** CELL PHONE TOWER MEEP EASEMENT, EXISTING RFMSRM REFERENCE MARKERS XX" = 48, 60, 72, 9 (A) **EQUATION AHEAD AEQNAH** ▲ SRSC3 TC.IR CONDUIT JACK OR BORING MEPAP_ EASEMENT, PERM., APPROX. SHLD, CTY, 123 DIG. TRUCTURE, ROUND B EQUATION BACK 0 **AEQNBK** \boxtimes SRSC4 SHID, CTY, 4 DIG **ICNTL CAB** CONTROLLER CABINET MFPP P EASEMENT. PERM., BACK LINE CTURE, RECT., WITH CUR \odot AEVT **EVENT STATION** 0 Ω SRSCT2 SHLD, CTY TOUR, 1-2 DIG TCPR COMMUNICATION PULL BOX MEPSP_ EASEMENT, PERM., SHAPE POINT OF CURVATURE ♠ SRSCT4 SHID, CTY TOUR, 3-4 DIG. TOTA CONDUIT TURNING DOWN MEAP P FEE ACQUISITION. APPROX. 'X" = I, K, L, M, O, P, U POINT OF COMPOUND CURVATURE ICTH 0 SRST SHLD. INTERSTATE CONDUITE TURNING UP MEP P FEE ACQUISITION, BACK LINE POINT OF INTERSECTION)@(**\rightarrow** SRSN2 **ICVTRT** COMM. VEH. ROAD TRANSCEIVER ย SHLD, NATIONAL, 2 DIG. MFSP_F FEE ACQUISITION. SHAPE **ENVIRONMENTAL** APOR POINT OF BEGINNING ~ Α TDEFAULT SRSN3 SHLD, NATIONAL, 3 DIG DEFAULT MHRAF HIGHWAY BNDRY., APPROX. CULV EIOP_P STR., INLET, OUTLET PROT. APOC POINT OF CURVATURE ΕZ (0) SRSS2 SHLD. STATE, 2 DIG. IF7R -ZPASS READER MHRCP HISTORICAL. BLDG. CORNERS POINT OF END Α **APOE** EZ-IF7TR TRANSMITTAL READER MHRE \cap SRSS3 SHLD, STATE, 3 DIG. HIGHWAY BNDRY, PT. (GB) EIPGB_P STR., INLET PROT., GRAVEL BAG APOL POINT ON LINE SRSS4 SHLD, STATE, 4 DIG. \square xc TIBER OPTIC X-CONNECT CABINE **IFOXCAB** MJCP PT., JURIS, CITY (H/S) EIPHS_P STR., INLET PROT., HAY/STRAW **APOS** POINT ON SPIRAL (*) PT., BUILDING CORNER **IFUSSPL** FUSION SPLICE TRAFFIC CONTROL **APOT** POINT ON TANGENT 0 HAR ADVISORY SIGN THARADV MPCC PT., CROSS CUT PRFB EIPP_P STR., INLET PROT., PREFAB. TCBJ BOX, JUNCTION POINT ON VERTICAL CURVE APOVO -/ IHARS1 AR SITE MPDH PT., DRILL HOLE CBP BOX, PULL BOX (SF) EIPSF_P STR., INLET PROT., SILT FENCE APOVT POINT ON VERTICAL TANGENT Δ TI C OAD CENTER MPF PT., FENCE LOCATION TCBS BOX, SPLICE APORC POINT ON REVERSE CURVE 0 IMECSPI MECHANICAL SPLICE MPIF PT., IRON PIPE **ERCB** RISER, CONCRETE BOX CMC MICROCOMPUTER CABINET (0) APT POINT OF TANGENCY PORT. SPEED & COUNT SENSOR IMSCS MPIR PT., IRON ROD $\overline{}$ ETRS_P TRAP. SEDIMENT TCPP PED POLE (0) APVC POINT OF VERTICAL CURVATURE IMSCTS MICRO SPEED & COUNT SENSOR MPM PT., MONUMENT WETLAND FLAG CSH SIGNAL HEADS APVCC POINT OF VERT. CMPND CURVE \blacksquare Δ :\M\: IMT PT., MONUMENT, MISC. MICROWAVE TRANSCEIVER МРММ TCSP SIGNAL POLE **GEOTECHNICAL** APVI POINT OF VERT, INTERSECTION IOVHVMS Ø PERM. OVERHEAD VMS MPN PT., NAIL TRAFFIC WORK ZONE APVRO POINT OF VERT. REVERSE CURVE € | GDH DRILL HOLE ₩ Δ PORT. ACCOU. SPD & CNT. SENSOI MPRS PT., RAILROAD SPIKE **IPASCS** (11) APVT POINT OF VERTICAL TANGENCY **IPEDS** PEDESTRIAN SIGNAL HEAD 斑 PT., SPIKE TWZAP_P ARROW PANEL LANDSCAPE ASC SPIRAL TO CURVE PAVEMENT SURFACE SENSOR MPST PT., STAKE ARROW PANEL, CAUTION MODE LFLS ELEVATION, SP01 ASPI SPIRAL POINT OF INTERSECTION **IPVMS** PERM. VMS PT., TREE W/ WIRE 000 ARROW PANEL. TRAILER OR SUPPOR LEP FLAG POLE ASTS SPIRAL TO SPIRAL IRM BARRICADE (TYPE III) RAMP METER MPWL PT., WALL LOCATION WZBCD_F LMB MATLBOX \otimes AST SPIRAL TO TANGENT IRWIS RDWY WEATHER INFO. SENSOR CHANGEABLE MESSAGE SIGN (PVMS) ROW ACQUISITION I PR PAPER BOX 꺗 \otimes ΔTS TANGENT TO SPIRAL ISP SOLAR PANEI WZFLG_ LPST POST, SINGLE MFS_P_T FEE ACQUISITION AVEVT VERTICAL EVENT POINT - (SS): ISS1 SPREAD SPECT, TRANSCEIVER TWZFT_P FLAG TREE 6...3 I RR ROCK, BOLL DER AVHIGH VERTICAL HIGH POINT TELEPHONE DEMARCATION BLK ITDB ▦ TWZIA_F CRASH CUSHION (TEMPORARY) MEPS_P EASEMENT, PERMANENT LSHC SHRUB, CONTEEROUS AVLOW VERTICAL LOW POINT LUMINAIRE (TEMPORARY) ITP SUBSURFACE TEMP. PROBE WZLUM_ LSHD SHRUB, DECIDUOUS METS_P_T EASEMENT, TEMPORARY)Ó(IVTRT VEHICLE TO RDWY TRANSCEIVER ➾ TWZSDT_F SYMBOL, DIRECTION OF TRAFFIC BRIDGE LTC TREE, CONIFEROUS SYMBOL, DIRECTION OF TEMPORARY IWIMD WEIGHT IN MOTION DETECTOR WZSDTD. W/M METS_P. OCCUPANCY, TEMPORARY LTD BSC BRIDGE, SCUPPER TREE, DECIDUOUS)WVR IWVR WIRELESS VIDEO REPEATER WZSGN_F SIGN (TEMPORARY) (MI) Ö LTS TREE, STUMP CONTROL MFS_P_T FEE ACQUISITION W/O ACCESS SIGNAL, TRAFFIC OR PEDESTRIAN \forall IWVRC WIRELESS VIDEO RECEIVER WZSIG_P Ø LTW TREE, WELL OR WALL ÷(V) CBP BASELINE, POINT IWVTT WIRELESS VIDEO TRANSMITTER മ TWZWL_P WARNING LIGHT ROADWAY LUKP UNKNOWN POINT CBPOL BASELINE, POINT ON LINE **1**13 TWZWV_P WORK VEHICLE \bigcirc RES F ELEVATION, SPOT WORK VEHICLE WITH TRUCK **(4)** CBSP BASELINE, SPUR POINT TWZWVA_P MOUNTED ATTENUATOR GUIDE RAIL, ANCHOR 1. THE LEGEND ILLUSTRATES MAPPING FEATURES (EXISTING AND PROPOSED) 47 CBTP BASELINE, TIE POINT RGP 2. FEATURES ARE SHOWN AS EITHER LINEAR (ROADWAY GUIDERAIL, ROADWAY SIDEWALK, GUIDE POST, SINGLE СРВМ RENCHMARK

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UTILITIES

DESCRIPTION

FLECTRIC, BOX

GAS, METER

GAS. MANHOLE

GAS. LINE MARKER

GAS/FIJEL PUMP

LIGHTING, POLE

LIGHTING, POLE, MEDIAN

LIGHTING, POLE, PED.

MISC. FILLER CA

OIL, LINE MARKER

OLE. WITH UTILIT

POLE, WITH LIGHT

TELEPHONE, BOOTH

POLE, DEAD (NO UTILIT

SANITARY SEWER MANHOLE

TELEPHONE, LINE MARKER

CABLE TV, LINE MARKER

UNKNOWN, JUNCTION BOX

JNKNOWN, MANHOL

INKNOWN, VEN

INKNOWN, WEL

WATER, METER

WATER, VALVE

WATER, WELL

WATER, MANHOLE

UNKNOWN, PULL BOX

WATER, FIRE HYDRANT

TELEPHONE, MANHOLE

CABLE TV, PULL BOX

GAS. VALVE

GAS. VENT

ELECTRIC, METER

ELECTRIC, MANHOLE

ELECTRIC, POLE, TRANS.

CELL NAME

UEM

LIEMH

UEPT

HGM

LIGMH

LIGL M

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DATE

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NO.	DESCRIPTION	BY	DATE		

CLIENT



CITY OF DUNKIRK

PROJECT NAME

LAKE SHORE DRIVE


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LEGEND POINT SYMBOLOGY

SCALE	DATE
NONE	DECEMBER 2021
P.I.N. 5763.53	FEDERAL AID PROJECT NO.
SHEET NO.	DRAWING NO.
4 of 94	LEG-02

- UTILITY LINES, ETC.) OR POINT (SIGN, UTILITY POLE, ETC.).

 3. FEATURES SHOWN ON THE LEGEND AS EXISTING FEATURES ALSO HAVE
- PROPOSED FEATURE SYMBOLOGY IS IDENTICAL TO EXISTING FEATURE SYMBOLOGY EXCLUDING LINE WEIGHT. LINE WEIGHT FOR PROPOSED FEATURES IS THICKER (0.015 in on B SIZE DRAWINGS).
- 5. MAPPING FEATURES NOT INCLUDED ON THE LEGEND SHEET DO NOT HAVE A UNIQUE SYMBOLOGY (SUCH AS THE PAVEMENT EDGE, PAVEMENT EDGE OF TRAVEL WAY) AND SHOULD BE LABELED ON THE PLANS.
- 6. FEATURES SHOWN AT THE HEAVIER WEIGHT ARE PROPOSED ONLY AND DO NOT HAVE CORRESPONDING EXISTING FEATURES.

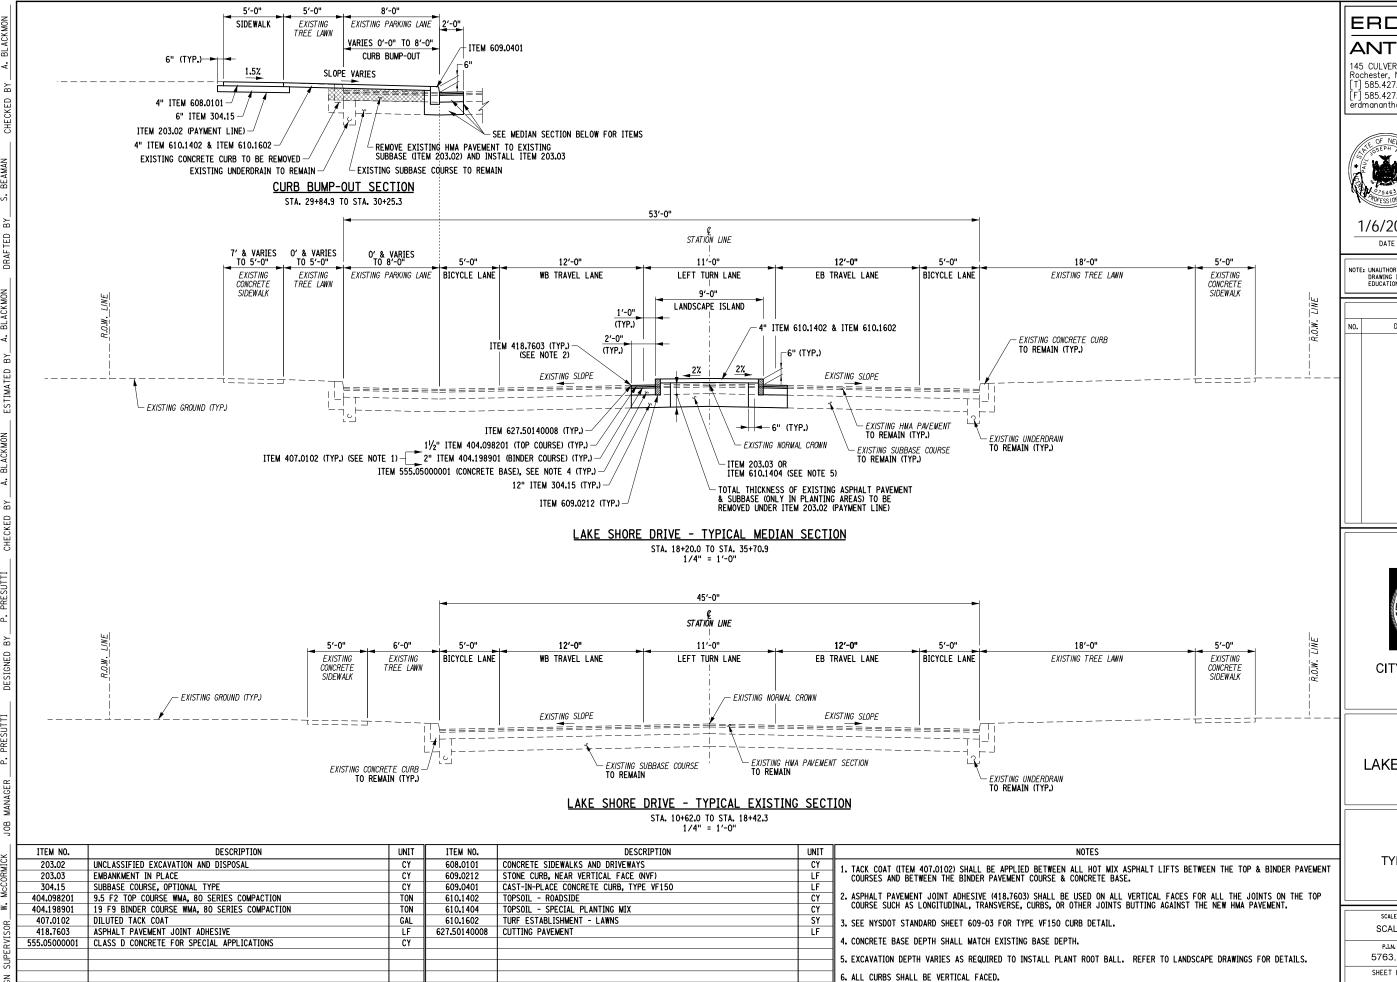

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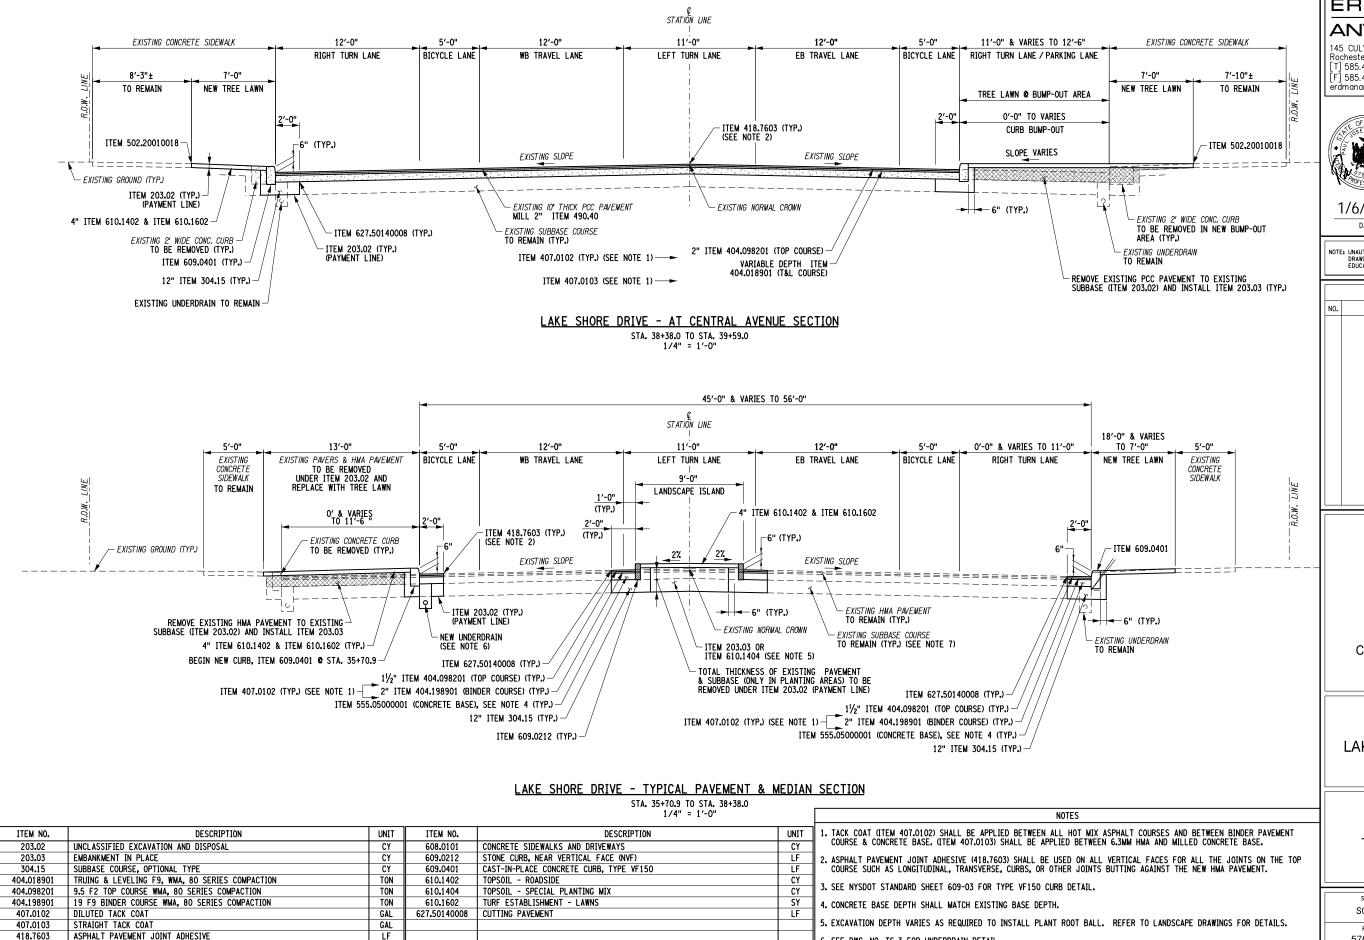
PROJECT NAME

LAKE SHORE DRIVE

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TYPICAL SECTION

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	SCALE	DATE				
1	SCALE	NOVEMBER 2021				
	P.I.N. 5763.53	FEDERAL AID PROJECT NO.				
-	SHEET NO.	DRAWING NO.				
	5 of 94	TS-01				



6. SEE DWG. NO. TS-3 FOR UNDERDRAIN DETAIL.

8. ALL CURBS SHALL BE VERTICAL FACED.

7. GRADING OF EXISTING SUBBASE MATERIAL TO BE INCLUDED IN THE COST OF PAVING ITEMS.

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502.20010018 FULL DEPTH PORTLAND CEMENT CONCRETE SAW CUTS

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ERDMAN
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<u>CLIENT</u>



CITY OF DUNKIRK


PROJECT NAME

LAKE SHORE DRIVE

DRAWING TITLE

TYPICAL SECTION

SCALE	DATE
SCALE	NOVEMBER 2021
P.I.N. 5763.53	FEDERAL AID PROJECT NO.
SHEET NO.	DRAWING NO.
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	SCALE P.I.N. 5763.53 SHEET NO.

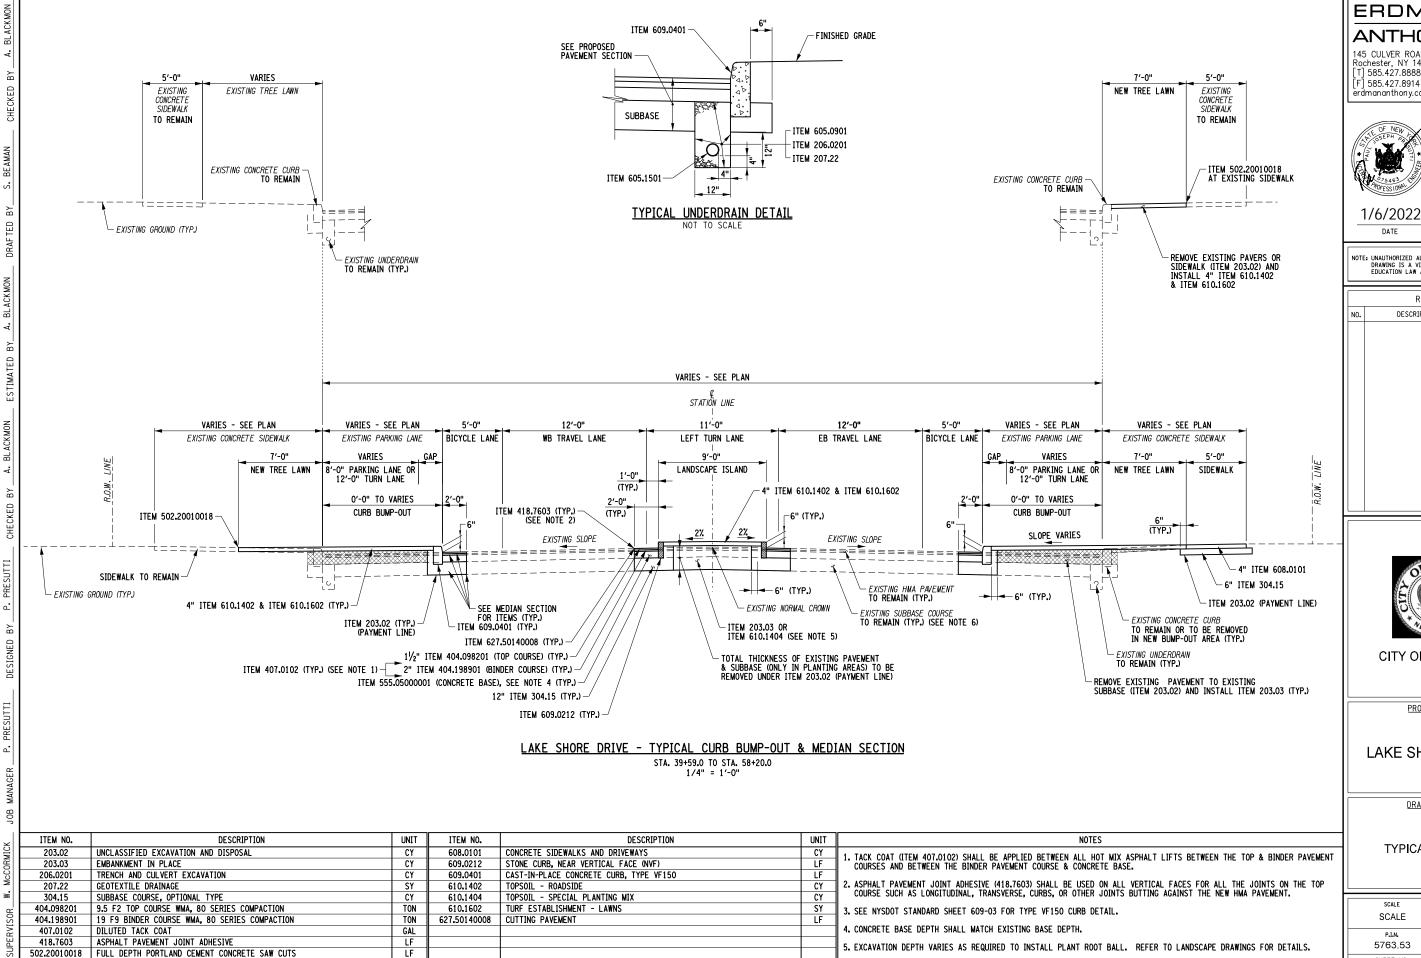

6. GRADING OF EXISTING SUBBASE MATERIAL TO BE INCLUDED IN THE COST OF PAVING ITEMS.

7. ALL CURBS SHALL BE VERTICAL FACED.

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CITY OF DUNKIRK

PROJECT NAME

LAKE SHORE DRIVE

DRAWING TITLE

TYPICAL SECTION

SCALE	DATE		
SCALE	NOVEMBER 2021		
P.I.N.	FEDERAL AID PROJECT NO.		
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GENERAL NOTES:

- 1. ANY AREA OF ROADWAY THAT IS OPEN TO TRAFFIC SHALL BE KEPT CLEAN OF MUD AND DEBRIS AT ALL
- 2. ROADWAY AND ROADSIDE DRAINAGE SHALL BE MAINTAINED AT ALL TIMES.
- 3. THESE CONTRACT DOCUMENTS HAVE BEEN PREPARED BASED UPON FIELD INSPECTION AND OTHER INFORMATION AVAILABLE AT THE TIME. THEREFORE, THE EXACT EXTENT OF PROPOSED WORK MAY NOT ALWAYS BE ACCURATELY DEPICTED; ACTUAL FIELD CONDITIONS MAY REQUIRE MODIFICATIONS TO CONSTRUCTION DETAILS AND WORK QUANTITIES. THE CONTRACTOR SHALL PERFORM THE WORK IN ACCORDANCE WITH FIELD
- 4. DETAILS ON THE DRAWINGS LABELED AS "NOT TO SCALE" ARE INTENTIONALLY DRAWN NOT TO SCALE FOR VISUAL CLARITY. ALL OTHER DETAILS FOR WHICH NO SCALE IS SHOWN ARE DRAWN PROPORTIONAL AND ARE
- 5. EXCEPT WHERE INDICATED IN THE PLANS, TURF ESTABLISHMENT FOR DISTURBED AREAS FROM ANY OF THE CONTRACTOR'S OPERATIONS WILL NOT BE PAID FOR AS A SEPARATE PAYMENT. RESTORATION OF DISTURBED AREAS SHALL BE PERFORMED AS SPECIFIED UNDER SECTION 107-08 OF THE STANDARD SPECIFICATIONS, PROTECTION AND RESTORATION OF PROPERTY AND LANDSCAPE. THE COST OF THIS WORK SHALL BE INCLUDED IN THE PRICES BID FOR THE VARIOUS ITEMS IN THE CONTRACT.
- 6. IF, DURING EXCAVATION AT ANY LOCATION, SIGNS OF CONTAMINATION ARE ENCOUNTERED, THE CONTRACTOR SHALL IMMEDIATELY STOP WORK AND NOTIFY THE ENGINEER. SIGNS OF CONTAMINATION INCLUDE, BUT NOT LIMITED TO: ODOR, OILY SHEEN, SLUDGE, SOIL STAINING AND UNUSUAL FILL MATERIAL OR UNDERGROUND IMPEDIMENTS. THE ENGINEER SHALL IMMEDIATELY NOTIFY THE NYSDOT CONSTRUCTION
- 7. THE NORTHERN LONG EARED BAT (MYOTIS SEPTENTRIONALIS) IS LISTED AS A FEDERALLY THREATENED SPECIES STATEWIDE. THIS PROJECT IS NOT ANTICIPATED TO INVOLVE THE REMOVAL OF TREES GREATER THAN THREE (3) INCHES IN DIAMETER DIAMETER BREAST HEIGHT (DBH)). IF PROJECT CONDITIONS CHANGE AND TREE REMOVALS ARE NECESSARY, WHETHER UNDER CLEARING AND GRUBBING OR TREE REMOVALS, THE ENGINEER MUST BE NOTIFIED PRIOR TO THE START OF ANY TREE REMOVAL. TREE REMOVALS WILL BE ALLOWED ONLY AFTER COORDINATION AND APPROVAL BY THE ENGINEER IN CONSULTATION WITH THE NYSDOT CONTENTIAL RECORDINATION.

UTILITY QUALITY LEVEL DEFINITIONS

1. QUALITY LEVEL A (QLA):

QUALITY LEVEL A IS THE HIGHEST DEGREE OF ACCURACY. THE INFORMATION SHOWN ON THE PLANS HAS BEEN OBTAINED BY THE ACTUAL EXPOSURE (OR VERIFICATION OF PREVIOUSLY EXPOSED AND SURVEYED UTILITY FACILITIES) OF SUBSURFACE UTILITIES, USING (TYPICALLY) MINIMALLY INTRUSIVE EXCAVATION EQUIPMENT TO DETERMINE THEIR PRECISE HORIZONTAL AND VERTICAL POSITIONS, AS WELL AS THEIR OTHER UTILITY FACILITY ATTRIBUTES (SLOWN AS OLA) FACILITY ATTRIBUTES. (SHOWN AS QLA)

2. QUALITY LEVEL B (QLB):

QUALITY LEVEL BIS THE SECOND HIGHEST DEGREE OF ACCURACY. THE INFORMATION SHOWN ON THE PLANS HAS QUALITY LEVEL BIS THE SECUND FIGHES! DEGREE OF ACCURACT. THE INFORMATION SHOWN ON THE PLANS HAB BEEN OBTAINED THROUGH THE APPLICATION OF APPROPRIATE SURFACE GEOPHYSICAL METHODS (I.E., UNDERGROUND CAMERAS, RADAR, SONAR, TONE OUTS, ETC.) TO IDENTIFY THE EXISTENCE AND APPROPRIATE HORIZONTAL POSITION OF SUBSURFACE UTILITY FACILITIES, QUALITY LEVEL B DATA ARE REPRODUCIBLE BY SURFACE GEOPHYSICS AT ANY POINT OF THEIR DEPICTION. THE INFORMATION WAS SURVEYED TO APPLICABLE TOLERANCES AND REDUCED ONTO THE PLANS. NO EXCAVATIONS WERE PERFORMED. (SHOWN AS QLB)

3. QUALITY LEVEL C (QLC):

QUALITY LEVEL C IS THE THIRD HIGHEST DEGREE OF ACCURACY. THE INFORMATION SHOWN ON THE PLANS HAS BEEN OBTAINED BY SURVEYING AND PLOTTING VISIBLE ABOVE-GROUND UTILITY FEATURES AND BY USING PROFESSIONAL JUDGMENT IN CORRELATING THIS INFORMATION TO QUALITY LEVEL D INFORMATION. (SHOWN AS

4. QUALITY LEVEL D (QLD):

QUALITY LEVEL DIS THE LOWEST DEGREE OF ACCURACY. THE INFORMATION SHOWN ON THE PLANS WAS DERIVED SOLELY FROM EXISTING NYSDOT AND/OR UTILITY COMPANY RECORDS OR RECOLLECTIONS. (SHOWN AS QLD)

PAVING NOTES:

- 1. STANDARD SPECIFICATION 619.3.02(A) SHALL APPLY TO ALL TEMPORARY TRAFFIC CONTROL ASSOCIATED WITH MILLED SURFACES DURING THIS CONTRACT.
- 2. THE CONTRACTOR SHALL NOT LEAVE THE MILLED OR GROOVED PAVEMENT EXPOSED TO TRAFFIC FOR MORE THAN 14 CALENDAR DAYS BEFORE PAVING THE HMA TOP COURSE. LIQUIDATED DAMAGES SHALL BE ASSESSED ON THE CONTRACTOR IN ACCORDANCE WITH SECTION 108-03B AND TABLE 108-1 OF THE NYSDOT STANDARD SPECIFICATIONS, UNTIL SUCH TIME AS THE TOP COURSE HAS BEEN PAVED, IF A SEGMENT OF ROADWAY TAKES MORE THAN ONE DAY TO MILL, TIME SHALL BE MEASURED FROM THE FIRST DAY OF THE MILLING OPERATION.
- TRANSVERSE JOINTS CREATED AT THE END OF EACH WORKING DAY AT THE COMPLETION OF PAVING TOP COURSE SHALL BE SAWCUT TO A VERTICAL EDGE, IN ORDER TO REMOVE THE ROLLED MATERIAL, PRIOR TO RESUMING PLACEMENT OF TOP COURSE. SEE STANDARD SPECIFICATION 619-3.02(A). SAWCUT SHALL BE INCLUDED IN PRICE BID FOR THE TOP COURSE ITEM.
- 4. PAVING OPERATIONS AT THE END OF THE WORKDAY SHALL BE FROM EDGE OF SHOULDER TO EDGE OF SHOULDER OR CURBLINE TO CURBLINE, LEAVING NO RAISED LONGITUDINAL JOINTS.
- 5. ALL PAVING OR SHOULDER MATERIAL SHALL BE INSTALLED IN THE DIRECTION OF FLOW OF TRAFFIC. TRUCKS HAULING MATERIAL FOR A GIVEN OPERATION SHALL PROCEED TO THE PLACEMENT EQUIPMENT WITH THE FLOW
- 6. ASPHALT JOINTS SHALL NOT BE ALLOWED IN ANY WHEEL PATH. THROUGHOUT THE PAVEMENT LENGTH, THE TOP COURSE SHALL BE MONOLITHICALLY PLACED OVER THE TRAVEL LANE AND CURB OFFSET UNLESS DIRECTED OTHERWISE BY THE ENGINEER.
- 7. CARE SHALL BE EXERCISED DURING MILLING, SWEEPING AND/OR PAVING OPERATIONS TO PREVENT MILLED MATERIAL AND/OR HOT MIX ASPHALT MATERIAL FROM ENTERING DRAINAGE INLETS. SHOULD ANY OF THESE MATERIALS ENTER THE DRAINAGE STRUCTURE, THE CONTRACTOR SHALL REMOVE THESE MATERIALS AT NO ADDITIONAL COST TO THE STATE.

RIGHT OF WAY NOTES:

- 1. ALL WORK TO BE PERFORMED UNDER THIS CONTRACT WILL BE WITHIN THE PUBLIC RIGHT-OF-WAY (ROW) IN ACCORDANCE WITH SECTION 105-15 OF THE STANDARD SPECIFICATIONS. THE CONTRACTOR IS TO ASSURE HIMSELF THAT ALL WORK IS BEING PERFORMED WITHIN THE ROW, INCLUDING BUT NOT LIMITED TO VEHICLE ACCESS; STORAGE OF EQUIPMENT, MATERIALS, DEBRIS AND WASTE; LANDSCAPING; VEGETATION REMOVAL AND MANAGEMENT, GRADING, SEEDING AND THE INSTALLATION OF TURF; AND THE INSTALLATION OF ANY FENCES OR DEDICATIVE DADBLED ADDITION.
- 2. IF CONTRACTOR IS UNABLE TO IDENTIFY THE LIMITS OF THE RIGHTS-OF-WAY WHEN THE CONTRACT CALLS FOR WORK IN THOSE VICINITIES, THE CONTRACTOR MUST CONTACT THE PROJECT ENGINEER FOR DEFINITIVE BOUNDARY DETERMINATIONS BEFORE ANY WORK MAY BE INITIATED AT THOSE LOCATIONS (STANDARD SPECIFICATIONS SECTION 105-10 AND 625).
- 3. IN ACCORDANCE WITH SECTION 105-15 OF THE STANDARD SPECIFICATIONS, RELEASES FOR ANY NON-ESSENTIAL CONTRACT WORK OUTSIDE OF THE EXISTING RIGHTS-OF-WAY, INCLUDING PLANTINGS, LANDSCAPING OR DRIVEWAY ENHANCEMENT, WILL BE PROVIDED BY THE PROJECT ENGINEER AND IN NO INSTANCE ARE TO BE SECURED BY THE CONTRACTOR. THE CONTRACTOR SHALL NOT INVADE UPON PRIVATE PROPERTIES, LANDS OR BUILDINGS OUTSIDE OF THE RIGHTS-OF-WAY FOR ANY REASON WITHOUT FIRST SECURING WRITTEN PERMISSION FROM THE PROPERTY OWNER (STANDARD SPECIFICATIONS SECTION 105-15).
- 4. THE CONTRACTOR WILL BE HELD LIABLE FOR ANY DAMAGES DONE, ANY SUCH INJURIES OR DAMAGES SHALL BE SATISFACTORILY REPAIRED OR ITEMS REPLACED AT THE CONTRACTOR'S EXPENSE (STANDARD SPECIFICATIONS



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DATE

NO. DESCRIPTION BY DA		REVISIONS		
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CLIENT



CITY OF DUNKIRK

PROJECT NAME

LAKE SHORE DRIVE

DRAWING TITLE

GENERAL NOTES

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I	SCALE	DATE	
l	NONE	DECEMBER 2021	
l	P.I.N. 5763.53	FEDERAL AID PROJECT NO.	
I	SHEET NO.	DRAWING NO.	
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GENERAL NOTES

- 1. THE CONTRACTOR SHALL MAINTAIN TRAFFIC THROUGHOUT THE LENGTH OF THE CONTRACT IN ACCORDANCE WITH THE REQUIREMENTS OF SECTION 619 OF THE CURRENT NYSDOT STANDARD SPECIFICATIONS, THE NATIONAL MANUAL OF UNIFORM TRAFFIC CONTROL DEVICES (MULTCD). THE NEW YORK STATE SUPPLEMENT TO THE NATIONAL MUTCD, THE WORK ZONE TRAFFIC CONTROL DETAILS IN THE PLANS AND PROPOSAL OF THIS CONTRACT, AND AS DIRECTED BY THE FMCINFER (ADRE).
- FOR TYPICAL APPLICATIONS OF TRAFFIC CONTROL DEVICES IN CONSTRUCTION AREAS NOT SPECIFIED IN THE PLANS, THE PROVISIONS OF PART 6 OF THE MUTCD SHALL APPLY. THE STANDARDS OF APPLICATION NOTED THEREIN AND ON THE PLANS ARE TO BE CONSIDERED MINIMUM STANDARDS.
- PRIOR TO THE START OF ANY WORK OPERATIONS, ALL RELATED WORK FOR PROPOSED WORK ZONE TRAFFIC CONTROL, ADBE, SHALL BE COMPLETE. THIS INCLUDES BUT IS NOT LIMITED TO, ALL SIGNS, SIGNALS, PAVEMENT MARKINGS, BARRIERS, DELINEATION (CONES, DRUMS, ETC.), FLAGGERS, PAVEMENT MODIFICATIONS, AND ANY OTHER RELATED WORK.
- 4. THE TRAFFIC CONTROL PLANS SHOWN ARE TO BE CONSIDERED MINIMUM REQUIREMENTS. ADDITIONAL SIGNS AND/ OR TRAFFIC CONTROL DEVICES MAY BE REQUIRED AS DETERMINED BY THE ENGINEER, COST TO BE INCLUDED IN THE PRICE BID FOR THE APPROPRIATE ITEMS.
- IF AT ANY TIME THE ENGINEER DETERMINES THAT TRAFFIC IS NOT BEING PROPERLY MAINTAINED WITHIN A WORK ZONE, THE CONTRACTOR SHALL IMMEDIATELY CORRECT THE INDICATED DEFICIENCY, ADDE.
- 6. TRAFFIC CONTROL DEVICES SHALL BE KEPT IN PROPER POSITION, CLEAN, AND LEGIBLE, REGARDLESS OF VARYING CONDITIONS.
- 7. WEEDS, SHRUBBERY, CONSTRUCTION MATERIALS, EQUIPMENT, VEHICLES OR WORKERS SHALL NOT OBSCURE TRAFFIC CONTROL DEVICES OR OBSTRUCT TRAFFIC. THE CONTRACTOR SHALL BE REQUIRED TO TRIM ANY FOLIAGE OBSTRUCTING THE VISIBILITY OF ANY TRAFFIC CONTROL DEVICES WHETHER PERMANENT, TEMPORARY OR CONSTRUCTION, ADBE. THE COST SHALL BE INCLUDED IN THE PRICE BID FOR BASIC WORK ZONE TRAFFIC CONTROL.
- 8. ALL ROADWAY SURFACES ARE TO BE KEPT CLEAR OF MUD AND DEBRIS AT ALL TIMES.
- 9. THE CONTRACTOR MUST SUBMIT TO THE ENGINEER, IN WRITING, PROPOSED REVISIONS TO THE TRAFFIC CONTROL PLAN FOR REVIEW AND APPROVAL FIVE (5) WORKING DAYS PRIOR TO THE PLANNED IMPLEMENTATION OF SUCH PROPOSED REVISIONS, EXCEPT FOR CHANGES THAT ALTER THE BASIC CONCEPT OF THE TRAFFIC CONTROL PLAN. SUCH CONCEPTUAL CHANGES MUST BE SUBMITTED TO THE ENGINEER FOR APPROVAL THIRTY (30) WORKING DAYS PRIOR TO IMPLEMENTATION OF SUCH REVISIONS.
- 10. THE CONTRACTOR SHALL MAINTAIN THE PROJECT AREA AND ALL SURFACE DRAINAGE FEATURES IN A MANNER TO PROVIDE POSITIVE DRAINAGE AT ALL TIMES.
- 11. CONTRACTOR MUST MAINTAIN ONE SIDEWALK IN BOTH EAST-WEST AND NORTH-SOUTH DIRECTIONS AT ALL TIMES.
- 12. FOR ADVANCE SIGNING ON ALL APPROACHES, REFER TO DWG. NO. WZ-3.
- CONTRACTOR MUST MAINTAIN ACCESS TO ADJACENT PROPERTIES. CONTRACTOR WILL COORDINATE WITH PROPERTY OWNERS.
- 14. ALL WORK REQUIRED BY THESE NOTES AND THE WORK ZONE TRAFFIC CONTROL PLANS SHALL BE INCLUDED IN THE PRICE BID FOR ITEM 619.01 BASIC WORK ZONE TRAFFIC CONTROL INJECTS OTHERWISE STATED.
- 15. THE LUMP SUM PRICE BID FOR ITEM 619.01 BASIC WORK ZONE TRAFFIC CONTROL SHALL INCLUDE ALL EQUIPMENT, MATERIALS AND LABOR NECESSARY TO ADEQUATELY AND SAFELY MAINTAIN AND PROTECT TRAFFIC EXCEPT AS PROVIDED IN SEPARATE PAYMENT ITEMS IN THE PROPOSAL
- 16. FLASHING WARNING LIGHTS MOUNTED ON BARRICADES OR OTHER CHANNELIZING DEVICES SHALL BE A STEADY BURN, LOW INTENSITY LIGHT EXCEPT FOR THE FIRST TWO IN THE SERIES WHICH SHALL BE HIGH INTENSITY FLASHING LIGHTS. PLASTIC DRUMS OR TYPE III BARRICADES MAY BE PLACED ALONG PAVEMENT TAPERS. REFER TO NYSDOT STANDARD SHEET 619-02 AND FOR TYPE III BARRICADES WITH WARNING LIGHTS.
- 17. THE CONTRACTOR SHALL SCHEDULE THEIR CONSTRUCTION OPERATIONS IN A MANNER SO AS TO MINIMIZE THE LENGTH OF TIME THAT NORMAL TRAFFIC FLOWS ARE DISTURBED.
- 18. THE CONTRACTOR SHALL USE STEEL PLATES, TEMPORARY PAVEMENT, CONES, BARRELS, BARRICADES AND PROTECTIVE FENCING AS NECESSARY AND AS ORDERED BY THE RESIDENT ENGINEER TO PROTECT AND MAINTAIN BOTH PEDESTRIAN AND TRAFFIC FLOW WITHIN THE PROJECT AREA.
- 19. ALL EXISTING TRAFFIC SIGNAL/BEACON EQUIPMENT WITHIN THE CONTRACT LIMITS SHALL BE MAINTAINED IN WORKING ORDER FOR THE DURATION OF THIS CONTRACT. PAYMENT SHALL BE INCLUDED UNDER ITEM 619.01.
- 20. ALL WORK ZONE TRAFFIC CONTROL SHALL BE PLACED WITHIN THE EXISTING RIGHT OF WAY.

WORK ARE

- 1. WORK OPERATIONS SHALL BE CONTAINED WITHIN EACH DESIGNATED WORK AREA.
- THE CONTRACTOR SHALL COORDINATE ANY WORK WITH OTHER CONTRACTORS, UTILITY
 COMPANIES, OR MUNICIPALITIES IN ORDER TO ENSURE PROPER WORK ZONE TRAFFIC
 CONTROL IS MAINTAINED.
- 3. WHEN TWO OR MORE AREAS ARE ADJACENT, OVERLAP OR ARE IN CLOSE PROXIMITY AS DETERMINED BY THE ENGINEER, THE CONTRACTOR SHALL ENSURE THERE IS NO CONFLICTING SIGNAGE AND THAT LANE CONTINUITY IS MAINTAINED THROUGHOUT ALL WORK AREAS. WORK AREAS ARE DEFINED AS AN AREA IN WHICH TRAFFIC IS RESTRICTED BECAUSE OF CONSTRUCTION ACTIVITIES OR WHICH INVOLVES A DROP-OFF GREATER THAN 4' ADJACENT TO THE EDGE OF PAVEMENT. THE CONTRACTOR SHALL MAINTAIN A MINIMUM 500' DISTANCE BETWEEN CONSTRUCTION OPERATIONS ON ALTERNATE SIDES OF THE ROADWAY.

CONSTRUCTION VEHICLES AND EQUIPMENT

1. VEHICLES OR EQUIPMENT BELONGING TO THE CONTRACTOR OR THE CONTRACTOR'S EMPLOYEES SHALL NOT BE PARKED WITHIN THE CLEAR ZONE, ON THE PAVEMENT OR SHOULDERS ALONG THE ROADWAY WHERE PARKING IS NOT NORMALLY PERMITTED, OR ANY OTHER AREAS DEEMED HAZARDOUS BY THE ENGINEER. VEHICLES BELONGING TO THE CONTRACTOR OR THE CONTRACTOR SEMPLOYEES SHALL NOT BE PARKED IN A MANNER WHICH OBSTRUCTS SIGNS, BARRIERS, BARRICADES, OR OTHER TRAFFIC CONTROL DEVICES. VEHICLES BELONGING TO THE CONTRACTOR OR THE CONTRACTOR'S EMPLOYEES SHALL NOT BE PARKED IN A MANNER WHICH INTERFERES WITH ACCESS TO ABUTTING PROPERTIES. VEHICLES PARKED BEHIND GUIDE RAIL/ BARRIER SHALL BE PARKED BEYOND THE GUIDE RAIL/ BARRIER DEFLECTION DISTANCE.

SIGNS

- ALL TRAFFIC CONTROL DEVICES SHALL BE IN ACCORDANCE WITH THE CURRENT NATIONAL MUTCD AND NEW YORK STATE SUPPLEMENT.
- 2. ALL SIGNS, INCLUDING GUIDE SIGNS, SHALL INDICATE ACTUAL CONDITIONS AT ALL TIMES AND SHALL BE COVERED, REMOVED, RELOCATED OR CHANGED IMMEDIATELY UPON NEW SITE CONDITIONS ADRE
- 3. MOUNTING HEIGHT REQUIREMENTS FOR ALL CONSTRUCTION SIGNS SHALL BE 5' MINIMUM (MEASURED FROM NEAR EDGE OF PAVEMENT). IN LOCATIONS WHERE SIGNS WOULD INTERFERE WITH PEDESTRIANS OR BE OBSTRUCTED BY PARKED VEHICLES, THE CONTRACTOR SHALL USE A 7' MOUNTING HEIGHT. THE CONTRACTOR SHALL USE CONSISTENT SIGN MOUNTING HEIGHTS FOR SIGNS USED IN A SERIES.
- 4. ANY EXISTING SIGNS, INCLUDING OVERHEAD SIGNS, WHICH CONFLICT WITH THE WORK ZONE SIGN LAYOUT SHALL BE COVERED, REMOVED, STORED OR RESET, ADBE. BLANK COVERS USED TO COVER PORTIONS OF EXISTING SIGNS SHALL BE OF A COLOR AND REFLECTORIZED MATERIAL MATCHING THAT OF THE SIGN BEING PARTIALLY COVERED. THE CONTRACTOR SHALL RELOCATE OR COVER SIGN PANELS OR SIGN TEXT AT NO ADDITIONAL COST. ALL APPROPRIATE EXISTING SIGNS SHALL BE RESTORED TO THEIR ORIGINAL CONDITION AND/OR LOCATION UNLESS OTHERWISE REPLACED IN THIS CONTRACT. THIS WORK SHALL BE INCLUDED IN THE PRICE BID FOR BASIC WORK ZONE TRAFFIC CONTROL.
- 5. THE MODIFICATION, RELOCATION OR ADJUSTMENT OF EXISTING SIGNS FOR BASIC WORK TRAFFIC CONTROL PURPOSES, NOT ALREADY SHOWN ON THE PLANS, SHALL BE INCLUDED IN THE PRICE BID FOR BASIC WORK ZONE TRAFFIC CONTROL.
- 6. THE CORRECT SPACING, SEQUENCE AND LOCATION OF THE SIGNS SHALL BE MAINTAINED AT ALL TIMES AS SPECIFIED BY THE MUTCD. THE LOCATION OF THE SIGNS SHOWN ON THE TRAFFIC CONTROL PLANS AND DETAILS, FOUND IN THE CONTRACT DOCUMENTS, ARE APPROXIMATE. THE EXACT LOCATIONS SHALL BE DETERMINED BY THE ENGINEER.
- SIGNS AT OR NEAR INTERSECTIONS SHALL BE PLACED SO THAT THEY DO NOT OBSTRUCT A MOTORIST'S LINE OF SIGHT.
- 8. SIGN SUPPORTS SHALL CONFORM TO STANDARD SHEET 619-04 OR BE CERTIFIED TO MEET THE REQUIREMENTS OF NCHRP 350. NO SIGNS OR SUPPORTS SHALL BE STORED ON TRAVEL LANES, SHOULDERS OR SIDEWALKS AT ANY TIME. ALL TEMPORARY SIGN SUPPORTS STORED ON THE ROADWAY, OR ANY AREA THAT MAY BE TRAVERSABLE BY AN ERRANT VEHICLE, SHALL BE LAID FLAT SUCH THAT NO PART OF THE SUPPORT IS MORE THAN 4" ABOVE THE GROUND. ANY SIGN THAT IS LAID FLAT SHALL HAVE A CONE PLACED IN ADVANCE OF THE SIGN TO DELINEATE THE HAZARD. NO SIGN SUPPORTS SHALL BE LEANED AGAINST OR OVERHANG TRAFFIC BARRIER. THE FACES OF STORED SIGNS SHALL NOT BE VISIBLE TO TRAFFIC IN ANY DIRECTION, REGARDLESS OF THE ORIENTATION OF THE SIGN.
- 9. THE CONTRACTOR SHALL RELOCATE STREET NAME AND DESTINATION SIGNS AS NECESSARY TO PROVIDE VISIBLE DESTINATION SIGNING IN ACCORDANCE WITH THE MUTCD AT ALL TIMES.
- CONTRACTOR MUST MAINTAIN ALL EXISTING REGULATORY, WARNING & PARKING SIGNS UNTIL SUCH TIME AS THEY ARE REPLACED.

DELINEATION AND GUIDING DEVICES

- DELINEATION AND GUIDING DEVICES AT OR NEAR INTERSECTIONS SHALL BE PLACED SO THAT THEY DO NOT OBSTRUCT A MOTORIST'S LINE OF SIGHT.
- THE CONTRACTOR IS RESPONSIBLE FOR FREQUENT CHECKS OF THE CHANNELIZING DEVICES THROUGHOUT THE WORK ZONE TO RESET DEVICES DISLODGED BY TRAFFIC. ADEQUATE BALLAST SHALL BE PROVIDED TO ENSURE THAT DEVICES ARE NOT DISLODGED BY PASSING TRAFFIC.
- WHERE POSSIBLE ALL DELINEATION AND GUIDING DEVICES ARE TO BE PLACED SO AS TO PROVIDE A MINIMUM 2' CLEARANCE TO THE TRAVELED WAY UNLESS OTHERWISE SHOWN ON THE PLANS.
- 4. ALL TRAFFIC CONTROL DEVICES INITIALLY FURNISHED FOR THIS PROJECT SHALL BE IN ACCEPTABLE CONDITION AS DEFINED BY THE GUIDELINES PAMPHLET DEVELOPED BY THE AMERICAN TRAFFIC SAFETY SERVICE ASSOCIATION (ATSSA), AS THE CONDITION OF DEVICES DETERIORATE OVER TIME, THOSE THAT FALL BELOW THE MARGINAL CATEGORY SHALL BE REPLACED.
- 5. WHERE NECESSARY TO PERMIT INGRESS OR EGRESS BY CONSTRUCTION VEHICLES, A GAP MAY BE PROVIDED BETWEEN CHANNELIZING DEVICES, NOT TO EXCEED THE DELINEATION OF FUERY FIFTH DEVICE
- 6. PAYMENT FOR CHANNELIZATION DEVICES IS INCLUDED UNDER ITEM 619.01 BASIC WORK ZONE TRAFFIC CONTROL, UNLESS PROVIDED FOR WITH SPECIFIC ITEMS IN THE CONTRACT SPECIFICATIONS.

PUBLIC ACCESS

- THE CONTRACTOR SHALL PLAN AND INCORPORATE ACCESS POINTS INTO THE WORK ZONE SUCH THAT, TO THE EXTENT PRACTICAL, THE CONTRACTOR'S VEHICLES ENTERING AND LEAVING THE WORK ZONE SHALL NOT IMPEDE THE MOVEMENT OF THROUGH TRAFFIC IN THE ADJACENT OPEN LANES.
- 2. PROPERTY OWNERS WHOSE DRIVEWAYS WILL BE MADE INACCESSIBLE SHALL BE NOTIFIED BY THE CONTRACTOR AT LEAST 24 HOURS PRIOR TO RESTRICTING USE OF THE DRIVE. ACCESS SHALL BE RESTORED WITHIN 24 HOURS. THE CONTRACTOR SHALL MAINTAIN ACCESS TO COMMERCIAL DRIVEWAYS AT ALL TIMES WHEN A FACILITY IS IN USE, FOR MULTIPLE ACCESS PROPERTIES, ONLY ONE DRIVEWAY MAY BE CLOSED AT A TIME.

PUBLIC ACCESS (CONTINUING)

3. SUITABLE RAMPS SHALL BE INSTALLED TO MAINTAIN SMOOTH TRANSITIONS FROM RESIDENTIAL AND COMMERCIAL DRIVEWAYS TO AND FROM THE WORK AREA. THE MATERIAL SHALL CONSIST OF CRUSHED STONE OR ASPHALT CONCRETE, WHICHEVER IS DEEMED MORE APPROPRIATE FOR THE CIRCUMSTANCE, ADBE. PLASTIC DRUMS OR OTHER APPROVED TRAFFIC CONTROL DEVICES SHALL BE USED TO DELINEATE THE DRIVEWAY AND TO CONTROL ACCESS DURING NON-WORKING HOURS. THE COST OF THIS WORK SHALL BE INCLUDED IN THE PRICE FOR BASIC WORK TRAFFIC CONTROL.

LANE CLOSURES

- A SINGLE, LONG LANE CLOSURE IS PREFERRED OVER A SERIES OF SUCCESSIVE SHORTER LANE CLOSURES. THE LENGTH OF THE LANE CLOSURE SHALL BE THE MINIMUM NECESSARY TO ACCOMPLISH THE PLANNED WORK SAFELY AND EFFICIENTLY. THE APPROPRIATE LENGTH OF LANE CLOSURE SHALL BE DETERMINED BY THE CONTRACTOR AND APPROVED BY THE ENGINEER.
- 2. THE CONTRACTOR SHALL START SHORT TERM LANE CLOSURES TO PROVIDE OPTIMUM VISIBILITY (I.E. BEFORE CURVE AND CRESTS) TO THE EXTENT THAT PROJECT AND TRAFFIC CONDITIONS PERMIT.
- THE CONTRACTOR SHALL NOT MIX CHANNELIZATION DEVICES IN A LINEAR CLOSURE OR TAPER (I.E. CONES, VERTICAL PANELS AND DRUMS SHALL NOT BE USED IN THE SAME TAPER OR CLOSURE). HOWEVER, DIFFERENT CHANNELIZATION DEVICES MAY BE USED IN DIFFERENT AREAS OF A PROJECT.
- 4. IF, IN THE OPINION OF THE ENGINEER, SHORT TERM LANE CLOSURES ARE CREATING EXCESSIVE DELAYS TO TRAFFIC OR ARE CREATING A SAFETY CONCERN DUE TO SLOW OR STOPPED TRAFFIC, AFFECTED LANE CLOSURES SHALL BE REMOVED AND THE ROADWAY OPENED TO TRAFFIC AT NO ADDITIONAL COST TO THE VILLAGE.
- 5. THE CONTRACTOR SHALL USE DRUMS FOR ANY LANE CLOSURES OR SHOULDER CLOSURES WHICH ARE TO REMAIN OVERNIGHT.

FLAGGER

- THE USE OF TEMPORARY SIGNALS AS A SUBSTITUTE FOR FLAGGERS WILL NOT BE ALLOWED ON THIS PROJECT.
- 2. THE CONTRACTOR SHALL PROVIDE FLAGGERS AS SHOWN ON THE PLANS, OR ADBE, TO CONTROL TRAFFIC MOVEMENT AT THE SITE OF WORK OPERATIONS THAT REQUIRE CLOSURE OF PORTIONS OF THE TRAVELED WAY.
- FLAGGING OPERATIONS FOR THIS PROJECT SHALL BE IN ACCORDANCE WITH SECTION 619
 OF THE STANDARD SPECIFICATIONS.
- 4. FLAGGERS SHALL BE PROVIDED WITH HAND HELD AUDIBLE ALARMS TO WARN OF VEHICLE INTRUSIONS.
- FLAGGER SIGNS SHALL NOT BE USED FOR BRIEF PERIODS OF INCIDENTAL FLAGGING, ADBE-FLAGGER SIGNS SHALL NOT BE VISIBLE WHEN FLAGGERS ARE NOT BEING USED.
- 6. AT ALL TIMES, THE CONTRACTOR SHALL PROVIDE FLAGGERS WITH A CLEAR ESCAPE PATH, FREE OF PARKED VEHICLES, EQUIPMENT OR OTHER OBSTACLES. THE FLAGGING STATION SHOULD NOT BE LOCATED IN LANES BEING USED BY MOVING TRAFFIC, WHERE WORKERS GATHER OR WHERE THE FLAGGER'S VEST WOULD NOT CONTRAST WITH THE BACKGROUND. THE STATION SHALL BE LOCATED FAR ENOUGH AHEAD OF THE WORK SPACE SO THAT APPROACHING TRAFFIC HAS SUFFICIENT DISTANCE TO STOP BEFORE ENTERING THE WORK SPACE. THE FLAGGER SHOULD MOVE INTO A LANE ONLY AFTER TRAFFIC HAS STOPPED AND ONLY IF THE FLAGGER NEEDS TO BE VISIBLE TO OTHER TRAFFIC OR MUST COMMUNICATE WITH DRIVERS.
- 7. WHERE FLAGGERS ARE UNABLE TO COORDINATE THEIR ACTIONS BY USING VOICE OR VISUAL SIGNALS, COMMUNICATION EQUIPMENT WILL BE NECESSARY. DEVICES SUCH AS INTERCOMS, TWO-WAY RADIOS, WALKIE TALKIES, FLAGS OR TOKEN CARRIED BY MOTORISTS, MAY BE EMPLOYED, ANY RADIO EQUIPMENT USED SHOULD BE OF A TYPE WHICH DOES NOT REQUIRE CONSTANT USE OF A FLAGGERS HAND. THE COST FOR REQUIRED COMMUNICATION EQUIPMENT SHALL BE INCLUDED IN THE PRICE BID FOR BASIC WORK ZONE TRAFFIC CONTROL.

SURFACE CONDITION

- I. TEMPORARY SLOPED TAPERS REQUIRED PER STANDARD SPECIFICATION 619-3.02 SHALL BE CONSTRUCTED FROM BITUMINOUS PATCHING MATERIAL (PLANT MIX OR SUITABLE WINTER MIX). THESE TAPERS SHALL BE MAINTAINED AND REMAIN IN PLACE UNTIL THE NEED FOR TAPERING IS ELIMINATED BY SUBSEQUENT WORK. THE COST FOR THIS WORK SHALL BE
- 2. WHEN MAINTAINING TRAFFIC ON PAVED OR MILLED SURFACES, THE CONTRACTOR SHALL MARK ALL HAZARDS PROJECTING UP FROM THE DRIVING SURFACE (I.E. VALVES, MANHOLES, ETC.). THE CONTRACTOR SHALL PROVIDE TEMPORARY SLOPED TAPERS FOR ALL VALVES, MANHOLES, ETC. LOCATED WITHIN THE TRAVEL LANES. THE CONTRACTOR IS RESPONSIBLE FOR PLACEMENT AND REMOVAL OF THESE TAPERS. TEMPORARY TAPERS SHALL BE CONSTRUCTED FROM BITUMINOUS PATCHING MATERIAL (PLANT MIX OR SUITABLE WINTER MIX). FOR VALVES, MANHOLES, ETC. LOCATED OUTSIDE THE ACTUAL TRAVEL LANES (I.E. SHOULDERS, CENTERLINE) THE CONTRACTOR MAY MARK THE FEATURE AS HAZARD WITH A DRUM. IF TAPERING IS NOT POSSIBLE, ALL VALVES, MANHOLES. ETC. LOCATED WITHIN AN INTERSECTION SHALL BE TAPERD. THESE TAPERS SHALL BE MAINTAINED AND REMAIN IN PLACE UNTIL THE NEED FOR TAPERING IS ELIMINATED BY SUBSEQUENT WORK, THE COST OF THIS WORK, INCLUDING REMOVAL OF TAPERS, SHALL BE INCLUDED IN BASIC WORK ZONE TRAFFIC CONTROL, ITEM 619.01.
- WHEN TRAFFIC IS MAINTAINED ON A ROADWAY DURING WORK OPERATIONS, THE CONTRACTOR SHALL NOT LEAVE LONGITUDINAL DROP-OFFS EXPOSED TO TRAFFIC AT THE END OF THE DAY.

IF STEEL PLATES ARE USED IN THE ROADWAY, DRUMS WITH FLASHERS NEED TO BE LOCATED AT THE PLATE. STEEL PLATE AHEAD AND BUMPP SIGNS ARE REQUIRED.



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1/6/2022

DATE

NOTE: UNAUTHORIZED ALTERATION OR ADDITION TO THIS DRAWING IS A VIOLATION OF THE NEW YORK STATE EDUCATION LAW ARTICLE 145, SECTION 7209.

DATE

	REVISIONS		
NO.	DESCRIPTION	BY	DATE

<u>CLIENT</u>



CITY OF DUNKIRK

PROJECT NAME

LAKE SHORE DRIVE

DRAWING TITLE

WORK ZONE TRAFFIC CONTROL NOTES

SCALE	DATE
N.T.S	DECEMBER 2021
p.i.n. 5763.53	FEDERAL AID PROJECT NO.
SHEET NO.	DRAWING NO.
9 of 94	WZ-01

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PAVEMENT MARKINGS

- TECHNIQUES FOR REMOVAL OR COVERING OF PAVEMENT MARKINGS ARE SUBJECT TO APPROVAL BY THE ENGINEER.
- 2. MAINTENANCE OF TEMPORARY OR INTERIM MARKINGS SHALL INCLUDE REMARKING AREAS WHERE THE ENGINEER DETERMINES THE MARKINGS ARE NOT CLEAR, NO LONGER EFFECTIVE OR COULD POTENTIALLY MISGUIDE MOTORISTS. THIS SHALL INCLUDE REAPPLYING, IF REQUIRED, PRIOR TO AND JUST AFTER WINTER SHUT-DOWN PERIODS ISOLATED AREAS OUTSIDE OF PREVIOUSLY DISTURBED CONSTRUCTION ZONES, WHERE EXISTING PAVEMENT MARKINGS HAVE BEEN OBLITERATED BY THE CONTRACTOR'S OPERATIONS. THERE WILL BE NO ADDITIONAL PAYMENT FOR THIS WORK EXCEPT AS NOTED IN SECTION 619.
- EXISTING PAVEMENT MARKINGS OUTSIDE OF PREVIOUSLY DISTURBED CONSTRUCTION ZONES SHALL BE MAINTAINED AND RE-STRIPED IF REQUIRED BY THE ENGINEER. THIS MAY INCLUDE, BUT NOT BE LIMITED TO RE-STRIPING THE EXISTING ROADWAY PRIOR TO OR DIRECTLY AFTER WINTER SHUTDOWN AND/OR RE-STRIPING AREAS THAT ARE NOT SCHEDULED DIRECTED BY THE OPERATION OF UTILITY COMPANIES SHALL BE MAINTAINED BY THE NOT SCHEDULED FOR WORK UNTIL LATER PHASES OF CONSTRUCTION. EXISTING MARKINGS, LETTERS AND SYMBOLS WILL BE RE-APPLIED AS NECESSARY, ADBE. PAVEMENT MARKINGS THAT HAVE BEEN OBLITERATED BY THE OPERATION OF UTILITY COMPANIES SHALL BE MAINTAINED AS DIRECTED BY THE ENGINEER. PAVEMENT MARKINGS APPLIED AS INDICATED IN THIS PARAGRAPH WILL BE PAID FOR UNDER THE APPROPRIATE 685 SERIES ITEM -REFLECTORIZED PAVEMENT MARKING EPOXY.

NOTIFICATIONS AND EMERGENCY ACCESS

- 1. THE CONTRACTOR SHALL SUBMIT TO THE APPROPRIATE LAW ENFORCEMENT AND EMERGENCY AGENCIES IN WRITING THE NAME, ADDRESS AND REACHABLE TELEPHONE NUMBERS OF THE PERSON(S) AUTHORIZED TO SECURE LABOR, MATERIALS AND EQUIPMENT FOR EMERGENCY REPAIRS OUTSIDE OF NORMAL WORKING HOURS. DUPLICATE COPIES OF THE ABOVE SHALL BE FILED WITH THE RESIDENT ENGINEER.
- 2. AT LEAST ONE 10' WIDE TRAVEL LANE OF SAFELY TRAVERSABLE ROAD MUST BE MAINTAINED THROUGHOUT THE PROJECT AREA AT ALL TIMES FOR EMERGENCY VEHICLES. AUTHORITIES RESPONSIBLE FOR EMERGENCY SERVICES MUST BE NOTIFIED IN ADVANCE OF ANY SUBSTANTIAL CHANGE IN TRAFFIC PATTERNS. WORK ON ONE SIDE OF THE HIGHWAY SHALL BE COMPLETED PRIOR TO ESTABLISHING A WORK AREA ON THE OPPOSITE SIDE.
- THE CONTRACTOR IS REQUIRED TO CONTACT THE APPROPRIATE SCHOOL AND EMERGENCY SERVICES ORGANIZATIONS WITH RESPECT TO THE EFFECT OF ROAD WORK, TRAVEL LANE REDUCTIONS, DETOURS ON OPERATIONS, OR IN ADVANCE OF ANY SUBSTANTIAL CHANGE IN TRAFFIC PATTERNS. THIS CONTACT SHALL BE MADE AS CONDITIONS CHANGE AND AT LEAST TWO WEEKS PRIOR TO IMPLEMENTING EACH TRAFFIC PHASE AND/OR DETOUR TO ALLOW ADEQUATE TIME FOR THE ORGANIZATIONS TO COORDINATE AND MAKE NECESSARY ADJUSTMENTS TO RESPONSE SCHEDULES AND ROUTES.
- THE CONTRACTOR IS REQUIRED TO CONTACT THE APPROPRIATE TRANSIT OFFICIALS IN THE CUNTRACTOR IS REQUIRED TO CONTACT THE APPROPRIATE TRANSIT OFFICIALS IN RESPECT TO THE EFFECT OF ROAD ALTERATIONS ON BUS OPERATIONS. THIS SHOULD BE DONE FOUR WEEKS IN ADVANCE OF ANY CHANGES IN TRAFFIC PATTERNS OR IMPLEMENTATION OF WORK ZONES SO THAT THERE WILL BE ADEQUATE TIME FOR TRANSIT OFFICIALS TO NOTIFY PERSONNEL OF THE EFFECTS TO SCHEDULES AND ROUTES. THE CONTRACTOR SHALL MAKE PROVISIONS FOR THE SAFE INCRESS AND EGRESS OF PASSENGERS AT EXISTING OR TEMPORARILY RELOCATED BUS STOPS.

TRAFFIC SIGNALS

- 1. THE CONTRACTOR SHALL BE REQUIRED TO MAINTAIN EXISTING TRAFFIC SIGNAL EQUIPMENT FROM THE START OF WORK UNTIL ACCEPTANCE BY SIGNAL MAINTENANCE ENGINEER. THE COST FOR MAINTAINING EXISTING TRAFFIC SIGNAL EQUIPMENT SHALL BE INCLUDED IN THE PRICE BID FOR MAINTAIN TRAFFIC SIGNAL EQUIPMENT (REQUIREMENT A). THE CONTRACTOR SHALL NOTIFY THE EIC OF THE DATE ON WHICH THE CONTRACTOR WILL ASSUME MAINTENANCE RESPONSIBILITY.
- 2. THE CONTRACTOR SHALL NOTIFY THE NYS SIGNAL MAINTENANCE DEPARTMENT THREE WORKING DAYS PRIOR TO ASSUMING MAINTENANCE, STARTING WORK IN THE AREA, OR DISTURBING
- 3. WORK OPERATIONS (I.E. ASPHALT PAVING) WHICH PASS THROUGH AN EXISTING SIGNALIZED WORK OPERATIONS (I.E. ASPHALL PAVING WHILE PASS INTOLOFI AN EAST THE STREET AS A PARTY OF THE TRAFFIC SIGNALS TO BE TURNED OFF AND THE INTERSECTION FLAGGED. THE CONTRACTOR SHALL NOTIFY THE EIC THREE WORKING DAYS PRIOR TO PERFORMING WORK.
- TEMPORARY REALIGNMENT OF EXISTING TRAFFIC SIGNAL HEADS TO ACCOMMODATE TEMPORARY TRAVEL LANES OR BAGGING OF EXISTING SIGNAL HEADS THAT ARE NOT USED MAY BE NECESSARY DURING STAGED CONSTRUCTION. RELOCATION SHALL BE DETERMINED BY THE EIC. PAYMENT FOR REALIGNMENT, RELOCATION OR BAGGING SHALL BE IN THE PRICE BID
- 5. TRAFFIC SIGNAL CONTROLLER PROGRAMMING CHANGES SHALL ONLY BE PERFORMED BY NYS SIGNAL MAINTENANCE PERSONNEL.
- 6. THE CONTRACTOR SHALL REQUEST PERMISSION FROM THE ENGINEER AND NYSDOT SIGNAL MAINTENANCE ENGINEER TO ENTER INTO ANY EXISTING TRAFFIC SIGNAL CONTROLLER CABINET OR DO ANY WORK ON AN EXISTING TRAFFIC SIGNAL.
- 7. PEDESTRIAN TRAFFIC SIGNAL DISPLAYS CONTROLLING CLOSED CROSSWALKS SHALL BE COVERED OR REMOVED.

BICYCLISTS AND PEDESTRIANS

- 1. THE CONTRACTOR SHALL PROVIDE. DELINEATE AND MAINTAIN A USABLE TRAVEL PATH FOR THE CONTRACTOR SHALL PROVIDE, DELINEATE AND MAINTAIN A USABLE TRAVEL PATH FOR PEDESTRIANS EITHER THROUGH OR AROUND WORK ZONES FOR THE DURATION OF THIS PROJECT, IN ACCORDANCE WITH THE PLANS. THE TRAVEL PATH SHALL COMPLY WITH THE "CONTINUOUS PASSAGE" PROVISIONS OF THE CURRENT AMERICANS WITH DISABILITIES ACT ACCESSIBILITY GUIDELINES (ADAAG). THE CONTRACTOR MAY UTILIZE ANY COMBINATION OF THE FOLLOWING TO PROVIDE THE USABLE TRAVEL PATH. EXISTING OF THE FOLLUSING TO PROTOE THE USABLE TRAVEL FAIT EALSTING
 SIDEWALKS/SHOULDERS; TEMPORARY SIDEWALKS/SHOULDERS; FINAL SIDEWALKS/SHOULDERS;
 AND EXISTING OR TEMPORARY SIDEWALK CURB RAMPS. THE USABLE TRAVEL PATH SHALL BE
 CLEARLY MARKED AND STAGED BETWEEN INTERSECTING ROADS TO ENSURE SAFE PEDESTRIAN
 CROSSING AND ACCESSIBILITY. PEDESTRIAN ACCESS TO RESIDENTIAL AND COMMERCIAL PROPERTIES SHALL BE MAINTAINED FOR THE DURATION OF CONSTRUCTION.
- 2. THE CONTRACTOR SHALL CONDUCT WORK OPERATIONS TO MINIMIZE THE INTERRUPTION OF PEDESTRIAN TRAFFIC. THE TEMPORARY STORAGE OF CONSTRUCTION EQUIPMENT OR MATERIALS SHALL NOT BE PERMITTED ON ANY USABLE TRAVEL PATH THAT IS OPEN TO
- 3. IF TEMPORARY SIDEWALK IS CONSTRUCTED AS PART OF THE USABLE TRAVEL PATH, IT SHALL BE ASPHALT CONCRETE MEETING THE REQUIREMENTS OF SECTION 608 OF THE NYSDOT STANDARD SPECIFICATIONS. ALL TEMPORARY SIDEWALK SHALL MEET THE FOLLOWING CRITERIA, IN ADDITION TO THOSE CONTAINED IN THE ADAAG:

 - A. MINIMUM SIDEWALK WIDTH = 5 FT.

 B. MAXIMUM SIDEWALK CROSS SLOPE = 2.0% (1:50)
 C. THICKNESS OF ASPHALT CONCRETE SIDEWALK = 2"
 - C. INICANESS OF ASTRALI CONCRETE SIDEWALK S. TO BE INSTALLED IN AREAS OF EXISTING GRASS, STRIP TURE TO A DEPTH OF 2" BEFORE INSTALLATION.

 E. MAX. LONGITUDINAL SLOPE = 5%
 F. TEMPORARY CURB RAMPS AS PER NYSDOT STANDARD SHEETS
- 4. ALL LABOR, MATERIALS AND EQUIPMENT NECESSARY TO INSTALL AND REMOVE TEMPORARY SIDEWALK AND CURB RAMPS, INCLUDING THE RESTORATION OF DISTURBED AREAS, SHALL BE INCLUDED IN THE PRICE BID FOR 619.01 BASIC WORK ZONE TRAFFIC CONTROL.
- 5. "SIDEWALK CLOSED" SIGNS SHALL BE PLACED WHEN A USABLE TRAVEL PATH IS CLOSED TO PEDESTRIAN TRAFFIC. ADDITIONAL SIGNS SHALL BE PLACED TO DIRECT PEDESTRIANS TO AN ALTERNATE ACCESSIBLE ROUTE. ALL SIGNS SHALL BE INCLUDED IN THE PRICE BID FOR BASIC WORK 70NF TRAFFIC CONTROL.
- 6. TEMPORARY SAFETY FENCING SHALL BE PLACED ALONG ANY SIDEWALK ADJACENT TO ANY EXCAVATION OR VERTICAL DROP-OFF OVER 6'. SAFETY FENCING SHALL BE CONTINUOUS PLASTIC FLUORESCENT ORANGE SUPPORTED BY METAL OR WOOD POSTS. THE FENCING SHALL BE A MINIMUM OF 4' IN HEIGHT AND MAY INCLUDE A TOP AND BOTTOM RAIL TO PROVIDE ADDITIONAL SUPPORT, ADBE. THE SAFETY FENCE SHALL CONFORM TO SECTION 107-05 OF THE STANDARD SPECIFICATIONS. ALL LABOR, MATERIALS AND EQUIPMENT NECESSARY TO INSTALL AND REMOVE TEMPORARY SAFETY FENCING SHALL BE INCLUDED IN THE PRICE BID FOR WORK ZONE TRAFFIC CONTROL.
- THE CONTRACTOR SHALL MAINTAIN A SAFE, TRAVERSABLE PEDESTRIAN ROUTE, INCLUDING CURB RAMPS, MEETING A.D.A.A.G. REQUIREMENTS ON ONE SIDE OF THE ROAD AT ALL TIMES, AND MUST PROVIDE ACESS TO BUSINESSES, RESIDENTS, BUS STOPS, CROSSWALKS,
- 8. ANY CONSTRUCTION ACTIVITY THAT RESULTS IN THE BREAKAGE OF SLABS OR THE REMOVAL OF SEGMENTS OF EXISTING SIDEWALK SERVING AS THE USABLE TRAVEL PATH SHALL BE REPAIRED IMMEDIATELY USING ASPHALT CONCRETE MEETING THE REQUIREMENTS OF SECTION 608 OF THE NYSDOT STANDARD SPECIFICATIONS. THE REPAIRED SURFACE SHALL BE IN CONFORMANCE WITH THE CRITERIA OUTLINED ABOVE, AS WELL AS THOSE CONTAINED IN THE ADAAG. SIDEWALK REPAIRS DUE TO REQUIRED CONSTRUCTION ACTIVITIES SHALL BE PAID FOR 619.01 - BASIC WORK ZONE TRAFFIC CONTROL THAT IS DAMAGED BY CARELESS CONSTRUCTION ACTIVITIES OR PRACTICES SHALL BE IMMEDIATELY REPAIRED, ADBE, AT NO
- 9. THE INSTALLATION OF TEMPORARY/ FINAL SIDEWALK SHALL BE STAGED SO THAT WORK IS STARTED AND COMPLETED ON ONE SIDE OF THE ROAD PRIOR TO THE START OF WORK ON THE OPPOSITE SIDE OF THE ROAD. WHEN A SECTION OF THE SIDEWALK/ USABLE TRAVEL PATH MUST BE CLOSED AND PEDESTRIAN TRAFFIC IS SHIFTED TO THE SIDEWALK/ USABLE TRAVEL PATH ON THE OPPOSITE SIDE OF THE ROAD, PEDESTRIANS SHALL BE DIRECTED TO CROSS AT THE NEXT AVAILABLE INTERSECTION. AT NO TIME SHALL TEMPORARY MID-BLOCK PEDESTRIAN CROSSINGS BE PERMITTED.

MISCELL ANEOUS

- EXCAVATION AND BACKFILL OPERATIONS FOR NEW DRAINAGE WILL BE SCHEDULED BY THE CONTRACTOR SUCH THAT THERE WILL BE NO OPEN EXCAVATIONS IN THE ROADWAY AT NIGHT. THE CONTRACTOR'S SCHEDULE SHALL ALSO MINIMIZE THE AMOUNT OF EXCAVATION LEFT OUTSIDE THE ROADWAY AT NIGHT AS DIRECTED BY THE ENGINEER.
- 2. IF FOR UNFORESEEN REASONS A PAVEMENT REPAIR AREA CANNOT BE OPENED FOR TWO-WAY TRAFFIC PRIOR TO NIGHTFALL, FULL DEPTH REPAIRS SHALL BE FILLED COMPLETELY WITH GRAVEL ADBE. ALL COSTS TO PLACE AND REMOVE GRAVEL SHALL BE INCLUDED IN THE PRICE BID FOR BASIC WORK ZONE TRAFFIC CONTROL.
- 3. TEMPORARY PAVEMENT MIGHT BE NECESSARY IN PLACES WHERE BACKFILLED DRAINAGE TRENCHES CROSS THE ROADWAY (ADBE). PAYMENT FOR THIS TEMPORARY PAVEMENT WILL BE MADE UNDER ITEM 402.198904.
- 4. TYPE III BARRICADES WITH FENCING SHALL BE USED AROUND EXCAVATIONS.

	GENERAL TIME RESTRICTIONS				
ROADWAY	DESCRIPTION OF PROPOSED WORK	DATE	DAY	TEMPORARY LANE SHIFTS / LANE AND SHOULDER CLOSURES ARE NOT ALLOWED FROM	
NYS ROUTE 5	CENTRAL AVENUE MILL & PAVE	AFTER LABOR DAY HOLIDAY TIME RESTRICTIONS	SAT-SUN	ALL DAY	
NYS ROUTE 5	CURB BUMP-OUTS MEDIAN ISLANDS	-	SAT-SUN	ALL DAY	

PROJECT SPECIFIC

1. A CONTINUOUS SIDEWALK SYSTEM AND PEDESTRIAN ROUTE, ETC. SHALL BE MAINTAINED ON ONE SIDE OF THE ROAD AT ALL TIMES. THE SIDEWALK AREAS UNDER CONSTRUCTION WILL BE CLOSED WITH APPROPRIATE SIGNAGE THAT SAFELY REDIRECTS PEDESTRIAN TO THE

NYSDOT STANDARD SHEETS FOR WORK ZONE TRAFFIC CONTROL

THE CONTRACTOR SHALL REFERENCE THE FOLLOWING NYSDOT STANDARD SHEETS FOR WORK ZONE TRAFFIC CONTROL FOR THE PROJECT:

619-02 TYPE III CONSTRUCTION BARRICADES 619-04 PORTABLE TEMPORARY WOODEN SIGN SUPPORT 619-10 WORK ZONE TRAFFIC CONTROL GENERAL NOTES 619-11 WORK ZONE TRAFFIC CONTROL LEGEND AND NOTES 619-20 SHOULDER CLOSURE 2-LANE 2-WAY ROADWAY 619-21 SHOULDER CLOSURE 2-LANE 2-WAY ROADWAY MULTIPLE WORK LOCATIONS 619-50 SIDEWALK DETOUR OR DIVERSION

619-51 SIDEWALK CLOSURE AND PEDESTRIAN DETOUR 619-60 FLAGGING OPERATION 2-LANE 2-WAY ROADWAY 619-61 FLAGGING OPERATION 2-LANE 2-WAY ROADWAY INTERSECTION

LAKE SHORE DRIVE WZTC SEQUENCING

619-12 SIGN TABLE

- 1. ALL APPLICABLE ADVANCE WARNING OR OTHER LONG-TERM CONSTRUCTION SIGNS SHALL BE INSTALLED PRIOR TO BEGINNING ANY WORK OPERATIONS.
- 2. INSTALL EROSION AND SEDIMENT CONTROL MEASURES THROUGHOUT THE PROJECT LIMITS
- PERFORM EXCAVATION AND CONSTRUCT PROPOSED DRAINAGE, CURB BUMP-OUTS, SIDEWALK, AND INSTALL TRAFFIC SIGNAL EQUIPMENT. UTILIZE DAILY SINGLE LANE CLOSURE ACCORDING TO DETAIL ON DWG. NO. WZ-4. THE DAILY WORK ZONE SHOULD BE LIMITED IN LENGTH BY CONTRACTOR'S ABILITY TO EXCAVATE FOR CURB AND PLACE COMPACTED SUBBASE BY THE FORD OF FACH WROPP DAILY. BY THE END OF EACH WORK DAY.
- 4. PRIOR TO THE CONSTRUCTION OF PROPOSED CURB BUMP-OUTS AT CENTRAL AVENUE, MILL AND PAVE CENTRAL AVENUE INTERSECTION. FOLLOW GENERAL/TIME RESTRICTIONS LISTED ON THIS SHEET. FOLLOW *3 AFTER PAVING OF INTERSECTION IS COMPLETE.
- PERFORM EXCAVATION AND CONSTRUCT MEDIAN CURB ISLANDS. UTILITZE DAILY CENTER TURN LANE CLOSURE ACCORDING TO THE DETAIL ON DWG. NO. WZ-5. THE DAILY WORK ZONE SHOULD BE LIMITED IN LENGTH BY CONTRACTOR'S ABILITY TO EXCAVATE FOR CURB AND PLACE COMPACTED SUBBASE BY THE END OF EACH WORK DAY.
- 6. PLANT STREET TREES AND PLACE TOPSOIL IN TREE LAWN AREAS.
- COMPLETE FINAL GRADING, LANDSCAPING, LAWN REPAIRS AND RESTORATION, PERMANENT SEEDING AND ESTABLISH TURF, PAVEMENT MARKINGS, AND SIGNS.

TIME RESTRICTIONS

- 1. NIGHT WORK AND WEEKEND WORK IS PROHIBITED. WORKING HOURS SHALL BE BETWEEN 7AM
- 2. THE TIME RESTRICTIONS LISTED ARE TO BE IMPLEMENTED THROUGHOUT THE DURATION OF THE PROJECT, NO DEVIATIONS ARE ALLOWED WITHOUT PRIOR APPROVAL FROM THE REGIONAL TRAFFIC ENGINEER OR DESIGNEE, IF, IN THE OPINION OF THE EIC SHORT TERM LANE CLOSURES ARE CREATING EXCESSIVE DELAYS TO TRAFFIC OR ARE CREATING A SAFETY CONCERN DUE TO SLOW OR STOPPED TRAFFIC, THE CLOSURES SHALL BE REMOVED AND THE
- THE TIME RESTRICTIONS LISTED ARE BASED ON ANTICIPATED TRAFFIC VOLUMES. IF, AT THE TIME OF CONSTRUCTION, THE TRAFFIC VOLUMES APPEAR TO ALLOW EXTENDED WORK HOURS, AN ADJUSTMENT TO THE TIME RESTRICTIONS MAY BE PROPOSED. ANY REQUESTS FOR REVISIONS TO THE TIME RESTRICTIONS SHALL BE SUBMITTED IN WRITING TO THE EIC FOR APPROVAL BY THE REGIONAL TRAFFIC ENGINER OR DESIGNEE. THE CONTRACTOR SHOULD NOT ASSUME THAT THE REVISIONS TO THE STATED TIME RESTRICTIONS WILL BE PERMITTED.
- THE DEPARTMENT RESERVES THE RIGHT TO CANCEL ANY WORK OPERATIONS, INCLUDING LANE CLOSURES AND/OR TOTAL ROAD CLOSURES, THAT WOULD CREATE TRAFFIC DELAYS BY UNFORSEEN EVENTS. THE CONTRACTOR WOULD BE NOTIFIED AT LEAST SEVEN (7) CALENDAR DAYS PRIOR TO THE PROPOSED WORK.

DATE RESTRICTIONS

- 1. THE CONTRACTOR SHALL BE LIMITED TO PERFORMING WORK ASSOCIATED WITH THE PAVEMENT OF CENTRAL AVENUE INTERSECTION AFTER LABOR DAY ONLY.
- 2. THE CONTRACTOR SHALL BE AWARE OF INCREASED TRAFFIC VOLUMES DUE TO FISHING TOURNAMENT WEEK OF AUGUST 21-28. NO LANE CLOSURES ARE ALLOWED DURING THIS TIME

HOLIDAY TIME RESTRICTIONS				
HOLIDAY	FALLS ON	TEMPORARY LANE AND SHOULDER CLOSURES ARE NOT ALLOWED FROM		
	SUNDAY OR MONDAY	6:00 AM FRIDAY BEFORE TO 6:00AM TUESDAY AFTER		
NEW YEAR'S DAY INDEPENDENCE DAY CHRISTMAS DAY	TUESDAY	6:00 AM SATURDAY BEFORE TO 6:00 AM WEDNESDAY AFTER (STARTING AT 6:00 AM FRIDAY BEFORE TO 6:00 AM WEDNESDAY AFTER FOR CHRISTMAS DAY)		
	WEDNESDAY	6:00 AM TUESDAY BEFORE TO 6:00 AM THURSDAY AFTER (STARTING AT 6:00 AM SATURDAY BEFORE TO 6:00 AM THURSDAY AFTER FOR CHRISTMAS DAY)		
	THURSDAY	6:00 AM THURSDAY TO 6:00 AM MONDAY AFTER (STARTING AT 6:00 AM WEDNESDAY BEFORE TO 6:00 AM MONDAY AFTER FOR CHRISTMAS DAY)		
	FRIDAY OR SATURDAY	6:00 AM THURSDAY BEFORE TO 6:00 AM MONDAY AFTER		
MEMORIAL DAY OR LABOR DAY	MONDAY	6:00 AM FRIDAY BEFORE TO 6:00 AM TUESDAY AFTER		
THANKSGIVING DAY	THURSDAY	6:00 AM WEDNESDAY BEFORE TO 6:00 AM MONDAY AFTER		



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NO.	DESCRIPTION	BY	DATE

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CITY OF DUNKIRK


PROJECT NAME

LAKE SHORE DRIVE

DRAWING TITLE

WORK ZONE TRAFFIC CONTROL **NOTES**

DATE
DECEMBER 2021
FEDERAL AID PROJECT NO.
DRAWING NO.
WZ - 02

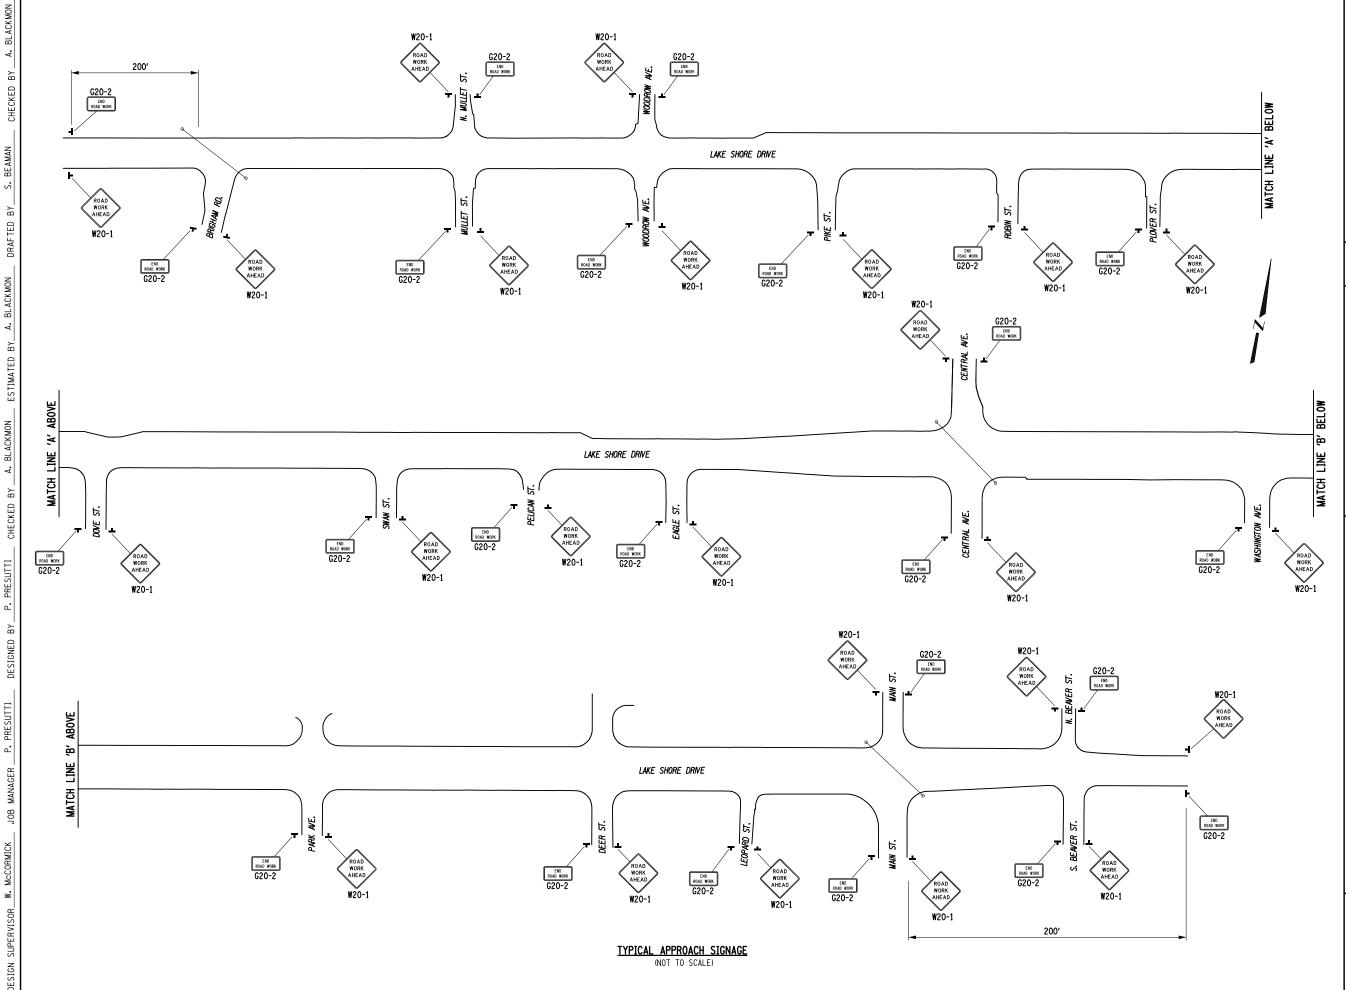

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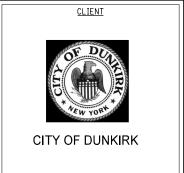


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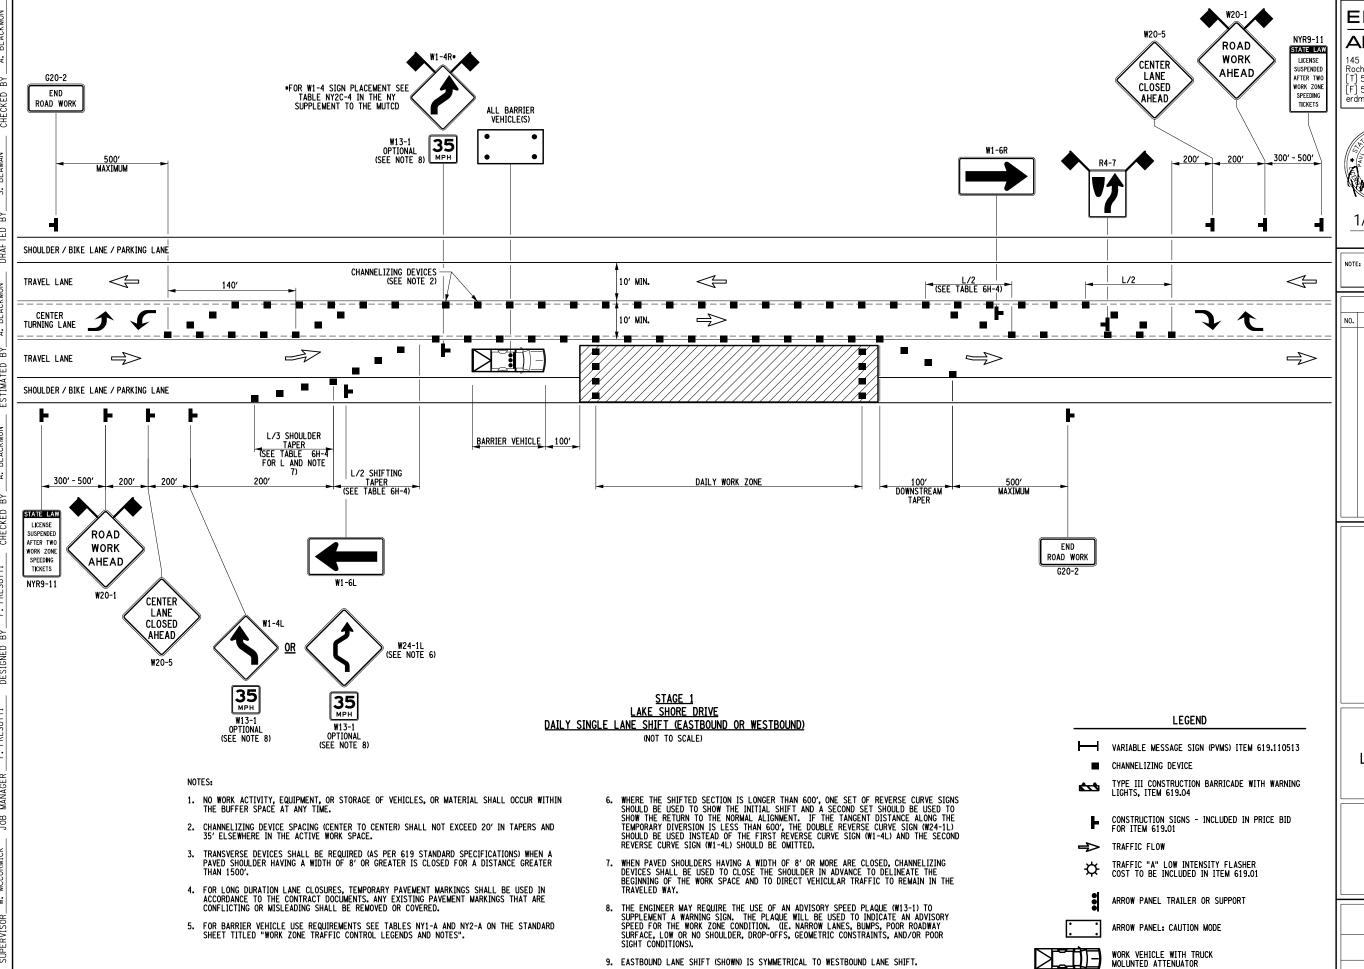
PROJECT NAME

LAKE SHORE DRIVE

DRAWING TITLE

WORK ZONE TRAFFIC CONTROL DETAILS

SCALE	DATE
N.T.S.	DECEMBER 2021
P.I.N. 5763.53	FEDERAL AID PROJECT NO.
SHEET NO.	DRAWING NO.
11 of 94	WZ-03



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PROJECT NAME

LAKE SHORE DRIVE

DRAWING TITLE

WORK ZONE TRAFFIC CONTROL DETAILS

SCALE
N.T.S.

DECEMBER 2021

P.I.N.


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SHEET NO.

DRAWING NO.

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WZ-04



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PROJECT NAME

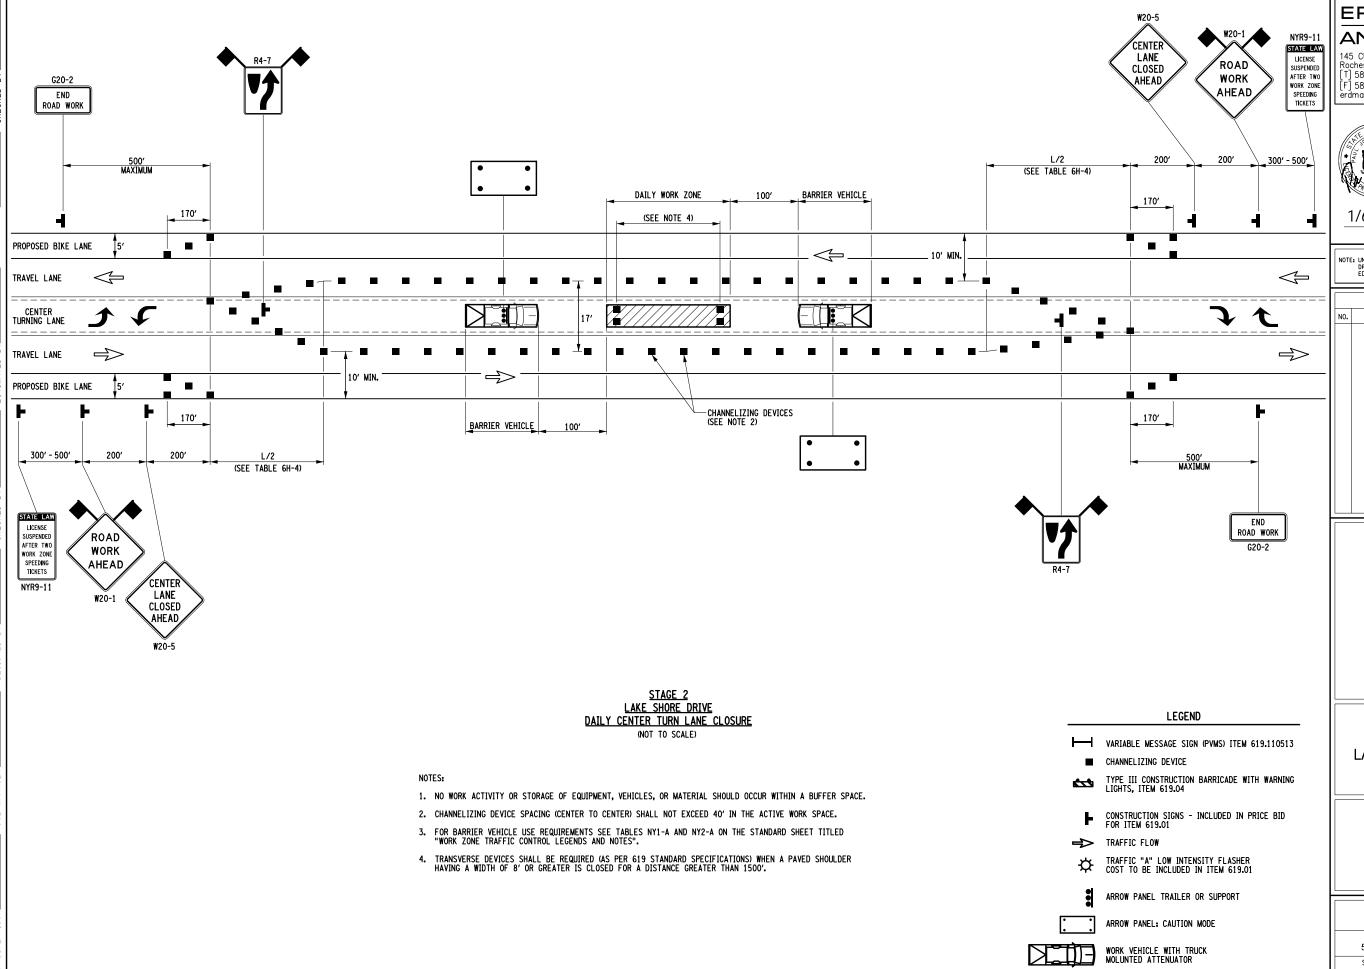LAKE SHORE DRIVE

DRAWING TITLE

WORK ZONE TRAFFIC CONTROL DETAILS

SCALE	DATE	
N.T.S.	DECEMBER 2021	
P.I.N.	FEDERAL AID PROJECT NO.	
5763.53		
SHEET NO.	DRAWING NO.	
13 of 94	WZ-05	

GRID NORTH CB 20 N 906589,160 E 942596,150 11•00 12+00 13-00 /4·00 N78°32′57"E /5·00 16+00 *17+00* N78°12′11"E 20<u>;</u>00 CB 10 N 906411.720 E 941720.150 ELEV 600.71 893.79 867.66 POB 10+00.00 AZ.=78°43'16.7" MATCH 11+00 12+00 ⊡ BM I CHISELED "X" NE BONNET BOLT OF HYD EL=604.52 ■ BM 2 CHISELED "X" NORTH BONNET BOLT OF HYD EL=604.08 MAINLINE HORIZONTAL ALIGNMENT COORDINATES STATION NORTH EAST LAKE SHORE DRIVE P.O.B. 10+00.00 906,549.87 942,547.85 GRID NORTH P.I. 18+20.08 906,710.26 943,352.09 **ABOVE** CB 30 N 906766.546 E 943445.486 ું ELEV 582,98' 27:00 23:00 N78°12'11"E 24:00 25<u>°</u>00 26<u>+</u>00 21•00 30:00 N78°56'11"E MATCH LINE 867.66 858.20 PI 18+20.08 2 AZ.=78°,43′16.7" 18+00 MATCH 14+00 15+00 17+00 19+00 13+00 21+00 22+00 16+00 20+00 23+00 □ BM 3 CHISELED "X" NW BONNET BOLT OF HYD EL=593.69 → BM 4 CHISELED "X" MW BONNET BOLT OF HYD EL=584,35

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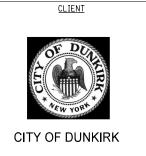


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PROJECT NAME

LAKE SHORE DRIVE

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SCALE	DATE	
N.T.S.	DECEMBER 2021	
p.i.n. 5763.53	FEDERAL AID PROJECT NO.	
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14 of 94	SA-01	

GRID NORTH SA-1 BELOW CB 40 N 906931,235 E 944287,734 ġ 36:00 ELEV 579.22 DWG. 33:00 34:00 N78°56′11"E 35:00 39:00 N78°36'41"E 40:00 41-00 42-00 858.20 1061.92 2 MATCH MATCH 24+00 25+00 26+00 29÷00 31+00 27+00 28+00 33+00 34+00 30+00 32+00 ⊡ BM 5 CHISELED "X" NW BONNET BOLT OF HYD EL=582.95 MAINLINE HORIZONTAL ALIGNMENT COORDINATES STATION EAST LAKE SHORE DRIVE P.I. 38+52.08 907,103.40 945,345.70 GRID NORTH P.I. 945,437.53 39+45.43 907,120.14 P.I. 43+43.96 907,197.91 945,828.40 **AB0VE** CB 50 N 907/40.925 E 945328,745 ELEV 583,87' 9 54:00 44:00 N78°36'41"E 45:00 47+00 48<u>+</u>00 940.60 N78°58′33"E 52•00 MATCH LINE 1061.92 PI 38+52.08 PI 39+45.43 MATCH PI 43+43.96 AZ.=78°50′39.8" AZ.=79°,40′08.5" AZ.=78°44'46.5" AZ.=78°58'39.8" 35+00 37+00 39÷00 36+00 43+00 38+00 41÷00 40+00 42+00 44+00 ⊡ BM 6 CHISELED "X" NW BONNET BOLT OF HYD EL=584.50 45+00 ⊡ BM 7 CHISELED "X" NW BONNET BOLT OF HYD EL=586.26 ⊡ BM 8 CHISELED "X" NORTH BONNET BOLT OF HYD EL=584.24

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SCALE	DATE
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15 of 94	SA-02

GRID NORTH SA-2 BE ġ CB 60 N 907320,789 E 946251,984 ELEV 583,59 CB 70 N 907495,580 E 947094,130 ELEV 588.89' DWG. 60°00 N 78°-16°-28° E 860.09′ 63<u>+</u>00 55,00 N 78°-58'-33" E 56,00 62:00 MATCH TO PI 56+00.48 AZ.=78º42'27.8 AZ.=78°58'39.8" 46+00 47+00 50+00 51+00 48+00 49+00 54+00 52+00 53+00 55+00 □ BM 9 CHISELED 'X' NORTH BONNET BOLT OF HYD EL-585.78 □ BM 10 CHISELED "X" NW BONNET BOLT OF HYD EL=584.80 DM II CHISELED *X* NE BONNET BOLT OF HYD EL=589.50 MAINLINE HORIZONTAL ALIGNMENT COORDINATES POINT STATION NORTH EAST LAKE SHORE DRIVE P.I. 56+00.48 907,438.15 947,061.74 P.O.E. 59+01.38 907,497.07 947,356.81 GRID NORTH **ABOVE** .. " MATCH LINE 68•00 69:00 70-00 N 79°-19'-30' E 71-00 72<u>+</u>00 73•00 74:00 CB 80 N 907679.990 E 948072.420 ELEV 593.43' 995.52 POE 59+01.38 AZ.=78°42′27.8" 57÷00 58+00 ∴ BM 12 CHISELED "X" NW BONNET BOLT OF HYD EL=591.65

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NYSPCS: WEST ZONE NAD 83 (2011) N: 907,320.79 E: 946,251.98




UNITS - FEET (TIES NOT TO SCALE) CB 10 @ B STA. 10+00.00 CB 10 IS A REBAR WITH CAP LOCATED ON THE NORTH SIDE OF LAKE SHORE DRIVE APPROX. 300' WEST OF NICHOLS AVE.

LAKE SHORE DRIVE


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NYSPCS: WEST ZONE NAD 83 (2011) N: 906,411.72 E: 941,720.15

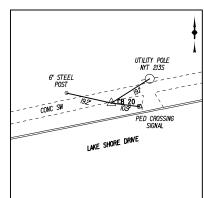


UNITS - FEET (TIES NOT TO SCALE) CB 20 @ B STA. 18+93.79 CB 20 IS A REBAR WITH CAP LOCATED ON THE NORTH SIDE OF LAKE SHORE DRIVE AT ITS INTERSECTION WITH BRIGHAM ROAD.

NYSPCS: WEST ZONE NAD 83 (2011) N: 906,589.16 E: 942,596.15

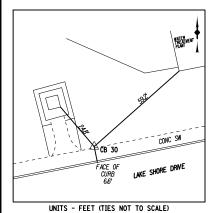

CB 30 @ B STA. 27+61.45 CB 30 IS A REBAR WITH CAP LOCATED ON THE NORTH SIDE OF LAKE SHORE DRIVE AT ITS INTERSECTION WITH PIKE STREET.


NYSPCS: WEST ZONE NAD 83 (2011) N: 906,766.55 E: 943,445.49

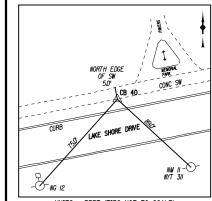

UNITS - FEET (TIES NOT TO SCALE) CB 40 @ B STA. 36+19.65

CB 40 IS A REBAR WITH CAP LOCATED ON THE NORTH SIDE OF LAKE SHORE DRIVE APPROX. 160' EAST OF DOVE STREET.


NYSPCS: WEST ZONE NAD 83 (2011) N: 906,931.24

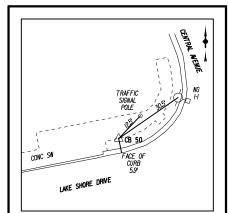


UNITS - FEET (TIES NOT TO SCALE) CB 50 @ B STA. 46+81.57

CB 50 IS A REBAR WITH CAP LOCATED AT THE NORTHWEST CORNER OF THE INTERSECTION OF LAKE SHORE DRIVE AND CENTRAL AVE.

NYSPCS: WEST ZONE NAD 83 (2011)
N: 907,140,92
E: 945,328.74

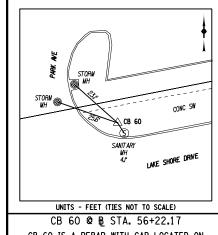


CB 60 IS A REBAR WITH CAP LOCATED ON THE NORTH SIDE OF LAKE SHORE DRIVE APPROX. 40' EAST OF PARK AVE.

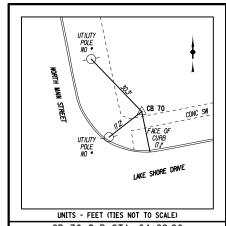

CB 70 @ B STA. 64+82.26 CB 70 IS A REBAR WITH CAP LOCATED AT THE NORTHEAST CORNER OF THE INTERSECTION OF LAKE SHORE DRIVE AND NORTH MAIN STREET.

> NYSPCS: WEST ZONE NAD 83 (2011) N: 907,495.58 E: 947,094.13

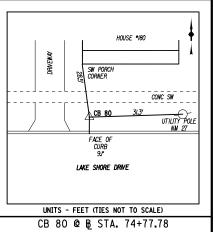

CB 80 IS A REBAR WITH CAP LOCATED ON THE NORTH SIDE OF LAKE SHORE DRIVE APPROX. 30' WEST OF ANTELOPE STREET.

NYSPCS: WEST ZONE NAD 83 (2011) N: 907,679.99 E: 948,072.42

	BENCHMARKS				
NO.	STATION	OFFSET	ELEV.	DESCRIPTION	
1	₽ 12+46.8	55.1′ RT.	604.52′	BM IS A CHISELED "X" NE BONNET BOLT OF HYDRANT LOCATED 100' WEST FROM © NICHOLS AVENUE.	
2	№ 18+37.2	54.5′ RT.	604.08′	BM IS A CHISELED "X" NORTH BONNET BOLT OF HYDRANT LOCATED 45' WEST FROM © BRIGHAM ROAD.	
3	B 22+57.6	66.1′ RT.	593 . 69′	BM IS A CHISELED "X" NW BONNET BOLT OF HYDRANT LOCATED 25′ EAST FROM € MULLET STREET.	
4	₽ 28+01 . 1	71.0′ RT.	584.35′	BM IS A CHISELED "X" NW BONNET BOLT OF HYDRANT LOCATED 35' EAST FROM © PIKE STREET.	
5	₽ 34+42.5	72 . 5′ RT.	582.95′	BM IS A CHISELED "X" NW BONNET BOLT OF HYDRANT LOCATED 35' EAST FROM © DOVE STREET.	
6	₽ 43+44.7	66.2′ RT.	584.50′	BM IS A CHISELED "X" NW BONNET BOLT OF HYDRANT LOCATED 40′ EAST FROM € EAGLE STREET.	
7	₽ 48+11 . 1	72.2′ RT.	586.26′	BM IS A CHISELED "X" N₩ BONNET BOLT OF HYDRANT LOCATED 75′ EAST FROM © CENTRAL AVENUE.	
8	₽ 51+10.7	78.8′ RT.	584.24′	BM IS A CHISELED "X" NORTH BONNET BOLT OF HYDRANT LOCATED 50′ WEST FROM € WASHINGTON AVENUE.	
9	₽ 55+50.8	75 . 5′ RT.	585.78′	BM IS A CHISELED "X" NORTH BONNET BOLT OF HYDRANT LOCATED 40' WEST FROM © PARK AVENUE.	
10	B 59+69.8	81.5′ RT.	584.80′	BM IS A CHISELED "X" NW BONNET BOLT OF HYDRANT LOCATED 45′ WEST FROM © DEER STREET.	
11	₽ 63+84.6	88.9′ RT.	589.50′	BM IS A CHISELED "X" NE BONNET BOLT OF HYDRANT LOCATED 55' WEST FROM © MAIN STREET.	
12	B 67+38.4	78.1′ RT.	591.65′	BM IS A CHISELED "X" NW BONNET BOLT OF HYDRANT LOCATED 30' EAST FROM © S BEAVER STREET.	

SURVEY NOTES:

- 1. NORTH ORIENTATION AND COORDINATES SHOWN REFERENCE NEW YORK STATE PLANE, NAD83(2011) WEST ZONE BASED ON GPS TIES TO THE CORS NETWORK. EXPRESSED IN US SURVEY FEET.
- 2. ALL ELEVATIONS REFERENCE NAVD88.
- 3. COMBINED SCALE FACTOR 0.99996186



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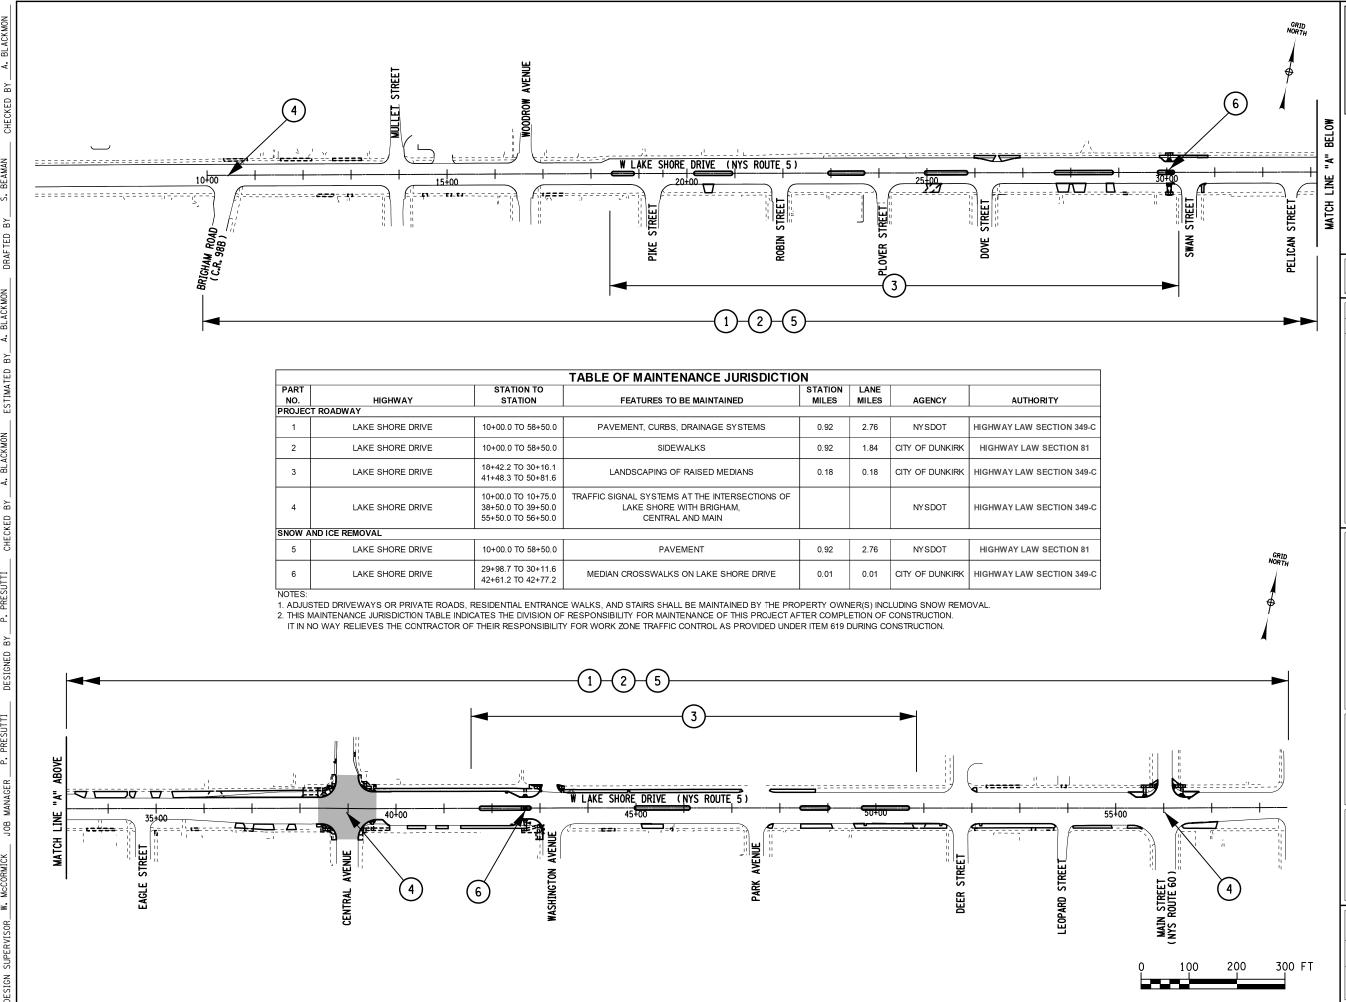
CITY OF DUNKIRK

PROJECT NAME

LAKE SHORE DRIVE

DRAWING TITLE

SCALE	DATE
N.T.S.	DECEMBER 2021
P.I.N. 5763.53	FEDERAL AID PROJECT NO.
SHEET NO.	DRAWING NO.
17 of 94	SA-04



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CITY OF DUNKIRK

PROJECT NAME

LAKE SHORE DRIVE

DRAWING TITLE

MAINTENANCE JURISDICTION PLAN & TABLE

SCALE	DATE
1" = 200'	DECEMBER 2021
P.I.N. 5763.53	FEDERAL AID PROJECT NO.
SHEET NO.	DRAWING NO.
18 of 94	MJ-01

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DRAINAGE NUMBER NUMBER STATION DESCRIPTION OFFSET TYPE FRAME FR						DRA	INAGE STI	RUCTURE TABLE
DS5-1		STATION	OFFSET					DESCRIPTION
DS6-1 30+05 21 RT EX - 579.36 E 575.66 REMOVE EXISTING INLET AND 11 +/- LF OF EXISTING 8" CPP TO THE EAST DS6-2 30+13 21.6 RT A 3 579.46 E 575.62 INSTALL TYPE A INLET AND OUTLET TO DS 6-3 WITH 3 LF OF 12" SICPP AT 0.50%. DS6-3 30+19.3 20.5 RT EX MH 579.52 W - EXISTING MANHOLE TO REMAIN. DS 7-1 38+73.3 46.9 RT EX - 585.03 S 581.93 ADJUST EXISTING CATCH BASIN TO GRADE. DS 8-1 42+41.6 34.2 RT A 3 581.70 SE 577.71 INSTALL TYPE A DRAINAGE STRUCTURE AND OUTLET TO DS 8-6 WITH 52 LF OF 15" SICPP AT 0.50% DS 8-2 42+30.8 33.0 LT S 11 581.45 N 577.15 INSTALL TYPE S DRAINAGE STRUCTURE AND OUTLET TO DS 8-3 WITH 3 LF OF 12"		28+83.6	20.3 RT		NO.			ADJUST EXISTING CATCH BASIN TO GRADE.
DS6-2 30+13 21.6 RT A 3 579.46 E 575.62 INSTALL TYPE A INLET AND OUTLET TO DS 6-3 WITH 3 LF OF 12" SICPP AT 0.50%. DS6-3 30+19.3 20.5 RT EX MH 579.52 W - EXISTING MANHOLE TO REMAIN. DS 7-1 38+73.3 46.9 RT EX - 585.03 S 581.93 ADJUST EXISTING CATCH BASIN TO GRADE. DS 8-1 42+41.6 34.2 RT A 3 581.70 SE 577.71 INSTALL TYPE A DRAINAGE STRUCTURE AND OUTLET TO DS 8-6 WITH 52 LF OF 15" SICPP AT 0.50% DS 8-2 42+30.8 33.0 LT S 11 581.45 N 577.15 INSTALL TYPE S DRAINAGE STRUCTURE AND OUTLET TO DS 8-3 WITH 3 LF OF 12"							W 575.16	
DS6-2 30+13 21.6 RT A 3 579.46 E 575.62 INSTALL TYPE A INLET AND OUTLET TO DS 6-3 WITH 3 LF OF 12" SICPP AT 0.50%. DS6-3 30+19.3 20.5 RT EX MH 579.52 W - EXISTING MANHOLE TO REMAIN. DS 7-1 38+73.3 46.9 RT EX - 585.03 S 581.93 ADJUST EXISTING CATCH BASIN TO GRADE. DS 8-1 42+41.6 34.2 RT A 3 581.70 SE 577.71 INSTALL TYPE A DRAINAGE STRUCTURE AND OUTLET TO DS 8-6 WITH 52 LF OF 15" SICPP AT 0.50% DS 8-2 42+30.8 33.0 LT S 11 581.45 N 577.15 INSTALL TYPE S DRAINAGE STRUCTURE AND OUTLET TO DS 8-3 WITH 3 LF OF 12"								
DS 6-3 30+19.3 20.5 RT EX MH 579.52 W - EXISTING MANHOLE TO REMAIN. DS 7-1 38+73.3 46.9 RT EX - 585.03 S 581.93 ADJUST EXISTING CATCH BASIN TO GRADE. DS 8-1 42+41.6 34.2 RT A 3 581.70 SE 577.71 INSTALL TYPE A DRAINAGE STRUCTURE AND OUTLET TO DS 8-6 WITH 52 LF OF 15" SICPP AT 0.50% DS 8-2 42+30.8 33.0 LT S 11 581.45 N 577.15 INSTALL TYPE S DRAINAGE STRUCTURE AND OUTLET TO DS 8-3 WITH 3 LF OF 12"	DS6-1	30+05	21 RT	EX	-	579.36	E 575.66	REMOVE EXISTING INLET AND 11 +/- LF OF EXISTING 8" CPP TO THE EAST
DS 6-3 30+19.3 20.5 RT EX MH 579.52 W - EXISTING MANHOLE TO REMAIN. DS 7-1 38+73.3 46.9 RT EX - 585.03 S 581.93 ADJUST EXISTING CATCH BASIN TO GRADE. DS 8-1 42+41.6 34.2 RT A 3 581.70 SE 577.71 INSTALL TYPE A DRAINAGE STRUCTURE AND OUTLET TO DS 8-6 WITH 52 LF OF 15" SICPP AT 0.50% DS 8-2 42+30.8 33.0 LT S 11 581.45 N 577.15 INSTALL TYPE S DRAINAGE STRUCTURE AND OUTLET TO DS 8-3 WITH 3 LF OF 12"								
DS 6-3 30+19.3 20.5 RT EX MH 579.52 W - EXISTING MANHOLE TO REMAIN. DS 7-1 38+73.3 46.9 RT EX - 585.03 S 581.93 ADJUST EXISTING CATCH BASIN TO GRADE. DS 8-1 42+41.6 34.2 RT A 3 581.70 SE 577.71 INSTALL TYPE A DRAINAGE STRUCTURE AND OUTLET TO DS 8-6 WITH 52 LF OF 15" SICPP AT 0.50% DS 8-2 42+30.8 33.0 LT S 11 581.45 N 577.15 INSTALL TYPE S DRAINAGE STRUCTURE AND OUTLET TO DS 8-3 WITH 3 LF OF 12"	DS6-2	30±13	21.6 PT	Δ	3	579.46	E 575.62	INSTALL TYPE A INLET AND OUTLET TO DS 6.3 WITH 3 LE OF 12" SICPD AT 0.50%
DS 7-1 38+73.3 46.9 RT EX - 585.03 S 581.93 ADJUST EXISTING CATCH BASIN TO GRADE. DS 8-1 42+41.6 34.2 RT A 3 581.70 SE 577.71 INSTALL TYPE A DRAINAGE STRUCTURE AND OUTLET TO DS 8-6 WITH 52 LF OF 15" SICPP AT 0.50% DS 8-2 42+30.8 33.0 LT S 11 581.45 N 577.15 INSTALL TYPE S DRAINAGE STRUCTURE AND OUTLET TO DS 8-3 WITH 3 LF OF 12"	D00-2	30113	21.0 1(1			373.40	L 373.02	INCIALE THE EXTREE FAIND COLLET TO BO 0-3 WITH 3 EL CH 12 CIGHT AT 0.30%.
DS 7-1 38+73.3 46.9 RT EX - 585.03 S 581.93 ADJUST EXISTING CATCH BASIN TO GRADE. DS 8-1 42+41.6 34.2 RT A 3 581.70 SE 577.71 INSTALL TYPE A DRAINAGE STRUCTURE AND OUTLET TO DS 8-6 WITH 52 LF OF 15" SICPP AT 0.50% DS 8-2 42+30.8 33.0 LT S 11 581.45 N 577.15 INSTALL TYPE S DRAINAGE STRUCTURE AND OUTLET TO DS 8-3 WITH 3 LF OF 12"								
DS 8-1	DS6-3	30+19.3	20.5 RT	EX	МН	579.52	W -	EXISTING MANHOLE TO REMAIN.
DS 8-1								
DS 8-1								
DS 8-2 42+30.8 33.0 LT S 11 581.45 N 577.15 INSTALL TYPE S DRAINAGE STRUCTURE AND OUTLET TO DS 8-3 WITH 3 LF OF 12"	DS 7-1	38+73.3	46.9 RT	EX	-	585.03	S 581.93	ADJUST EXISTING CATCH BASIN TO GRADE.
DS 8-2 42+30.8 33.0 LT S 11 581.45 N 577.15 INSTALL TYPE S DRAINAGE STRUCTURE AND OUTLET TO DS 8-3 WITH 3 LF OF 12"								
DS 8-2 42+30.8 33.0 LT S 11 581.45 N 577.15 INSTALL TYPE S DRAINAGE STRUCTURE AND OUTLET TO DS 8-3 WITH 3 LF OF 12"	DS 8-1	42+41.6	34.2 RT	A	3	581.70	SE 577.71	INSTALL TYPE A DRAINAGE STRUCTURE AND OUTLET TO DS 8-6 WITH 52 LF OF 15" SICPP
	DS 8-2	42+30.8	33.0 LT	S	11	581.45	N 577.15	
SIGPP AT 0.50%.								SICPP AT 0.50%.
DS 8-3 42+30.8 37.9 LT 48 MH 581.82 E 577.13 INSTALL 48 MH AND REMOVE +/-5LF OF EXISTING 12' CMP TO THE EAST AND WEST.	DS 8-3	42+30.8	37.9 LT	48	МН	581.82		
W 577.13 CONNECT TO EXISTING 12" CMP WITH +/-5LF OF PROPOSED 12" SICPP TO EAST AND S 577.13 WEST WITH CONCRETE COLLARS.								
DS 8-4	DO 0.4	40.05.5	27.0 LT	00	2411	504.04	F 570 77	DEMONE EVICTING IN STAND MANUALE INICIAL COUNTY AND DEMONE A F IS OF ACILONAL
SE 574.17 TO WEST. CONNECT TO EXISTING 12" CMP WITH +/-SLF OF PROPOSED 12" SICPP	DS 6-4	42+00.0	37.2 LI	60	IVIT	361.61		
W 576.77 AND CONCRETE COLLAR. CONNECT TO EXISTING 18" CPP WITH +/-5LF OF PROPOSED 18" S 577.07 SICPP TO SOUTH WITH CONCRETE COLLAR. OUTLET AND CONNECT TO EXISTING 18" CPP								
WITH +/-5LF OF PROPOSED 18" SICPP TO SOUTHEAST WITH CONCRETE COLLAR.							3 377.07	
DS 8-5 42+86.7 33.2 LT EX 11 581.16 N 577.16 REMOVE EXISTING INLET AND EXISTING PIPE TO THE NORTH AND +/- 5LF OF 18"CPP	DS 8.5	12±86.7	33.2 IT	EY	11	581 16	N 577 16	DEMOVE EXISTING INLET AND EXISTING DIDE TO THE MODTH AND 1/ 5LE OF 18"CDD
S 577.16 TO THE SOUTH.	D3 6-3	42+00.7	33.2 LI		''	361.10		
DS 8-6 42+95.9 47.1 RT 72 MH 581.41 E 577.45 REMOVE EXISTING MANHOLE AND INLET. INSTALL 72" MH AND REMOVE +/-5 LF OF	DS 8-6	42+95 9	47.1 RT	72	MH	581 41	F 577 45	REMOVE EXISTING MANHOLE AND INLET. INSTALL 72" MH AND REMOVE +/-5 LE OF
W 577.45 18" CMP TO THE NORTH. CONNECT TO EXISTING 18" CMP WITH PROPOSED 18" SICPP	2000	42.30.5	47.1 101	,,,		001.41	W 577.45	18" CMP TO THE NORTH. CONNECT TO EXISTING 18" CMP WITH PROPOSED 18" SICPP
N 577.45 SICPP TO NORTH WITH CONCRETE COLLAR.							N 577.45	SICPP TO NORTH WITH CONCRETE COLLAR.
				_				
DS 8-7 43+02.4 36.3 LT S 11 581.26 W 576.84 INSTALL TYPE S DRAINAGE STRUCTURE AND OUTLET TO DS8-4 WITH 14 LF OF 12" SICPP AT 0.50%.	DS 8-7	43+02.4	36.3 LT	S	11	581.26	W 576.84	
DS 8-8 43+07.3 44.1 RT A 3 581.01 W 577.49 INSTALL TYPE A DRAINAGE STRUCTURE AND OUTLET TO DS8-6 WITH 8 LF OF 12" SICPP AT 0.50%.	DS 8-8	43+07.3	44.1 RT	Α	3	581.01	W 577.49	
	20111	50.50.5		=>/				
DS11-1 56+52.5 31.3 LT EX - 587.50 S 584.81 REMOVE EXISTING INLET AND +/- 14 LF OF 12" RCP TO THE SOUTH.	DS11-1	56+52.5	31.3 LT	EX	-	587.50	S 584.81	REMOVE EXISTING INLET AND +/- 14 LF OF 12" RCP TO THE SOUTH.
7040 7050 7040 7050 7040 7050 7050 7050	D0110	50.50.0	01.0 1.7		4.	507.00	0 50175	INOTALL DADE O DRAINAGE OTDUOTUDE AND CONTROL TO EVOLUTION AND CONTROL TO
DS11-2 56+52.6 21.0 LT S 11 587.86 S 584.79 INSTALL TYPE S DRAINAGE STRUCTURE AND CONNECT TO EXISTING 12" RCP WITH +/- 5LF OF PROPOSED 12" SICPP TO SOUTH WITH CONCRETE COLLAR.	DS11-2	56+52.6	21.0 LT	S	11	587.86	S 584.79	
	NOTE	EVERNOSS	OF ALL DEATH	IA OF CTDUCTUS	EC CLIA!!	DE COAT	D /4/ITI T)4/2 2	
NOTE: EXTERIORS OF ALL DRAINAGE STRUCTURES SHALL BE COATED WITH TWO COATS OF HIGH BUILD COAL TAR PAINT. INTERIOR OF ALL DRAINAGE STRUCTURES SHALL BE COATED WITH TWO COATS OF EPOXY RESIN DAMP PROOFING. COST TO BE INCLUDED IN THE PRICE BID FOR THE STRUCTURES.	INUTE:							



145 CULVER ROAD, SUITE 200 Rochester, NY 14620 [T] 585.427.8888 [F] 585.427.8914 erdmananthony.com



1/6/2022

DATE

NOTE: UNAUTHORIZED ALTERATION OR ADDITION TO THIS DRAWING IS A VIOLATION OF THE NEW YORK STATE EDUCATION LAW ARTICLE 145, SECTION 7209.

DATE

	REVISIONS		
NO.	DESCRIPTION	BY	DATE

CLIENT



CITY OF DUNKIRK

PROJECT NAME

LAKE SHORE DRIVE

DRAWING TITLE

MISCELLANEOUS **TABLES**

ſ	SCALE	DATE				
l	NONE	DECEMBER 2021				
	P.I.N. 5763.53	FEDERAL AID PROJECT NO.				
ı	SHEET NO.	DRAWING NO.				
l	19 of 94	MT-01				

FILE NAME = DATE/TIME = USER =

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W. MCCORMICK
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ERDMAN ANTHONY 145 CULVER ROAD, SUITE 200 Rochester, NY 14620 [T] 585.427.8888 [F] 585.427.8914 erdmananthony.com



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CITY OF DUNKIRK

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DRAWING TITLE

MISCELLANEOUS **TABLES**

SCALE	DATE
NONE	DECEMBER 2021
p.i.n. 5763.53	FEDERAL AID PROJECT NO.
SHEET NO.	DRAWING NO.
20 of 94	MT-02

									CURB	TABLE								
START		OFFSET	END		OFFSET		ITEM		COMMENTS	START		OFFSET	END		OFFSET		ITEM	COMMENTS
STATION	SIDE	(FT)	STATION	SIDE	(FT)	609.0212	609.0401		- COMMILITY O	STATION	SIDE	(FT)	STATION	SIDE	(FT)	609.0212	609.0401	Comment
18+46.7	LT	4.5	18+46.7	RT	MEDIAN 4.5	14.1		R=4.5'		35+70.9	LT	22.5	38+40.4	LT	RAVELW A	Y CONT.	269.5	
18+46.7	LT	4.5	18+86.0	LT	4.5	39.3		K-4.5		38+40.4	LT	22.5	38+74.6	LT	57.0		54.1	R=35'
18+46.7	RT	4.5	18+86.0	RT	4.5	39.3				38+74.6	LT	57.0	38+74.7	LT	65.1		8.1	11 00
18+86.0	LT	4.5	18+86.0	RT	4.5	14.1		R=4.5'		38+74.7	LT	65.1	38+73.0	LT	69.6		4.8	
20+18.6	LT	4.5	20+18.6	RT	4.5	14.1		R=4.5'		38+34.6	RT	32.8	38+45.7	RT	32.8		11.1	
20+18.6	LT	4.5	20+91.0	LT	4.5	72.4				38+45.7	RT	32.8	38+76.7	RT	62.6		47.3	R=30'
20+18.6 20+91.0	RT LT	4.5 4.5	20+91.0 20+91.0	RT RT	4.5 4.5	72.4 14.1		R=4.5'		38+76.7 39+20.6	RT LT	62.6 69.6	38+76.7 39+20.7	RT LT	65.7 65.0		3.1 4.6	
22+98.0	LT	4.5	22+98.0	RT	4.5	14.1		R=4.5'		39+20.7	LT	65.0	39+51.6	LT	35.3		47.0	R=30'
22+98.0	LT	4.5	23+66.3	LT	4.5	68.3		11 1.0		39+51.6	LT	35.3	39+58.4	LT	35.3		6.8	11.00
22+98.0	RT	4.5	23+66.3	RT	4.5	68.4				39+58.4	LT	35.3	39+89.5	LT	35.2		31.1	
23+66.3	LT	4.5	23+66.3	RT	4.5	14.1		R=4.5'		39+21.8	RT	65.3	39+21.8	RT	62.8		2.5	
24+99.3	LT	4.5	24+99.3	RT	4.5	14.1		R=4.5'		39+21.8	RT	62.8	39+60.8	RT	22.5		62.7	R=40'
24+99.3	LT	4.5	25+80.9	LT	4.5	81.6				39+60.8	RT	22.5	39+70.0	RT	22.5 24.0	-	9.2 3.9	D-51
24+99.3 25+80.9	RT LT	4.5 4.5	25+80.9 25+80.9	RT RT	4.5 4.5	81.6 14.1		R=4.5'		39+70.0 39+73.5	RT RT	22.5 24.0	39+73.5 39+82.9	RT RT	33.3		13.2	R=5'
27+69.9	LT	4.5	27+69.9	RT	4.5	14.1		R=4.5'		39+82.9	RT	33.3	39+86.4	RT	34.8		3.9	R=5'
27+69.9	LT	4.5	28+84.2	LT	4.5	114.3				42+27.5	LT	34.5	42+32.7	LT	34.5		5.2	
27+69.9	RT	4.5	28+84.2	RT	4.5	114.3				42+32.7	LT	34.5	42+34.8	LT	34.0		2.2	R=5'
28+84.2	LT	4.5	28+84.2	RT	4.5	14.1		R=4.5'		42+34.8	LT	34.0	42+57.8	LT	23.0		25.5	
29+84.8	LT	4.5	29+84.8	RT	4.5	14.1		R=4.5'		42+57.8	LT	23.0	42+60.0	LT	22.5		2.2	R=5'
29+84.8	LT	4.5 4.5	30+11.6	LT	4.5	26.8				42+60.0	LT LT	22.5 22.5	42+78.2 43+01.8	LT LT	22.5 39.2		18.2 30.9	D-051
29+84.8 30+11.6	RT LT	4.5	30+11.6 30+11.6	RT RT	4.5 4.5	26.8 14.1		R=4.5'		42+78.2 43+01.8	LT	39.2	43+01.8	LT	47.9		9.2	R=25'
41+77.8	LT	4.5	41+77.8	RT	4.5	14.1		R=4.5'		42+39.9	RT	35.7	42+43.3	RT	35.7		3.4	
41+77.8	LT	4.5	42+77.2	LT	4.5	99.4				42+43.3	RT	35.7	42+46.9	RT	34.2		3.9	R=5'
41+77.8	RT	4.5	42+77.2	RT	4.5	99.4				42+46.9	RT	34.2	42+57.3	RT	23.9		14.6	
42+77.2	LT	4.5	42+77.2	RT	4.5	14.1		R=4.5'		42+57.3	RT	23.9	42+60.8	RT	22.5		3.9	R=5'
45+01.0	LT	4.5	45+01.0	RT	4.5	14.1		R=4.5'		42+60.8	RT	22.5	42+81.0	RT	22.5		20.2	
45+01.0 45+01.0	LT RT	4.5 4.5	46+08.8 46+08.8	LT RT	4.5 4.5	107.8 107.8				42+81.0 43+06.0	RT RT	22.5 47.6	43+06.0 43+05.9	RT RT	47.6 65.4		39.3 17.8	R=25'
46+08.8	LT	4.5	46+08.8	RT	4.5	14.1		R=4.5'		43+06.0	LT	47.6	43+05.9	LT	37.9		10.8	R=23'
48+46.2	LT	4.5	48+46.2	RT	4.5	14.1		R=4.5'		43+58.0	LT	31.5	43+73.0	LT	31.3		15.0	11-23
48+46.2	LT	4.5	48+99.7	LT	4.5	53.5				45+11.1	RT	32.8	45+32.2	RT	32.7		21.1	
48+46.2	RT	4.5	48+99.7	RT	4.5	53.5				47+75.9	RT	36.6	47+86.0	RT	32.6		11.1	R=21.5'
48+99.7	LT	4.5	48+99.7	RT	4.5	14.1		R=4.5'		49+53.5	RT	32.3	49+75.4	RT	32.2		21.9	
49+74.1	LT	4.5	49+74.1	RT	4.5	14.1		R=4.5'		49+92.7	RT	32.2	50+20.4	RT	32.2		27.7	
49+74.1	LT RT	4.5 4.5	50+65.7	LT RT	4.5 4.5	91.6 91.6				50+59.3	RT	32.2 39.0	51+31.2 52+08.3	RT RT	32.2 33.1		71.9 11.5	R=19.3'
49+74.1 50+65.7	LT	4.5	50+65.7 50+65.7	RT	4.5	14.1		R=4.5'		51+98.6 52+00.0	RT LT	38.9	52+08.3	LT	33.1		12.0	R=19.3 R=27.3'
30103.7		7.5	30103.7	IXI	4.5	14.1		11-4.5		55+26.2	LT	32.5	55+29.0	LT	31.6		3.1	R=5'
			I.	OUTSIE	DE TRAVEI	WAY				55+29.0	LT	31.6	55+40.7	LT	23.4		14.3	
										55+40.7	LT	23.4	55+43.5	LT	22.5		3.1	R=5'
20+33.4	RT	22.3	20+56.1	RT	22.4		22.7			55+43.5	LT	22.5	55+57.6	LT	22.5		14.1	
24+98.7	RT	22.0	25+31.2	RT	22.1	1	32.5	D 401		55+57.6	LT	22.5	55+87.6	LT	52.6	1	47.2	R=30'
25+98.6	LT LT	30.8 29.6	26+07.7 26+94.0	LT LT	29.7	-	9.4 9.3	R=40' R=40'		55+87.6 56+17.0	LT LT	52.6 61.2	55+87.6 56+18.2	LT LT	58.5 47.0	1	5.9 14.2	
26+84.7 27+69.3	RT	29.6	26+94.0	RT	22.2	+	62.4	K=40		56+17.9 56+18.2	LT LT	47.0	56+18.2	LT	22.5		38.8	R=25'
28+74.0	RT	22.2	28+88.7	RT	22.2		14.7			56+43.2	LT	22.5	56+56.2	LT	22.5		13.0	11-25
29+84.9	LT	30.7	29+88.4	LT	29.3		3.9	R=5'		56+56.2	LT	22.5	56+59.1	LT	23.4	1	3.1	R=5'
29+88.4	LT	29.3	29+93.7	LT	24.0		7.5			56+59.1	LT	23.4	56+70.4	LT	31.4		13.8	
29+93.7	LT	24.0	29+97.2	LT	22.5		3.9	R=5'		56+70.4	LT	31.4	56+73.3	LT	32.3		3.1	R=5'
29+97.2	LT	22.5	30+13.1	LT	22.5	-	15.9	D 5:		56+59.7	RT	31.1	56+80.3	RT	30.1	1	20.6	
30+13.1 30+16.6	LT LT	22.5 24.0	30+16.6 30+21.8	LT LT	24.0 29.1	-	3.9 7.3	R=5'		56+94.8	RT	29.4	57+12.2	RT	28.6	1	17.4	
30+16.6	LT	29.1	30+21.8	LT	30.6	+	3.9	R=5'				1			TOTAL	1793	1444	
29+99.7	RT	22.5	30+25.3	RT	22.6	+	7.1	1		PAYMENT S	HALL BF	MADE UNI	DER:		IVIAL	1 1700		1
30+06.8	RT	22.6	30+16.3	RT	23.8		9.6	R=38'					IEAR VERTIC	AL FACE	(NVF)			
30+64.2	LT	30.5	30+85.5	LT	30.6		21.3						CONCRETE			LF)		
30+68.9	RT	28.0	30+81.6	RT	22.9		13.9	R=14'										

FLEXIBLE DELINIATOR TABLE STATION SIDE OFFSET COLOR

3.38 YELLOW

3.37 YELLOW

3.37 YELLOW

3.37 YELLOW

3.37 YELLOW

3.37 YELLOW

3.38 YELLOW

3.37 YELLOW

3.38 YELLOW

3.37 YELLOW

WHITE

WHITE

YELLOW

YELLOW

WHITE

WHITE

WHITE

WHITE

YELLOW

YELLOW

WHITE

YELLOW

WHITE

WHITE

WHITE

WHITE

3.38

3.38

3.37

3.37

3.37

3.38

3.37

3.38

3.38

3.37

3.38

3.38

31.39

23.94

3.87

3.38

23.94

31.25

23.69

35.46

3.37

3.38

23.92

3.37

3.37

3.38

3.38

3.38

3.38

3.38

3.38

3.37

3 37

33.31

23.82

24.87

23.62

23.92 WHITE

35.48 WHITE

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23.74 WHITE

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22+97.97

23+66.34

23+66.34

24+99.34

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25+80.90

25+80.90

27+69.61

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28+84.17

28+84.17

29+84.82

29+84.82

29+87.22

29+95.7

30+11.64

30+11.64

30+14.56

30+22.95

39+58.47

39+71.45

39+84.07

41+77.77

41+77.7

42+34.03

42+46.86

42+59.08

42+59.31

42+77.22

42+77.23

42+78.18

42+80.97

45+01.01

45+01.03

46+08.80

46+08.81

48+46.16

48+46.16

48+99.70

48+99.72

49+74.12

49+74.13

50+65.7

50+65.74

55+28.01

55+42.37

55+66.03

56+45.2

56+57.40

56+71.44

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DAIE/IIME	USER	

RVISOR W. MCCORMICK	J0B 1	JOB MANAGER_	P. PRESUTTI	DESIGNED BY_	P. PRES

VALVE ADJUSTMENT TABLE								
STATION	OFFSET (FT.)	SIDE	ITEM 663.33 (EA)	DISPOSITION				
38+87.0	27.3	RT	1	ADJUST EXISTING VALVE TO GRADE				
39+31.0	32.2	LT	1	ADJUST EXISTING VALVE TO GRADE				
40+57.4	36.8	RT	1	ADJUST EXISTING VALVE TO GRADE				
41+93.9	38.1	RT	2	ADJUST EXISTING VALVE TO GRADE				
43+00.2	50.8	RT	1	ADJUST EXISTING VALVE TO GRADE				
45+49.1	37.3	RT	1	ADJUST EXISTING VALVE TO GRADE				
55+42.9	39.3	RT	1	ADJUST EXISTING VALVE TO GRADE				
56+70.8	36.3	RT	1	ADJUST EXISTING VALVE TO GRADE				
57+03.3	31.9	RT	1	ADJUST EXISTING VALVE TO GRADE				
		TOTAL	10					

	UNDERDRAIN TABLE							
FRO	M UPSTR	EAM	TO DO	OWNSTR	EAM	ITEM	ITEM	ITEM
STATION	SIDE	FEATURE	STATION	SIDE	FEATURE	206.0201	605.0901	605.1501
o in iioit	O.D.E	LETTORE	CIATION	O.D.E	LETTORE	(CY)	(CY)	(LF)
38+74	LT	EXISTING	35+71	LT	EXISTING	22.4	21.2	303
					TOTAL	22	21	303

PAYMENT SHALL BE MADE UNDER:

ITEM 206.0201 - TRENCH AND CULVERT EXCAVATION (CY)

ITEM 605.0901 - UNDERDRAIN FILTER, TYPE I (CY)

ITEM 605.1501 - PERFORATED CORRUGATED POLYETHYLENE UNDERDRAIN TUBING, 4 INCH DIAMETER (LF)

FIELD INLET ADJUSTMENT TABLE					
STATION	OFFSET (FT.)	SIDE	ITEM 604.070503 (EA)	DISPOSITION	
41+92.9	38.4	LT	1	ADJUST EXISTING FIELD INLET TO GRADE	
43+00.3	49.7	LT	1	ADJUST EXISTING FIELD INLET TO GRADE	
49+04.5	36.9	RT	1	ADJUST EXISTING FIELD INLET TO GRADE	
TOTAL 3					
PAY ITEM DE	PAY ITEM DESCRIPTION:				

ITEM 604.070503 - ALTERING DRAINAGE STRUCTURES, LEACHING BASINS AND MANHOLES



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1/6/2022

DATE

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	REVISIONS		
NO.	DESCRIPTION	BY	DATE

CLIENT



CITY OF DUNKIRK

PROJECT NAME

LAKE SHORE DRIVE

DRAWING TITLE

MISCELLANEOUS **TABLES**

SCALE	DATE	
NONE	DECEMBER 2021	
P.I.N. 5763.53	FEDERAL AID PROJECT NO.	
SHEET NO.	DRAWING NO.	
21 of 94	MT-03	


1.5% (SEE NOTE 1) - 4" CONCRETE SIDEWALK, (6" AT DRIVEWAYS) ITEM 608.0101 6" SUBBASE COURSE, OPTIONAL TYPE ITEM 304.15

CONCRETE SIDEWALK / DRIVEWAY SECTION REPLACEMENT DETAIL

NOT TO SCALE

NOTES:

- CROSS-SLOPE OF CONCRETE SIDEWALK IS 1.5% MAXIMUM FOR DESIGN AND LAYOUT, AND 2" MAXIMUM FOR WORK ACCEPTANCE.
- 2. PROVIDE 1/2 INCH WIDE EXPANSION JOINT BETWEEN NEW CONCRETE CONSTRUCTION AND BACK EDGE CURB, CONCRETE GUTTER, OTHER PAYED AREAS, BUILDINGS, WALLS, POLE BASES AND OTHER STRUCTURES/APPURTENANCES.
- FOR EXPANSION JOINT USE 1/2 INCH WIDE PREMOULDED EXPANSION JOINT MATERIAL, SEALED WITH 1/2 INCH WIDE CAULKING SEALANT 5/8 INCH DEEP.

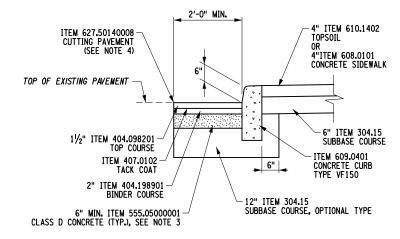


CONCRETE CURB REPLACEMENT DETAIL


NOT TO SCALE

CONCRETE CURB NOTES:

- 1. CAST-IN-PLACE CONCRETE CURB TYPE VF150 SHALL BE DETAILED ACCORDING TO STANDARD SHEET 609-03.
- 2. PROVIDE O" CURB REVEAL FOR HEADER CURB AT SIDEWALK RAMPS AND $1\frac{1}{2}$ " FOR HEADER CURB AT DRIVEWAYS.
- THE TOP OF THE NEW CLASS D CONCRETE IS TO BE EVEN WITH OR LOWER THAN THE TOP OF THE EXISTING BASE, IN ORDER TO PROVIDE MINIMUM THICKNESS ASPHALT TOP AND BINDER.
- SEAL SEAM WITH BITUMINOUS SEALER CORRESPONDING TO NYSDOT MATERIAL DESIGNATION 702-0700. COST INCLUDED IN PAYEMENT ITEMS.
- 5. ITEM 520.51000006 SAWCUTTING EXISTING CONCRETE, GRANITE AND ASPHALT CURBS SHALL BE USED TO SEPARATE NEW CURBS FROM EXISTING.

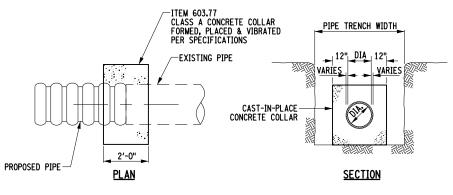

CONCRETE COLLAR CONNECTION NOT TO SCALE

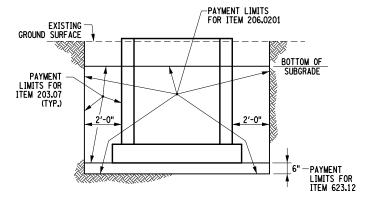

EXCAVATION AND BACKFILL DETAIL FOR DRAINAGE STRUCTURES NOT TO SCALE

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NO.	DESCRIPTION	BY	DATE

CLIENT



CITY OF DUNKIRK

PROJECT NAME

LAKE SHORE DRIVE

DRAWING TITLE

SCALE	DATE
NONE	DECEMBER 2021
P.I.N. 5763.53	FEDERAL AID PROJECT NO.
SHEET NO.	DRAWING NO.
22 OF 94	MD-01

TRENCH DETAIL TEMPORARY TRENCH RESTORATION

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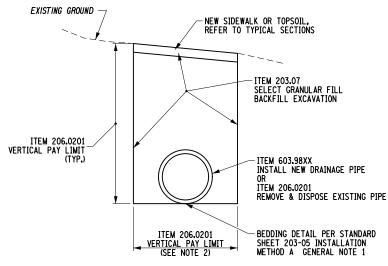
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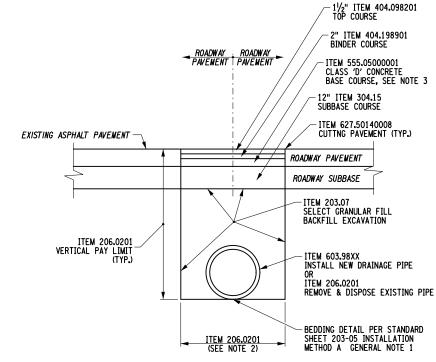
NAME 'TIME USER

- THE CONTRACTOR SHALL REMOVE EXISTING PIPE UNDER THE INSTALLATION OF PROPOSED DRAINAGE PIPE WHEN IN THE SAME TRENCH.
- 2. PROPOSED: THE PAY LIMIT WIDTH OF TRENCH SHALL BE PAID PER STANDARD SHEET 203-05 INSTALLATION METHOD A TABLE 1. REMOVAL: THE PAY LIMIT WIDTH OF TRENCH SHALL BE A MINIMUM OF 2 FEET WIDE OR 0.D. OF THE EXISTING PIPE, WHICHEVER IS GREATERIN LOCATION WHERE THE EXISTING PIPE IS OUTSIDE OF THE PROPOSED TRENCH.
- THE FINAL PAVEMENT SECTION SHALL MATCH TYPICAL SECTIONS. PAYMENT SHALL BE MADE UNDER RESPECTIVE ITEMS.



TRENCH DETAIL OUTSIDE PAVEMENT LIMITS NOT TO SCALE

- THE CONTRACTOR SHALL REMOVE EXISTING PIPE UNDER THE INSTALLATION OF PROPOSED DRAINAGE PIPE WHEN IN THE SAME TRENCH.
- 2. PROPOSED: THE PAY LIMIT WIDTH OF TRENCH SHALL BE PAID PER STANDARD SHEET 203-05 INSTALLATION METHOD A TABLE 1.
 REMOVAL: THE PAY LIMIT WIDTH OF TRENCH SHALL BE A MINIMUM OF 2 FEET WIDE OR O.D. OF THE EXISTING PIPE, WHICHEVER IS GREATER.IN LOCATION WHERE THE EXISTING PIPE IS OUTSIDE OF THE PROPOSED TRENCH.



PERMANENT TRENCH RESTORATION

NOTES:

EXISTING DRAINAGE STRUCTURE

EXISTING PAVEMENT

ITFM 206-0201

VERTICAL PAY LIMIT

- 1. THE CONTRACTOR SHALL REMOVE EXISTING PIPE UNDER THE INSTALLATION OF PROPOSED DRAINAGE PIPE WHEN IN THE SAME TRENCH.
- THE PAY LIMIT WIDTH OF TRENCH SHALL BE PAID PER STANDARD SHEET 203-05 INSTALLATION METHOD A TABLE 1.
- 3. CONCRETE BASE DEPTH SHALL MATCH EXISTING BASE DEPTH.

ITEM 206.0201 VERTICAL PAY LIMIT (SEE NOTE 2)

REMOVAL OF DRAINAGE STRUCTURE

BELOW PAVEMENT

THE CONTRACTOR SHALL REMOVE EXISTING PIPE UNDER THE INSTALLATION OF PROPOSED DRAINAGE PIPE WHEN IN THE SAME TRENCH.

2. THE PAY LIMIT WIDTH OF TRENCH SHALL BE 6 INCHES BEYOND THE EXTERIOR LIMITS OF THE EXISTING STRUCTURE. IN LOCATIONS WHERE THE EXISTING STRUCTURE IS OUTSIDE OF THE PROPOSED TRENCH.

3. THE FINAL PAVEMENT SECTION SHALL MATCH TYPICAL SECTIONS, PAYMENT SHALL BE MADE UNDER RESPECTIVE ITEMS.

CLIENT 4" ITEM 404.198901 (BINDER COURSE) TEMPORARY PAVEMENT ITEM 627.50140008 CUT EXISTING PAVEMENT (TYP.) ROADWAY PAVEMENT ROADWAY SUBBASE ITEM 203.07 SELECT GRANULAR FILL BACKFILL EXCAVATION CITY OF DUNKIRK

- ITEM 206.0201 REMOVE & DISPOSE

EXISTING PIPE

PROJECT NAME

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BY DATE

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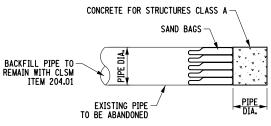
DESCRIPTION

LAKE SHORE DRIVE

DRAWING TITLE

MISCELLANEOUS DETAILS

SCALE NONE DECEMBER 2021 FEDERAL AID PROJECT NO. 5763.53 SHEET NO. DRAWING NO. 23 or 94 MD-02



NOT TO SCALE

NOTES:


- 2. ACCESS PIPE THROUGH EXISTING STRUCTURE IN ORDER TO BACKFILL WHEN NO PORTION OF THE PIPE IS TO BE REMOVED
- 3. REFER TO DRAINAGE TABLES ON DWG. MST-01 FOR PLUG

PIPE PLUG DETAIL

- THE COST OF SAND BAGS AND CONCRETE FOR STRUCTURES, CLASS A SHALL BE INCLUDED IN THE TRENCH AND CULVERT EXCAVATION, ITEM 206.0201.

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ALTERING DRAINAGE STRUCTURE DETAIL (2.5 INCHES OR LESS) ITEM 604.070502

NOT TO SCALE

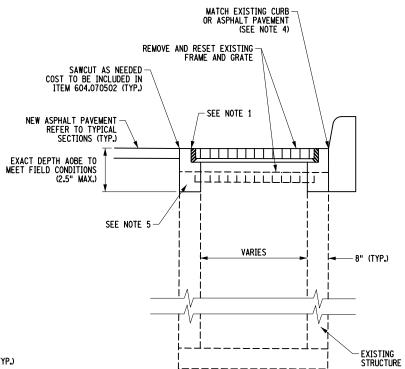NOTES:

- 1. NEW ASPHALT PAVEMENT SHALL BE FLUSH WITH DRAINAGE STRUCTURE FRAME.
- 2. SEE DRAINAGE ADJUSTMENT TABLE DRAWING FOR APPROXIMATE LOCATIONS.
- 3. DRAINAGE STRUCTURES SHALL BE ALTERED PRIOR TO PAVING FINAL COURSE.
- CURB IS SHOWN BEHIND STRUCTURE FOR ILLUSTRATIVE PURPOSES. ACTUAL FIELD CONDITIONS MAY VARY.
- 5. ADJUSTMENTS OF FRAME AND GRATES UP TO 2.5 INCHES SHALL BE MADE WITH BEDDING MATERIAL MEETING THE REQUIREMENTS OF CONCRETE REPAIR MATERIAL (701-04), RAPID HARDENING CONCRETE REPAIR MATERIALS (701-09) OR CONCRETE REPAIR MATERIAL HIGH EARLY STRENGTH (701-12) (PER STANDARD SHEET 604-02, NOTE 10).
- 6. DETAIL ABOVE REFERS TO STRUCTURES THAT NEED TO BE RAISED. SOME STRUCTURES MAY REQUIRE LOWERING, IN WHICH CASE COST TO LOWER FRAME AND GRATE, INCLUDING ANY STRUCTURE MODIFICATIONS, SHALL BE INCLUDED IN ITEM 604.070501.



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DATE

	REVISIONS		
NO.	DESCRIPTION	BY	DATE

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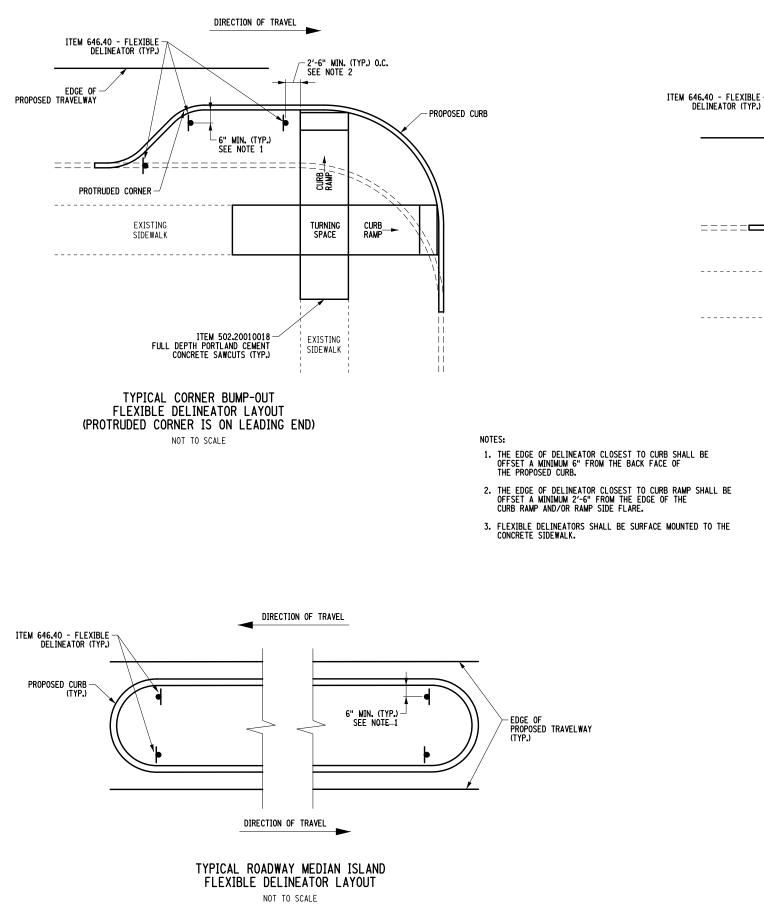
CITY OF DUNKIRK


PROJECT NAME

LAKE SHORE DRIVE

DRAWING TITLE


SCALE	DATE		
NONE	DECEMBER 2021		
P.I.N.	FEDERAL AID PROJECT NO.		
5763.53			
SHEET NO.	DRAWING NO.		
24 of 94	MD-03		



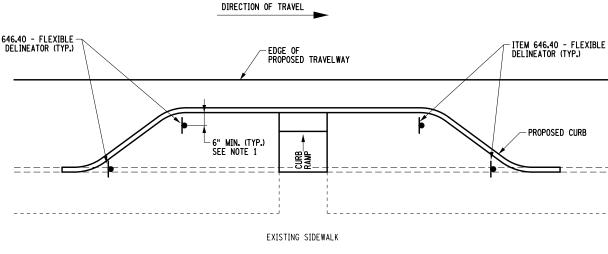

TYPICAL MID-LOCK BUMP-OUT FLEXIBLE DELINEATOR LAYOUT

NOT TO SCALE

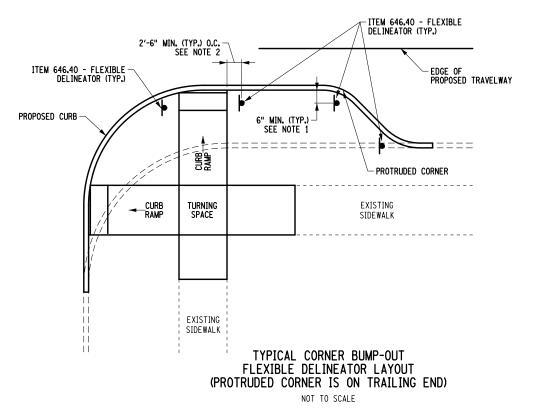

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NO.	DESCRIPTION	BY	DATE

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CITY OF DUNKIRK

PROJECT NAME

LAKE SHORE DRIVE


DRAWING TITLE

SCALE	DATE	
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P.I.N. 5763.53	FEDERAL AID PROJECT NO.	
SHEET NO.	DRAWING NO.	
25 of 94	MD-04	


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0 0 0 NAME 'TIME USER WATER MAIN NOTES:

- 1. WATER MAINS AND APPURTENANCES SHALL BE CONSTRUCTED IN ACCORDANCE WITH THE REGULATIONS AND SPECIFICATIONS OF THE CITY OF DUNKIRK WATER DEPARTMENT AND THE CHAUTAUQUA COUNTY HEALTH DEPARTMENT, AND MUST MEET APPROPRIATE AWWA STANDARDS.
- 2. WATER MAIN(S) SHALL BE DUCTILE IRON CEMENT-LINED CLASS 52. ALL D.I.P.
 SHALL MEET AWWA STANDARD C-151. NEW WATER SERVICE LINES SHALL BE A
 MINIMUM 1" TYPE K SOFT COPPER, UNLESS OTHERWISE APPROVED BY THE CITY
- 3. THE EXTERIOR OF DUCTILE IRON PIPE SHALL BE COATED WITH A LAYER OF ARC-SPRAYED ZINC PER ISO 8179. THE MASS OF THE ZINC APPLIED SHALL BE 200g/m2 OF PIPE SURFACE AREA. A FINISHING LAYER TOPCOAT SHALL BE APPLIED TO THE ZINC. THE MEAN DRY FILM THICKNESS OF THE FINISHING LAYER SHALL NOT BE LESS THAN 3 MILS WITH A LOCAL MINIMUM NOT LESS THAN 2 MILS. THE ZINC COATING SYSTEM SHALL CONFORM TO ISO 8179-1.
- 4. THE WATER MAIN SHALL BE DISINFECTED EQUAL TO AWWA C651 STANDARD FOR DISINFECTING WATER MAINS, BY USING THE CONTINUOUS FEED METHOD. THE SLUG METHOD SHALL NOT BE USED. FOLLOWING DISINFECTION, THE WATER MAIN SHALL BE FLUSHED UNTIL CHLORINE MEASUREMENTS SHOW THAT THE CONCENTRATION IN THE WATER LEAVING THE MAIN IS NO HIGHER THAN THAT PREVAILING IN THE SYSTEM. UPON COMPLETION OF DISINFECTION AND FLUSHING, THE CHAUTAUQUA COUNTY HEALTH DEPARTMENT WILL COLLECT BACTERIOLOGICAL SAMPLES FOR TOTAL AND FECAL COLIFORM AND STANDARD PLATE COUNT. THE SAMPLING POINT(S) BE DECONTAMINATED BY FLAMING, SAMPLES OF WATER MUST BE COLLECTED FROM THE MAIN AND EACH BRANCH. FIRE HYDARNTS ARE NOT ACCEPTABLE SAMPLING POINTS. THE WATER MAINS SHALL NOT BE PLACED IN SERVICE UNTIL SO AUTHORIZED BY THE CHAUTAUQUA COUNTY HEALTH DEPARTMENT.
- 5. WATER MAINS AND ALL WATER SERVICE LINES SHALL HAVE A MINIMUM OF 5' OF COVER FROM FINISHED GRADE IN LAWN AREAS AND A MINIMUM OF 6' OF COVER FROM FINISHED GRADE IN PAVED AREAS.
- 6. MINIMUM VERTICAL SEPARATION BETWEEN WATER MAIN AND SEWER MAIN SHALL BE 18" MEASURED FROM THE OUTSIDE OF THE PIPES AT THE POINT OF CROSSING, MINIMUM HORIZONTAL SEPARATION BETWEEN WATER MAINS AND SEWER MAINS SHALL BE 10' MEASURED FROM THE OUTSIDE OF THE PIPES. ONE FULL LENGTH OF WATER MAIN SHALL BE CENTERED UNDER OR OVER THE SEWER SO THAT BOTH JOINTS WILL BE AS FAR FROM THE SEWER AS POSSIBLE, WHERE A WATER MAIN CROSSES UNDER A SEWER, ADEQUATE STRUCTURAL SUPPORT (COMPACTED SELECT FILL) SHALL BE PROVIDED FOR THE SEWER TO PREVENT EXCESSIVE DEFLECTION OF JOINT AND SETTLING ON AND BREAKING THE WATER MAINS.
- 7. RETAINER GLANDS SHALL BE THE PRIMARY METHOD OF THRUST RESTRAINT FOR ALL FITTINGS (TEES, BENDS, PLUGS, REDUCERS, ETC.). SELECT FITTINGS SHALL ALSO BE BACKED WITH 2,500 PSI CONCRETE THRUST BLOCKS AS A SECONDARY METHOD OF THRUST RESTRAINT. THESE LOCATIONS ARE NOTED ON THE PLANS OR IN THE DETAILS. CONCRETE MUST NOT CONTAIN ANY FLY-ASH OR OTHER POZZOLAN- CONTAINING MATERIALS.
- 8. DURING CONSTRUCTION, ALL OPEN PIPES ENDS SHALL BE COVERED IN A WATER-TIGHT MANNER USING TEMPORARY CAPS, PLUGS OR DOUBLE-LAYERED
- THE EXCAVATION WATER LEVEL SHALL BE KEPT A MINIMUM OF 12" BELOW THE WATERMAIN INVERT DURING INSTALLATION.

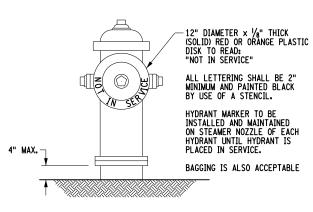


HYDRANT MARKER NOT TO SCALE

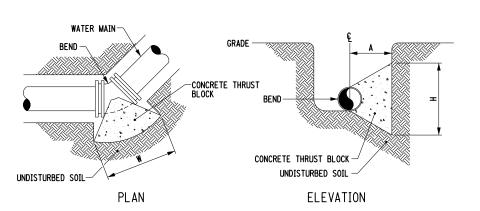


HORIZONTAL THRUST BLOCK FOR BENDS NOT TO SCALE

MINIMUM HORIZONTAL THRUST BLOCK DIMENSIONS TO BE POURED AGAINST UNDISTURBED SOIL				
	TO BE POURED AGAI	N21 ONDT210	KDED SOIL	
PIPE SIZE	FITTING	Н	W	A
(IN)	(DEGREE)	(IN)	(IN)	(IN)
6	11-1/4 BEND	12	18	18
6	22-1/2 BEND	18	24	18
l 6	45 BEND	24	36	18
6	90 BEND	24	48	24
6	TEE OR PLUG	36	36	18

NOTE: WIDTH (W) OF BLOCK SHALL NOT EXCEED TWICE THE HEIGHT (H)

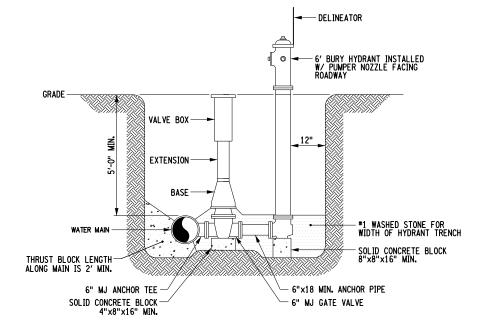

PERPENDICULAR HYDRANT INSTALLATION NOT TO SCALE

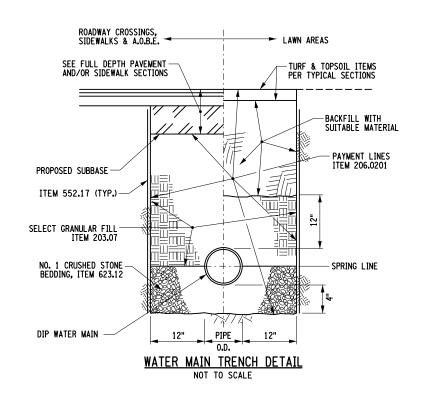

WATERMAIN TRENCH NOTES:

ITEM 552.17 - SHIELDS AND SHORING SHALL BE USED AS REQUIRED.



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DATE

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NO.	DESCRIPTION	BY	DATE

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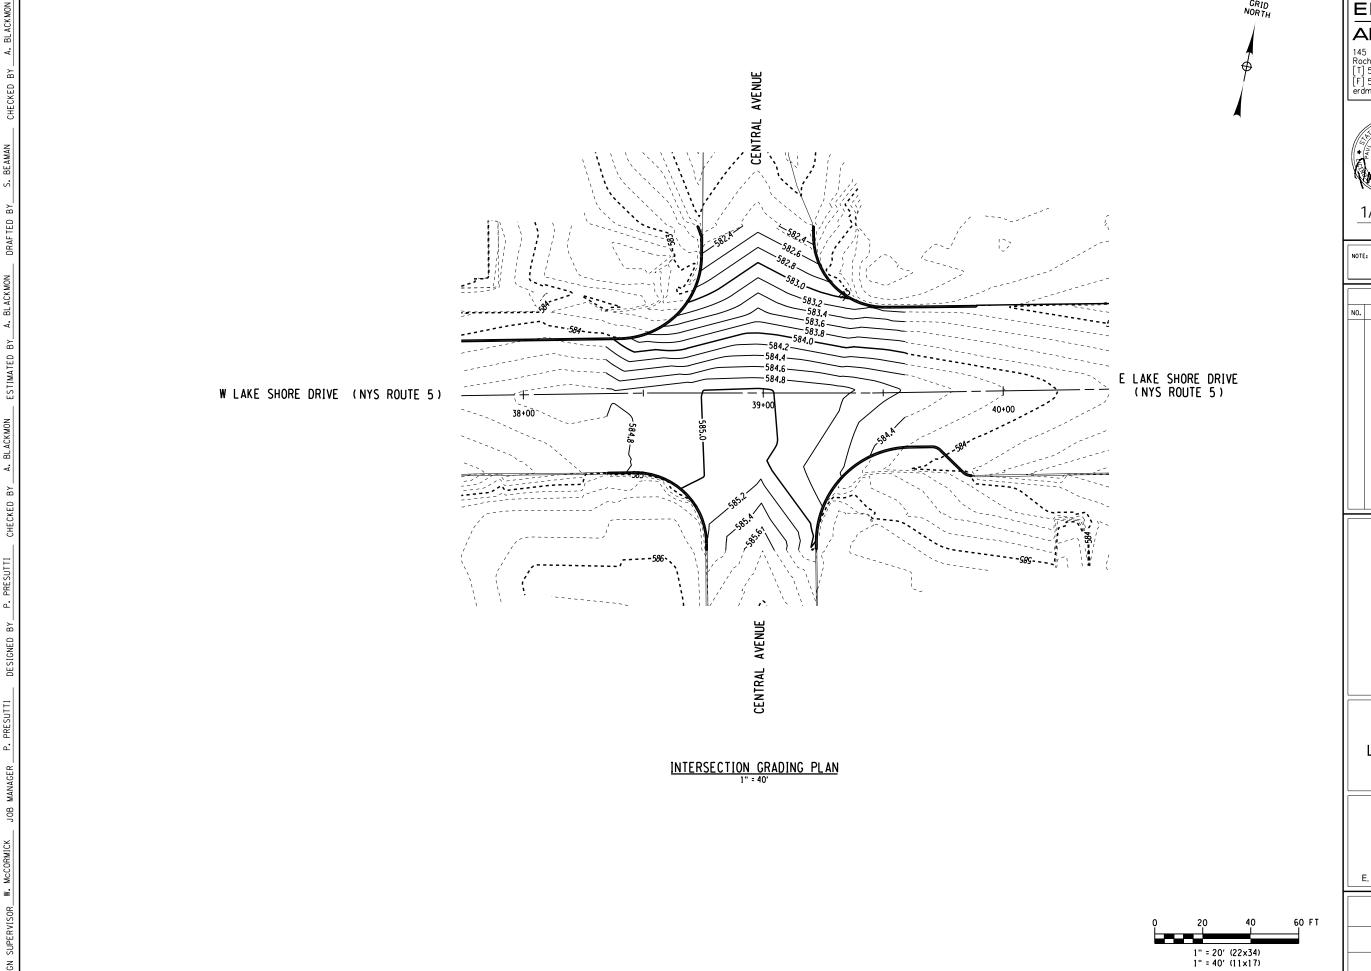
CITY OF DUNKIRK

PROJECT NAME

LAKE SHORE DRIVE

DRAWING TITLE

SCALE	DATE	
NONE	DECEMBER 2021	
P.I.N. 5763.53	FEDERAL AID PROJECT NO.	
SHEET NO.	DRAWING NO.	
26 of 94	MD-05	



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CITY OF DUNKIRK

PROJECT NAME


LAKE SHORE DRIVE

DRAWING TITLE

MISCELLANEOUS DETAILS

E. LAKE SHORE DR. @ CENTRAL AVE.

SCALE	DATE
1" = 40'	DECEMBER 2021
p.i.n. 5763.53	FEDERAL AID PROJECT NO.
SHEET NO.	DRAWING NO.
27 or 94	MD-06

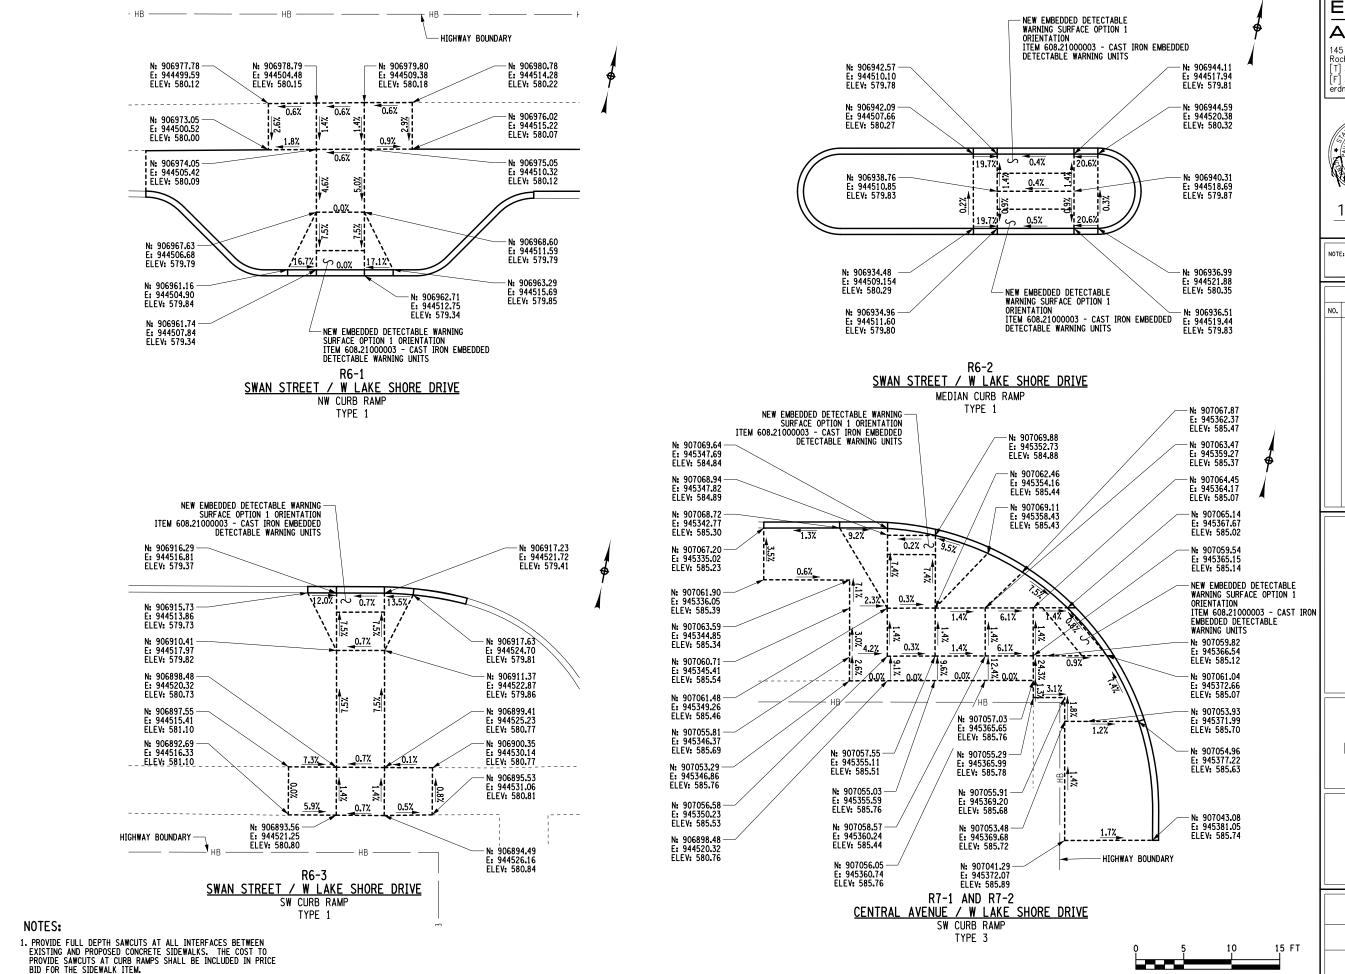

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NAME 'TIME USER ERDMAN ANTHONY

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CITY OF DUNKIRK

PROJECT NAME


LAKE SHORE DRIVE

DRAWING TITLE

CURB RAMP DETAILS

SCALE	DATE	
1" = 10'	DECEMBER 2021	
P.I.N.	FEDERAL AID PROJECT NO.	
5763.53		
SHEET NO.	DRAWING NO.	
28 of 94	CRD-01	

1" = 10'

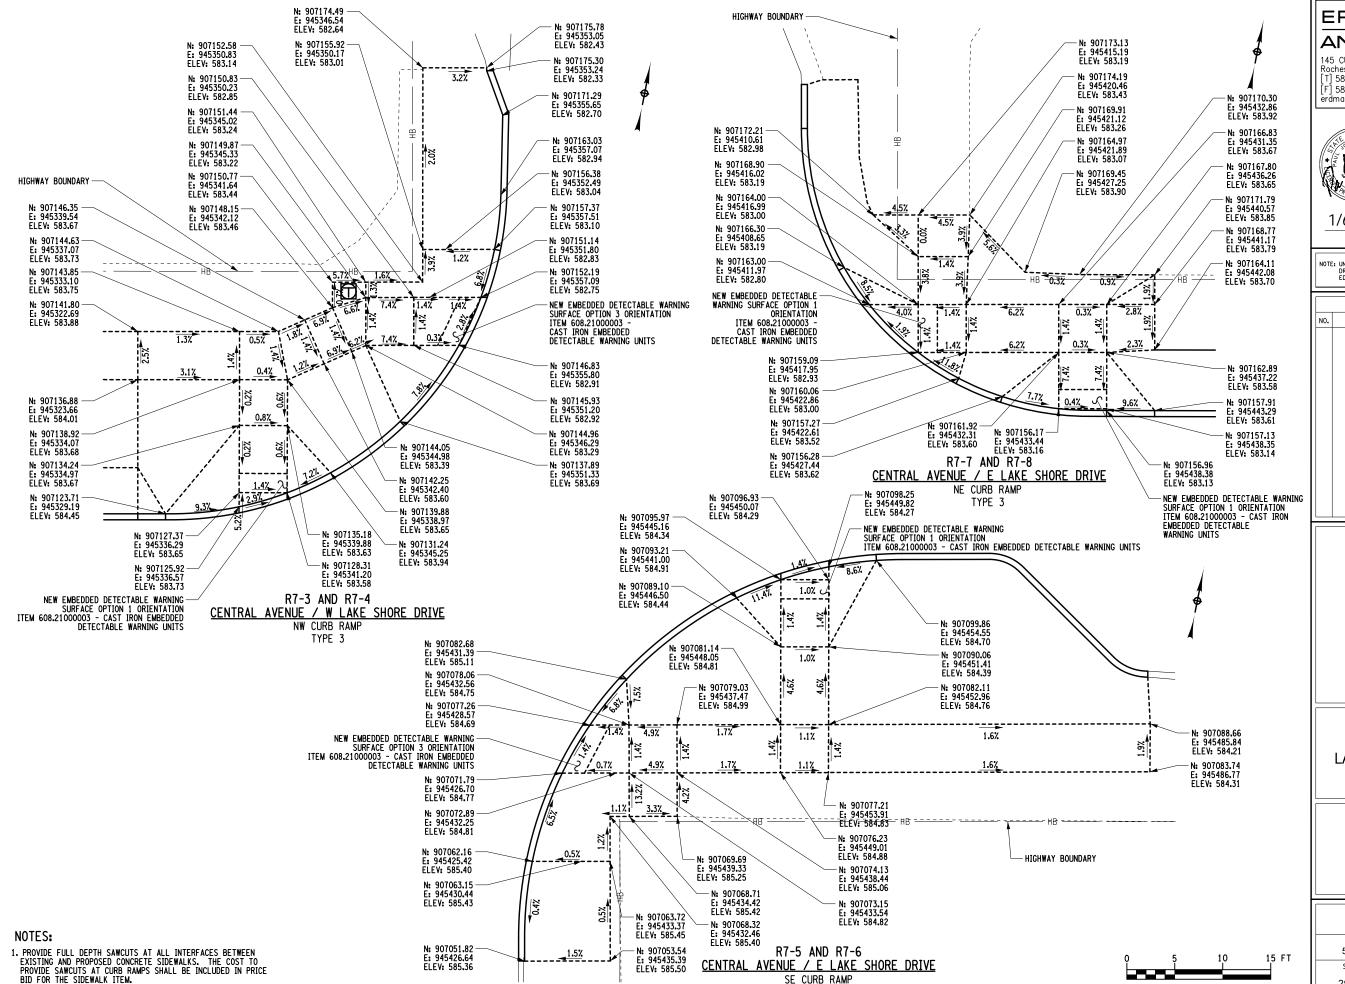

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PROJECT NAME

LAKE SHORE DRIVE

DRAWING TITLE

CURB RAMP DETAILS


SCALE	DATE	
1" = 10'	DECEMBER 2021	
P.I.N.	FEDERAL AID PROJECT NO.	
5763.53		
SHEET NO.	DRAWING NO.	
29 of 94	CRD-02	

1" = 10'

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CLIENT



CITY OF DUNKIRK

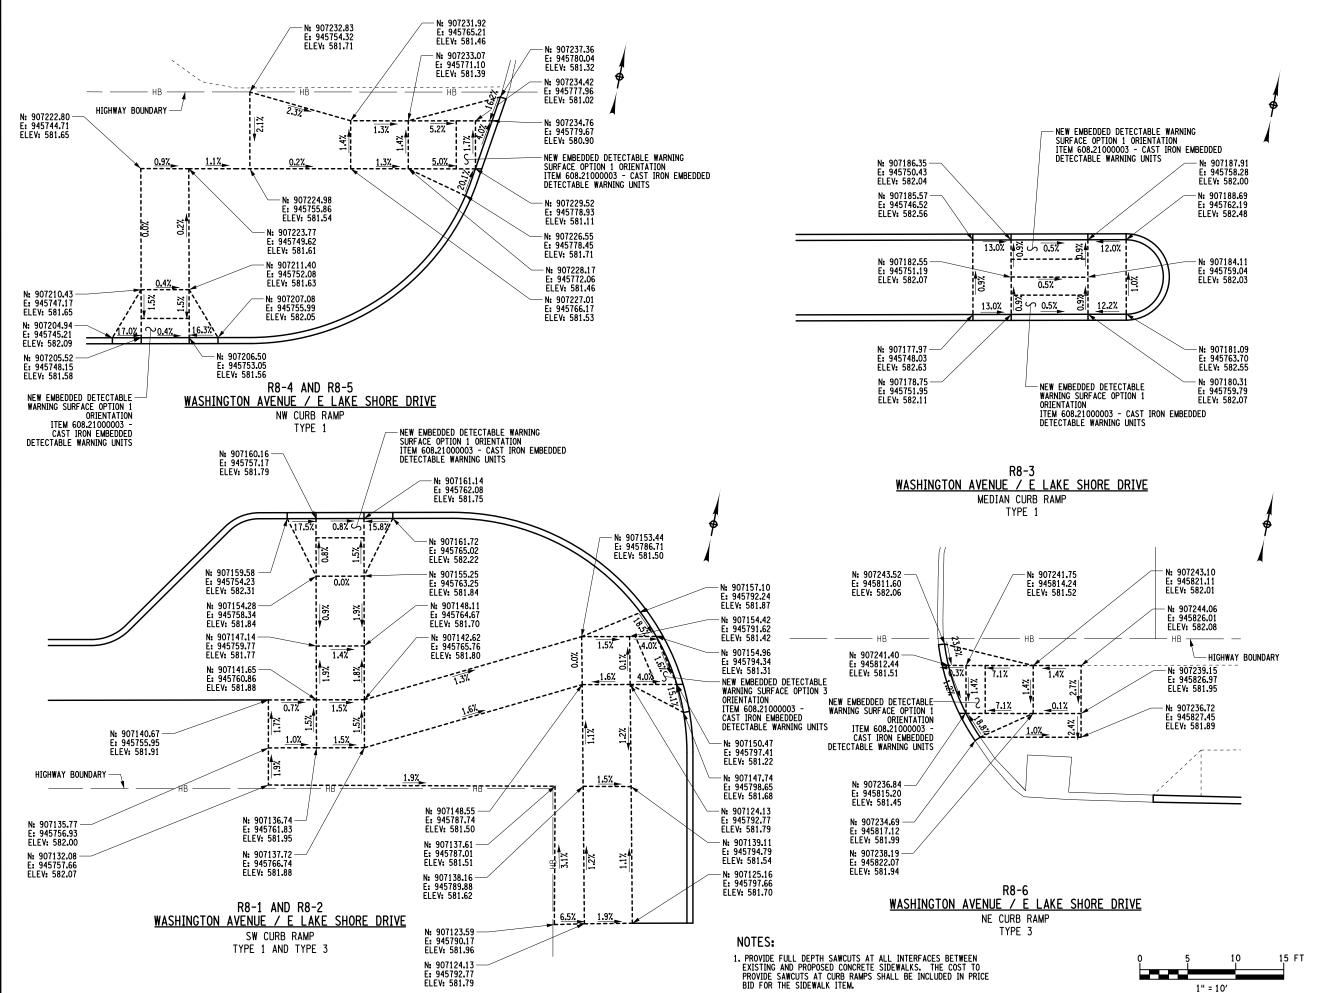PROJECT NAME

LAKE SHORE DRIVE

DRAWING TITLE

CURB RAMP DETAILS

SCALE	DATE	
1" = 10'	DECEMBER 2021	
p.i.n. 5763.53	FEDERAL AID PROJECT NO.	
SHEET NO.	DRAWING NO.	
30 of 94	CRD-03	

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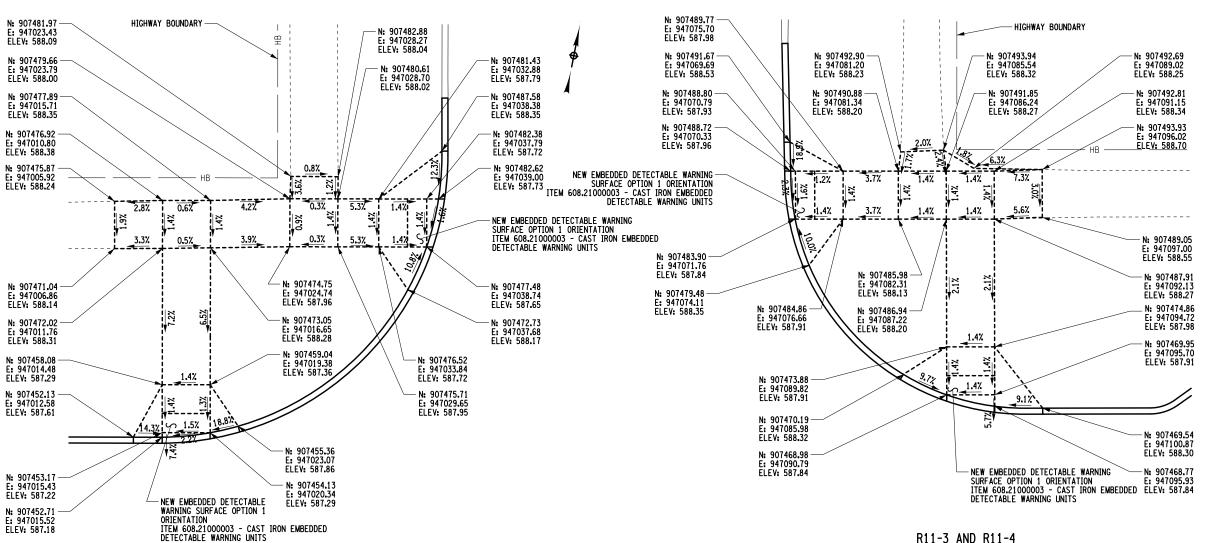
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JOB

NOTES: 1. PROVIDE FULL DEPTH SAWCUTS AT ALL INTERFACES BETWEEN EXISTING AND PROPOSED CONCRETE SIDEWALKS. THE COST TO PROVIDE SAWCUTS AT CURB RAMPS SHALL BE INCLUDED IN PRICE BID FOR THE SIDEWALK ITEM.

R11-1 AND R11-2

MAIN STREET / E LAKE SHORE DRIVE NW CURB RAMP TYPE 3



R11-3 AND R11-4 MAIN STREET / E LAKE SHORE DRIVE NE CURB RAMP TYPE 3



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CITY OF DUNKIRK

PROJECT NAME


LAKE SHORE DRIVE

DRAWING TITLE

CURB RAMP DETAILS

SCALE	DATE	
1" = 10'	DECEMBER 2021	
P.I.N.	FEDERAL AID PROJECT NO.	
5763.53		
SHEET NO.	DRAWING NO.	
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1" = 10'

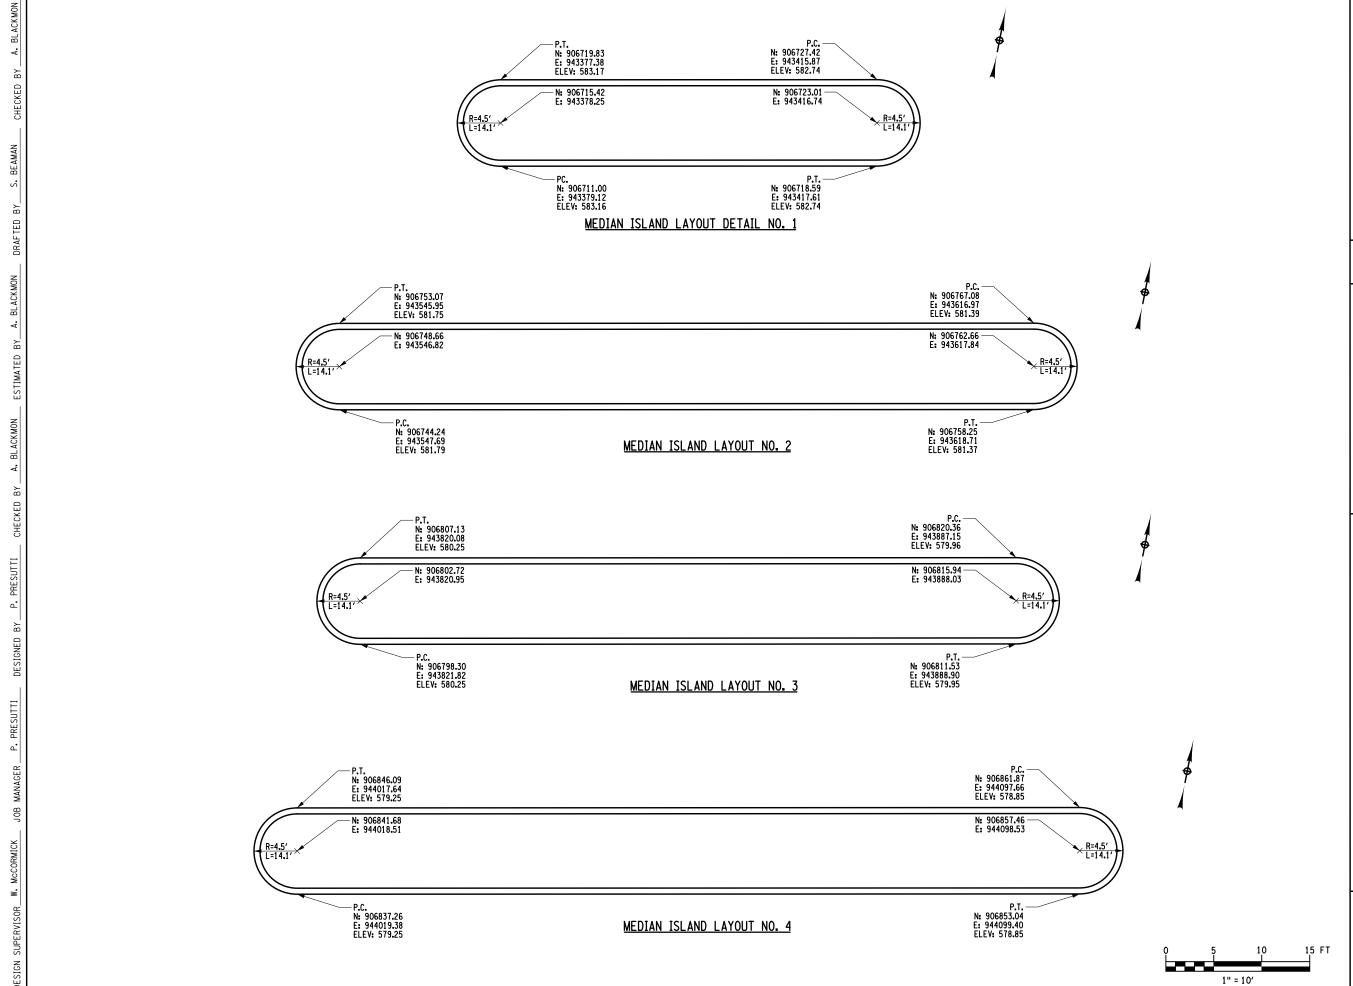

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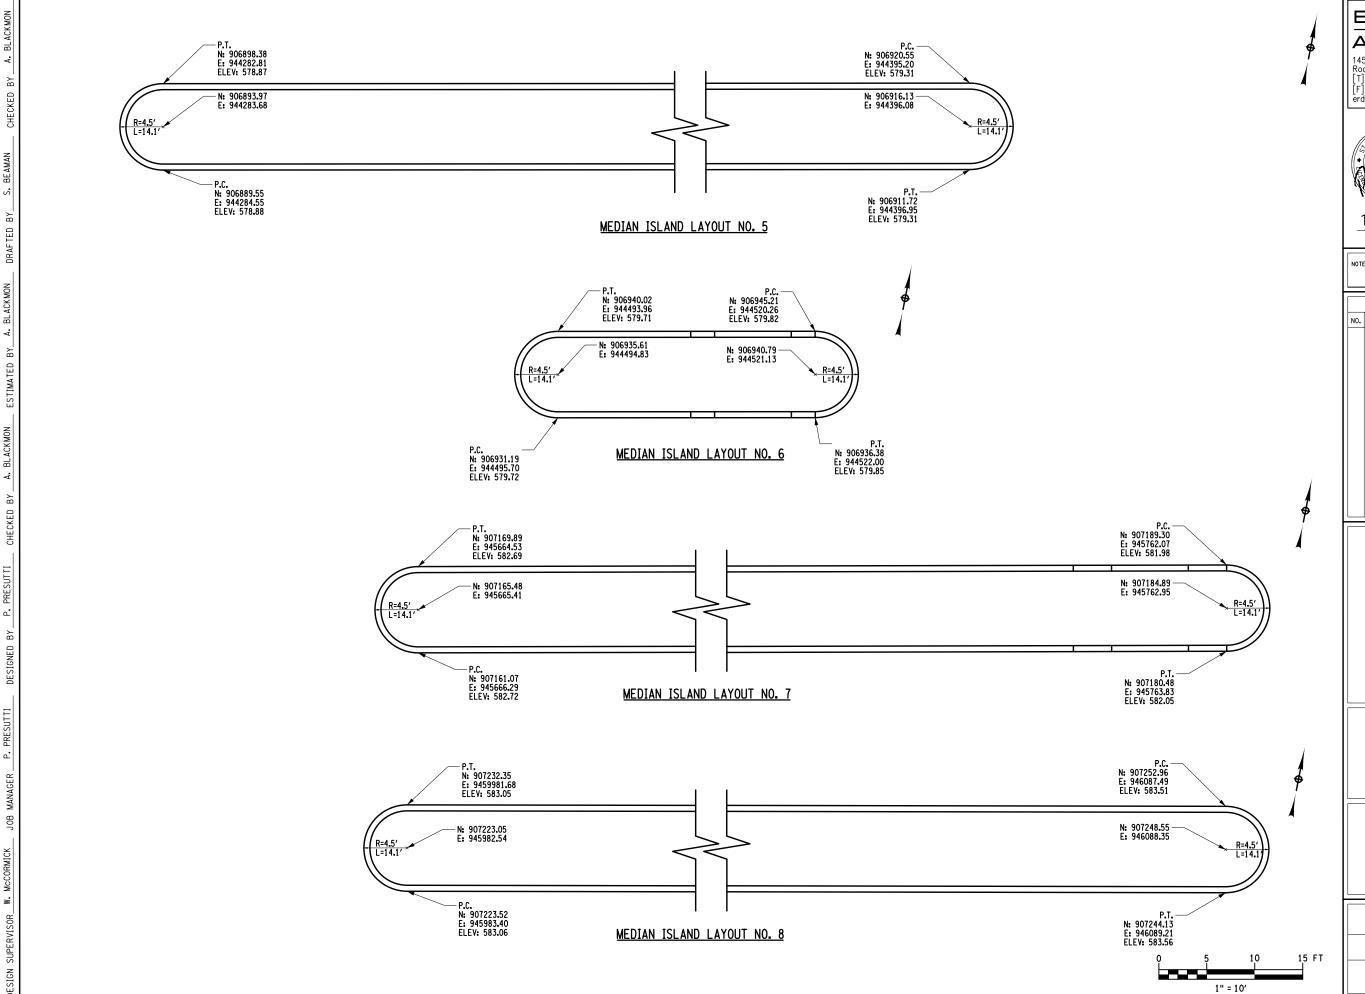
PROJECT NAME

LAKE SHORE DRIVE

DRAWING TITLE

MEDIAN ISLAND LAYOUT DETAIL

SCALE	DATE
1" = 10'	DECEMBER 2021
P.I.N.	FEDERAL AID PROJECT NO.
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SHEET NO.	DRAWING NO.
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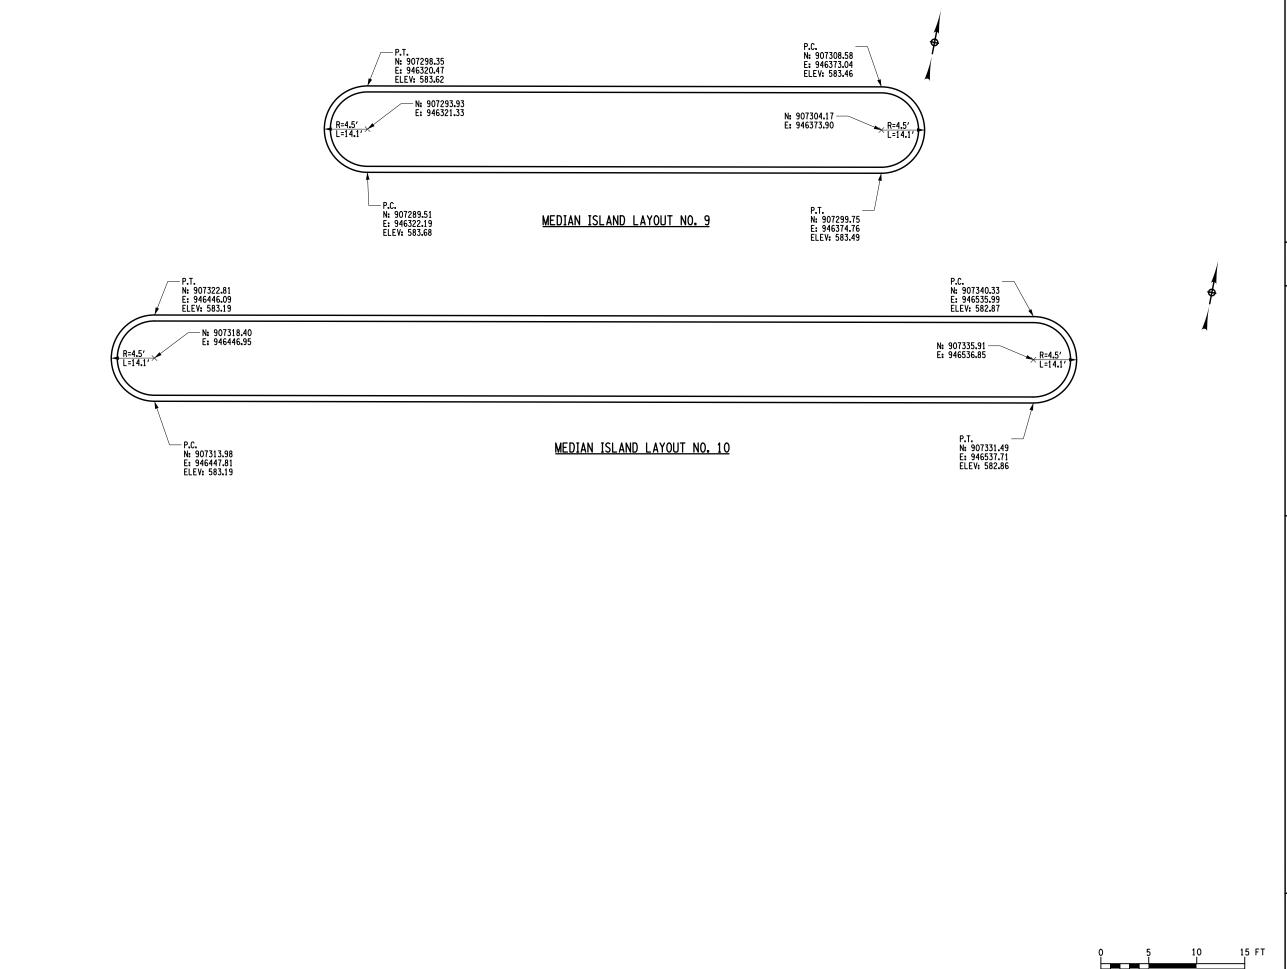
PROJECT NAME

LAKE SHORE DRIVE

DRAWING TITLE

MEDIAN ISLAND LAYOUT DETAIL

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SCALE	DATE
1" = 10'	DECEMBER 2021
p.i.n. 5763.53	FEDERAL AID PROJECT NO.
SHEET NO.	DRAWING NO.
33 of 94	MID-02



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CITY OF DUNKIRK

PROJECT NAME

LAKE SHORE DRIVE

DRAWING TITLE

MEDIAN ISLAND LAYOUT DETAIL

SCALE	DATE
1" = 10'	DECEMBER 2021
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1" = 10'

SOURCE

(1) LAKE SHORE DRIVE

TOTALS

DRAINAGE

SOURCE

1340

ROCK

SUMMARY OF TRENCH AND CULVERT EXCAVATION (ITEM 206.0201 ONLY)

EXCAVATION

NON-ROCK

172

FILE NAME : DATE/TIME : USER

 C_{E} AND/OR C_{R} c_G SUBGRADE SURFACE **CUT SECTION** SUMMARY OF EARTHWORK (ITEMS 203.02 AND 203.03 ONLY) ITEM 203.03 **EXCAVATION** T_E F_T TU

1340

ITEM

206.0201

172

172

180

– C A

ORIGINAL SURFACE

 $\boldsymbol{c}_{\boldsymbol{B}}$ - excavation for required benching, (both Longitudinal and Transverse).

CG - EXCAVATION FOR SUBGRADE IMPROVEMENT.

 $C_{\mbox{\scriptsize P}}$ - EXCAVATION FROM CUT SLOPE NECESSARY TO PLACE SLOPE PROTECTION.

 c_{E} - Portion of cut assumed to be earth suitable for embankment construction, excluding c_{G} and c_{P} .

SUBGRADE SURFACE -

 T_{E} - $(C_{B}$ + C_{G} + C_{P} + C_{E}) Total Earth excavation assumed suitable for embankment construction.

 ${\sf C}_{\sf A}$ - EXCAVATION OF TOPSOIL (UNSUITABLE MATERIAL) IN CUT.

 c_S - excavation of topsoil (unsuitable material) under embankment.

 c_{χ} - excavation of unsuitable material in cut: swamp or Dump

C_O - EXCAVATION OF UNSUITABLE MATERIAL BENEATH EMBANKMENT: SWAMP OR DUMP

 ${\rm T_U}$ - $({\rm C_A}$ + ${\rm C_S}$ + ${\rm C_X}$ + ${\rm C_0})$ total excavation assumed unsuitable for embankment construction.

 ${\rm C\,}_{\rm R}$ - PORTION OF CUT ASSUMED TO BE ROCK, INCLUDING ${\rm C\,}_{\rm G}$ IF APPLICABLE.

 $C_T - (T_E + T_U + C_R)$ TOTAL EXCAVATION.

DEFINITIONS:

- C_S OR F_S

FILL SECTION

 ${\sf F}_{\sf B}$ - FILL REQUIRED TO REPLACE BENCHES.

 $\boldsymbol{F_{S}}$ - FILL REQUIRED TO REPLACE TOPSOIL REMOVED BENEATH EMBANKMENTS.

ORIGINAL SURFACE -

F - FILL REQUIRED TO COMPLETE EMBANKMENT TO SUBGRADE SURFACE AND SIDE-SLOPES AFTER FOUNDATION IS PREPARED.

 F_T - $(F_B + F_S + F)$ TOTAL FILL REQUIRED.

 $\rm T_A$ - (T_E \times $\rm F_E$ + $\rm ^C_R$ \times $\rm ^F_R$) The volume which the suitable excavated material could occupy in embankment.

 $\mathbf{F}_{\mathbf{E}}$ - Shrinkage factor for earth

F_R - SWELL FACTOR FOR ROCK

NOTES:

THE CONTRACTOR'S ATTENTION IS DIRECTED TO THE FACT THAT THESE TABLES ARE ESTIMATED, AND ARE PROVIDED FOR THE PURPOSE OF PREPARING AN ESTIMATE. THEY ARE NOT TO BE CONSTRUED AS BEING EXACT. THEY ARE INTENDED TO QUANTIFY AND QUALIFY THE NATURE OF THE WORK TO BE PERFORMED. SIGNIFICANT DIFFERENCE FROM THIS REPRESENTATION, WHEN ENCOUNTERED DURING THE ACTUAL WORK, WILL BE HANDLED ACCORDING TO THE SPECIFICATIONS GOVERNING THIS PROJECT.

203.02 UNCLASSIFIED EXCAVATION AND DISPOSAL

203.03 EMBANKMENT IN PLACE

206.0201 TRENCH AND CULVERT EXCAVATION



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CITY OF DUNKIRK

PROJECT NAME

LAKE SHORE DRIVE

DRAWING TITLE

EARTHWORK SUMMARY

SCALE	DATE
NONE	DECEMBER 2021
P.I.N. 5763.53	FEDERAL AID PROJECT NO.
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MBANKMENT																	
	EMBAN		TOTAL EXCAVATION		VATION	TABLE EXCA	UNSUIT		ROCK	SUITABLE EXCAVATION				ATION	LOCA	SUBDIVISION	
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S)	0 0	F _в	1,340	T _U 0	0 Co	C _X	C _s	C _A	C _R	1,340	1,340	С _Р	C _G	С _в	59+00	`	1

FOR DEFINITIONS AND NOTES SEE DWG. ES-01



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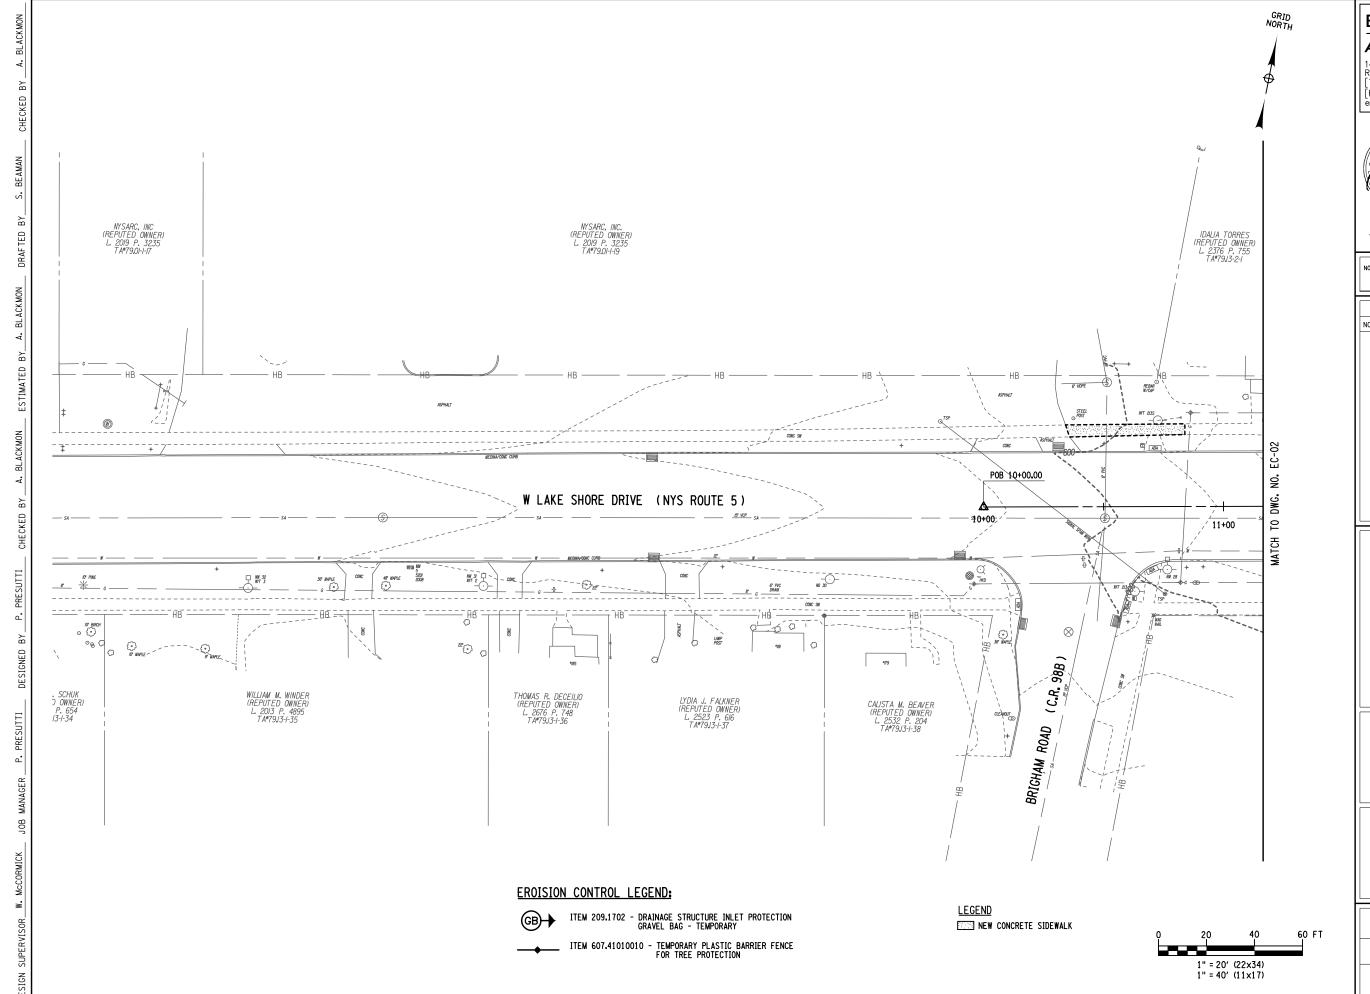
PROJECT NAME

LAKE SHORE DRIVE

DRAWING TITLE

EARTHWORK SUMMARY

scale NONE	DATE DECEMBER 2021
P.I.N. 5763.53	FEDERAL AID PROJECT NO.
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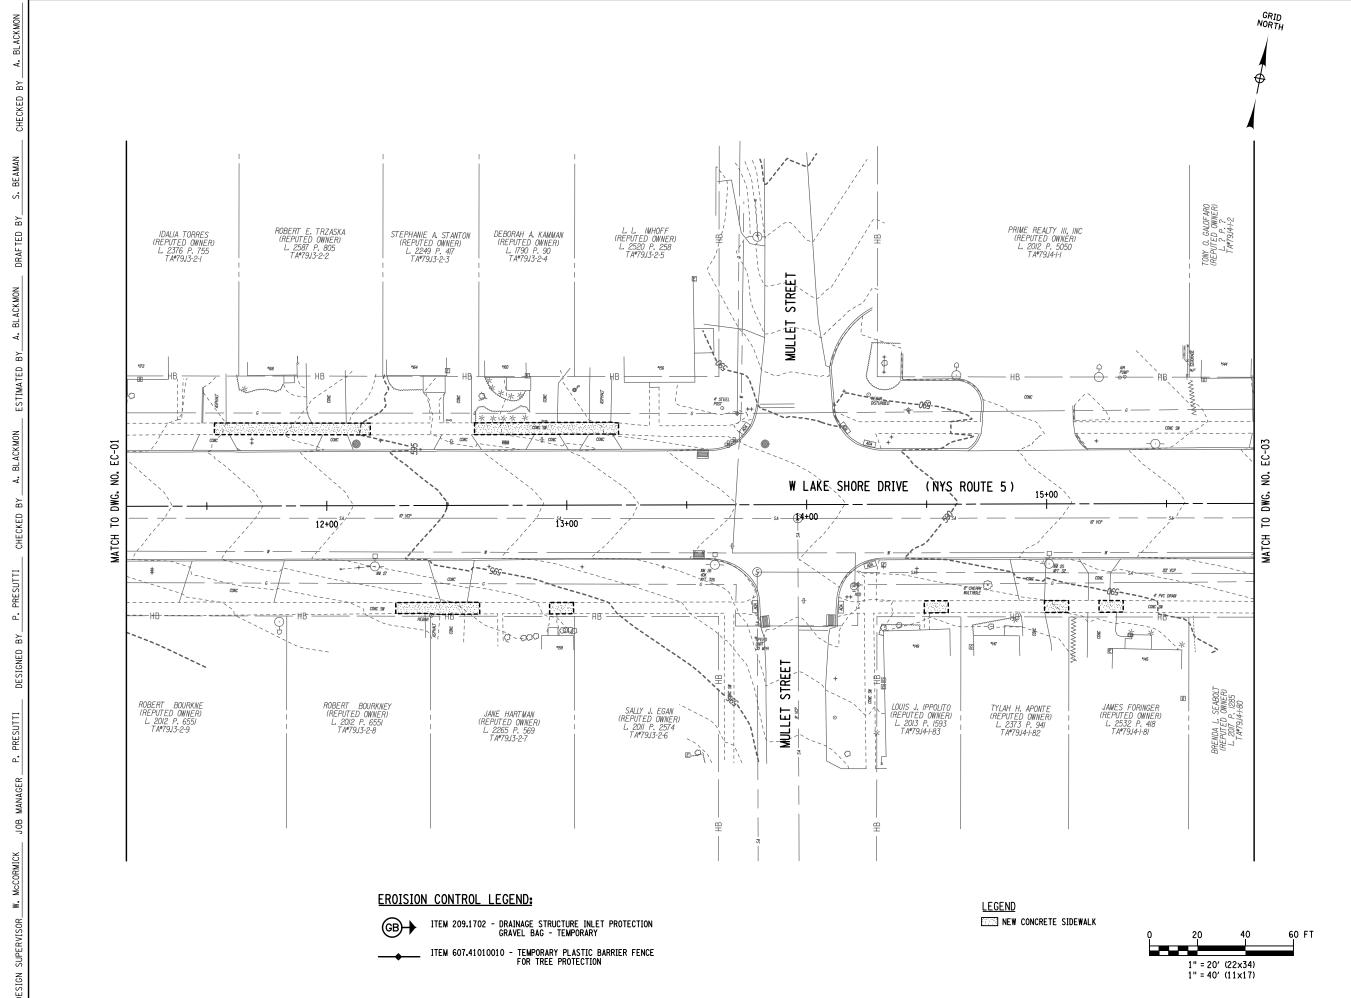


PROJECT NAME

LAKE SHORE DRIVE

DRAWING TITLE

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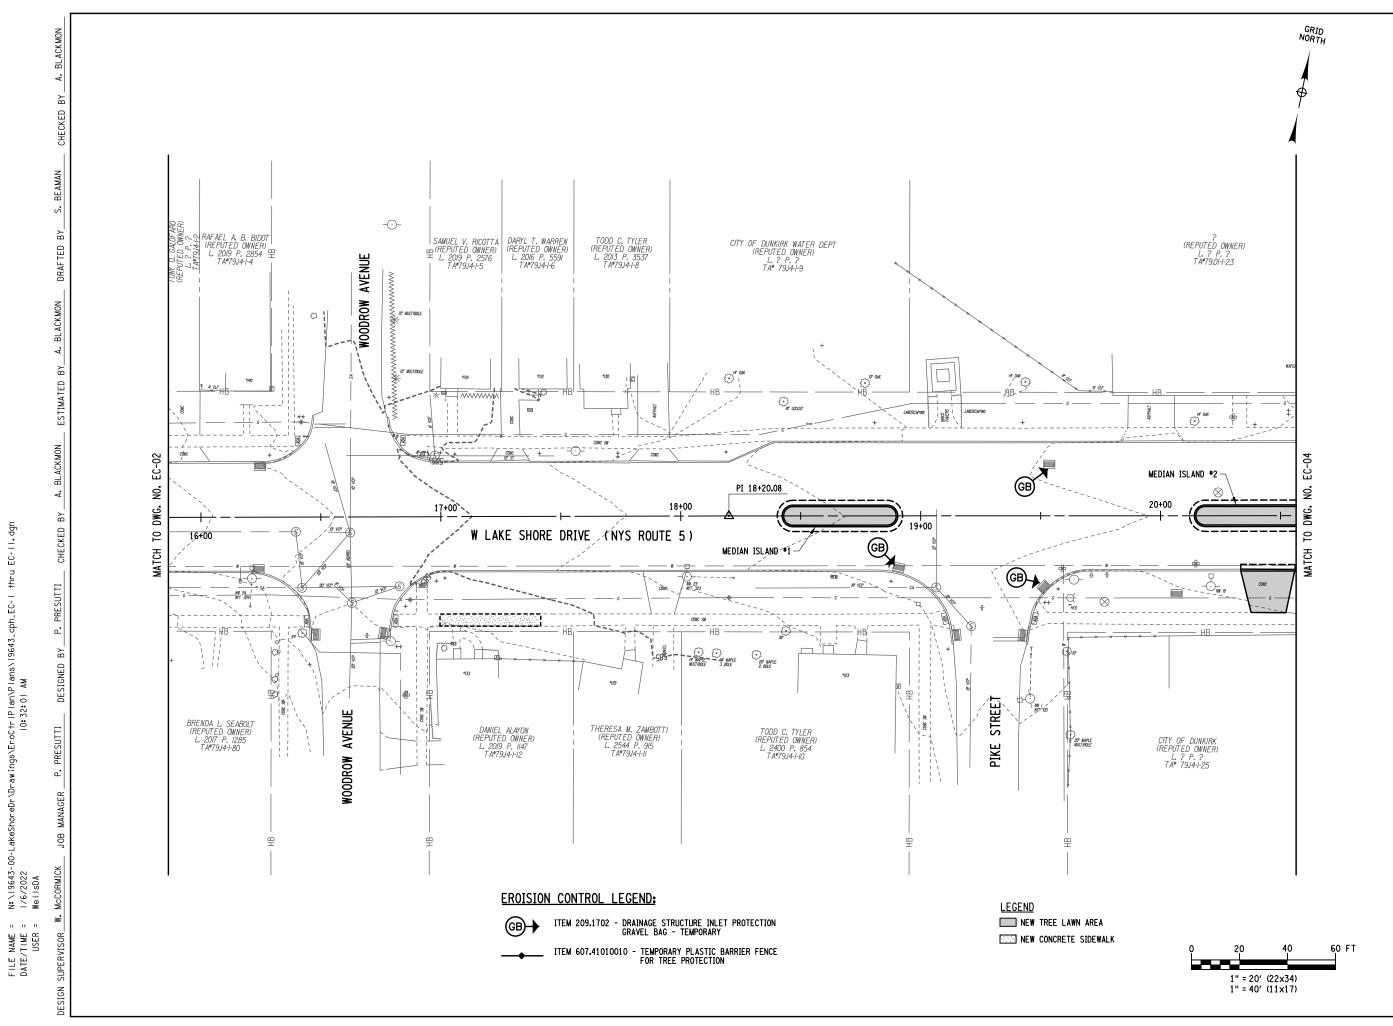
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PROJECT NAME

LAKE SHORE DRIVE

DRAWING TITLE

SCALE	DATE
1" = 40'	DECEMBER 2021
P.I.N. 5763.53	FEDERAL AID PROJECT NO.
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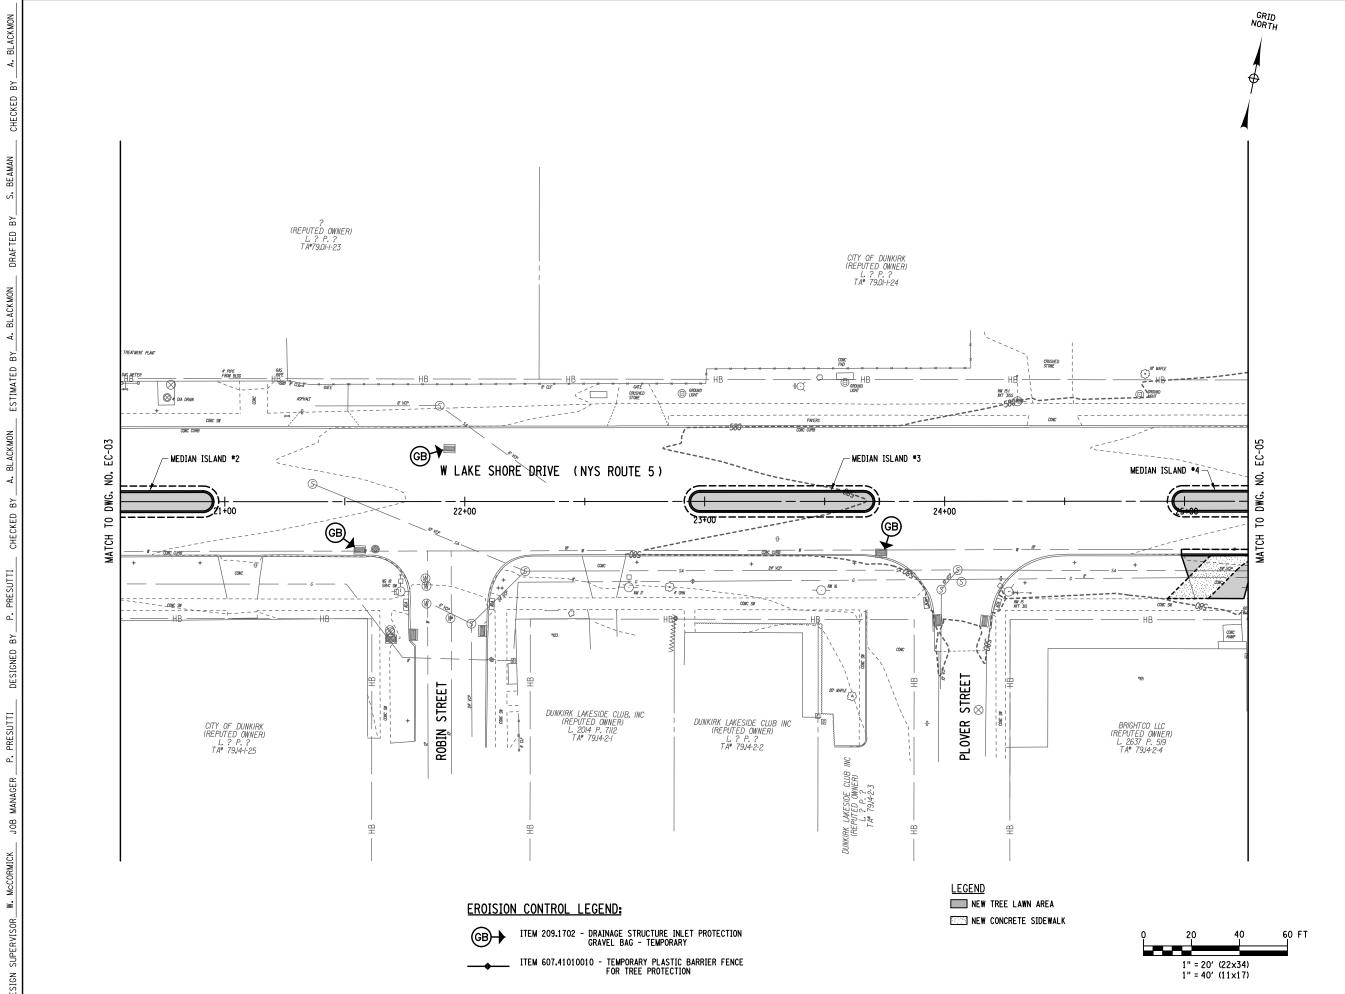


PROJECT NAME

LAKE SHORE DRIVE

DRAWING TITLE

SCALE	DATE
1" = 40'	DECEMBER 2021
P.I.N. 5763.53	FEDERAL AID PROJECT NO.
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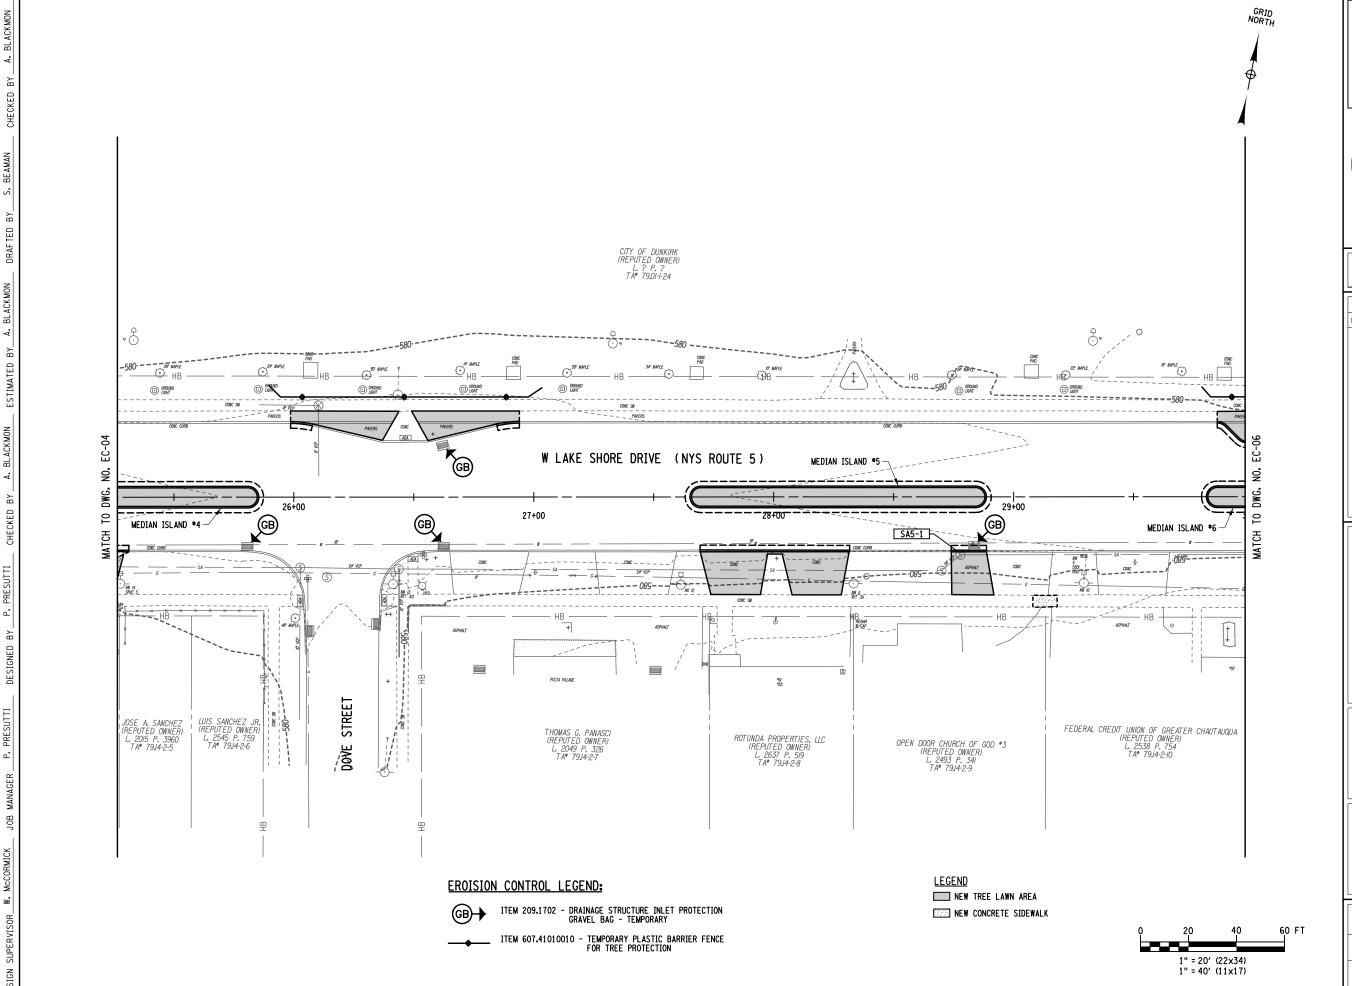


PROJECT NAME

LAKE SHORE DRIVE

DRAWING TITLE

scale 1" = 40'	DATE DECEMBER 2021
p.i.n. 5763.53	FEDERAL AID PROJECT NO.
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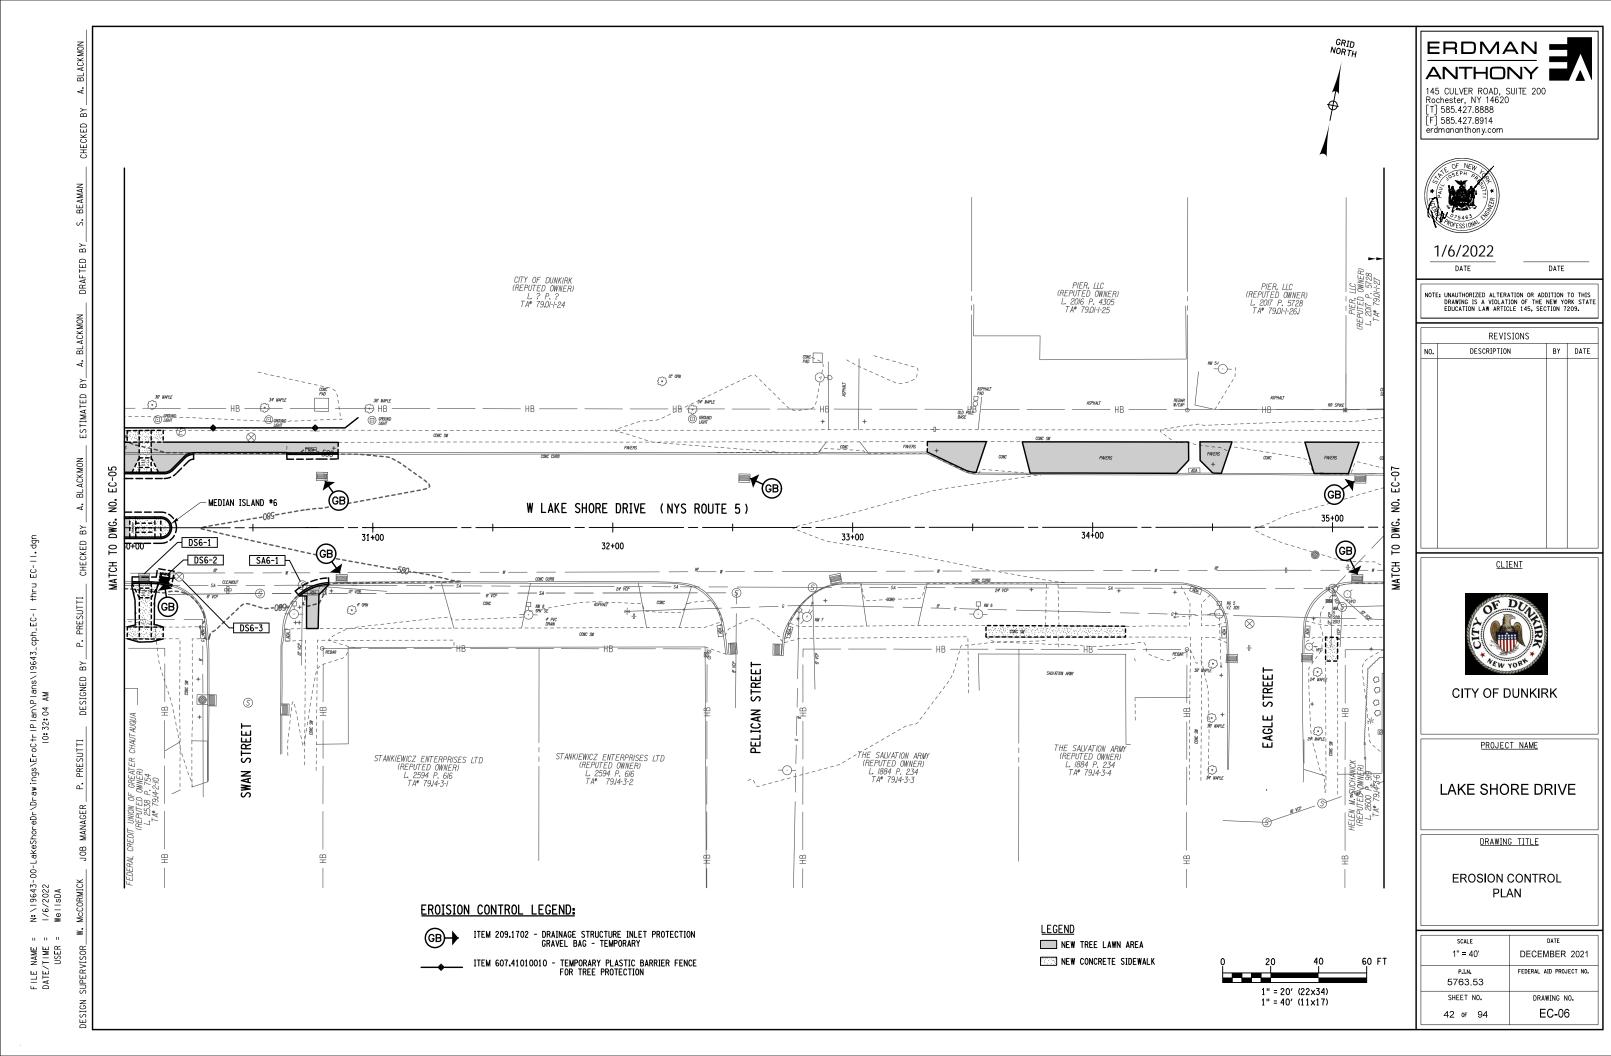



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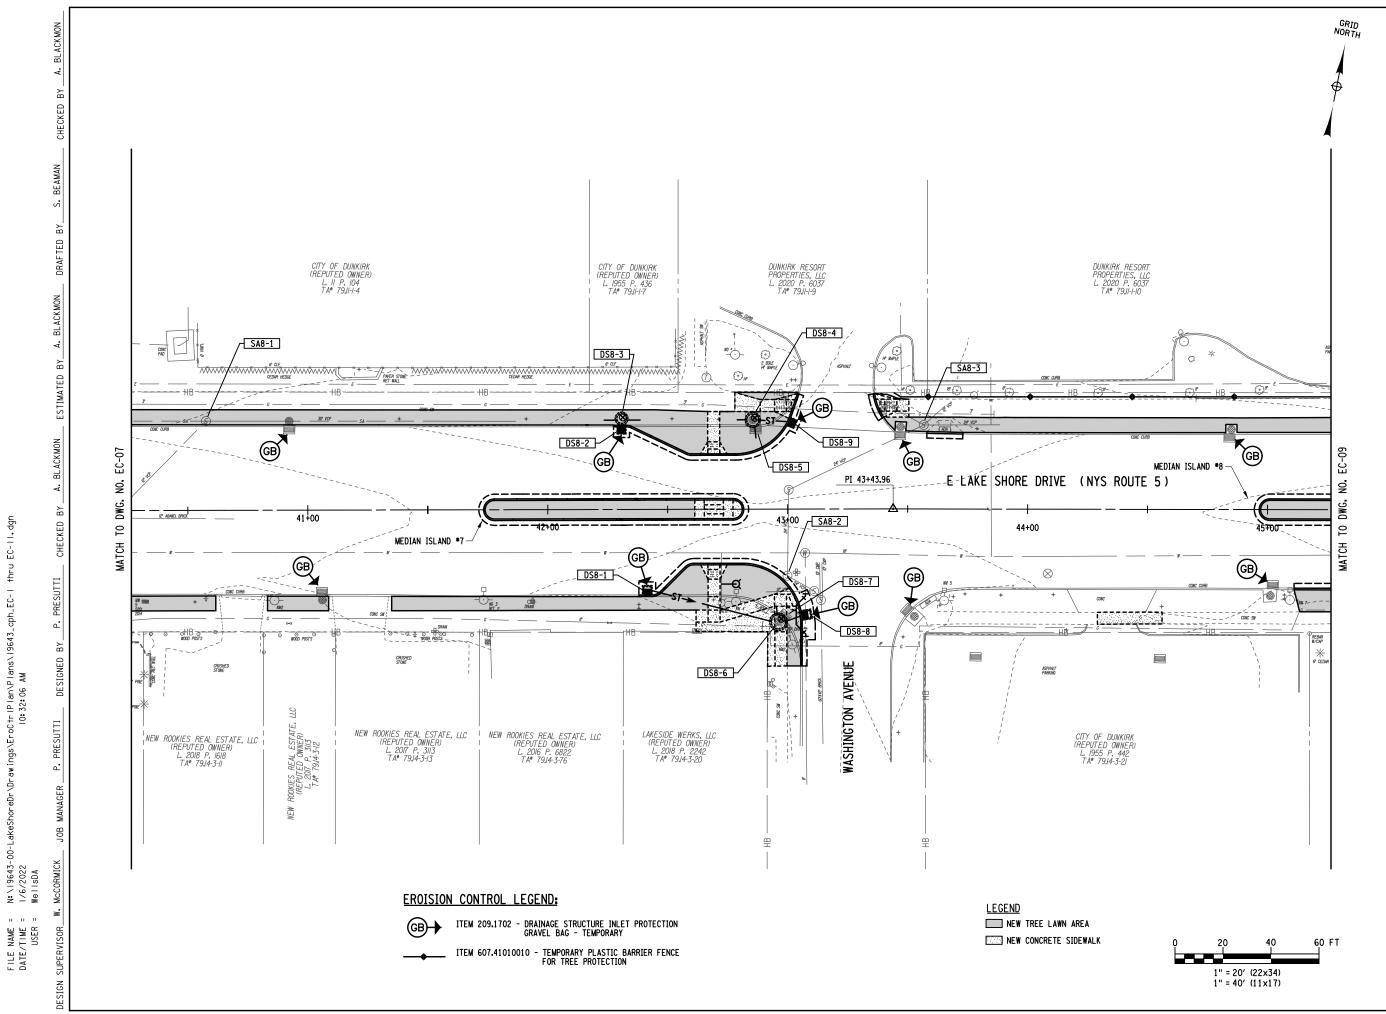
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1" = 40'	DECEMBER 2021
P.I.N. 5763.53	FEDERAL AID PROJECT NO.
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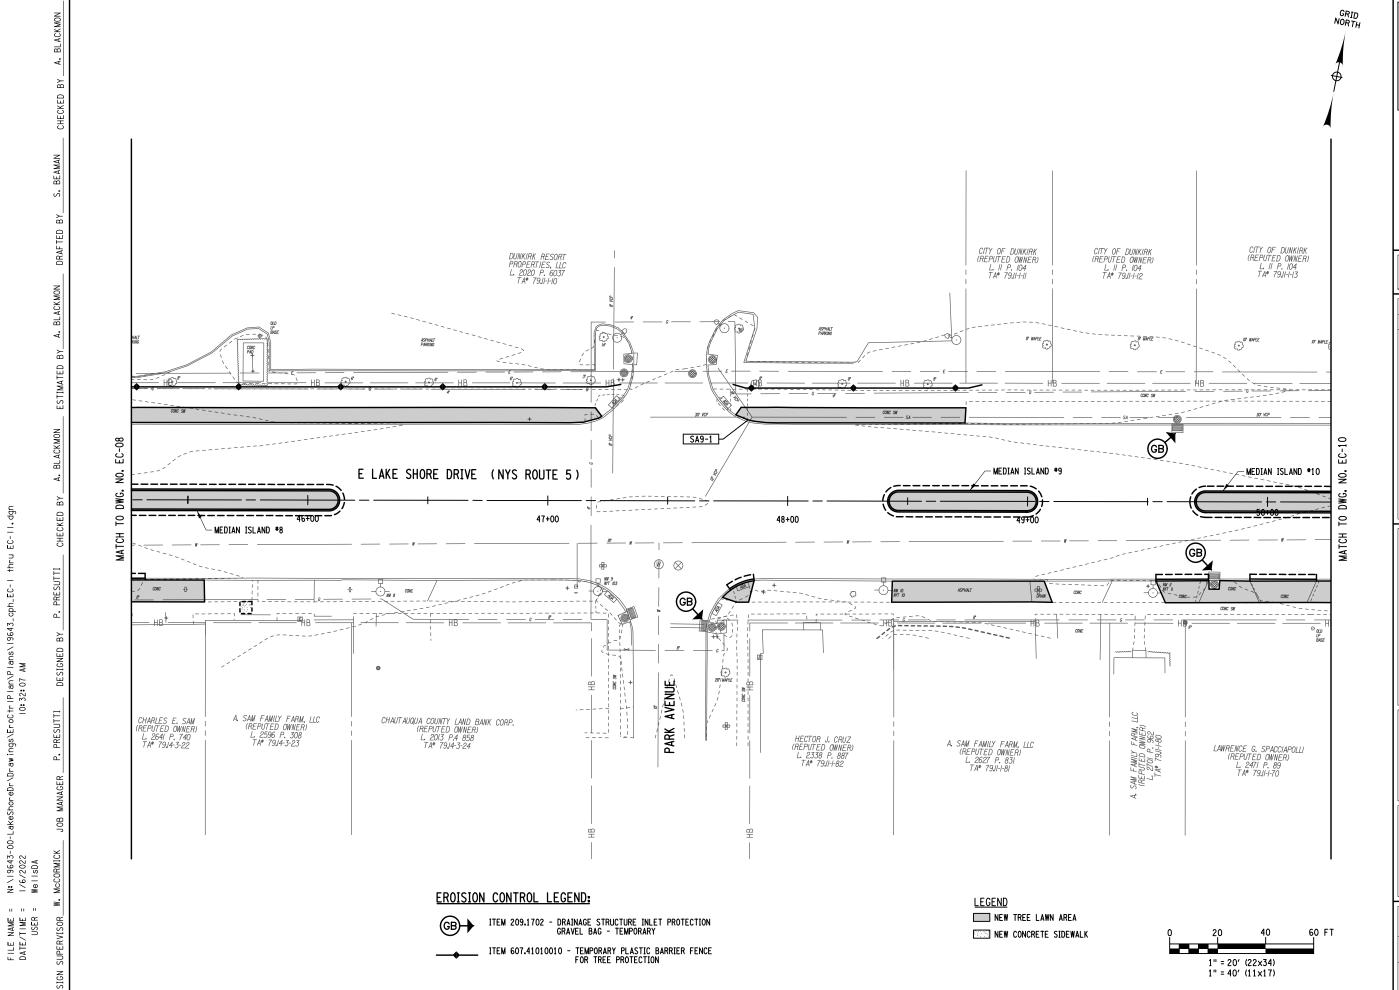


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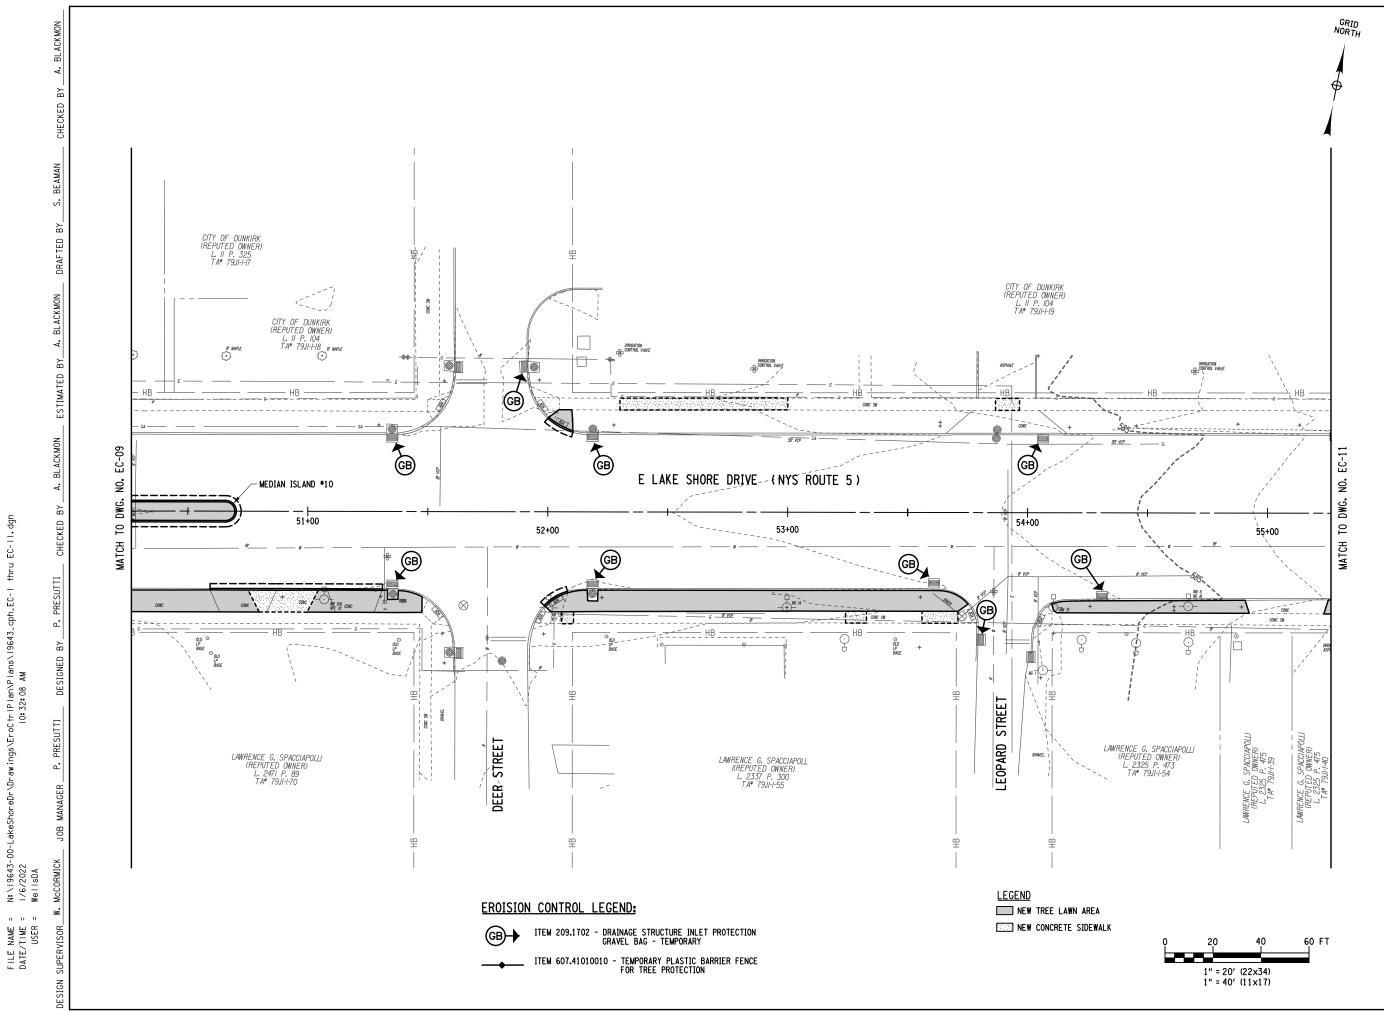


PROJECT NAME

LAKE SHORE DRIVE

DRAWING TITLE

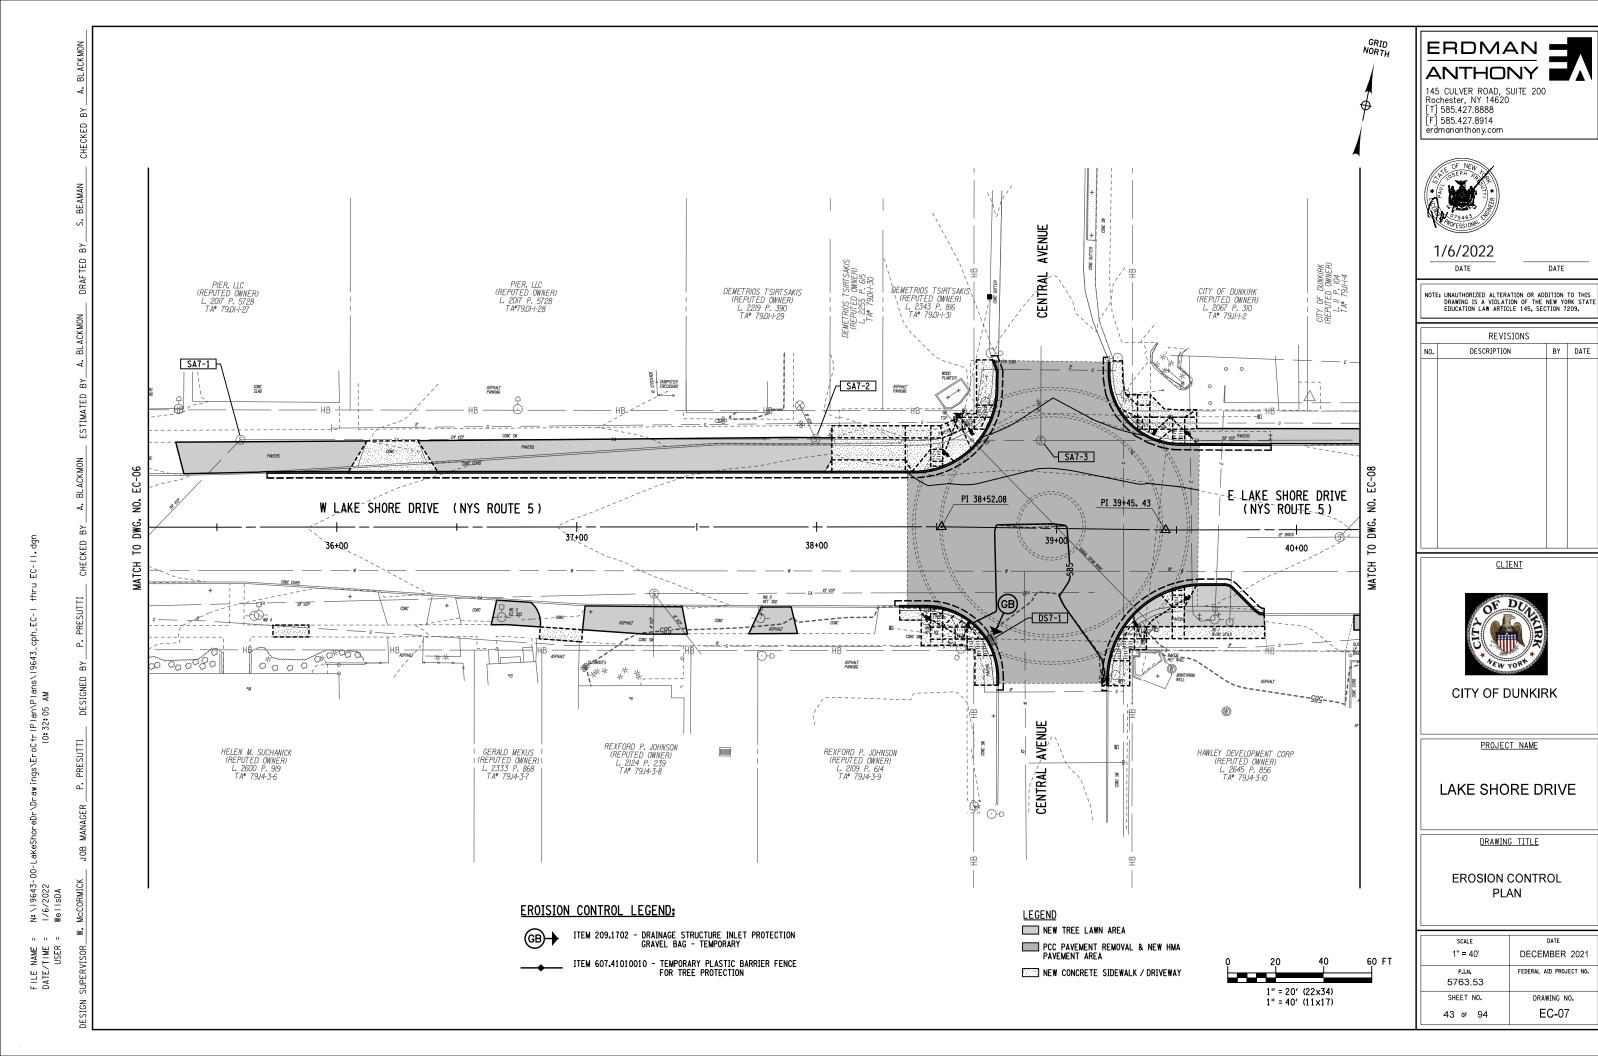SCALE	DATE
1" = 40'	DECEMBER 2021
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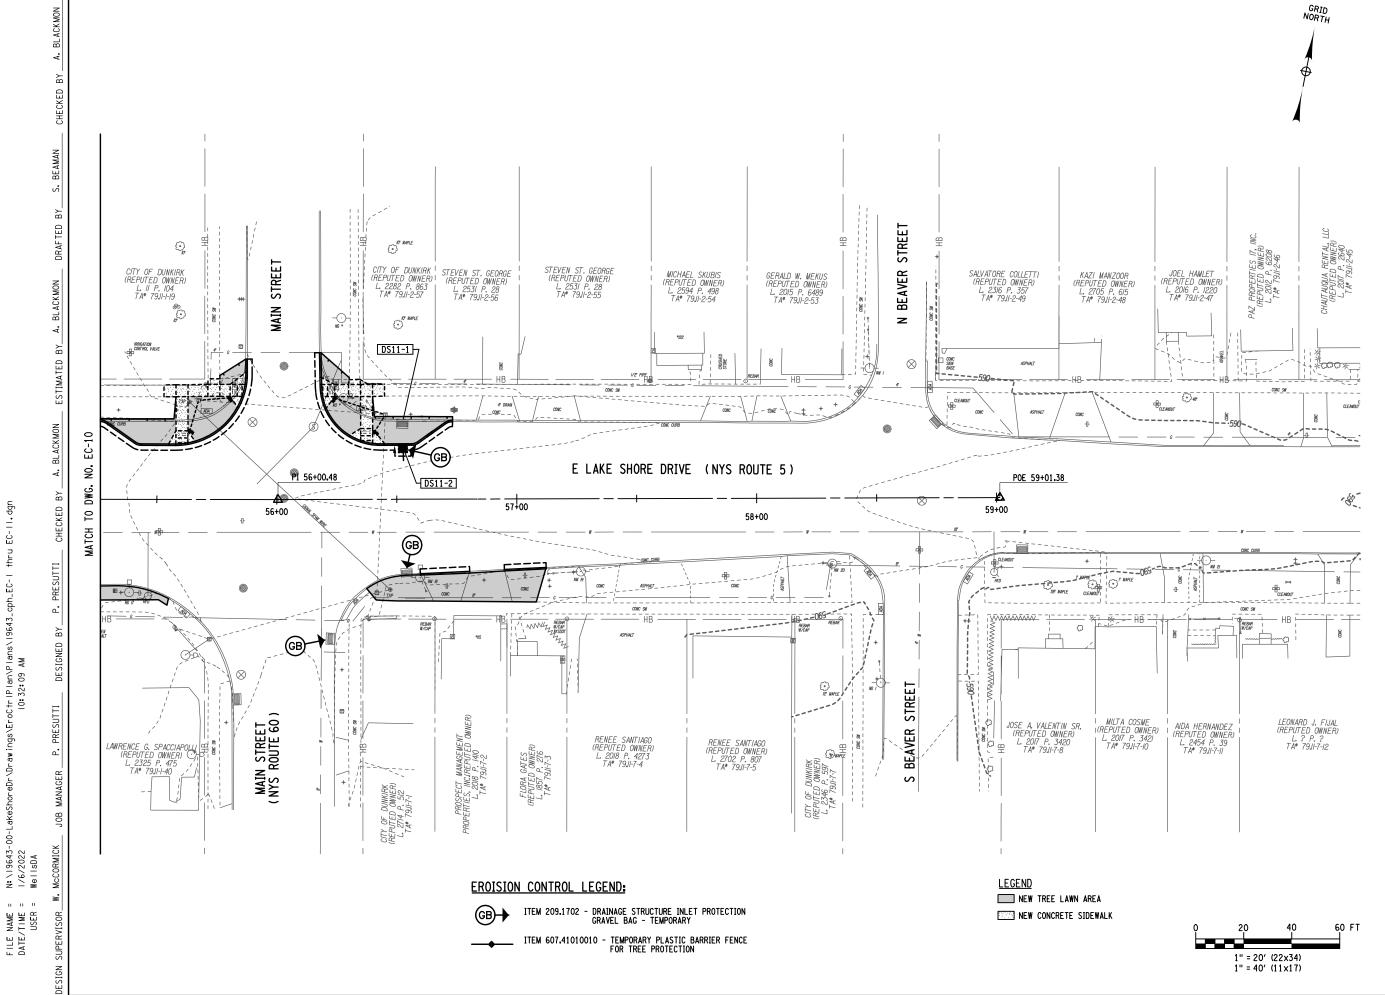


PROJECT NAME

LAKE SHORE DRIVE

DRAWING TITLE

SCALE	DATE
1" = 40'	DECEMBER 2021
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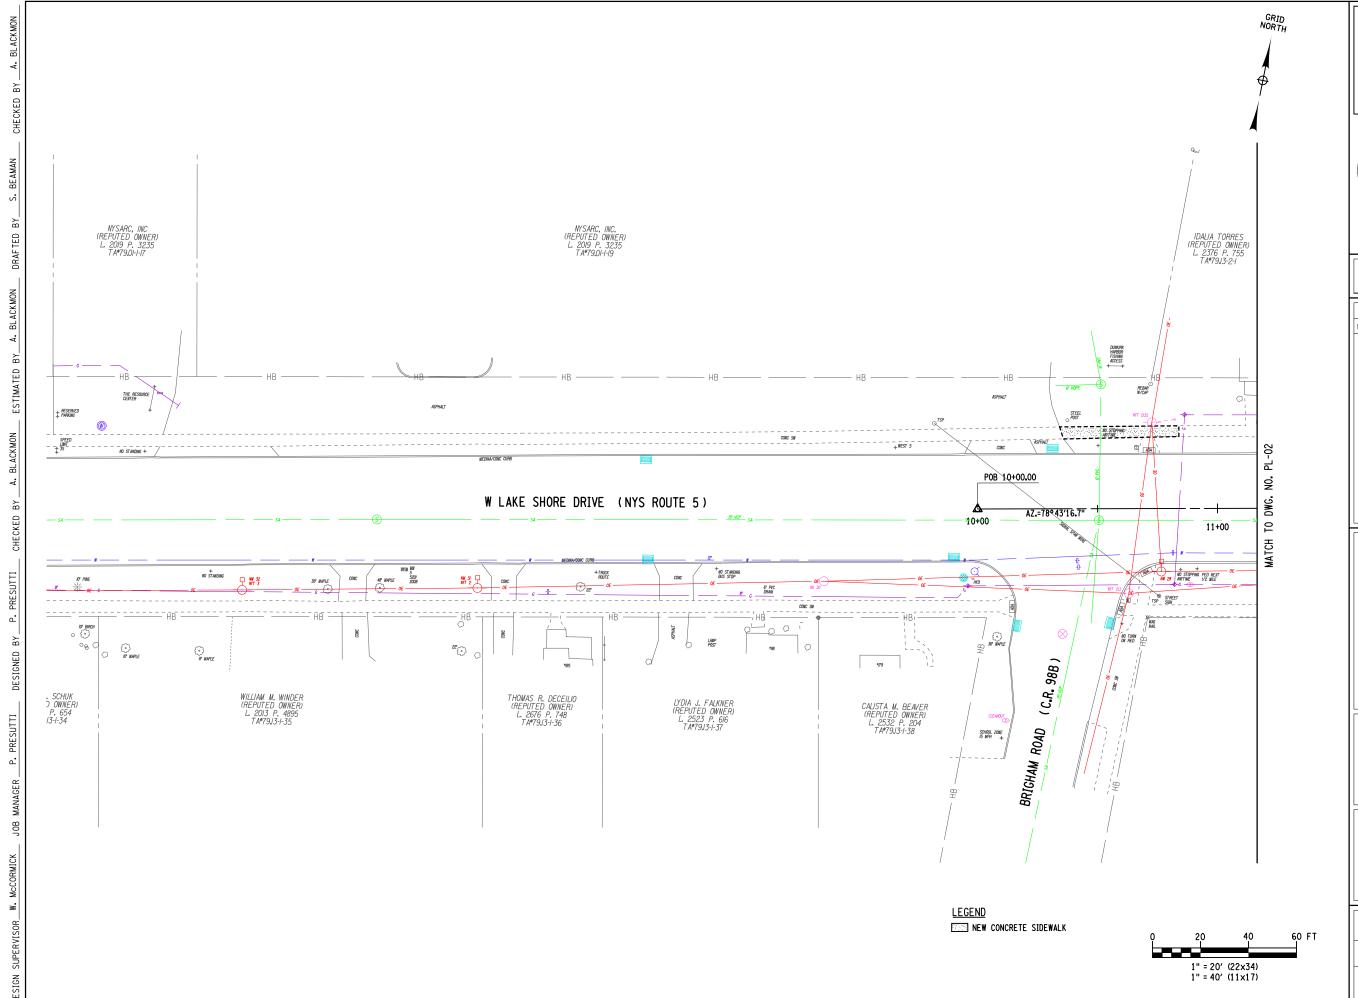


PROJECT NAME

LAKE SHORE DRIVE

DRAWING TITLE

SCALE	DATE
1" = 40'	DECEMBER 2021
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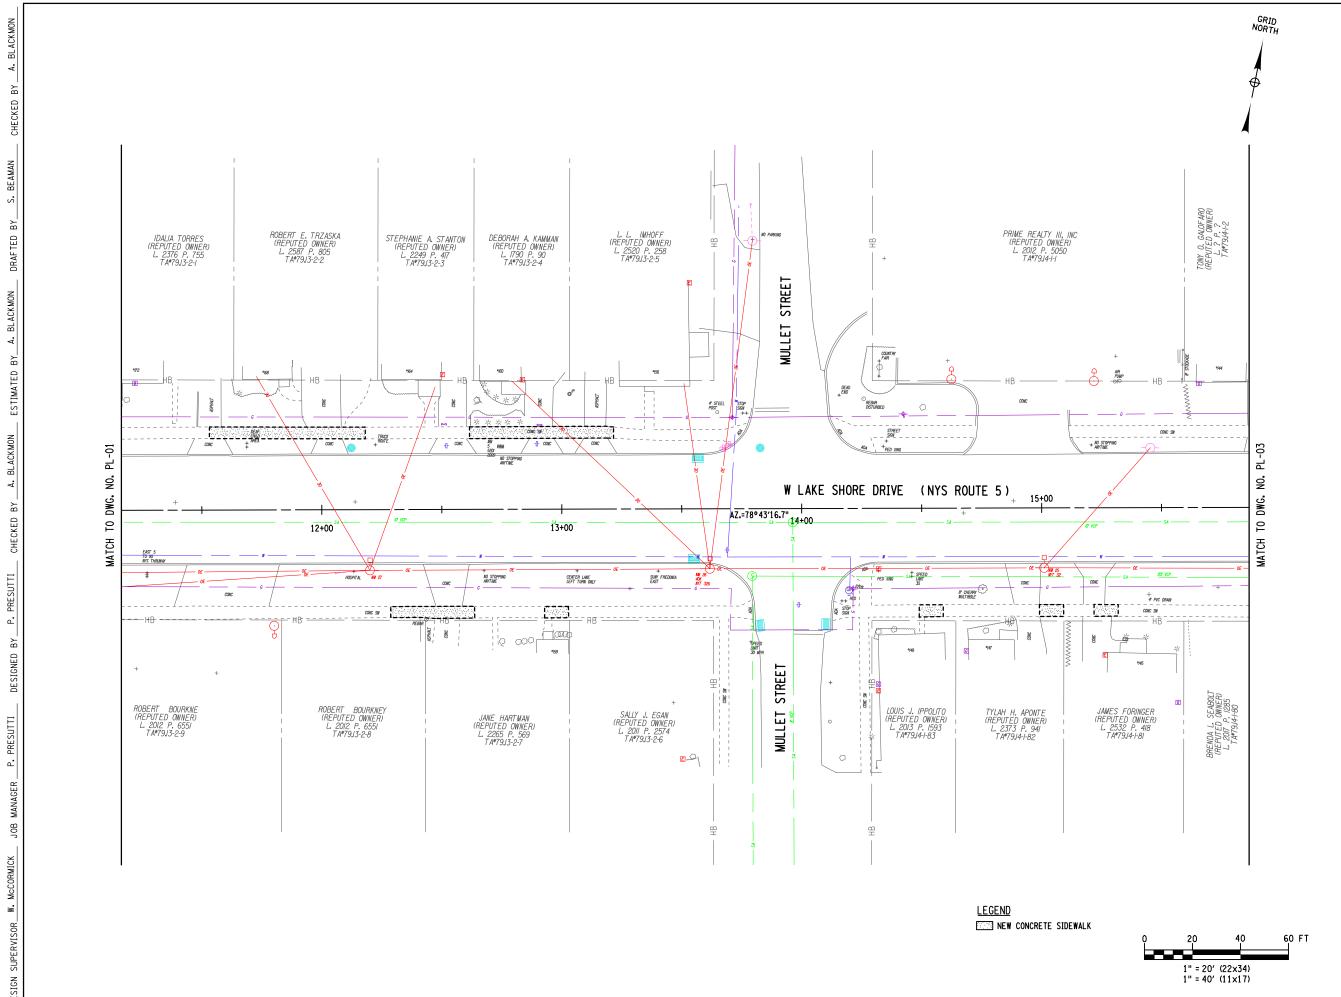


PROJECT NAME

LAKE SHORE DRIVE

DRAWING TITLE

scale 1" = 40'	DECEMBER 2021
P.I.N. 5763.53	FEDERAL AID PROJECT NO.
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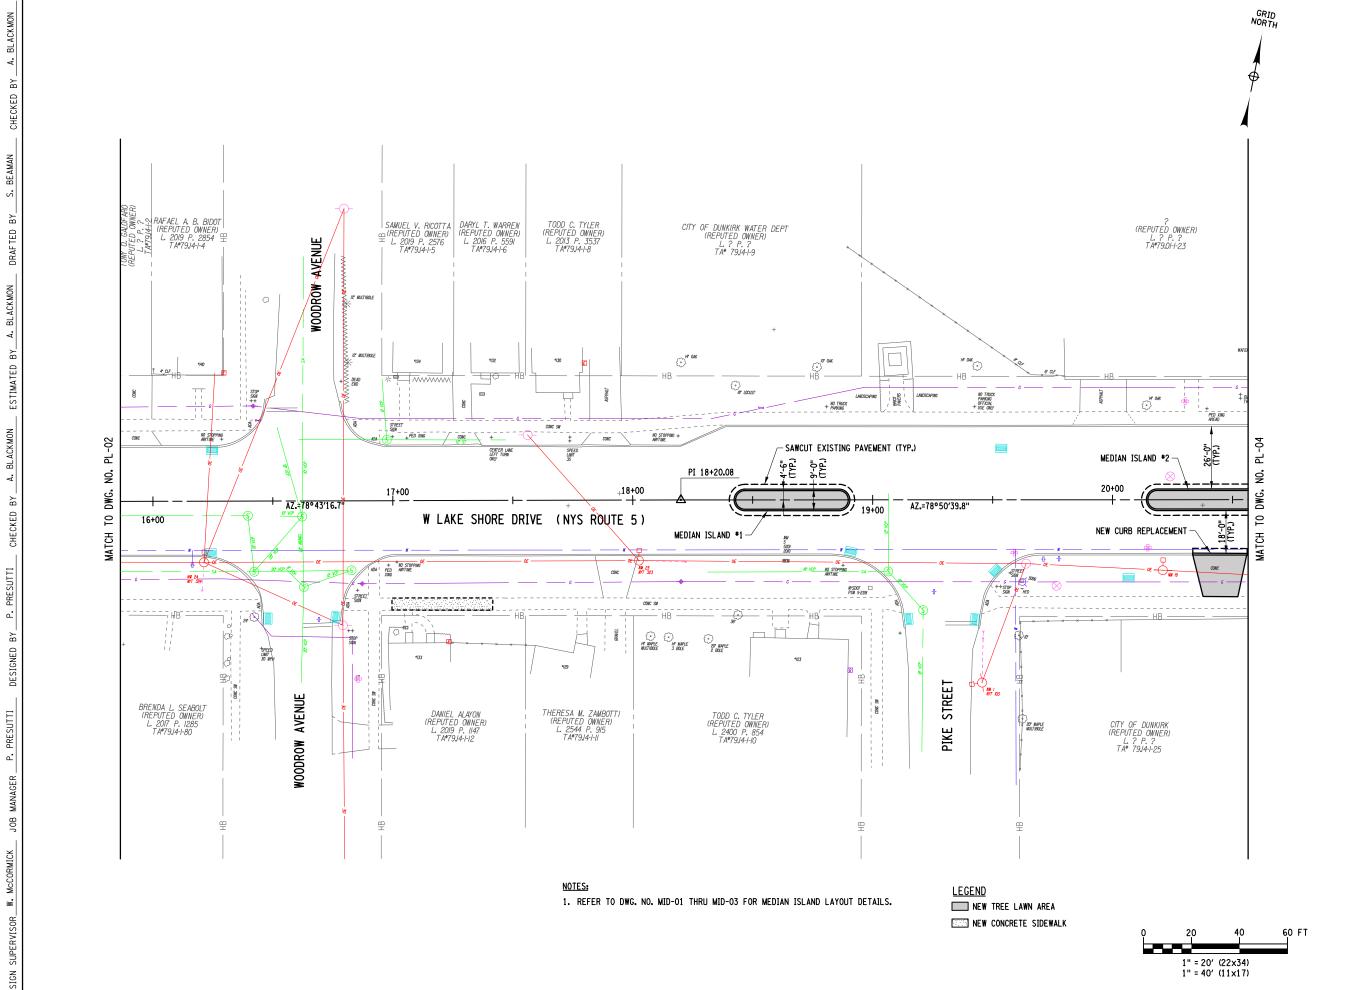


PROJECT NAME

LAKE SHORE DRIVE

DRAWING TITLE

SCALE 1" = 40'	DECEMBER 2021
P.I.N.	FEDERAL AID PROJECT NO.
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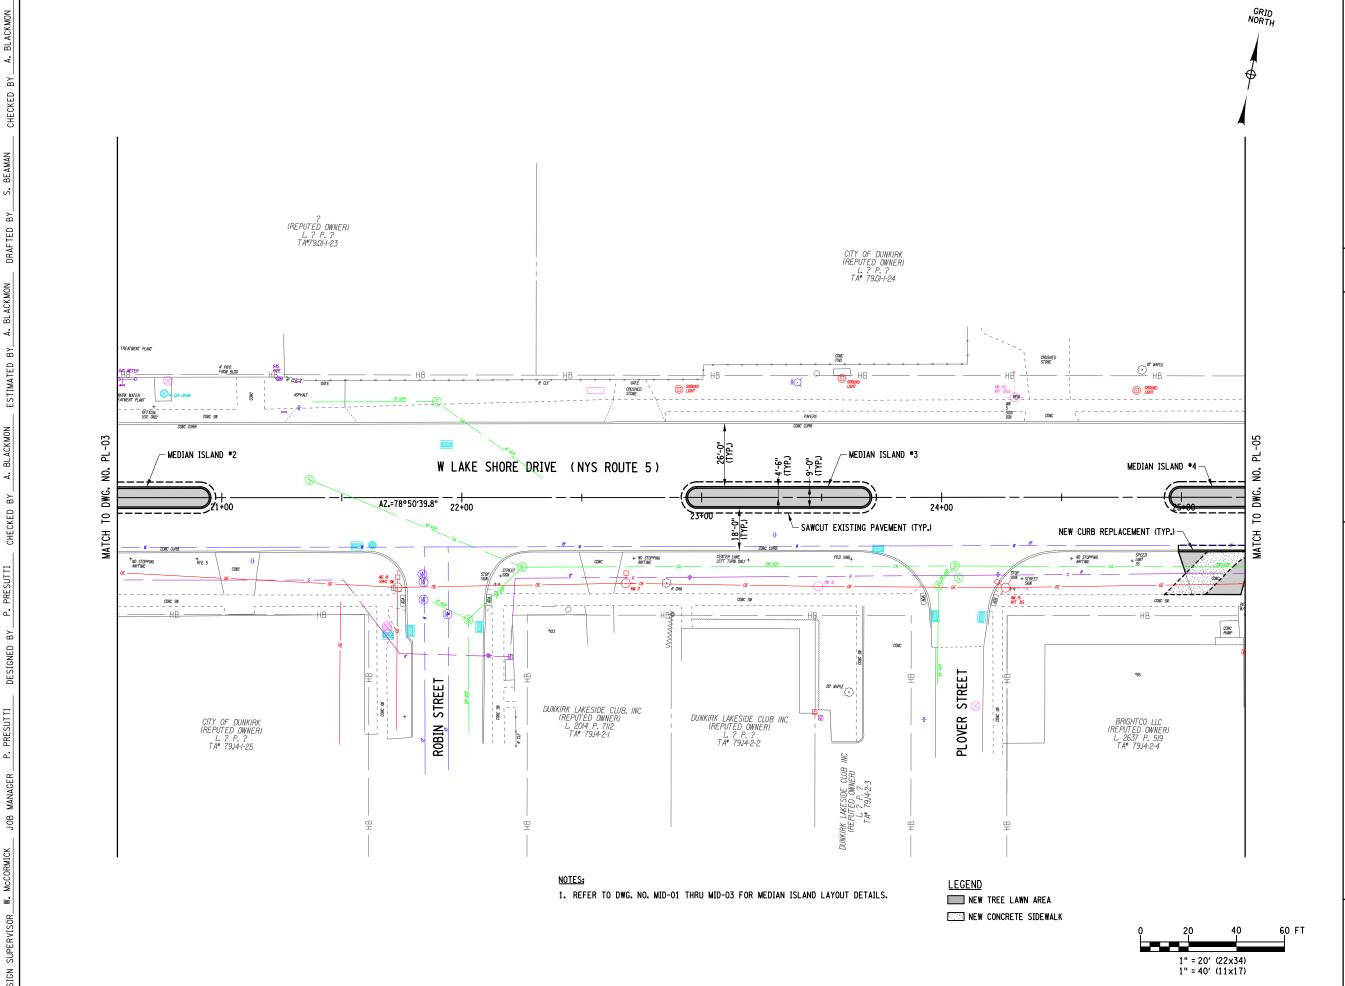


PROJECT NAME

LAKE SHORE DRIVE

DRAWING TITLE

scale 1" = 40'	DECEMBER 2021
p.i.n. 5763.53	FEDERAL AID PROJECT NO.
SHEET NO.	DRAWING NO.
50 of 94	PL-03



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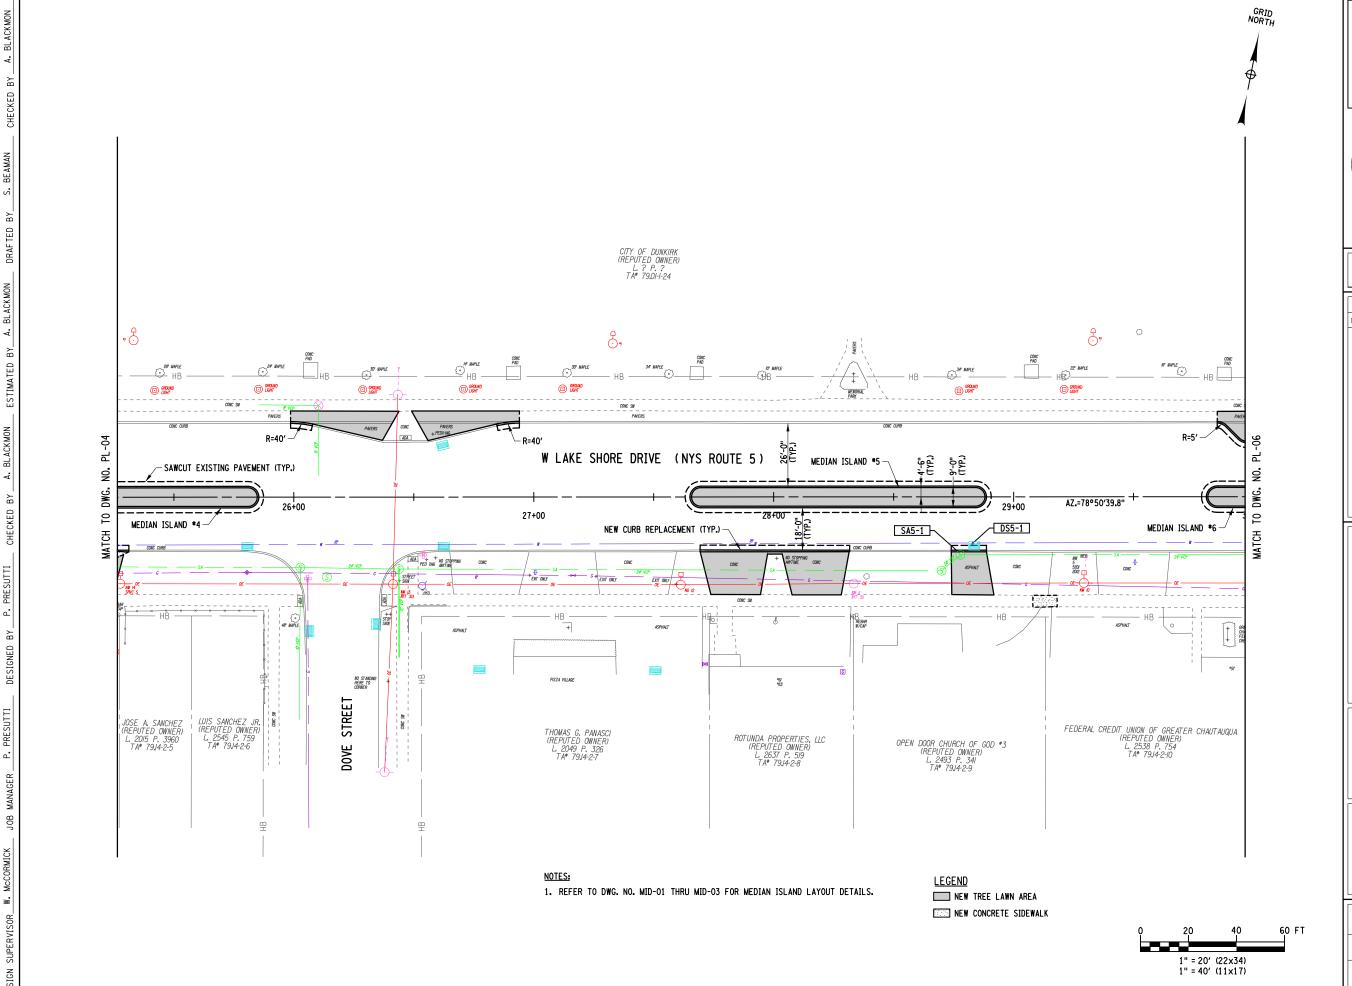


PROJECT NAME

LAKE SHORE DRIVE

DRAWING TITLE

SCALE	DATE
1" = 40'	DECEMBER 2021
P.I.N. 5763.53	FEDERAL AID PROJECT NO.
SHEET NO.	DRAWING NO.
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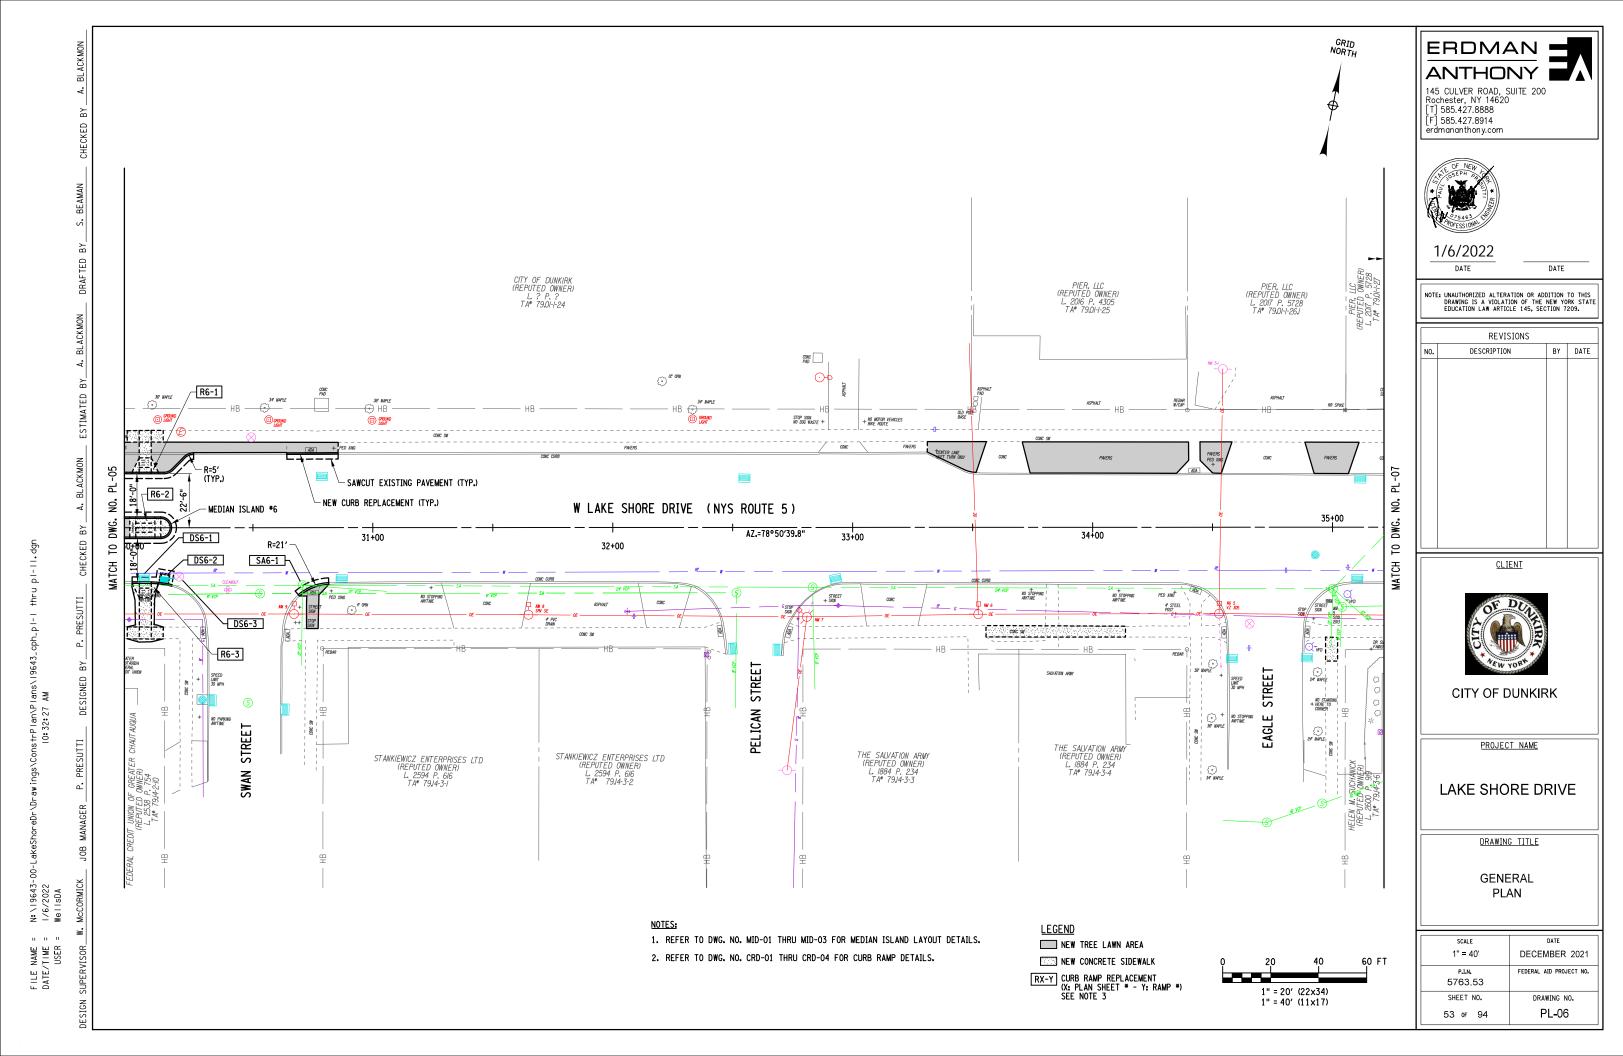



PROJECT NAME

LAKE SHORE DRIVE

DRAWING TITLE

SCALE	DATE
1" = 40'	DECEMBER 2021
P.I.N.	FEDERAL AID PROJECT NO.
5763.53	
SHEET NO.	DRAWING NO.
52 of 94	PL-05



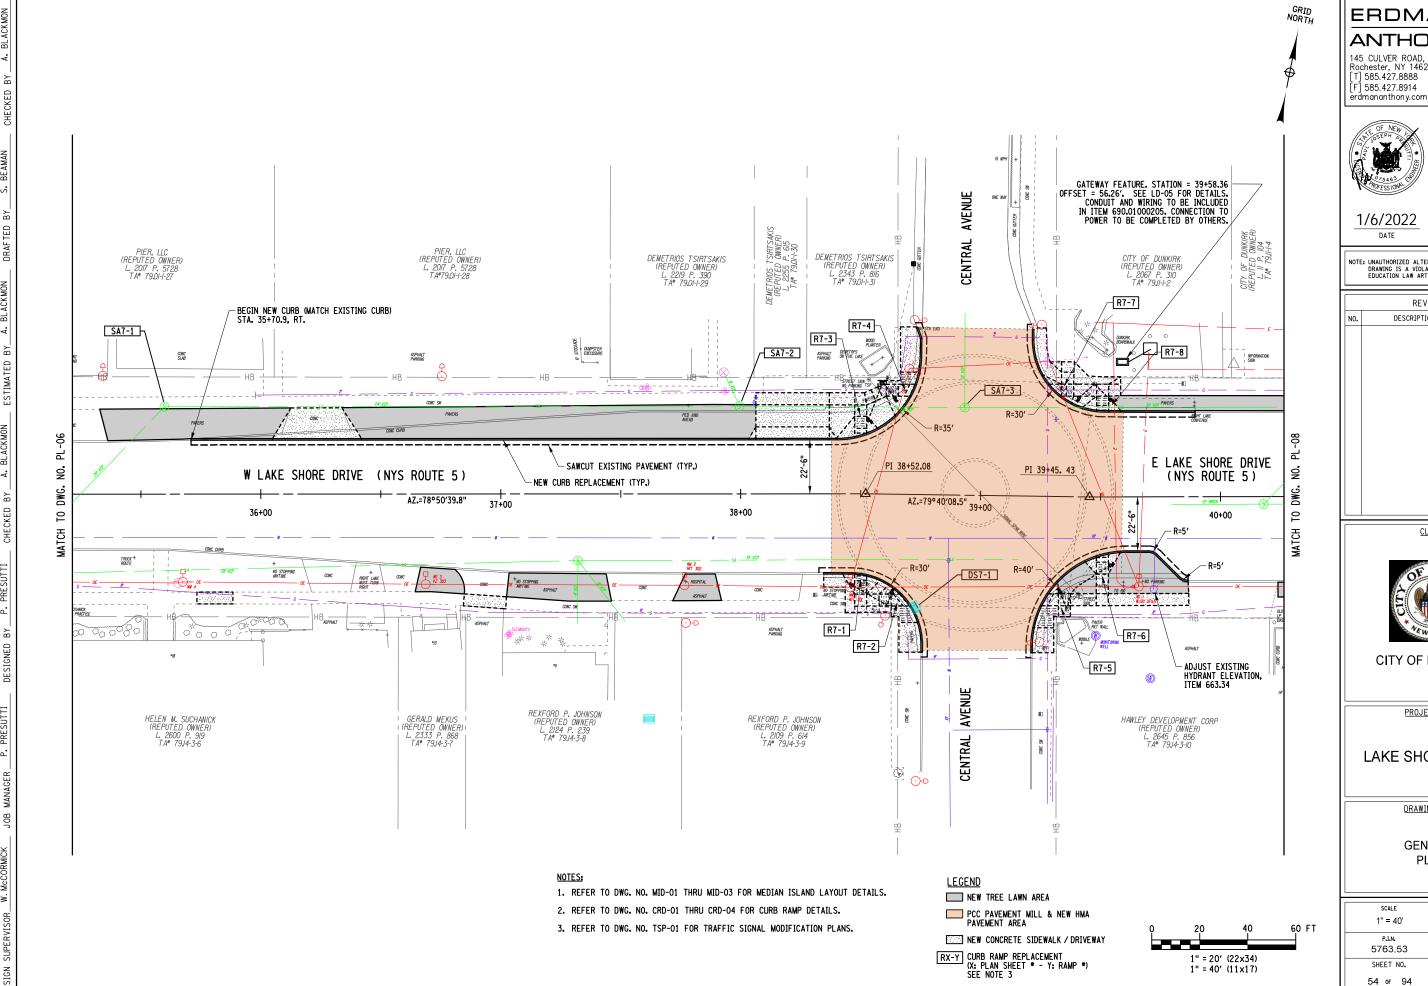

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	REVISIONS		
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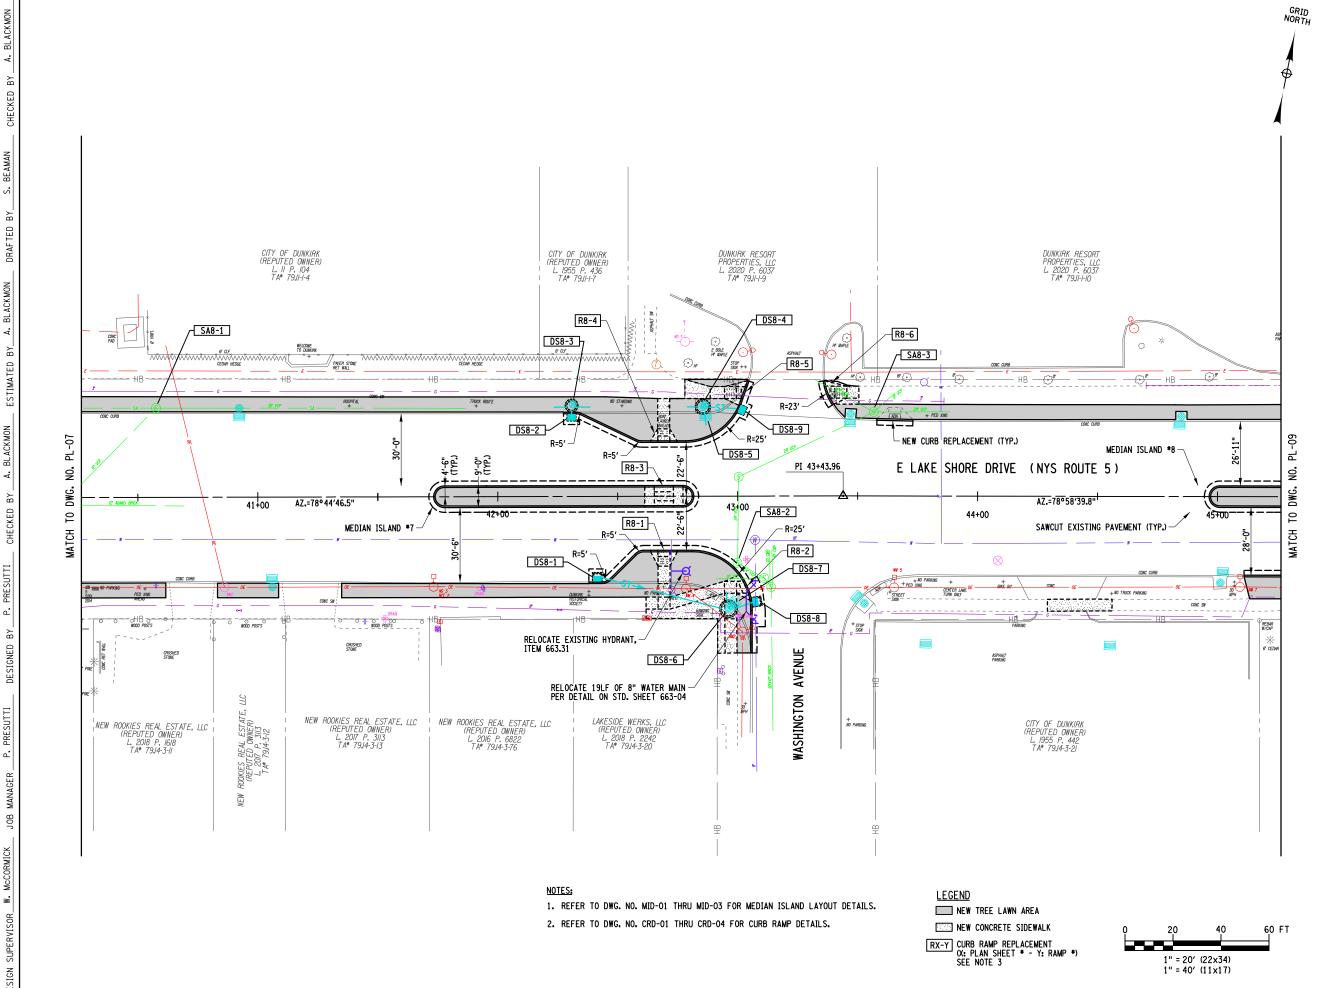


PROJECT NAME

LAKE SHORE DRIVE

DRAWING TITLE

SCALE	DATE
1" = 40'	DECEMBER 2021
P.I.N.	FEDERAL AID PROJECT NO.
5763.53	
SHEET NO.	DRAWING NO.
54 of 94	PL-07



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ANTHONY

145 CULVER ROAD, SUITE 200
Rochester, NY 14620
[T] 585.427.8888



[F] 585.427.8914 erdmananthony.com

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DATE

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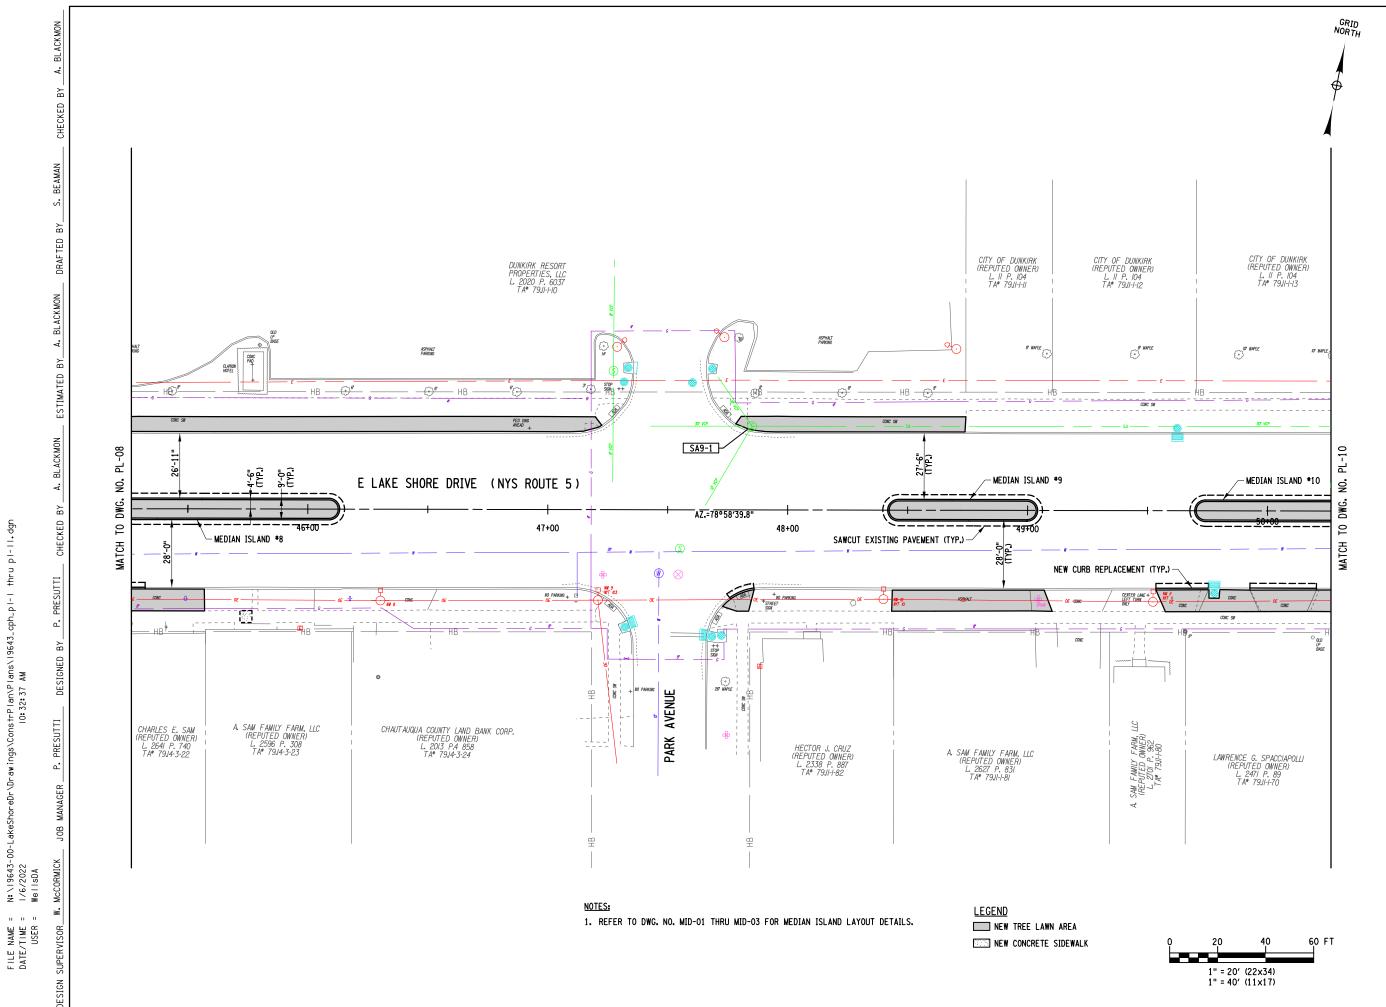


PROJECT NAME

LAKE SHORE DRIVE

DRAWING TITLE

SCALE	DATE
1" = 40'	DECEMBER 2021
P.I.N.	FEDERAL AID PROJECT NO.
5763.53	
SHEET NO.	DRAWING NO.
55 of 94	PL-08



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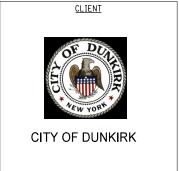


1/6/2022

DATE

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REVISIONS			
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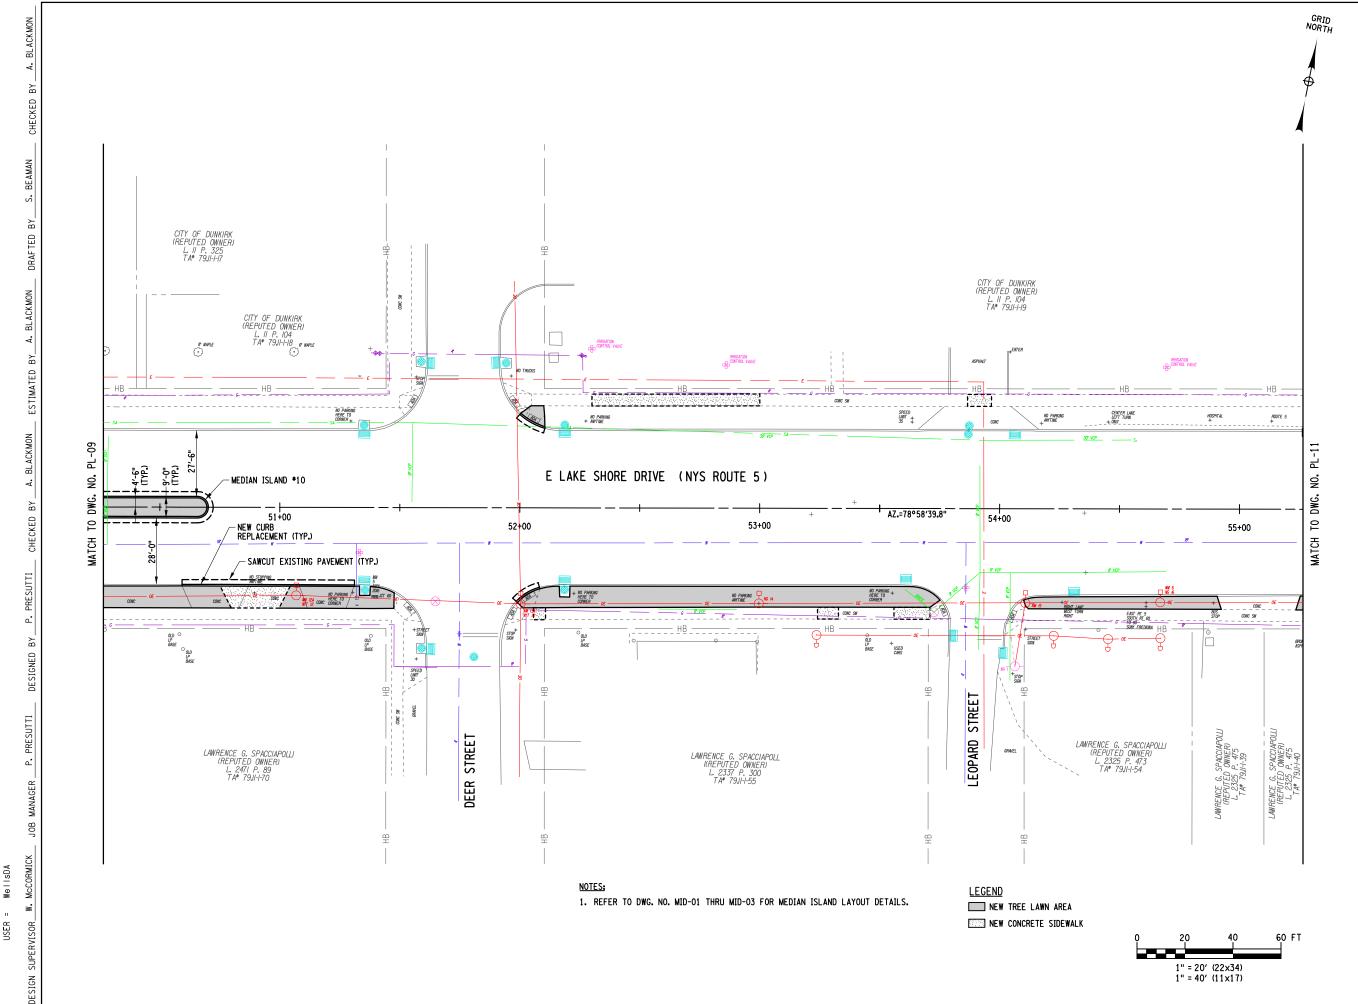


PROJECT NAME

LAKE SHORE DRIVE

DRAWING TITLE

SCALE	DATE
1" = 40'	DECEMBER 2021
P.I.N. 5763.53	FEDERAL AID PROJECT NO.
SHEET NO.	DRAWING NO.
56 or 94	PL-09



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ANTHONY

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Rochester, NY 14620
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1/6/2022

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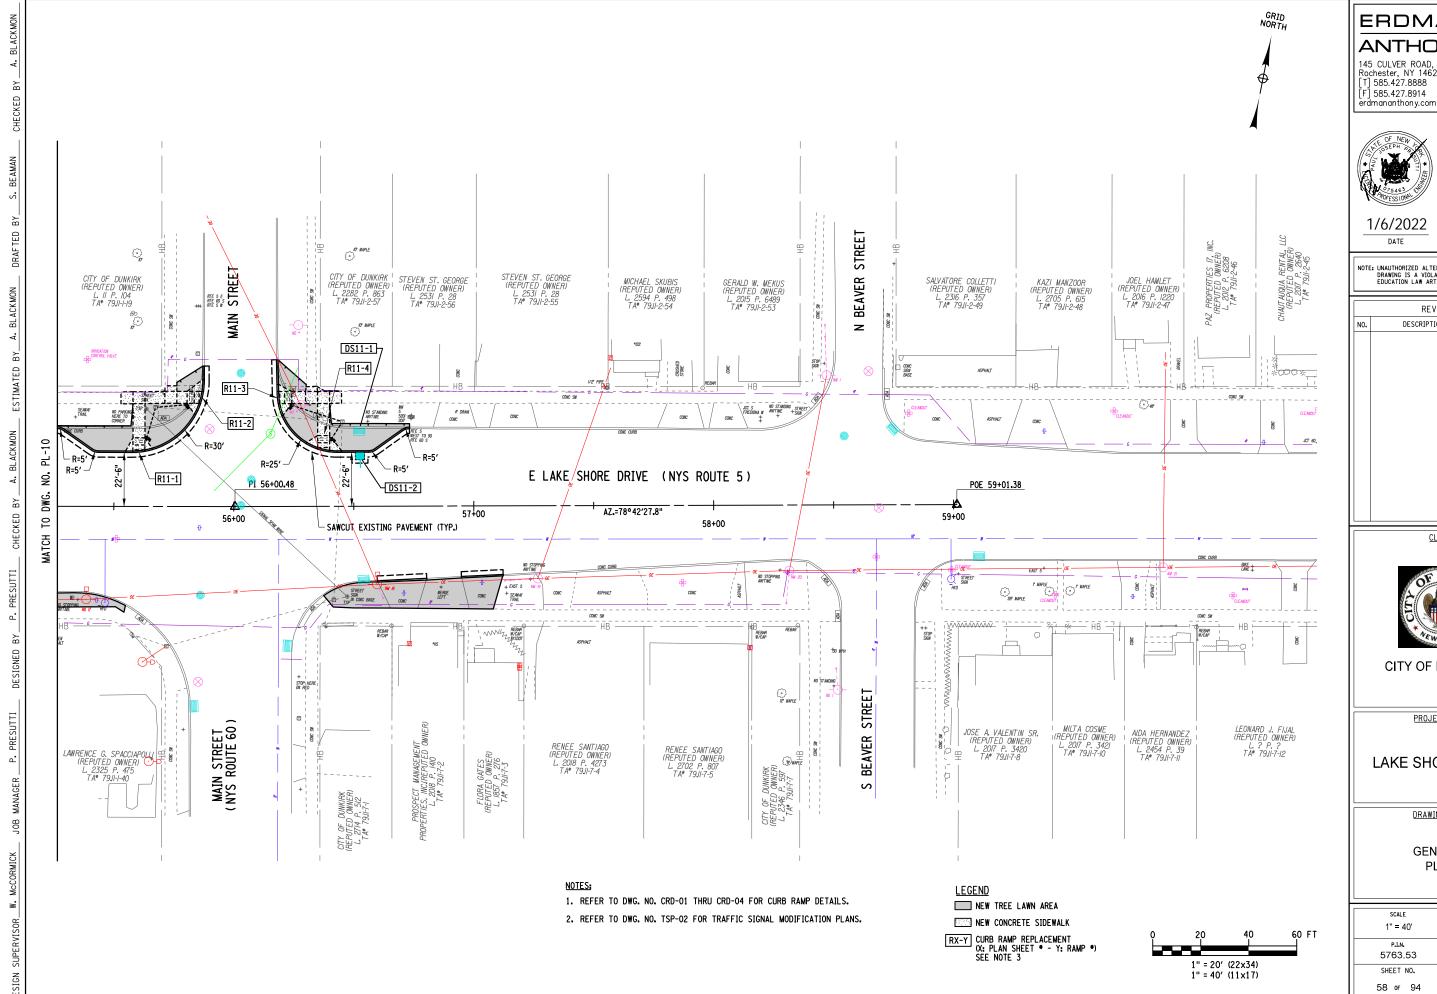


PROJECT NAME

LAKE SHORE DRIVE

DRAWING TITLE

SCALE	DATE
1" = 40'	DECEMBER 2021
p.i.n. 5763.53	FEDERAL AID PROJECT NO.
SHEET NO.	DRAWING NO.
57 of 94	PL-10



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	REVISIONS					
NO.	DESCRIPTION	ВҮ	DATE			



PROJECT NAME

LAKE SHORE DRIVE

DRAWING TITLE

SCALE	DATE
1" = 40'	DECEMBER 2021
P.I.N.	FEDERAL AID PROJECT NO.
5763.53	
SHEET NO.	DRAWING NO.
58 of 94	PL-11

	TABLE OF QUANTITIES				
ITEM	DESCRIPTION	UNIT	QUANTITY		
206.03010010	CONDUIT EXCAVATION AND BACKFILL (RESTORING TOP SURFACE NOT INCLUDED)	LF	115		
619.1611	MAINTAIN TRAFFIC SIGNAL EQUIPMENT (REQUIREMENT A)	INTM	8		
680.01970210	PAINT GALVANIZED EXISTING TRAFFIC SIGNAL POLE (ALL SIZES)	EA	2		
680.5001	POLE EXCAVATION AND CONCRETE FOUNDATION	CY	5		
680.50500005	REMOVE POLE FOUNDATIONS	LF	4		
680.51000010	ALTER ELEVATION OF PULLBOXES	EA	4		
680.510301	PULLBOX-CIRCULAR, 24 INCH DIAMETER, REINFORCED CONCRETE	EA	2		
680.520706	TRAFFIC SIGNAL CONDUIT, RIGID PLASTIC, CLASS 1 OR 2, 2"	LF	103		
680.53080305	CONDUIT, FLEXIBLE, LIQUID TIGHT NON METALLIC, 1"	LF	11		
680.54	INDUCTANCE LOOP INSTALLATION	LF	204		
680.72	INDUCTANCE LOOP WIRE	LF	581		
680.730514	SIGNAL CABLE 5 CONDUCTORS, 14 AWG	LF	1129		
680.6710	TRAFFIC SIGNAL POLE POST TOP MOUNT, 10 FEET MOUNTING HEIGHT	EA	8		
680.77000105	MODIFY TRAFFIC SIGNAL EQUIPMENT	LS	1		
680.78010005	ALTER PULLBOX FOR CONDUITS	EA	5		
680.78020005	ALTER CONDUIT GROUP FOR PULLBOX	EA	2		
680.81310209	ACCESSIBLE PEDESTRIAN SIGNAL (APS) WITHOUT POLE	EA	8		
680.813105	PEDESTRIAN SIGNAL MODULES - 12 INCH BI-MODAL, HAND/MAN SYMBOLS LED	EA	8		
680.813106	PEDESTRIAN SIGNAL SECTION - POLYCARBONATE, TYPE I, 12 INCH	EA	16		
680.8142	PEDESTRIAN SIGNAL POST TOP MOUNT ASSEMBLY	EA	8		
680.81500010	PEDESTRIAN COUNT-DOWN TIMER MODULE	EA	8		

EXISTING LOOPS TO REMAIN-UNLESS OTHERWISE (TYP.) 680.5001 680.6710 REPLACE PULLBOX & ALTER PULLBOX FOR CONDUIT 680,510301 680.8142 680.730514 680.81310209 680.51000010 206.03010010 680.520706 680.730514 PAINT EXISTING TRAFFIC SIGNAL POLE 680.01970210 206.03010010 680.6708 680.8142 680.5001 680.520706 680.730514 680-6710 680.730514 680.81310209 680.8142 680.730514 680.81310209 680.78010005 - 680.53080305 680,5001 206.03010010 680.6710 06.03010010 680.520706 680.730514 680.8142 680.730514 680.81310209 W LAKE SHORE DRIVE 20' 206.03010010 680.520706 680.730514 LAKE≃SHORE DRIVE 26' 206.03010010 39+00 680.520706 680.54 680.72 680.54 680.72 680.730514 680.5001 206.03010010 680.520706 680.6710 680.8142 680.730514 680.81310209 680,5001 680.6710 680,8142 680.5001 680.6710 680.8142 680.81310209 26' 206.03010010 680.520706 680.730514 680.730514 680.81310209 AVENU 680.51000010 PAINT EXISTING TRAFFIC SIGNAL POLE 680.01970210 206.03010010 680.520706 680.730514 - 680.51000010 680,6710 680.8142 680.730514 680.81310209

TRAFFIC SIGNAL PLAN


NO. PHASE WIRED NO. TURNS SIZE FUNCTION		LOOP TABLE						
24 1 DIRECT 2.4.2 6V20 LEET TURN ERO		PHASE	WIRED		SIZE	FUNCTION		
24 1 DIRECT 2-4-2 6/20 LEFTTORN FRO	24	1	DIRECT	2-4-2	6X20	LEFT TURN FRONT		
25 1 DIRECT 3 6X20 LEFT TURN BAC	25	1	DIRECT	3	6X20	LEFT TURN BACK		

1. THE CONTRACTOR SHALL VERIFY THE LOCATION AND CONDITION OF THE EXISTING TRAFFIC SIGNAL CONDUITS. ANY ADDITIONAL CONDUIT OR EXCAVATION NECESSARY TO COMPLETE THE PROPOSED WORK SHALL BE APPROVED BY THE ENGINEER. 2. COST OF CUTTING AND/OR REMOVING EXISTING SHIELDED LEAD-IN CABLE AND PEDESTRIAN SIGNAL HEAD CONDUCTOR WIRE TO BE INCLUDED IN THE NEW CABLE WIRING ITEMS.


- 3. UNDER ITEM 680.77000105, THE EXISTING PEDESTRIAN SIGNAL POLES AND HEADS SHALL BE REUSED AND RELOCATED AS DESIGNATED ON THE PLAN. 4. UNDER ITEM 680.50500005, THE CONTRACTOR SHALL REMOVE EXISTING PEDESTRIAN POLE FOUNDATION TO A MINIMUM OF 2 FEET BELOW FINISHED GRADE.
- 5. EXISTING PULLBOXES TO REMAIN SHALL BE CLEANED OF DIRT AND DEBRIS. COST INCLUDED

IN THE BID PRICE OF THE VARIOUS SIGNAL ITEMS.


6. APS BUTTONS SHALL BE CHECKED FOR CORRECT VOICES AND REFLECT REGION 5 DEFAULT SETTINGS BY NYSDOT CONSTRUCTION INSPECTOR, CONTRACTOR, OR CONSTRUCTION EIC.

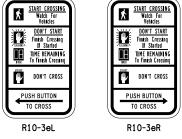




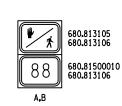

EXISTING/PROPOSED PEDESTRIAN SIGNAL HEADS

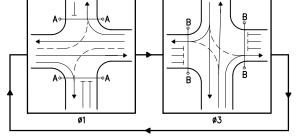

PREFERENTIAL PHASING SEQUENCE

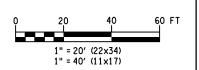





1/6/2022 DATE

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DATE

	REVISIONS					
NO.	DESCRIPTION	BY	DATE			

CLIENT



CITY OF DUNKIRK

PROJECT NAME

LAKE SHORE DRIVE

DRAWING TITLE

TRAFFIC SIGNAL PLAN


LAKE SHORE DRIVE @ CENTRAL AVENUE

SCALE	DATE
1" = 40'	DECEMBER 2021
P.I.N. 5763.53	FEDERAL AID PROJECT NO.
SHEET NO.	DRAWING NO.
59 of 94	TSP-01

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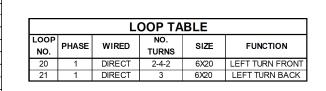
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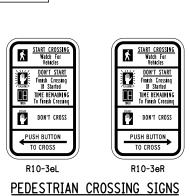
POLE LAYOUT AND CABLE WIRING DIAGRAM

TABLE OF QUANTITIES			
ITEM	DESCRIPTION	UNIT	QUANTITY
206.03010010	CONDUIT EXCAVATION AND BACKFILL (RESTORING TOP SURFACE NOT INCLUDED)	LF	80
619.1611	MAINTAIN TRAFFIC SIGNAL EQUIPMENT (REQUIREMENT A)	INTM	8
680.01970210	PAINT GALVANIZED EXISTING TRAFFIC SIGNAL POLE (ALL SIZES)	EA	2
680.5001	POLE EXCAVATION AND CONCRETE FOUNDATION	CY	3
680.50500005	REMOVE POLE FOUNDATIONS	LF	4
680.51000010	ALTER ELEVATION OF PULL BOXES	EA	4
680.520706	TRAFFIC SIGNAL CONDUIT, RIGID PLASTIC, CLASS 1 OR 2, 2"	LF	54
680.53080305	CONDUIT, FLEXBLE, LIQUID TIGHT NON METALLIC, 1"	LF	25
680.54	INDUCTANCE LOOP INSTALLATION	LF	188
680.72	INDUCTANCE LOOP WIRE	LF	614
680.730514	SIGNAL CABLE 5 CONDUCTORS, 14 AWG	LF	660
680.6710	TRAFFIC SIGNAL POLE POST TOP MOUNT, 10 FEET MOUNTING HEIGHT	EA	4
680.77000105	MODIFY TRAFFIC SIGNAL EQUIPMENT	LS	1
680.78010005	ALTER PULLBOX FOR CONDUITS	EA	2
680.81310209	ACCESSIBLE PEDESTRIAN SIGNAL (APS) WITHOUT POLE	EA	4
680.813105	PEDESTRIAN SIGNAL MODULE - 12 INCH BI-MODAL, HAND/MAN SYMBOLS LED	EA	4
680.813106	PEDESTRIAN SIGNAL SECTION - POLYCARBONATE, TYPE I, 12 INCH	EA	8
680.8142	PEDESTRIAN SIGNAL POST TOP MOUNT ASSEMBLY	EA	4
680.81500010	PEDESTRIAN COUNT-DOWN TIMER MODULE	EA	4

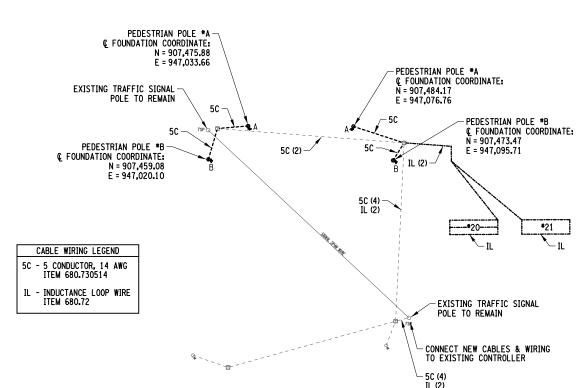

NOTESE CONTRACTOR SHALL VERIFY THE LOCATION AND CONDITION OF THE EXISTING TRAFFIC SIGNAL CONDUITS. ANY ADDITIONAL CONDUIT OR EXCAVATION NECESSARY TO COMPLETE THE PROPOSED WORK SHALL BE APPROVED BY THE ENGINEER.

- COST OF CUTTING AND/OR REMOVING EXISTING SHIELDED LEAD-IN CABLE AND PEDESTRIAN SIGNAL HEAD CONDUCTOR WIRE TO BE INCLUDED IN THE NEW CABLE WIRING ITEMS.
- 3. UNDER ITEM 680.77000105, THE EXISTING PEDESTRIAN SIGNAL POLES AND HEADS SHALL BE REUSED AND RELOCATED AS DESIGNATED ON THE PLAN.
- 4. UNDER ITEM 680.50500005, THE CONTRACTOR SHALL REMOVE EXISTING PEDESTRIAN POLE FOUNDATION TO A MINIMUM OF 2 FEET BELOW FINISHED GRADE.
- 5. EXISTING PULLBOXES TO REMAIN SHALL BE CLEANED OF DIRT AND DEBRIS. COST INCLUDED IN THE BID PRICE OF THE VARIOUS SIGNAL ITEMS.
- 6. APS BUTTONS SHALL BE CHECKED FOR CORRECT VOICES AND REFLECT REGION 5 DEFAULT SETTINGS BY NYSDOT CONSTRUCTION INSPECTOR, CONTRACTOR, OR CONSTRUCTION EIC.





680,5001

680.6710 680.8142 680.730514

680.81310209

206.03010010 680.520706

680.730514

680.51000010 680.78010005


206.03010010 680.520706 680.730514

PAINT EXISTING TRAFFIC SIGNAL POLE | ITEM 680.01970210

55+00

680.51000010 -

EXISTING/PROPOSED
PEDESTRIAN SIGNAL HEADS

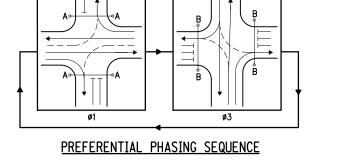

- EXISTING LOOPS TO REMAIN UNLESS OTHERWISE (TYP.)

STREET

206.03010010 680.520706 680.730514

56+00

STREE.

MAIN

TRAFFIC SIGNAL PLAN
1" = 40'

680.5001 680.6710

680.8142 680.730514 680.81310209

WAIN NAIN

680.6710 680.8142

680.730514 680.81310209

> 21' 206.03010010 680.520706 680.730514

> > 680.51000010 680.78010005

> > > 680.5001 680.6710 680.8142 680.730514 680.81310209

- 680.53080305

680.54 680.72

| PAINT EXISTING TRAFFIC SIGNAL POLE | ITEM 680.01970210

680.51000010

E LAKE SHORE DRIVE

680.54 680.72







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DATE

REVISIONS				
NO.	DESCRIPTION	BY	DATE	

CLIENT



CITY OF DUNKIRK

PROJECT NAME

LAKE SHORE DRIVE

DRAWING TITLE

TRAFFIC SIGNAL PLAN

E. LAKE SHORE DRIVE @ MAIN STREET

SCALE	DATE	
1" = 40'	DECEMBER 2021	
P.I.N.	FEDERAL AID PROJECT NO.	
5763.53		
SHEET NO.	DRAWING NO.	
60 of 94	TSP-02	

LANDSCAPE NOTES

TOPSOIL PLACEMENT

- ONE TYPE OF TOPSOIL IS SPECIFIED FOR TURF AREAS: ITEM 610.1402 TOPSOIL- ROADSIDE.
- UNLESS NOTED OTHERWISE, THE REQUIRED FINISHED DEPTH OF TOPSOIL FOR ALL DISTURBED AREAS IS A MIN. OF 4 INCHES
- THE CONTRACTOR SHALL ACCOUNT FOR THE 25% SETTLING OF TOPSOIL DURING PLACEMENT.

TURF ESTABLISHMENT

- ONE TURF ESTABLISHMENT ITEM NUMBER IS SPECIFIED FOR THIS PROJECT
- ALL DISTURBED AREAS SHALL BE REVEGETATED PER, ITEM 610.1602 TURF ESTABLISHMENT, LAWNS
- MULCH (INCLUDED IN ITEM 610.1602) SHALL BE STRAW IN ACCORDANCE WITH SECTION 713-19.
- MULCH ANCHORAGE (INCLUDED IN ITEM 610.1602) SHALL BE IN ACCORDANCE WITH ITEM 209.2101 SOIL STABILIZERS, CLASS IV TYPE A AND SHALL BE APPLIED OVER STRAW.
- THE ACCEPTANCE STANDARD FOR ITEM 610.1602 TURF ESTABLISHMENT LAWNS SHALL BE IN ACCORDANCE WITH SECTION 610-3.03.
- THE CONTRACTOR SHALL REPEAT THE WORK OF SECTIONS 610-3.03 & 209-3.08B AT NO ADDITIONAL COST TO THE CITY IF AN ACCEPTABLE STAND OF TURF HAS NOT BEEN PRODUCED IN ANY SEEDED AREA WITHIN 4 WEEKS OF SEEDING, OR BY APRIL 30 FOR DORMANT SEEDING. DORMANT SEEDING OCCURS BETWEEN SEPTEMBER 16
- 7. THE PAY ITEMS FOR WATERING AND MOWING HAVE BEEN SPECIFIED FOR ALL TURF ESTABLISHMENT

MOWING

- ALL TURF ESTABLISHMENT AREAS SHALL BE MOWN UNDER ITEM 610.21.
- 2. ONE MOWING HAS BEEN SPECIFIED. MOWING SHALL OCCUR BEFORE ACCEPTANCE OF TURF ESTABLISHMENT

WEED REMOVAL

- 1. ALL TURF ESTABLISHMENT AREAS SHALL BE WEEDED UNDER ITEM 610.13 & IN ACCORDANCE WITH SECTION
- 2. WEED REMOVAL FOR TREE & SHRUB PLANTING PITS SHALL BE PAID UNDER POSTPLANTING CARE.

PLANTING

- REFER TO THE LP DWGS. FOR TREE AND SHRUB PLANTING LOCATIONS.
- REFER TO THE LD DWGS. FOR REQUIRED LANDSCAPE PLANTING DETAILS
- ALL PLANT MATERIALS SHALL BE INSPECTED FOR VARIETY, SIZE AND QUALITY PRIOR TO PLANTING
- PLANTING SOIL SHALL BE TOPSOIL-SPECIAL PLANTING MIX- ITEM 610.1404. EXISTING EXCAVATED SOIL FROM THE PLANT PIT MAY BE USED AS PART OF THE PLANTING SOIL ONLY AS DIRECTED BY THE LANDSCAPE ARCHITECT. TOPSOIL, -SPECIAL PLANTING MIX - ITEM 610.1404 USED FOR PLANTING SOIL SHALL BE TESTED AND APPROVED FOR USE TWO WEEKS PRIOR TO PLANTING.
- MULCH TYPE A, (INCLUDED IN ITEMS 611.0151, 611.0201, 611.0442, AND 611.0751) SEASONED WOOD CHIPS SHALL MEET THE REQUIREMENTS OF SECTION 713-05 AND SHALL BE APPLIED TO THE SURFACE OF PLANT PITS AS INDICATED IN PLANTING DETAILS.
- 6. THE PAY ITEM FOR POST-PLANTING CARE WITH REPLACEMENT HAS BEEN SPECIFIED FOR ALL PLANT MATERIALS.

WATERING VEGETATION

- 1. ALL TURF ESTABLISHMENT AREAS, SHRUBS AND TREES SHALL BE WATERED IN ACCORDANCE WITH SECTION 610-3.10.
- 4 WATERINGS ARE SPECIFIED FOR TURF ESTABLISHMENT AREAS. WATERINGS SHALL OCCUR FOR THE DURATION OF THE CONTRACT.
- 52 WATERINGS ARE SPECIFIED FOR TREES, SHRUBS AND HERBACEOUS PLANTS. WATERINGS SHALL BEGIN UPON ACCEPTANCE OF THE PLANTING AND CONTINUE FOR 26 WEEKS AS PER NYSDOT SPECIFICATIONS. PORTABLE DRIP IRRIGATION SYSTEMS FOR EACH TREE SHALL BE FILLED COMPLETELY TWICE PER WEEK.
- EACH WATERING OF TREES, SHRUBS AND HERBACEOUS PLANTS REQUIRES APPROXIMATELY 3.24 MG OF
- SEE POST PLANTING CARE WITH REPLACEMENT NOTE 4.

POST PLANTING CARE WITH REPLACEMENT

- ALL TREES AND SHRUBS SHALL RECEIVE ITEM 611.190X0024 POST-PLANTING CARE WITH REPLACEMENT.
- POST-PLANTING CARE WITH REPLACEMENT SHALL BEGIN UPON ACCEPTANCE OF THE PLANTING AND CONTINUE FOR ONE YEAR.
- PRIOR TO ANY PLANTING, THE CONTRACTOR SHALL PREPARE AND SUBMIT A POST-PLANTING CARE WORK SCHEDULE FOR APPROVAL.
- PER POST-PLANTING CARE, AT ANY TIME WHEN A TREE OR SHRUB REQUIRES REPLACEMENT, THE PLANT MATERIAL REQUIRING REPLACEMENT SHALL BE REPLACED IN KIND WITHIN THE PLANTING SEASONS LISTED IN THE STANDARD SPECIFICATIONS & POST-PLANTING CARE & WATERING SHALL CONTINUE TO THE END OF THE PERIOD.

Design & Research a better environment P. 315.471.0688



: Unauthorized alteration or addition to this drawing is a violation of the New York State education law article 145, section 7209.

	REVISIONS		
NO.	DESCRIPTION	BY	DATE

CLIENT



CITY OF DUNKIRK


PROJECT NAME

LAKE SHORE DRIVE

DRAWING TITLE

LANDSCAPE DETAILS

SCALE AS SHOWN	DATE JANUARY 2022
P.I.N. 5763.53	FEDERAL AID PROJECT NO.
SHEET NO.	DRAWING NO.
61 or 94	LD - 01

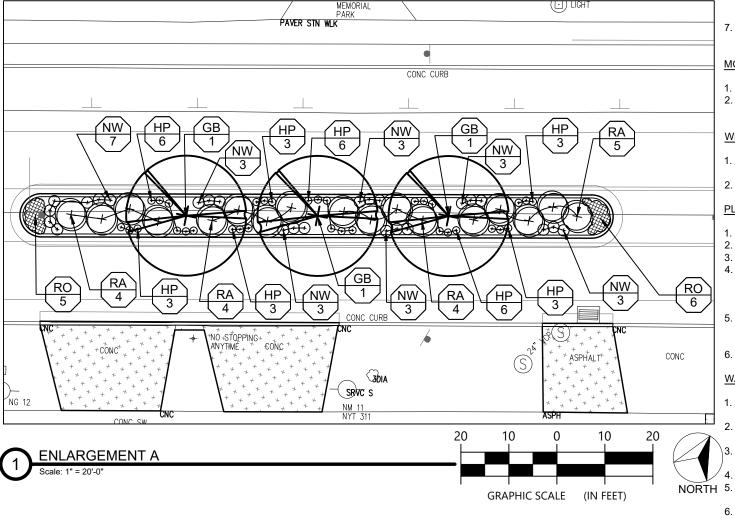

LEGEND:

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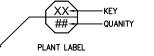
o.

PROPOSED CONCRETE SIDEWALKS AND DRIVEWAYS, ITEM 608.0101 (REFER TO TYPICAL SECTION SHEETS TS-01-TS-03)


PROPOSED TURF ESTABLISHMENT, ITEM 610.1602 (REFER TO TYPICAL SECTION SHEETS TS-01-TS-03)



PROPOSED TREE (REFER TO DWG. LT-01-06 FOR LANDSCAPE TABLES AND SPECIFICATIONS)




REFER TO DWG LT-01-06 FOR LANDSCAPE TABLES OF TREE AND SHRUB PLANTINGS

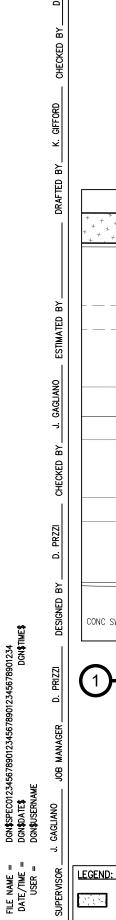

PROPOSED CONCRETE SIDEWALKS AND DRIVEWAYS, ITEM 608.0101 (REFER TO TYPICAL SECTION SHEETS TS-01-TS-03)

PROPOSED TURF ESTABLISHMENT, ITEM 610.1602

(REFER TO TYPICAL SECTION SHEETS TS-01-TS-03)

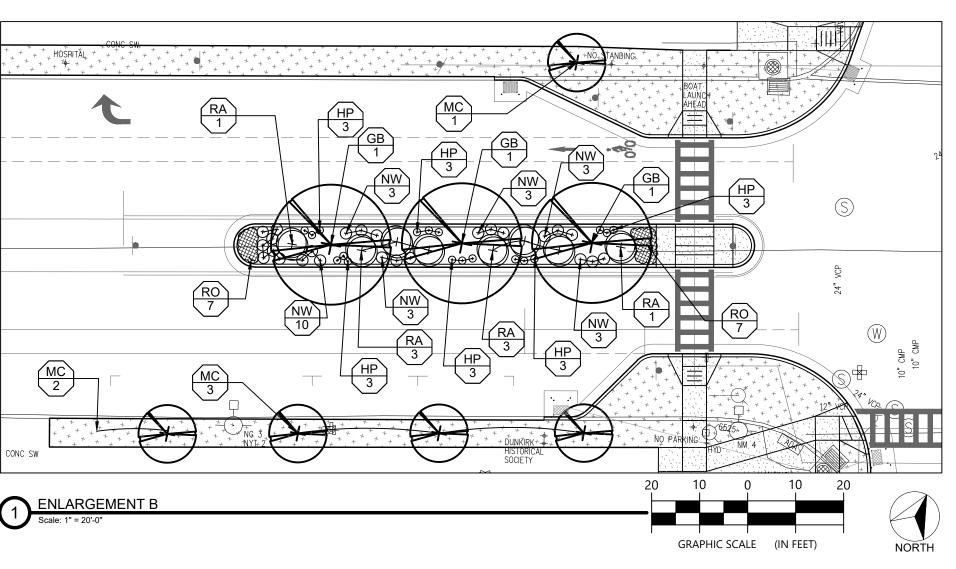

PROPOSED TREE (REFER TO DWG. LT-01-06 FOR LANDSCAPE TABLES AND SPECIFICATIONS)





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CITY OF DUNKIRK

PROJECT NAME

LAKE SHORE DRIVE

DRAWING TITLE

LANDSCAPE DETAILS

SCALE AS SHOWN	DATE JANUARY 2022
P.I.N. 5763.53	FEDERAL AID PROJECT NO.
SHEET NO.	DRAWING NO.
62 o f 94	LD - 02

 NU	<u> 152:</u>

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PLANT LABEL


1. REFER TO DWG LT-01-06 FOR LANDSCAPE TABLES OF TREE AND SHRUB PLANTINGS

LEGEND:

PROPOSED CONCRETE SIDEWALKS AND DRIVEWAYS, ITEM 608.0101 (REFER TO TYPICAL SECTION SHEETS TS-01-TS-03)

PROPOSED TURF ESTABLISHMENT, ITEM 610.1602 (REFER TO TYPICAL SECTION SHEETS TS-01-TS-03)



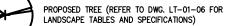

ENLARGEMENT C

30" VCP

NW

HP 3

RA 3

RA 1

NW 4

CONC CURB

HP 5


NW 4

CB 1

+CONC+

 $\binom{\mathsf{CB}}{\mathsf{1}}$

BIKE LN NW

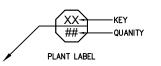

REFER TO DWG LT-01-06 FOR LANDSCAPE TABLES OF TREE AND SHRUB PLANTINGS

 $\frac{\text{HP}}{3}$

RA 3

RO 5

NORTH

NW 3

MC 4

GRAPHIC SCALE (IN FEET)





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	REVISIONS		
NO.	DESCRIPTION	BY	DATE

CLIENT



CITY OF DUNKIRK


PROJECT NAME

LAKE SHORE DRIVE

DRAWING TITLE


LANDSCAPE DETAILS

SCALE AS SHOWN	JANUARY 2022
P.I.N. 5763.53	FEDERAL AID PROJECT NO.
SHEET NO.	DRAWING NO.
63 o f 94	LD - 03

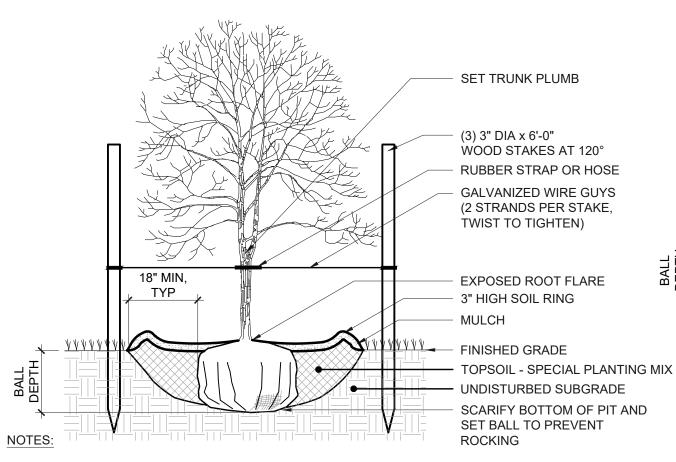

REMOVE BURLAP, ROPE, OR WIRE BASKET FROM TOP 1/3 OF BALL MINIMUM, CUT REMAINING PORTIONS OF ROPE OR WIRE BASKET ONCE PLANT IS IN THE FINAL POSITION IN PIT.

TOP OF ROOT BALL SHALL BE SET FLUSH WITH SURROUNDING FINISHED GRADE.

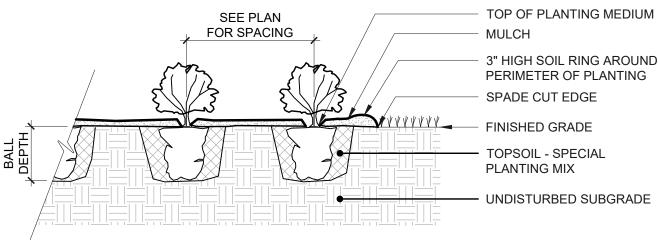


NOTES:

- REMOVE GROWING CONTAINER
- LOOSEN POT BOUND ROOTS
- TOP OF PLANTING MEDIUM SHALL BE SET FLUSH WITH SURROUNDING FINISHED GRADE.
- SET PLANTS PLUMB

PLANTING - HERBACEOUS PLANTS

ITEM NO. 611.0751

ITEM NO. 611.0151 AND ITEM NO. 611.0201

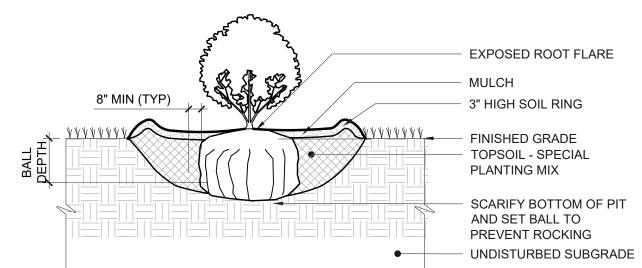

- 1. TOP OF ROOT BALL SHALL BE SET FLUSH WITH SURROUNDING FINISHED GRADE.
- 2. SET PLANTS PLUMB

PLANTING - DECIDUOUS TREE

PLANTING - SHRUB

ITEM NO. 611.0442





DATE

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	REVISIONS		
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NO.	DESCRIPTION	BY	DATE

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CITY OF DUNKIRK

PROJECT NAME


LAKE SHORE DRIVE

DRAWING TITLE

LANDSCAPE DETAILS

SCALE AS SHOWN	DATE JANUARY 2022
P.I.N. 5763.53	FEDERAL AID PROJECT NO.
SHEET NO.	DRAWING NO.
64 o f 94	LD - 04


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REVISIONS			
NO.	DESCRIPTION	BY	DATE

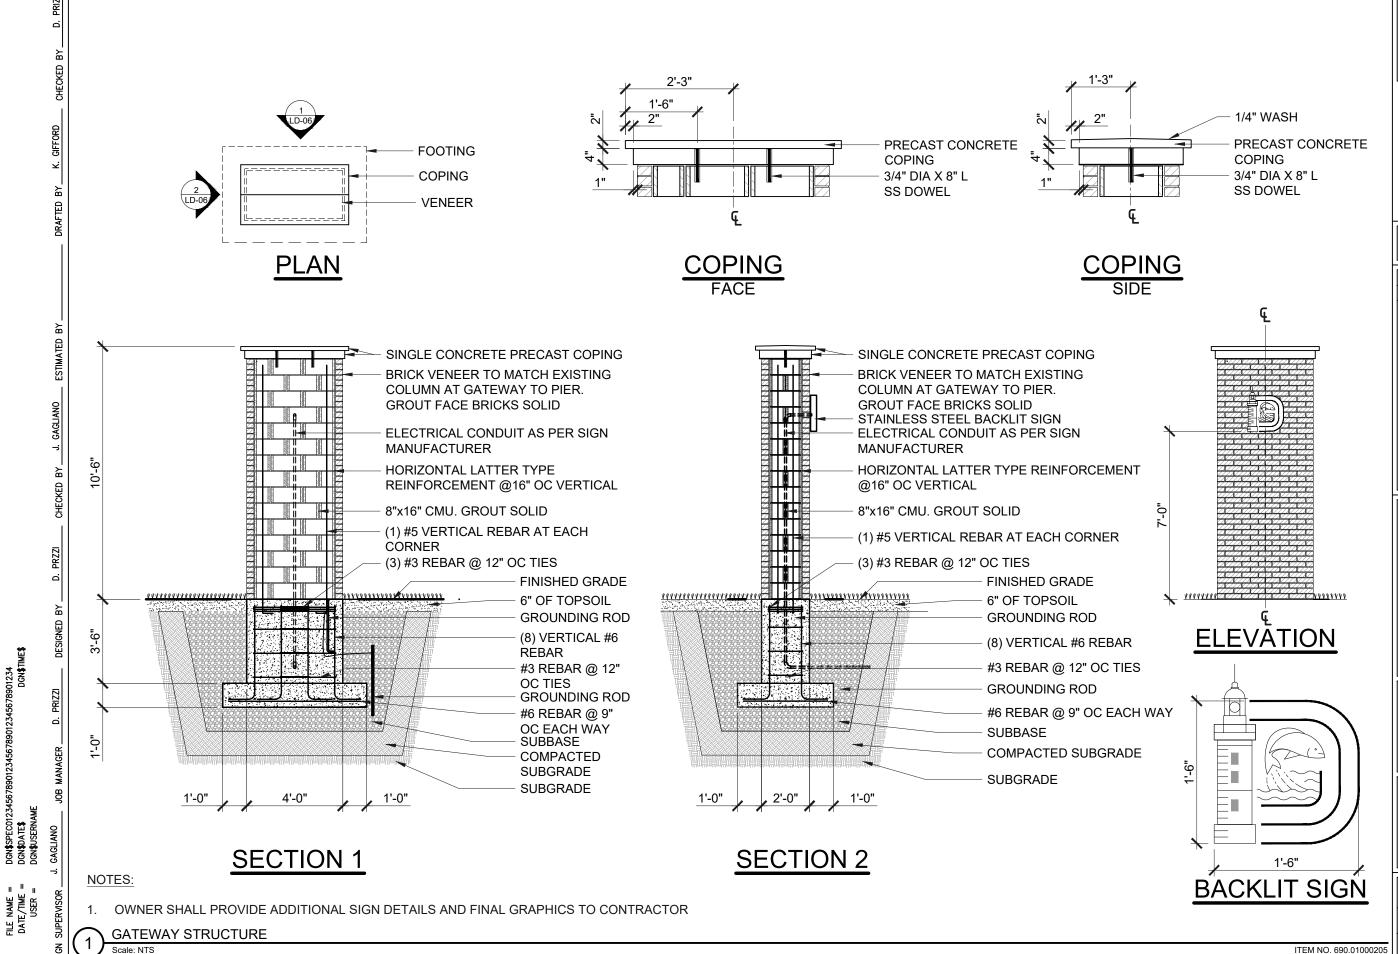

PROJECT NAME


LAKE SHORE DRIVE

DRAWING TITLE

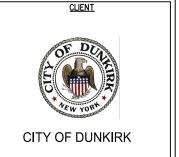GATEWAY STRUCTURE

SCALE AS SHOWN	JANUARY 2022
P.I.N. 5763.53	FEDERAL AID PROJECT NO.
SHEET NO.	DRAWING NO.
65 o f 94	LD - 05

ITEM NO. 690.01000205

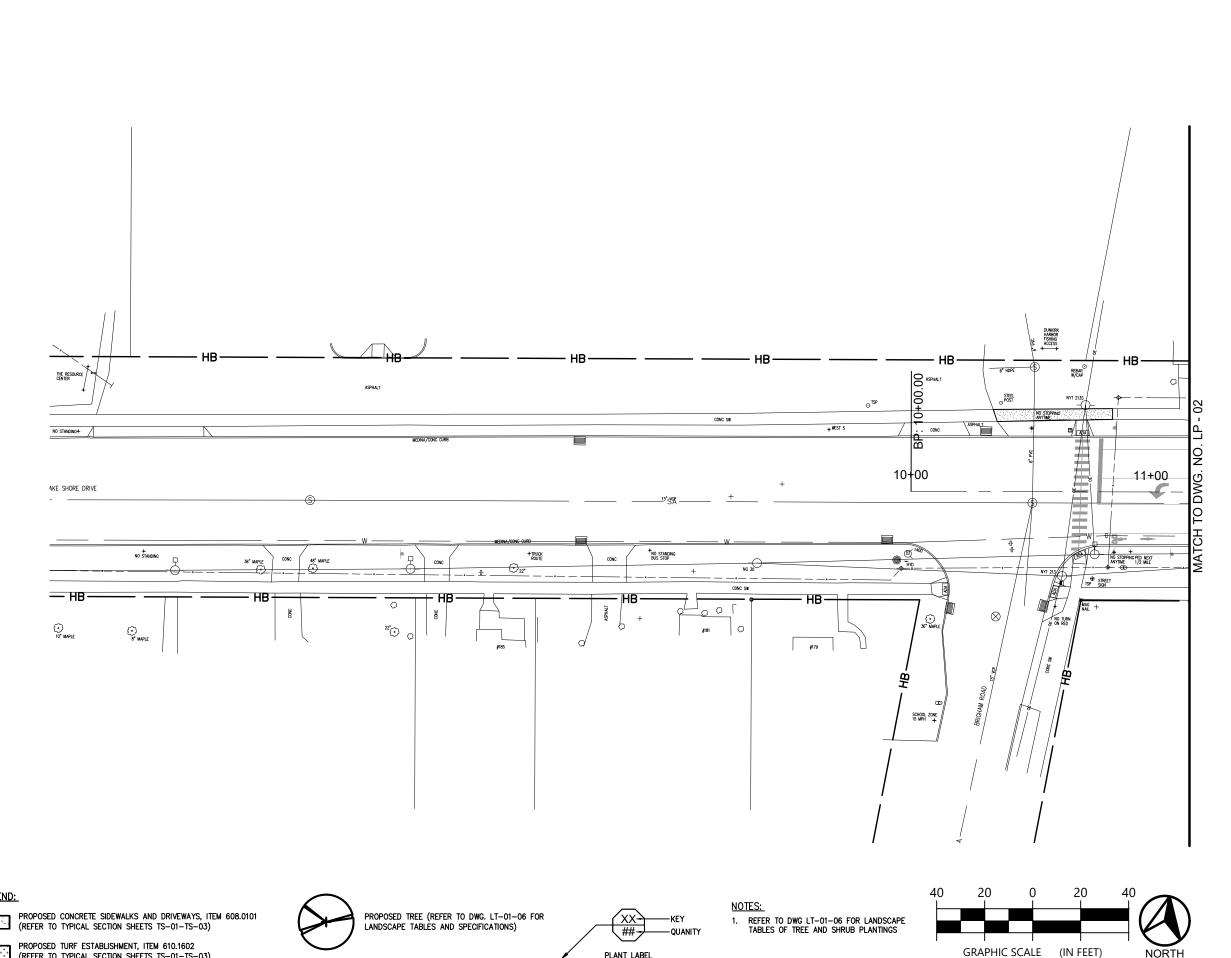





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	REVISIONS		
NO.	DESCRIPTION	BY	DATE

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CITY OF DUNKIRK

PROJECT NAME

LAKE SHORE DRIVE

DRAWING TITLE

LANDSCAPE PLAN


SCALE 1" = 40'-0"	DATE JANUARY 2022
P.I.N. 5763.53	FEDERAL AID PROJECT NO.
SHEET NO.	DRAWING NO.
66 o r 94	LP - 01


LEGEND:

o.

PROPOSED TURF ESTABLISHMENT, ITEM 610.1602 (REFER TO TYPICAL SECTION SHEETS TS-01-TS-03)



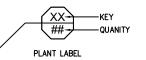

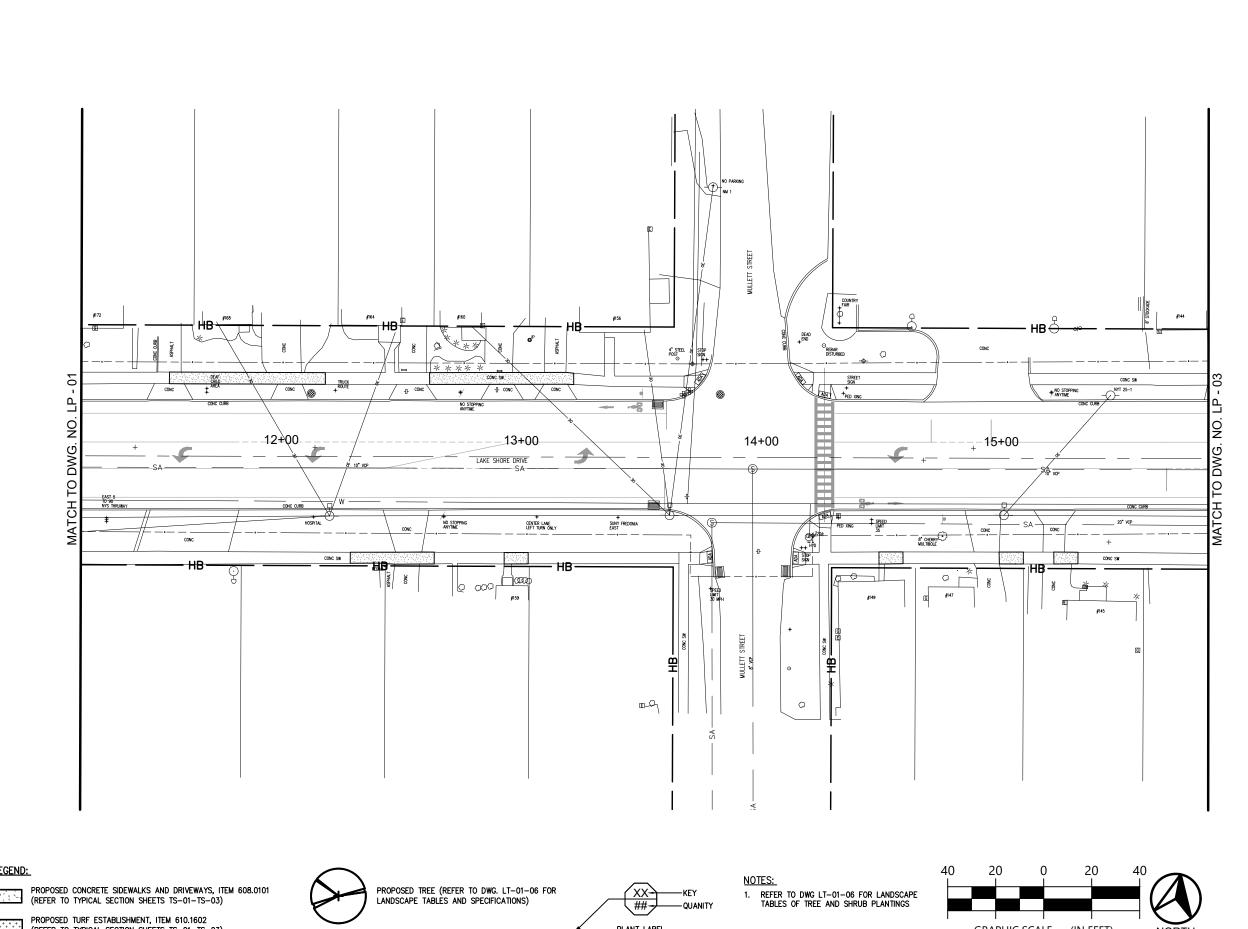

a better environment P. 315.471.0688



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REVISIONS			
NO.	DESCRIPTION	BY	DATE



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PROJECT NAME

LAKE SHORE DRIVE


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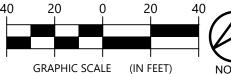
LANDSCAPE PLAN


SCALE 1" = 40'-0"	DATE JANUARY 2022
P.I.N. 5763.53	FEDERAL AID PROJECT NO.
SHEET NO.	DRAWING NO.
67 o f 94	LP - 02

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PROPOSED TURF ESTABLISHMENT, ITEM 610.1602 (REFER TO TYPICAL SECTION SHEETS TS-01-TS-03)





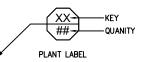

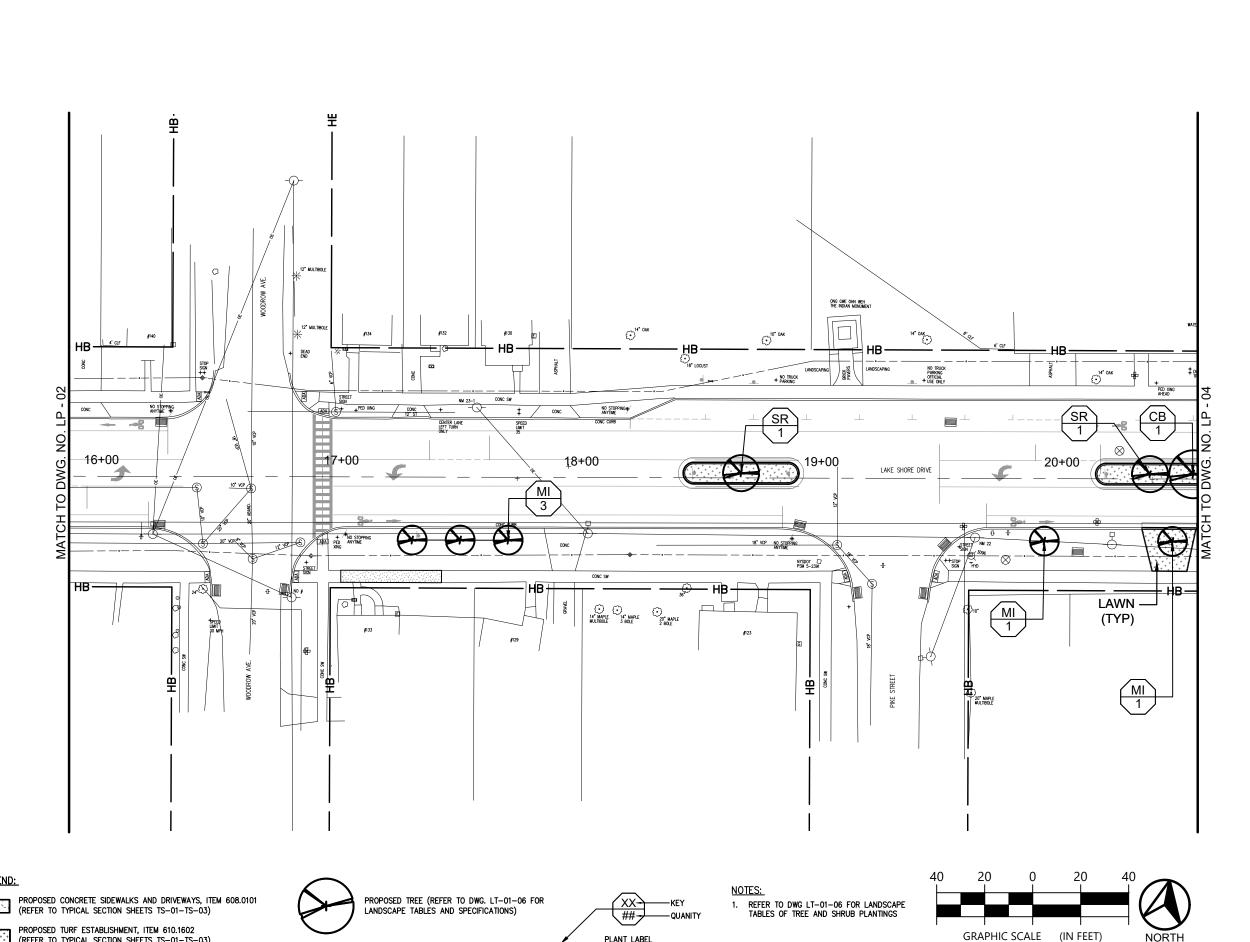
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REVISIONS			
NO.	DESCRIPTION	BY	DATE



PROJECT NAME

LAKE SHORE DRIVE

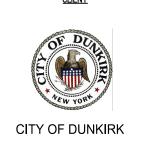DRAWING TITLE


LANDSCAPE PLAN


SCALE	DATE
1" = 40'-0"	JANUARY 2022
P.I.N. 5763.53	FEDERAL AID PROJECT NO.
SHEET NO.	DRAWING NO.
SILLI NO.	DRAWING NO.
68 o f 94	LP - 03

LEGEND:

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PROPOSED TURF ESTABLISHMENT, ITEM 610.1602 (REFER TO TYPICAL SECTION SHEETS TS-01-TS-03)



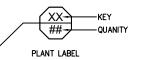
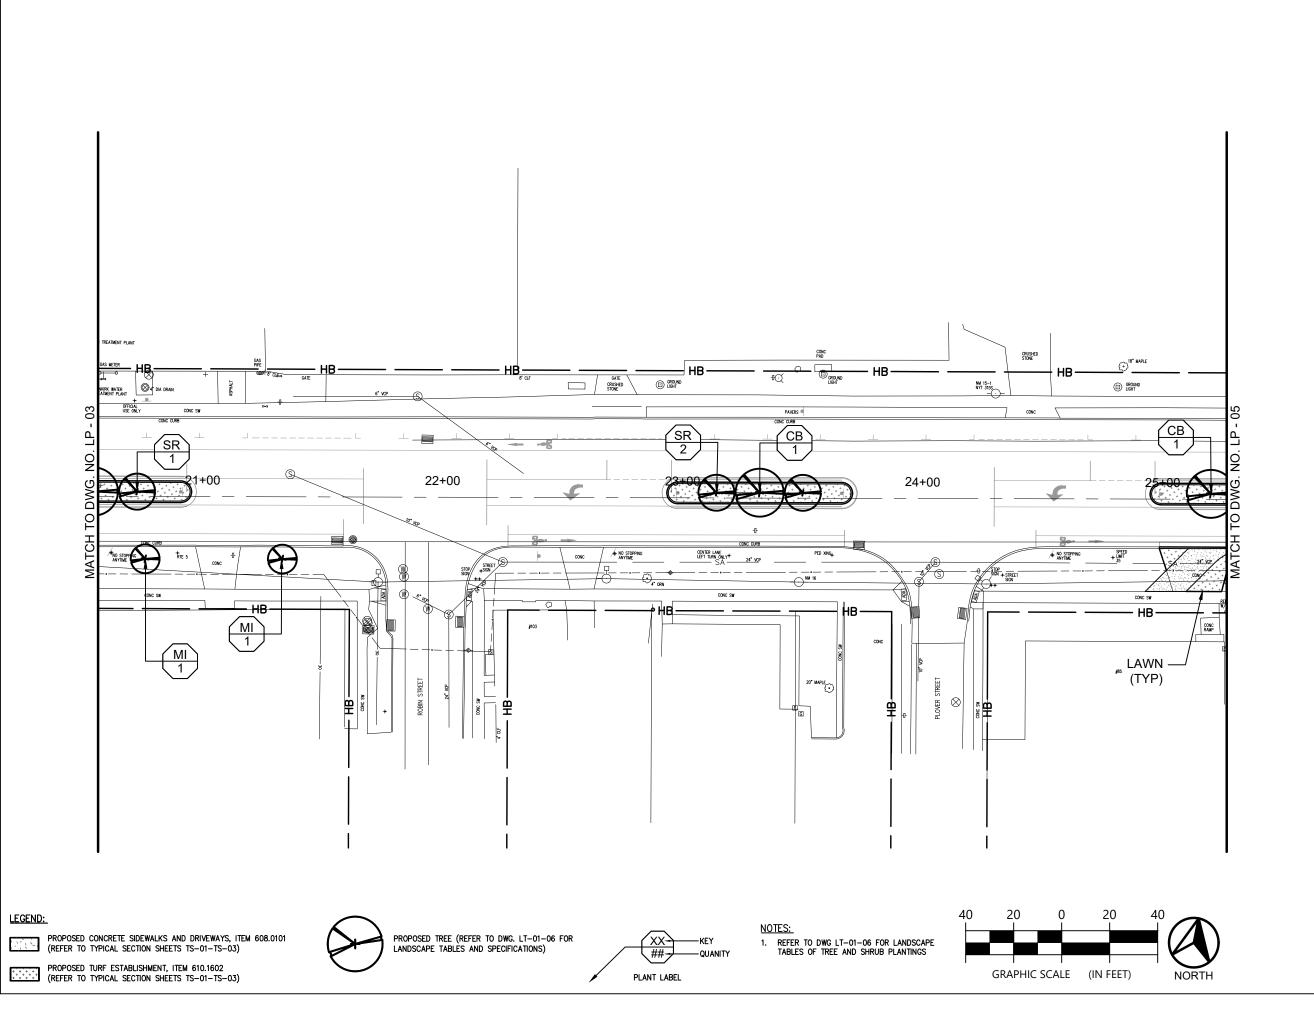
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Environmental
Design & Researcl
Landrage Architecture, Engineerin
& Environmental Services, D.P.C.
21 Montgomery Street, Susta 100
Syracuse, New York 13302

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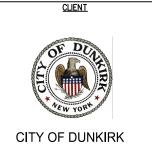


PS & E PLANS 12/6/2021

700

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REVISIONS			
NO.	DESCRIPTION	BY	DATE




PROJECT NAME

LAKE SHORE DRIVE

DRAWING TITLE

LANDSCAPE PLAN

SCALE 1" = 40'-0"	DATE JANUARY 2022
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5763.53	FEDERAL AID PROJECT NO.
SHEET NO.	DRAWING NO.
69 o F 94	LP - 04

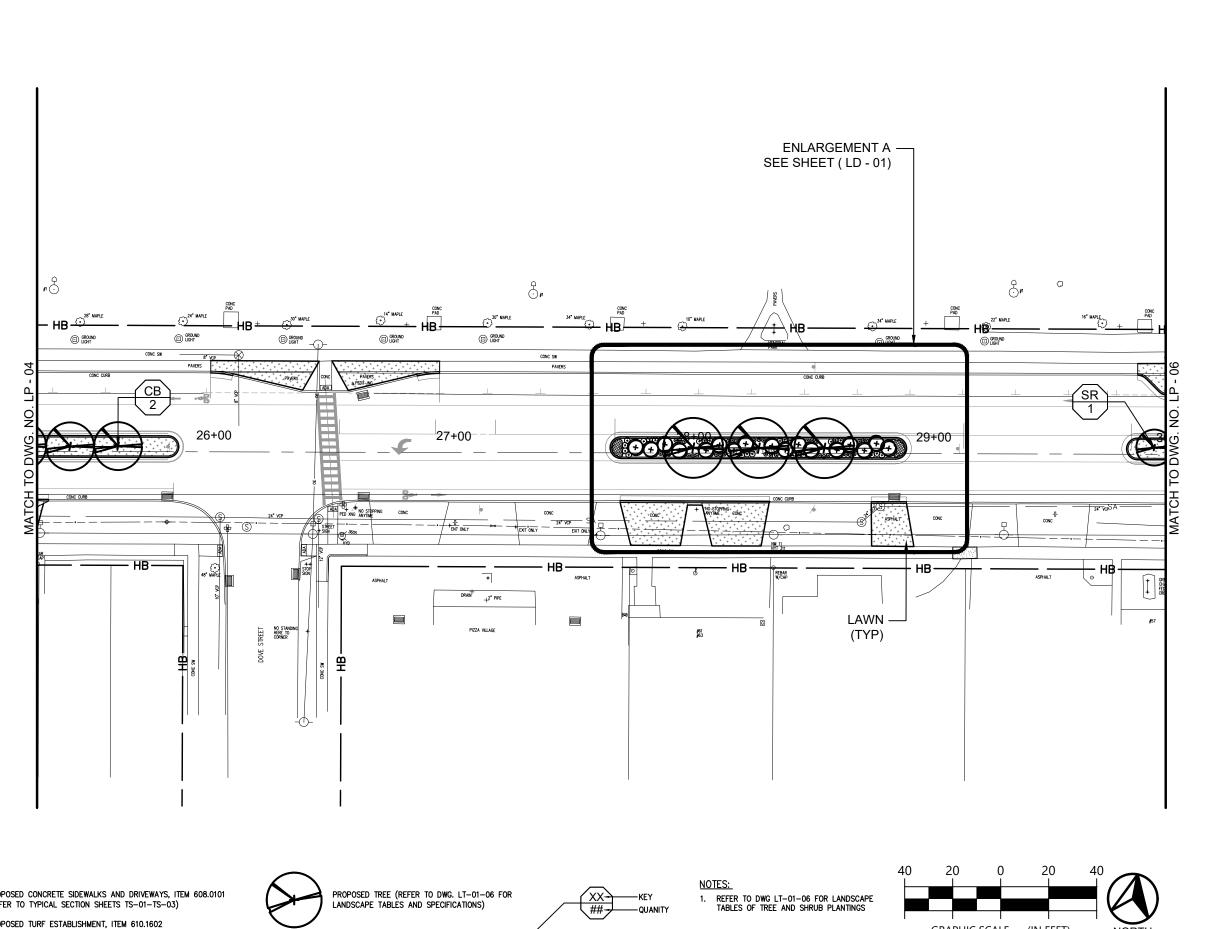

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REVISIONS			
NO.	DESCRIPTION	BY	DATE
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PROJECT NAME

LAKE SHORE DRIVE

DRAWING TITLE

LANDSCAPE PLAN

SCALE 1" = 40'-0"	DATE JANUARY 2022
P.I.N. 5763.53	FEDERAL AID PROJECT NO.
SHEET NO.	DRAWING NO.
70 o f 94	LP - 05


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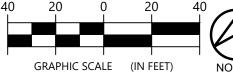
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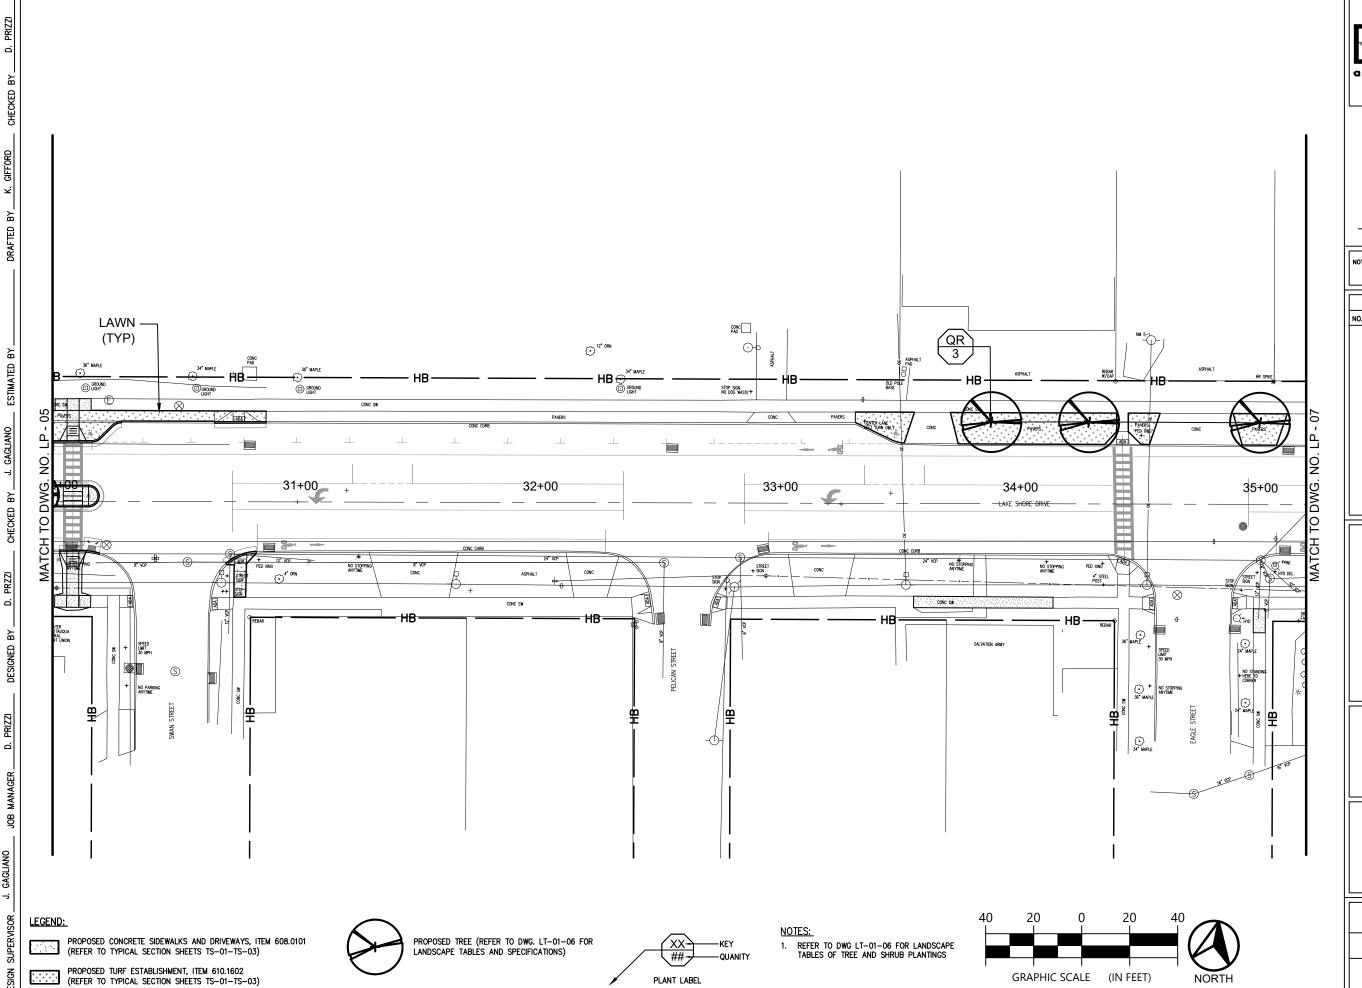
PROPOSED CONCRETE SIDEWALKS AND DRIVEWAYS, ITEM 608.0101 (REFER TO TYPICAL SECTION SHEETS TS-01-TS-03)

PROPOSED TURF ESTABLISHMENT, ITEM 610.1602
(REFER TO TYPICAL SECTION SHEETS TS-01-TS-03)







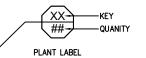

J. GAGLIANO

D. PRZZI


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REVISIONS			
NO.	DESCRIPTION	BY	DATE




PROJECT NAME

LAKE SHORE DRIVE

DRAWING TITLE

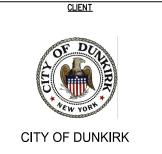LANDSCAPE PLAN

SCALE	DATE	
1" = 40'-0"	JANUARY 2022	
P.I.N. 5763.53	FEDERAL AID PROJECT NO.	
SHEET NO.	DRAWING NO.	
71 or 94	LP - 06	

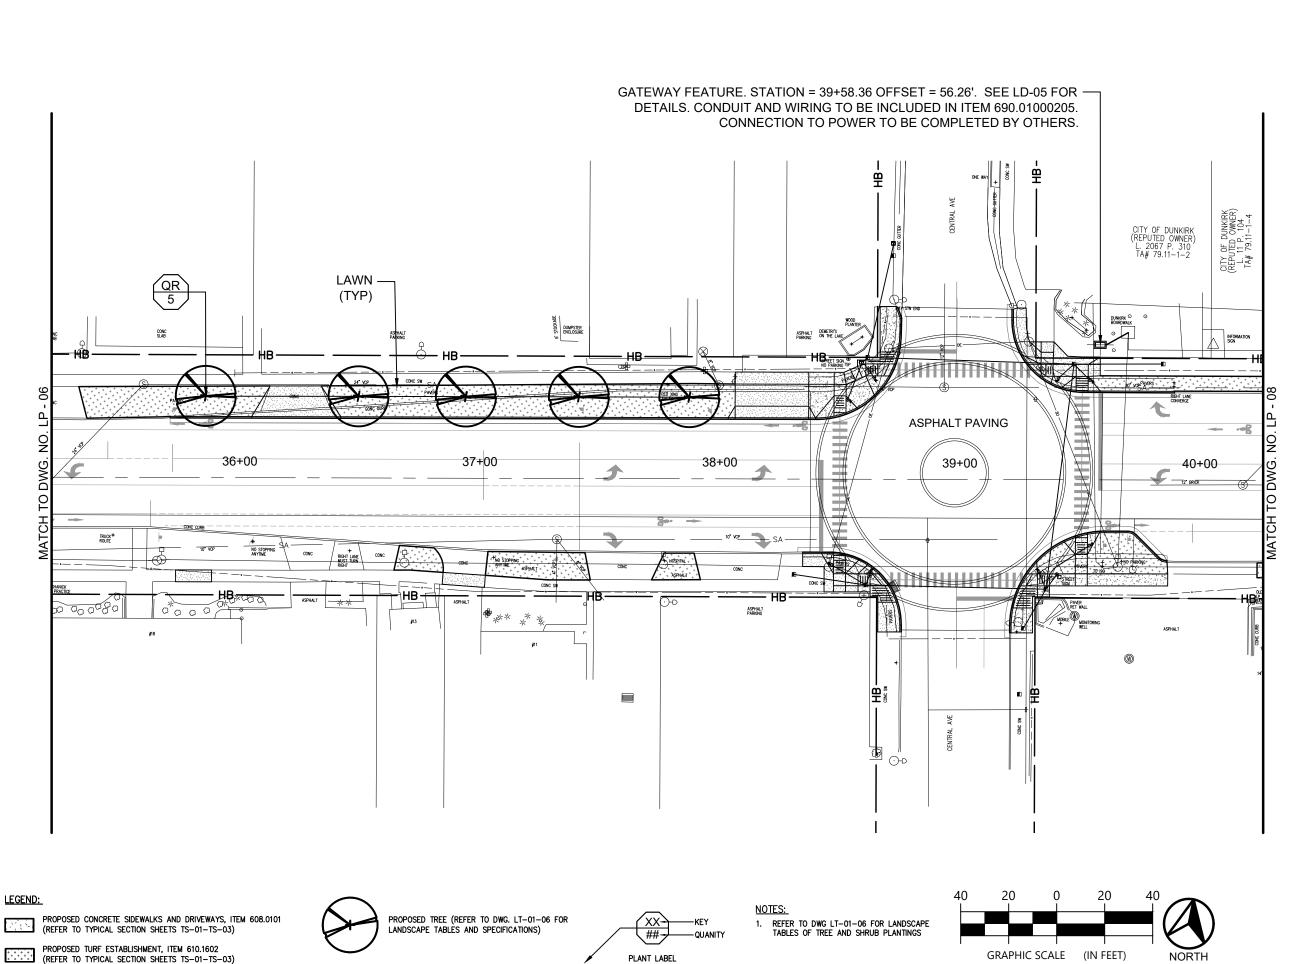

Environmental
Design & Research,
Landscape Architecture, Engineering
to Environmental Services, D.P.C.
Syracuse, New York 1302 ± 1100
Syracuse, New York 1302 ± 1100
Syracuse, New York 1302 ± 1100
Syracuse, New York 1302



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DATE

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	REVISIONS		
NO.	DESCRIPTION	BY	DATE




PROJECT NAME

LAKE SHORE DRIVE

DRAWING TITLE

LANDSCAPE PLAN

SCALE 1" = 40'-0"	DATE JANUARY 2022	
P.I.N. 5763.53	FEDERAL AID PROJECT NO.	
SHEET NO.	DRAWING NO.	
72 o f 94	LP - 07	

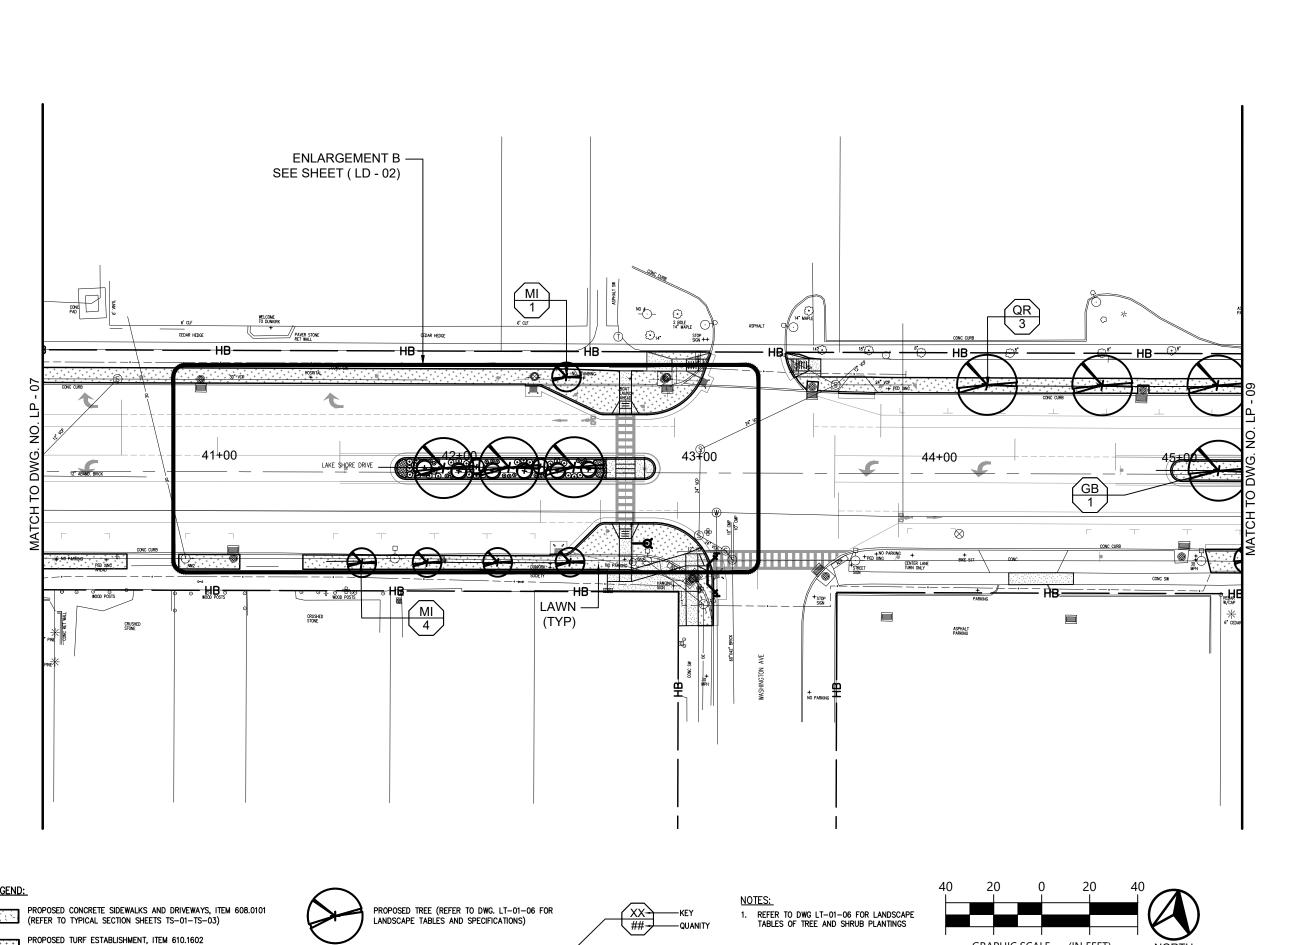

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	REVISIONS						
NO.	DESCRIPTION	BY	DATE				



PROJECT NAME

LAKE SHORE DRIVE

DRAWING TITLE


LANDSCAPE PLAN

SCALE 1" = 40'-0"	JANUARY 2022
P.I.N. 5763.53	FEDERAL AID PROJECT NO.
SHEET NO.	DRAWING NO.
73 o f 94	LP - 08


LEGEND:

PROPOSED TURF ESTABLISHMENT, ITEM 610.1602 (REFER TO TYPICAL SECTION SHEETS TS-01-TS-03)



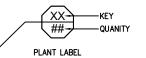



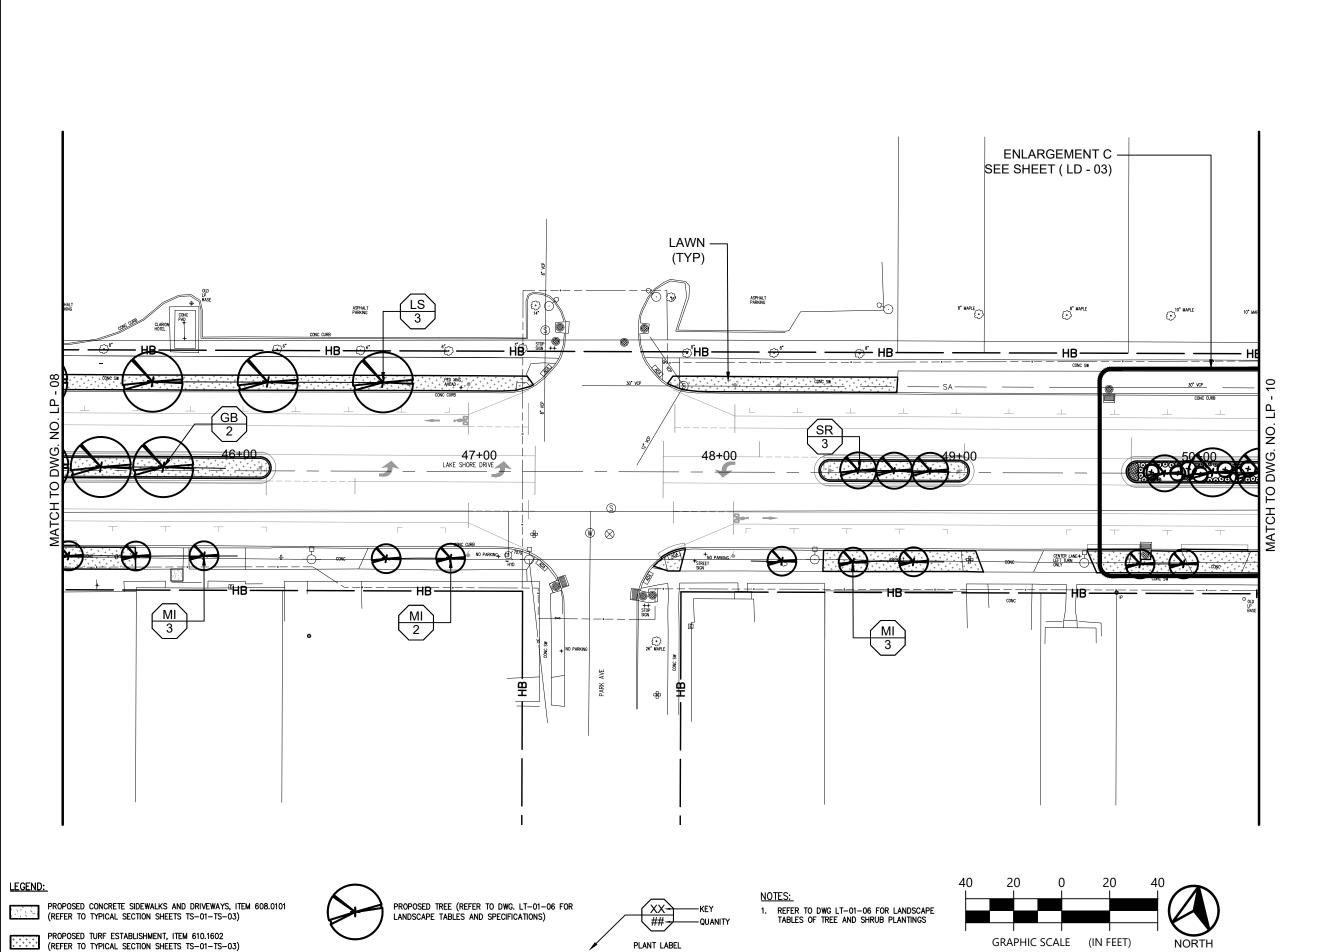

Environmental
Design & Research,
Landsage Architecture, Engineering
& Reference St. P.C.
217 Montportury Street, State 1100
Synacus, New York 13002

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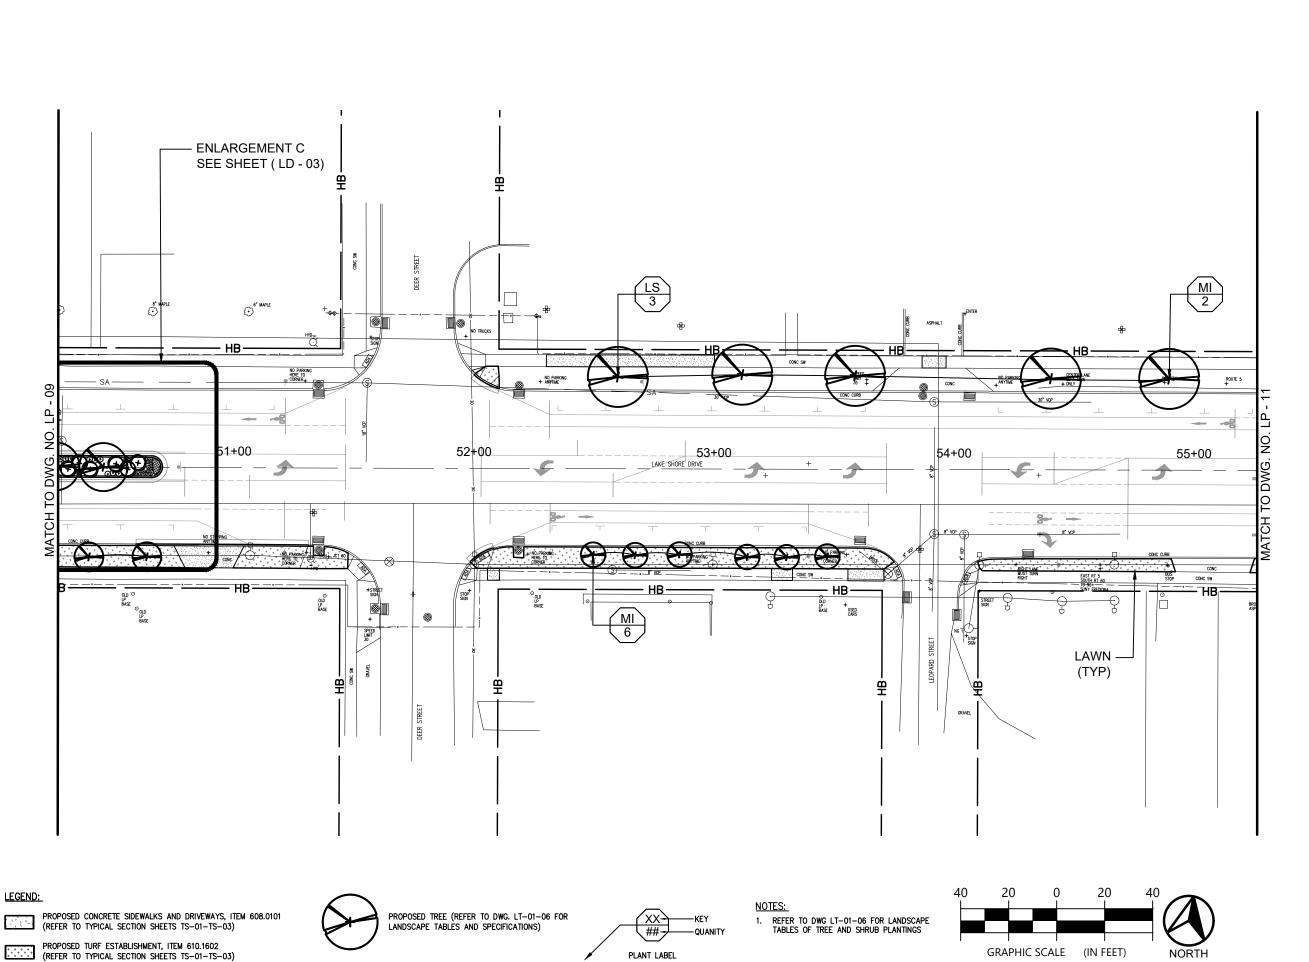
PROJECT NAME

LAKE SHORE DRIVE

DRAWING TITLE

LANDSCAPE PLAN

DATE
JANUARY 2022
FEDERAL AID PROJECT NO.
DRAWING NO.
LP - 09



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Environmental
Design & Research,
Landscape Architecture, Engineering
& Environmental Services, D.P.C.
217 Montponery Street, State 1100
Syracuse, New York 13002

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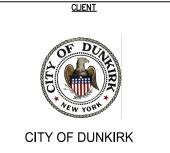


PS & E PLANS 12/6/2021

DATE

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REVISIONS					
NO.	DESCRIPTION	BY	DATE		




PROJECT NAME

LAKE SHORE DRIVE

DRAWING TITLE

LANDSCAPE PLAN

	SCALE 1" = 40'-0"	JANUARY 2022
	P.I.N. 5763.53	FEDERAL AID PROJECT NO.
П	SHEET NO.	DRAWING NO.
	75 o f 94	LP - 10

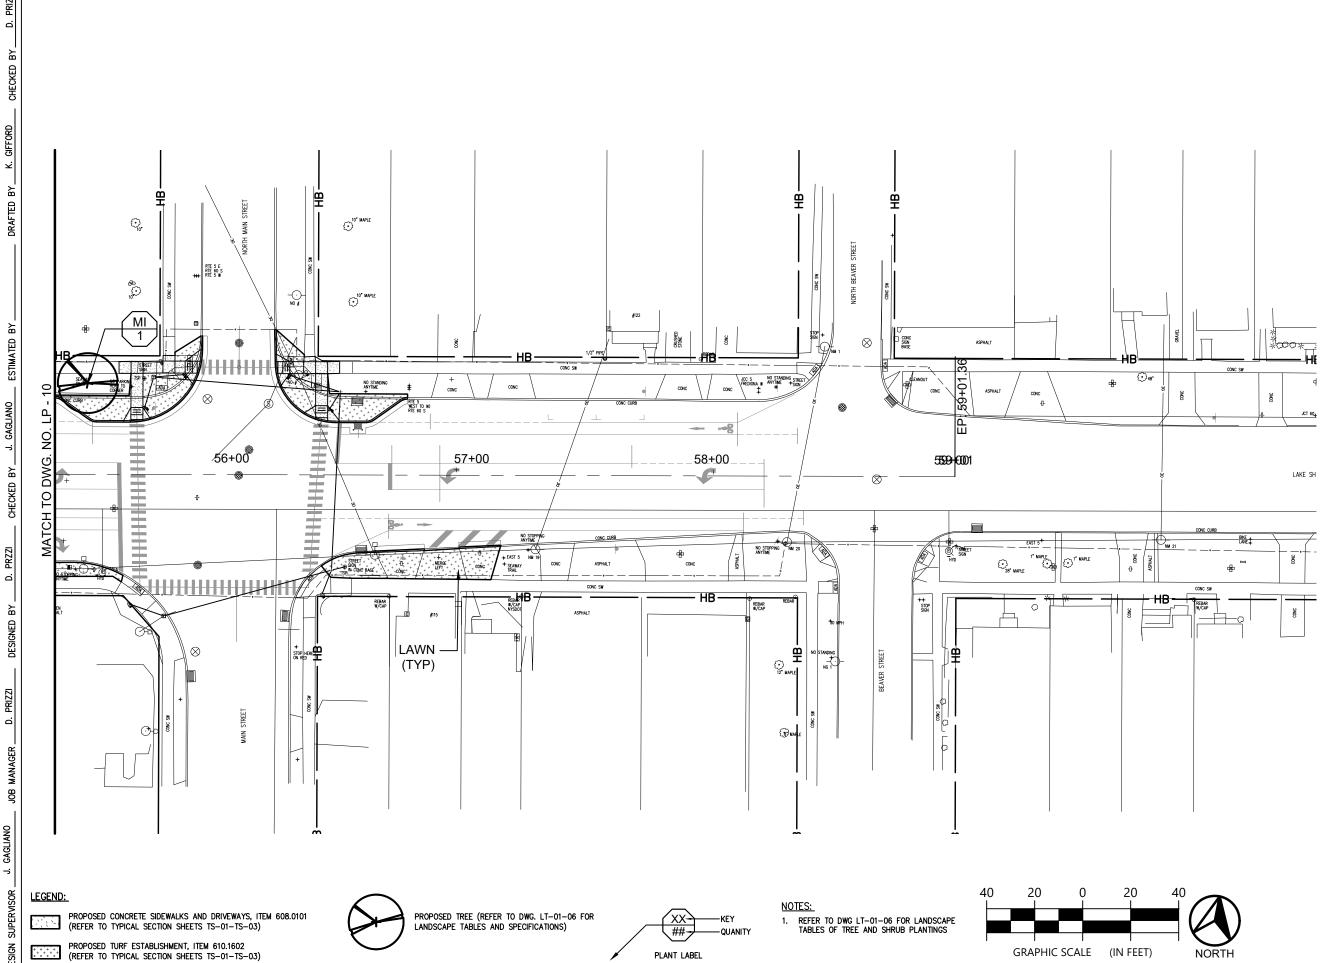

Environmental
Design & Research,
Landcape Architecture, Engineering
& Environmental Services, D.P.C.
217 Montgomery Street, Suite 1100
Synacuse, New York 13202


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PS & E PLANS 12/6/2021

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	REVISIONS						
NO.	DESCRIPTION BY DATE						



PROJECT NAME

LAKE SHORE DRIVE

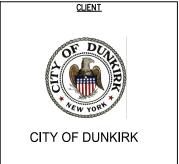DRAWING TITLE

LANDSCAPE PLAN

SCALE 1" = 40'-0"	DATE JANUARY 2022
P.I.N. 5763.53	FEDERAL AID PROJECT NO.
SHEET NO.	DRAWING NO.
76 o f 94	LP - 11

	K. GIFF
	DRAFTED BY K. GIFF
	FSTIMATED BY
	CHECKED BY J. GAGLIANO
	D. PRZZI
DGN \$ TIME\$	DESIGNED BY D. PRZZI
DGI	D. PRIZZI
	31

	TREE PLANTING TABLE (1 OF3)												
ITEM NO.	DESCRIPTION												
611.0151	PLANTING - MAJOR DECIDUOUS TREES - 2 INCH CALIPER BALL& BURLAP, FIELD POTTED OR FIELD BOXED												
611.0201	PLANTING - N	PLANTING - MINOR DECIDUOUS TREES - 2 INCH CALIPER BALL& BURLAP, FIELD POTTED OR FIELD BOXED											
611.19010024	POST PLANT	ING CARE WITH	REPLACEMENT	r - MAJOR DEC	IDUOUS TREES								
611.19020024	POST PLANT	ING CARE WITH	REPLACEMENT	r - MINOR DECI	DUOUS TREES								
610.19	WATERING V	EGETATION (PE	R APPLICATION	l)									
611.17	PORTABLE D	RIP IRRIGATION	I SYSTEM										
STATION	SIDE	OFFSET	ID No.	KEY	611.0151 (EA)	611.0201 (EA)	611.19010024 (EA)	611.19020024 (EA)	610.19 (MGAL)	611.17 (EA)	BOTANICAL NAME	COMMON NAME	ROOT
17+29.39	RT	26.27'	1	МІ		1		1	0.015	1	MALUS 'JFS KW214MX'	IVORY SPEAR CRABAPPLE	BALL AND BURLAP
17+49.39	RT	26.22'	2	MI		1		1	0.015	1	MALUS 'JFS KW214MX'	IVORY SPEAR CRABAPPLE	BALL AND BURLAP
17+69.39	RT	26.17'	3	МІ		1		1	0.015	1	MALUS 'JFS KW214MX'	IVORY SPEAR CRABAPPLE	BALL AND BURLAP
18+66.36	LT	-1.96'	4	SR		1		1	0.015	1	SYRINGA RETICULATA 'IVORY SILK'	IVORY SILK TREE LILAC	BALL AND BURLAP
19+92.77	RT	26.01'	5	MI		1		1	0.015	1	MALUS 'JFS KW214MX'	IVORY SPEAR CRABAPPLE	BALL AND BURLAP
20+36.73	LT	-2.00'	6	SR		1		1	0.015	1	SYRINGA RETICULATA 'IVORY SILK'	IVORY SILK TREE LILAC	BALL AND BURLAP
20+46.19	RT	26.00'	7	МІ		1		1	0.015	1	MALUS 'JFS KW214MX'	IVORY SPEAR CRABAPPLE	BALL AND BURLAP
20+54.75	LT	-2.00'	8	СВ	1		1		0.015	1	CARPINUS BETULUS 'FASTIGIATA'	UPRIGHT EUROPEAN HORNBEAM	BALL AND BURLAP
20+72.75	LT	-2.00'	9	SR		1		1	0.015	1	SYRINGA RETICULATA 'IVORY SILK'	IVORY SILK TREE LILAC	BALL AND BURLAP
20+76.19	RT	26.00'	10	MI		1		1	0.015	1	MALUS 'JFS KW214MX'	IVORY SPEAR CRABAPPLE	BALL AND BURLAP
21+33.35	RT	25.95'	11	MI		1		1	0.015	1	MALUS 'JFS KW214MX'	IVORY SPEAR CRABAPPLE	BALL AND BURLAP
23+14.13	LT	-2.16'	12	SR		1		1	0.015	1	SYRINGA RETICULATA 'IVORY SILK'	IVORY SILK TREE LILAC	BALL AND BURLAP
23+32.15	LT	-2.21'	13	СВ	1		1		0.015	1	CARPINUS BETULUS 'FASTIGIATA'	UPRIGHT EUROPEAN HORNBEAM	BALL AND BURLAP
23+50.15	LT.	-2.22'	14	SR		1		1	0.015	1	SYRINGA RETICULATA 'IVORY SILK'	IVORY SILK TREE LILAC	BALL AND BURLAP
25+20.12	LT	-2.23'	15	СВ	1		1		0.015	1	CARPINUS BETULUS 'FASTIGIATA'	UPRIGHT EUROPEAN HORNBEAM	BALL AND BURLAP
25+40.12	LT	-2.11'	16	СВ	1		1		0.015	1	CARPINUS BETULUS 'FASTIGIATA'	UPRIGHT EUROPEAN HORNBEAM	BALL AND BURLAP
25+60.11	LT	-2.28'	17	СВ	1		1		0.015	1	CARPINUS BETULUS 'FASTIGIATA'	UPRIGHT EUROPEAN HORNBEAM	BALL AND BURLAP
27+99.74	LT	-2.16'	18	GB	1		1		0.015	1	GINKGO BILOBA 'AUTUMN GOLD'	AUTUMN GOLD GINKGO	BALL AND BURLAP
28+27.11	LT	-2.17'	19	GB	1		1		0.015	1	GINKGO BILOBA 'AUTUMN GOLD'	AUTUMN GOLD GINKGO	BALL AND BURLAP
28+54.40	LT	-2.20'	20	GB	1		1		0.015	1	GINKGO BILOBA 'AUTUMN GOLD'	AUTUMN GOLD GINKGO	BALL AND BURLAP
29+91.86	LT	-2.79'	21	SR		1		1	0.015	1	SYRINGA RETICULATA 'IVORY SILK'	IVORY SILK TREE LILAC	BALL AND BURLAP
33+87.78	LT	-33.97'	22	QR	1	·	1	·	0.015	1	QUERCUS RUBRA	RED OAK	BALL AND BURLAP
34+28.53	LT	34.00'	23	QR	1		1		0.015	1	QUERCUS RUBRA	RED OAK	BALL AND BURLAP
34+99.73	LT	-34.00'	24	QR	1		1		0.015	1	QUERCUS RUBRA	RED OAK	BALL AND BURLAP
35+85.75	LT	-34.00'	25	QR	1		1		0.015	1	QUERCUS RUBRA	RED OAK	BALL AND BURLAP
36+49.39	LT	34.01'	26	QR	1		1		0.015	1	QUERCUS RUBRA	RED OAK	BALL AND BURLAP
36+94.12	LT	-34.00'	27	QR	1		1		0.015	1	QUERCUS RUBRA	RED OAK	BALL AND BURLAP
37+41.21	LT	-34.00'	28	QR	1		1		0.015	1	QUERCUS RUBRA	RED OAK	BALL AND BURLAP
37+87.22	LT	-34.00'	29	QR	1		1		0.015	1	QUERCUS RUBRA	RED OAK	BALL AND BURLAP
41+59.47	RT	37.75'	30	MI	'	1	,	1	0.015	1	MALUS 'JFS KW214MX'	IVORY SPEAR CRABAPPLE	BALL AND BURLAP
41+39.47	RT	-37.75'	31	MI		1		1	0.015	1	MALUS 'JFS KW214MX'	IVORY SPEAR CRABAPPLE	BALL AND BURLAP
71:00.03	I IXI	-01.10] 31	SUBTOTAL	16		16		0.015		INVINCO OI O INVIZITIVIA	IVOICE OF LAIN OF COURTER	DALL AND BURLAP
				JUDIUIAL	10	15	16	15	0.47	31			

NOTE

file name = Date/Time = USER =

1. SEE DRAWING LD-04 FOR WATERING VEGETATION REQUIREMENTS





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	REVISIONS							
NO.	DESCRIPTION	BY	DATE					

CLIEN



CITY OF DUNKIRK

PROJECT NAME

LAKE SHORE DRIVE

DRAWING TITLE

LANDSCAPE TABLES

SCALE AS SHOWN	DATE JANUARY 2022
P.I.N. 5763.53	FEDERAL AID PROJECT NO.
SHEET NO.	DRAWING NO.
77 o f 94	LT - 01

	TREE PLANTING TABLE (2 OF3)												
ITEM NO.	DESCRIPTION												
611.0151	PLANTING -	PLANTING - MAJOR DECIDUOUS TREES - 2 INCH CALIPER BALL& BURLAP, FIELD POTTED OR FIELD BOXED											
611.0201	PLANTING -	MINOR DECIDUO	OUS TREES - 2 IN	CH CALIPER I	BALL& BURLAP, FIELL	D POTTED OR FIELD	BOXED						
611.19010024	POST PLANT	TING CARE WITH	REPLACEMENT	- MAJOR DEC	IDUOUS TREES								
611.19020024	POST PLANT	TING CARE WITH	REPLACEMENT	- MINOR DEC	IDUOUS TREES								
610.19	WATERING \	VEGETATION (PE	R APPLICATION)										
611.17	PORTABLE I	DRIP IRRIGATION	I SYSTEM										
STATION	SIDE	OFFSET	ID No.	KEY	611.0151 (EA)	611.0201 (EA)	611.19010024 (EA)	611.19020024 (EA)	610.19 (MGAL)	611.17 (EA)	BOTANICAL NAME	COMMON NAME	ROOT
41+93.47		1	•	•	•	•	1		TREE OMITTE	D	1	•	
42+16.11	RT	37.75'	33	MI		1		1	0.015	1	MALUS 'JFS KW214MX'	IVORY SPEAR CRABAPPLE	BALL AND BURLAP
42+20.75	LT	-2.10'	34	GB	1		1		0.015	1	GINKGO BILOBA 'AUTUMN GOLD'	AUTUMN GOLD GINKGO	BALL AND BURLAP
42+44.54	LT	-39.75'	35	MI		1		1	0.015	1	MALUS 'JFS KW214MX'	IVORY SPEAR CRABAPPLE	BALL AND BURLAP
42+46.53	RT	37.75'	36	MI		1		1	0.015	1	MALUS 'JFS KW214MX'	IVORY SPEAR CRABAPPLE	BALL AND BURLAP
42+47.86	LT	-2.24'	37	GB	1		1		0.015	1	GINKGO BILOBA 'AUTUMN GOLD'	AUTUMN GOLD GINKGO	BALL AND BURLAP
44+19.83	LT	-37.00'	38	QR	1		1		0.015	1	QUERCUS RUBRA	RED OAK	BALL AND BURLAP
44+67.83	LT	-36.99'	39	QR	1		1		0.015	1	QUERCUS RUBRA	RED OAK	BALL AND BURLAP
45+15.83	LT	-36.99'	41	QR	1		1		0.015	1	QUERCUS RUBRA	RED OAK	BALL AND BURLAP
45+16.38	LT	-1.49'	42	GB	1		1		0.015	1	GINKGO BILOBA 'AUTUMN GOLD'	AUTUMN GOLD GINKGO	BALL AND BURLAP
45+29.01	RT	35.65'	43	MI		1		1	0.015	1	MALUS 'JFS KW214MX'	IVORY SPEAR CRABAPPLE	BALL AND BURLAP
45+42.38	LT	-1.49'	44	GB	1		1		0.015	1	GINKGO BILOBA 'AUTUMN GOLD'	AUTUMN GOLD GINKGO	BALL AND BURLAP
45+57.06	RT	35.65'	45	MI		1		1	0.015	1	MALUS 'JFS KW214MX'	IVORY SPEAR CRABAPPLE	BALL AND BURLAP
45+63.82	LT	-37.00'	46	LS	1		1		0.015	1	LIQUIDAMBAR STYRACIFLUA	SWEET GUM	BALL AND BURLAP
45+68.38	LT	-1.47'	47	GB	1		1		0.015	1	GINKGO BILOBA 'AUTUMN GOLD'	AUTUMN GOLD GINKGO	BALL AND BURLAP
45+85.09	RT	35.88'	48	MI		1		1	0.015	1	MALUS 'JFS KW214MX'	IVORY SPEAR CRABAPPLE	BALL AND BURLAP
46+11.83	LT	-37.00'	49	LS	1		1		0.015	1	LIQUIDAMBAR STYRACIFLUA	SWEET GUM	BALL AND BURLAP
46+59.83	LT	-36.97'	50	LS	1		1		0.015	1	LIQUIDAMBAR STYRACIFLUA	SWEET GUM	BALL AND BURLAP
46+61.35	RT	36.46'	51	MI		1		1	0.015	1	MALUS 'JFS KW214MX'	IVORY SPEAR CRABAPPLE	BALL AND BURLAP
46+88.18	RT	36.18'	52	MI		1		1	0.015	1	MALUS 'JFS KW214MX'	IVORY SPEAR CRABAPPLE	BALL AND BURLAP
48+26.19	RT	37.09'	53	MI		1		1	0.015	1	MALUS 'JFS KW214MX'	IVORY SPEAR CRABAPPLE	BALL AND BURLAP
48+55.94	RT	37.40'	54	MI		1		1	0.015	1	MALUS 'JFS KW214MX'	IVORY SPEAR CRABAPPLE	BALL AND BURLAP
48+57.92	LT	-0.80'	55	SR		1		1	0.015	1	SYRINGA RETICULATA 'IVORY SILK'	IVORY SILK TREE LILAC	BALL AND BURLAP
48+72.92	LT	-0.74'	56	SR		1		1	0.015	1	SYRINGA RETICULATA 'IVORY SILK'	IVORY SILK TREE LILAC	BALL AND BURLAP
48+81.08	RT	37.20'	57	MI		1		1	0.015	1	MALUS 'JFS KW214MX'	IVORY SPEAR CRABAPPLE	BALL AND BURLAP
48+87.92	LT	-0.70'	58	SR		1		1	0.015	1	SYRINGA RETICULATA 'IVORY SILK'	IVORY SILK TREE LILAC	BALL AND BURLAP
		SUBTOTAL	•	1	11	14	11	14	0.38	25			
			•		1		1				•	'	1

Environmental
Design & Research,
Landscape Architecture, Engineering of trivinomental Services, D.P.C.
Syracus, New York 1320.

G better environment P. 315.471.0688



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NO.	DESCRIPTION	BY	DATE				
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<u>CLIENT</u>



CITY OF DUNKIRK

PROJECT NAME

LAKE SHORE DRIVE

DRAWING TITLE

LANDSCAPE TABLES

SCALE AS SHOWN	DATE JANUARY 2022
P.I.N. 5763.53	FEDERAL AID PROJECT NO.
SHEET NO.	DRAWING NO.
78 o r 94	LT - 02

NOTE

1. SEE DRAWING LD-04 FOR WATERING VEGETATION REQUIREMENTS

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B ⊢		611.
		611.19
SECK		611.19
-		610
GIFFORD		611
K. GIFF		STA
ΒY		49+7
		49+8
DRAFI		49+9
_		50+0
		50+2
		50+3
		50+4
B≺		50+6
ÅED		52+4
STIM/		52+5
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	TREE PLANTING TABLE (3 OF3)] !
ITEM NO.	DESCRIPTION	
611.0151	PLANTING - MAJOR DECIDUOUS TREES - 2 INCH CALIPER BALL& BURLAP, FIELD POTTED OR FIELD BOXED	
611.0201	PLANTING - MINOR DECIDUOUS TREES - 2 INCH CALIPER BALL& BURLAP, FIELD POTTED OR FIELD BOXED	
611.19010024	POST PLANTING CARE WITH REPLACEMENT - MAJOR DECIDUOUS TREES	
611.19020024	POST PLANTING CARE WITH REPLACEMENT - MINOR DECIDUOUS TREES	
610.19	WATERING VEGETATION (PER APPLICATION)	1
611 17	PORTABI F DRIP IRRIGATION SYSTEM	11

011.0201	FLANTING -	WIINON DECIDOO	103 INLLS - 2 II	VOIT CALIFER L	DALLO DUNLAF, I ILLI	D FOI IED OK FIELD	DOXLD						
611.19010024	POST PLANTING CARE WITH REPLACEMENT - MAJOR DECIDUOUS TREES												
611.19020024	POST PLANT	TING CARE WITH	REPLACEMENT	- MINOR DECI	DUOUS TREES								
610.19	WATERING \	EGETATION (PE	R APPLICATION	<i>I</i>)									
611.17	PORTABLE I	ORIP IRRIGATION	I SYSTEM										
STATION	SIDE	OFFSET	ID No.	KEY	611.0151 (EA)	611.0201 (EA)	611.19010024 (EA)	611.19020024 (EA)	610.19 (MGAL)	611.17 (EA)	BOTANICAL NAME	COMMON NAME	ROOT
49+75.45	RT	37.83'	59	MI		1		1	0.015	1	MALUS 'JFS KW214MX'	IVORY SPEAR CRABAPPLE	BALL AND BURLAP
49+85.59	RT	0.07'	60	SR		1		1	0.015	1	SYRINGA RETICULATA 'IVORY SILK'	IVORY SILK TREE LILAC	BALL AND BURLAP
49+93.64	RT	37.76'	61	MI		1		1	0.015	1	MALUS 'JFS KW214MX'	IVORY SPEAR CRABAPPLE	BALL AND BURLAP
50+05.58	LT	-0.39'	62	СВ	1		1		0.015	1	CARPINUS BETULUS 'FASTIGIATA'	UPRIGHT EUROPEAN HORNBEAM	BALL AND BURLAP
50+25.58	LT	-0.42'	63	СВ	1		1		0.015	1	CARPINUS BETULUS 'FASTIGIATA'	UPRIGHT EUROPEAN HORNBEAM	BALL AND BURLAP
50+39.67	RT	37.32	64	МІ		1		1	0.015	1	MALUS 'JFS KW214MX'	IVORY SPEAR CRABAPPLE	BALL AND BURLAP
50+45.58	LT	-0.13'	65	СВ	1		1		0.015	1	CARPINUS BETULUS 'FASTIGIATA'	UPRIGHT EUROPEAN HORNBEAM	BALL AND BURLAP
50+63.82	RT	37.18'	66	МІ		1		1	0.015	1	MALUS 'JFS KW214MX'	IVORY SPEAR CRABAPPLE	BALL AND BURLAP
52+49.77	RT	35.84'	67	МІ		1		1	0.015	1	MALUS 'JFS KW214MX'	IVORY SPEAR CRABAPPLE	BALL AND BURLAP
52+59.89	LT	-38.24'	68	LS	1		1		0.015	1	LIQUIDAMBAR STYRACIFLUA	SWEET GUM	BALL AND BURLAP
52+67.28	RT	36.00'	69	МІ		1		1	0.015	1	MALUS 'JFS KW214MX'	IVORY SPEAR CRABAPPLE	BALL AND BURLAP
52+85.76	RT	35.68'	70	МІ		1		1	0.015	1	MALUS 'JFS KW214MX'	IVORY SPEAR CRABAPPLE	BALL AND BURLAP
53+11.71	LT	-39.33'	71	LS	1		1		0.015	1	LIQUIDAMBAR STYRACIFLUA	SWEET GUM	BALL AND BURLAP
53+13.97	RT	36.64'	72	МІ		1		1	0.015	1	MALUS 'JFS KW214MX'	IVORY SPEAR CRABAPPLE	BALL AND BURLAP
53+30.42	RT	36.69'	73	MI		1		1	0.015	1	MALUS 'JFS KW214MX'	IVORY SPEAR CRABAPPLE	BALL AND BURLAP
53+47.34	RT	36.35'	74	МІ		1		1	0.015	1	MALUS 'JFS KW214MX'	IVORY SPEAR CRABAPPLE	BALL AND BURLAP
53+58.75	LT	-38.94'	75	LS	1		1		0.015	1	LIQUIDAMBAR STYRACIFLUA	SWEET GUM	BALL AND BURLAP
54+40.30	LT	-37.90'	76	MI	1		1		0.015	1	LIQUIDAMBAR STYRACIFLUA	SWEET GUM	BALL AND BURLAP
54+89.59	LT	-38.00'	77	МІ	1		1		0.015	1	LIQUIDAMBAR STYRACIFLUA	SWEET GUM	BALL AND BURLAP
55+39.98	LT	-38.00'	78	МІ	1		1		0.015	1	LIQUIDAMBAR STYRACIFLUA	SWEET GUM	BALL AND BURLAP
	•		•	SUBTOTAL	9	11	9	11	0.30	20			





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NO.	DESCRIPTION	BY	DATE				

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CITY OF DUNKIRK

PROJECT NAME

LAKE SHORE DRIVE

DRAWING TITLE

LANDSCAPE TABLES

SCALE AS SHOWN	DATE JANUARY 2022
P.I.N. 5763.53	FEDERAL AID PROJECT NO.
SHEET NO.	DRAWING NO.
79 o f 94	LT - 03

1. SEE DRAWING LD-04 FOR WATERING VEGETATION REQUIREMENTS

file name = Date/Time = USER =

PLANT LIST: PLANTING ENLARGEMENT AREAS									
ITEM NO.	DESCRIPTION								
611.0442	PLANTING - DECIDUOUS SHRUBS - 2 FOOT HE	PLANTING - DECIDUOUS SHRUBS - 2 FOOT HEIGHT/SPREAD CONTAINER OR BOX GROWN							
611.0751	PLANTING - HERBACEOUS PLANTS - NUMBER	PLANTING - HERBACEOUS PLANTS - NUMBER 2 CONTAINER - CONTAINER GROWN							
611.19040024	POST PLANTING CARE WITH REPLACEMENT -	POST PLANTING CARE WITH REPLACEMENT - DECIDUOUS SHRUBS							
611.19070024	POST PLANTING CARE WITH REPLACEMENT -	HERBACEOUS PLANTS							
610.19	WATERING VEGETATION (PER APPLICATION)								
KEY	BOTANICAL NAME	COMMON NAME	611.0442 (EA)	611.0751 (EA)	611.19040024 (EA)	611.19070024 (EA)	610.19 (MGAL)		
ENLARGEMENT AREA 'A'	'	•			•				
HP	HEMEROCALLIS 'PARDON ME'	PARDON ME DAYLILLY		33.00		33.00	0.02		
NW	NEPTA X FAASSENII 'WALKER'S LOW'	WALKER'S LOW CATMINT		25.00		25.00	0.02		
RA	RHUS AROMATICA 'GRO- LOW'	GRO-LOW FRAGRANT SUMAC	17.00		17.00		0.54		
RO	ROSA CORAL DRIFT	CORAL DRIFT ROSE		11.00		11.00	0.23		
ENLARGEMENT AREA 'B'	•	<u> </u>			•	•	•		
HP	HEMEROCALLIS 'PARDON ME'	PARDON ME DAYLILLY		32.00		32.00	0.02		
NW	NEPTA X FAASSENII 'WALKER'S LOW'	WALKER'S LOW CATMINT		25.00		25.00	0.02		
RA	RHUS AROMATICA 'GRO- LOW'	GRO-LOW FRAGRANT SUMAC	8.00		8.00		0.12		
RO	ROSA CORAL DRIFT	CORAL DRIFT ROSE		14.00		14.00	0.37		
ENLARGEMENT AREA 'C'	·	·					•		
HP	HEMEROCALLIS 'PARDON ME'	PARDON ME DAYLILLY		33.00		33.00	0.02		
NW	NEPTA X FAASSENII 'WALKER'S LOW'	WALKER'S LOW CATMINT		24.00		24.00	0.01		
RA	RHUS AROMATICA 'GRO- LOW'	GROW-LOW FRAGRANT SUMAC	13.00		13.00		0.32		
RO	ROSA CORAL DRIFT	CORAL DRIFT ROSE		10.00		10.00	0.19		
SUBTOTAL			38.00	207.00	38.00	207.00	1.87		



1. SEE DRAWING LD-04 FOR WATERING VEGETATION REQUIREMENTS





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NO.	DESCRIPTION	BY	DATE				



CITY OF DUNKIRK


PROJECT NAME

LAKE SHORE DRIVE

DRAWING TITLE

LANDSCAPE TABLES

SCALE	DATE
AS SHOWN	JANUARY 2022
P.I.N.	FEDERAL AID PROJECT NO.
5763.53	
SHEET NO.	DRAWING NO.
80 or 94	LT-04

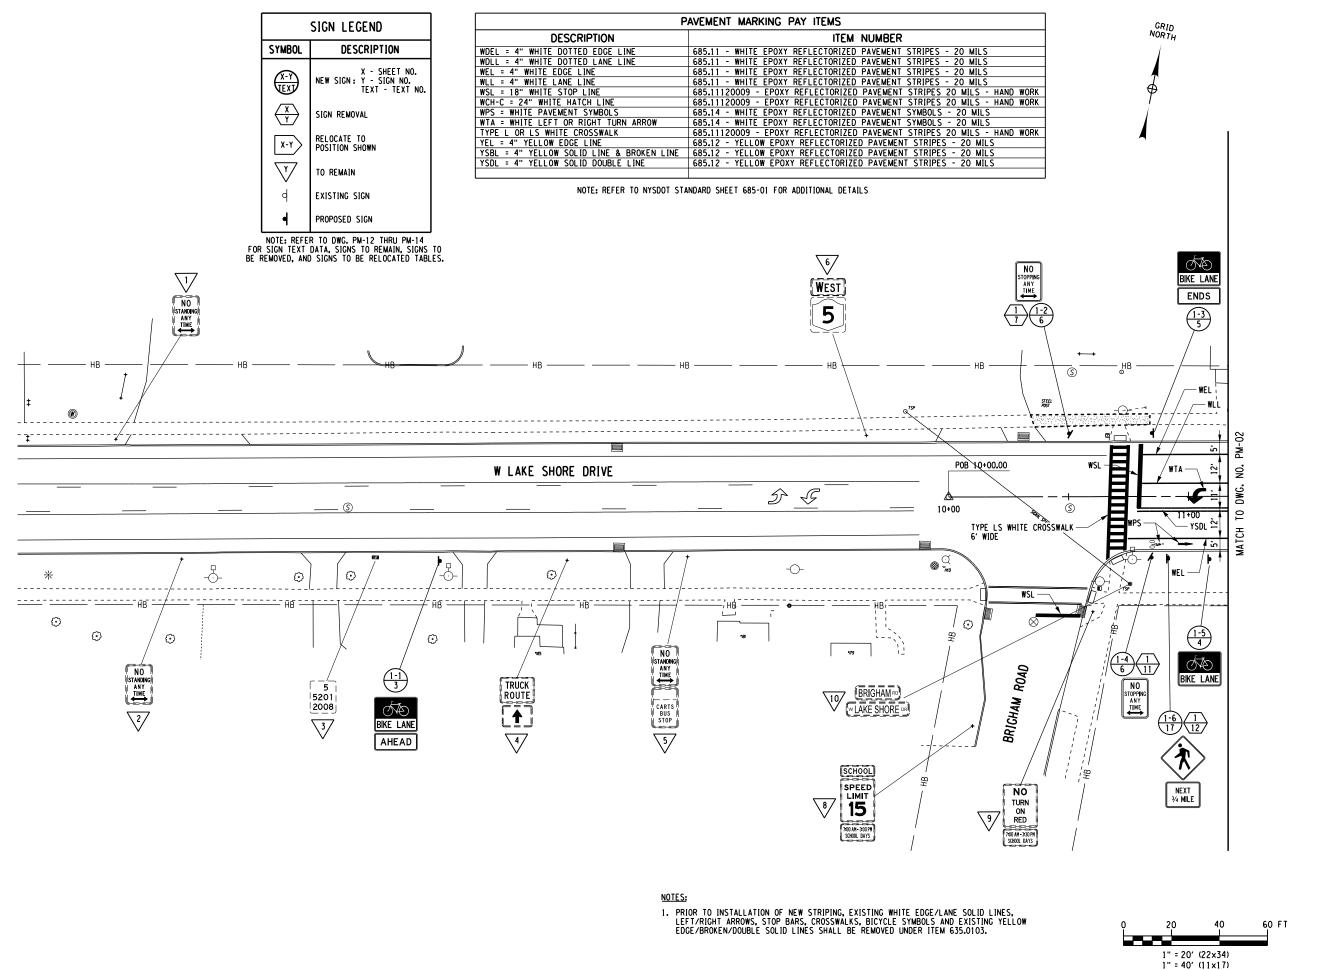

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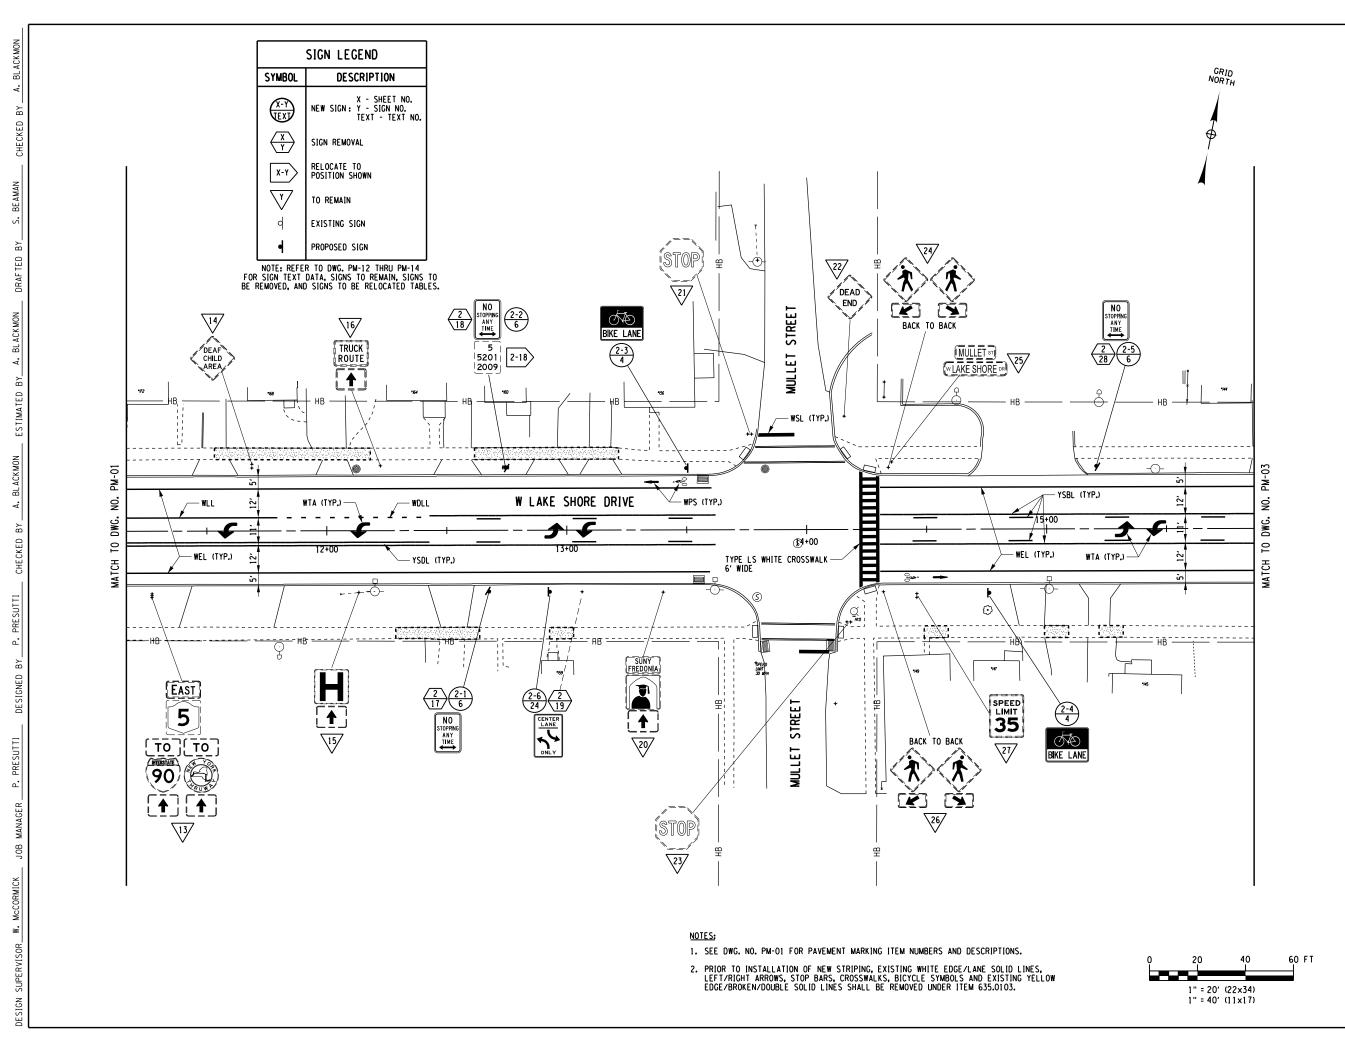


PROJECT NAME

LAKE SHORE DRIVE

DRAWING TITLE

SCALE 1" = 40'	DATE DECEMBER 2021
p.i.n. 5763.53	FEDERAL AID PROJECT NO.
SHEET NO.	DRAWING NO.
81 of 94	PM-01



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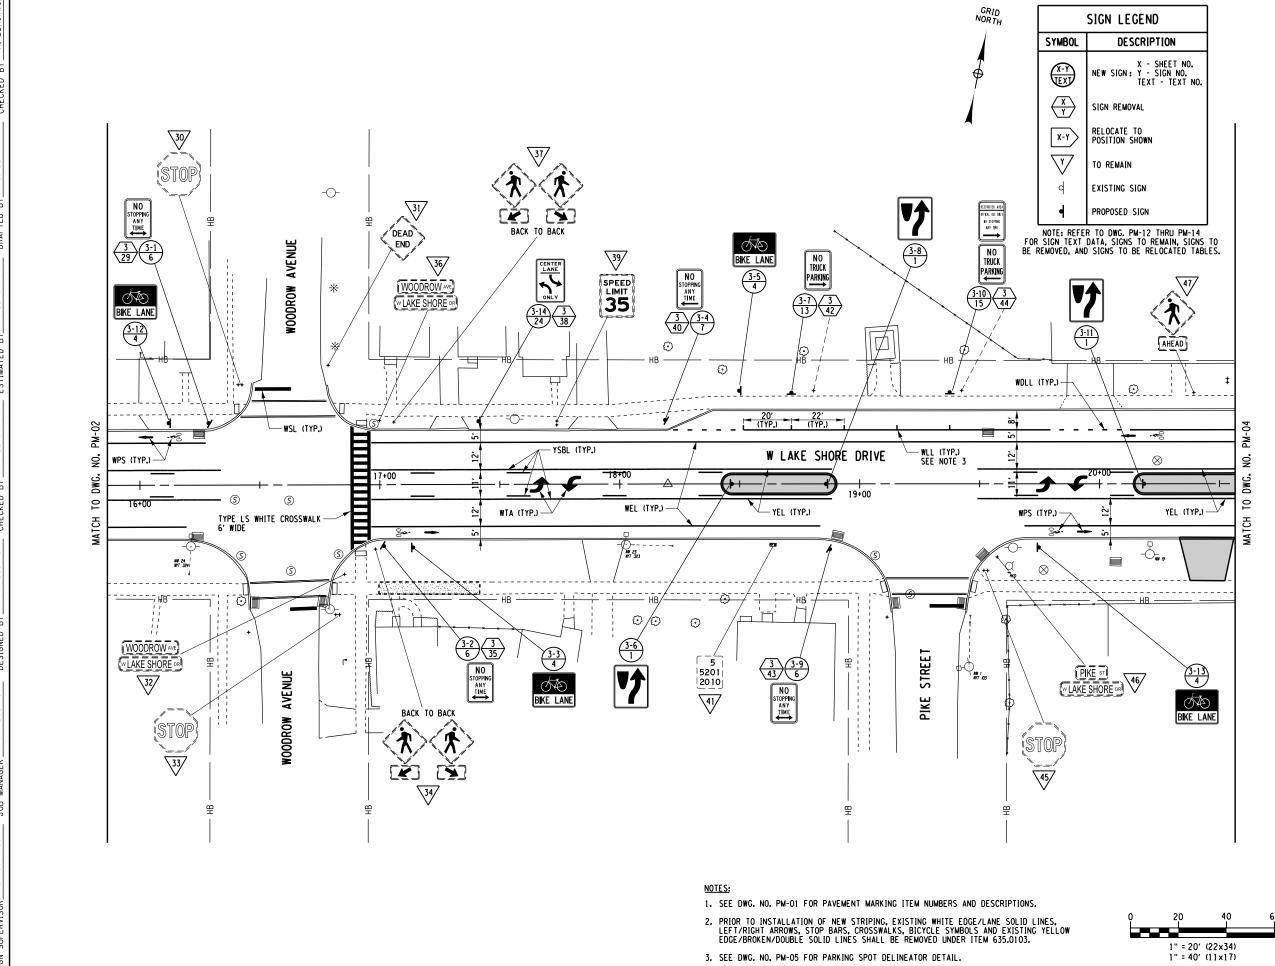
CITY OF DUNKIRK

PROJECT NAME

LAKE SHORE DRIVE

DRAWING TITLE

SCALE 1" = 40'	DECEMBER 2021	
p.l.n. 5763.53	FEDERAL AID PROJECT NO.	
SHEET NO.	DRAWING NO.	
82 or 94	PM-02	



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REVISIONS			
NO.	DESCRIPTION	BY	DATE



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PROJECT NAME

LAKE SHORE DRIVE

DRAWING TITLE


PAVEMENT MARKING AND SIGNING

SCALE 1" = 40'	DATE DECEMBER 2021
P.I.N. 5763.53	FEDERAL AID PROJECT NO.
SHEET NO.	DRAWING NO.
83 or 94	PM-03

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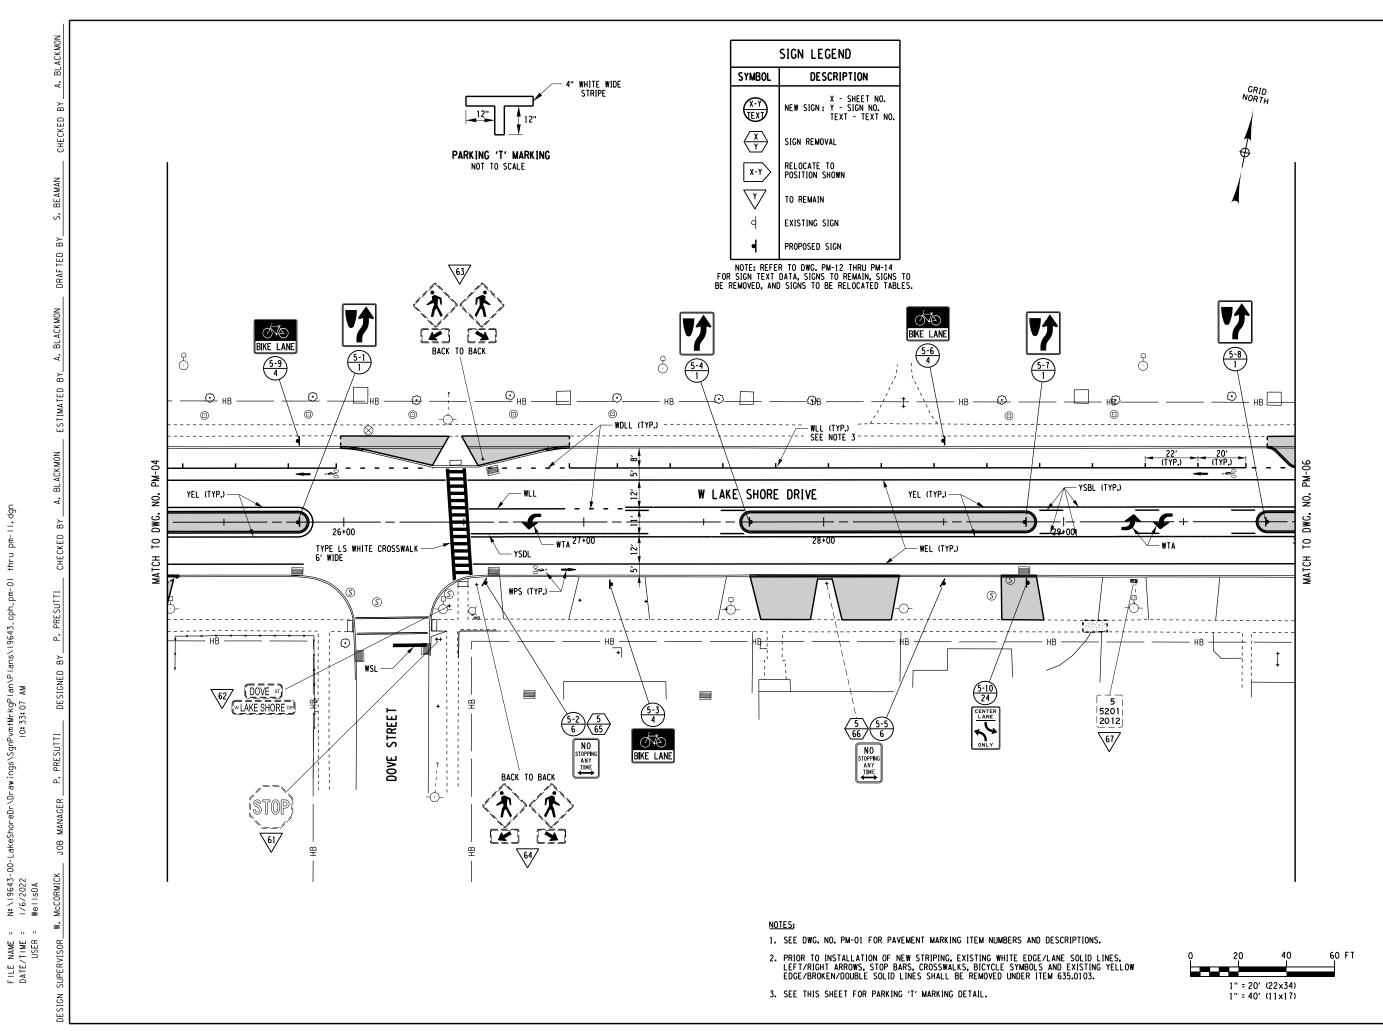


PROJECT NAME

LAKE SHORE DRIVE

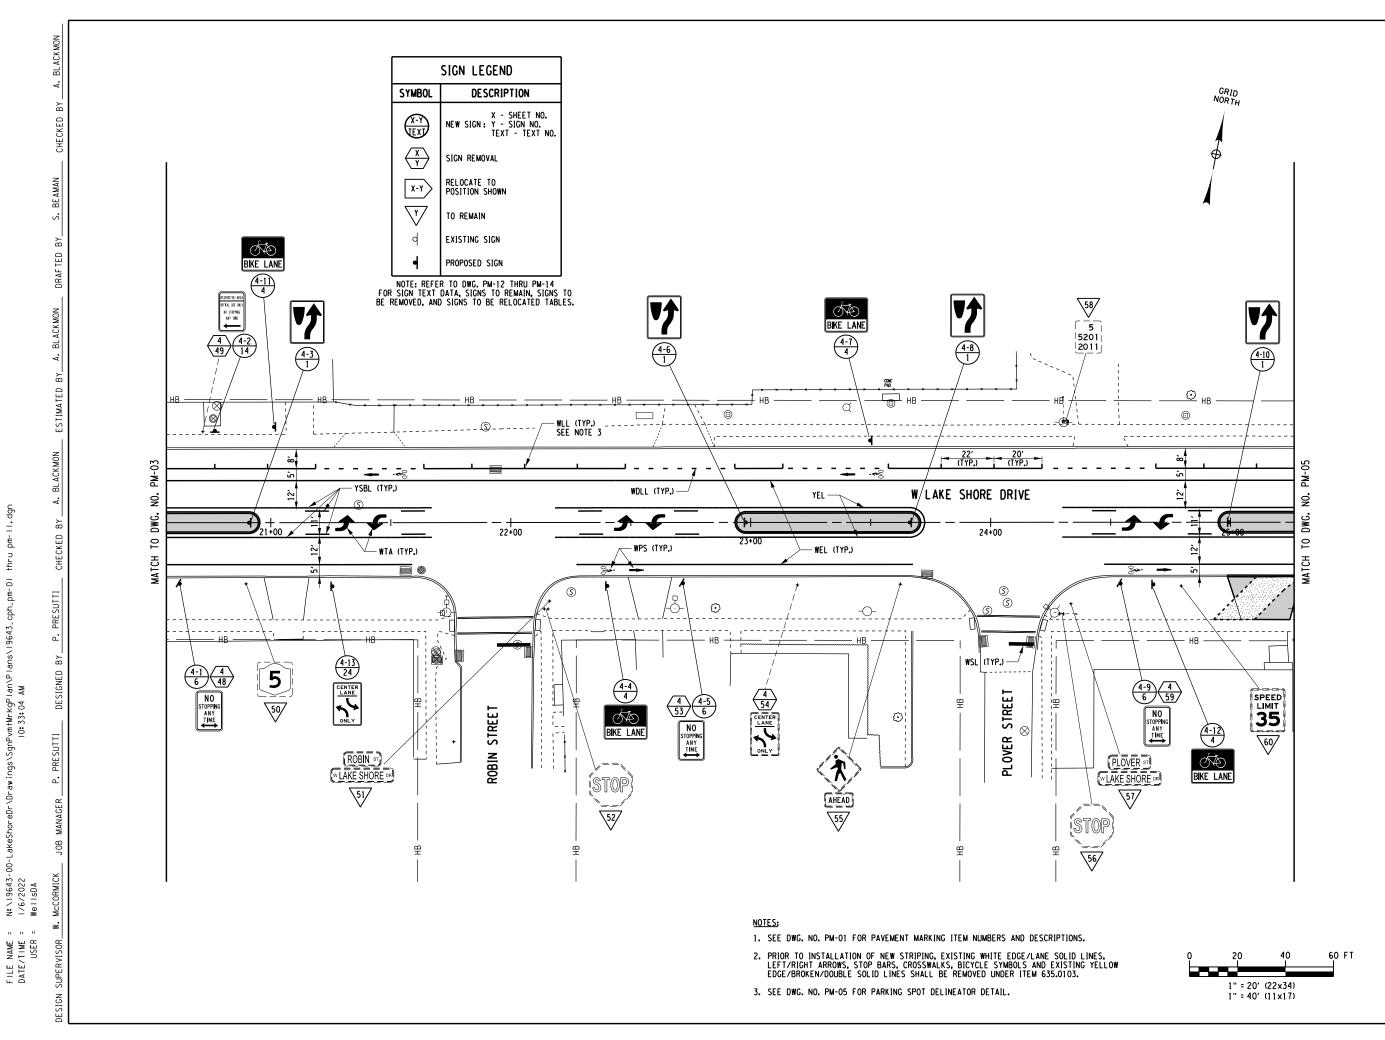DRAWING TITLE

scale 1" = 40'	DATE DECEMBER 2021
p.i.n. 5763.53	FEDERAL AID PROJECT NO.
SHEET NO.	DRAWING NO.
84 of 94	PM-04



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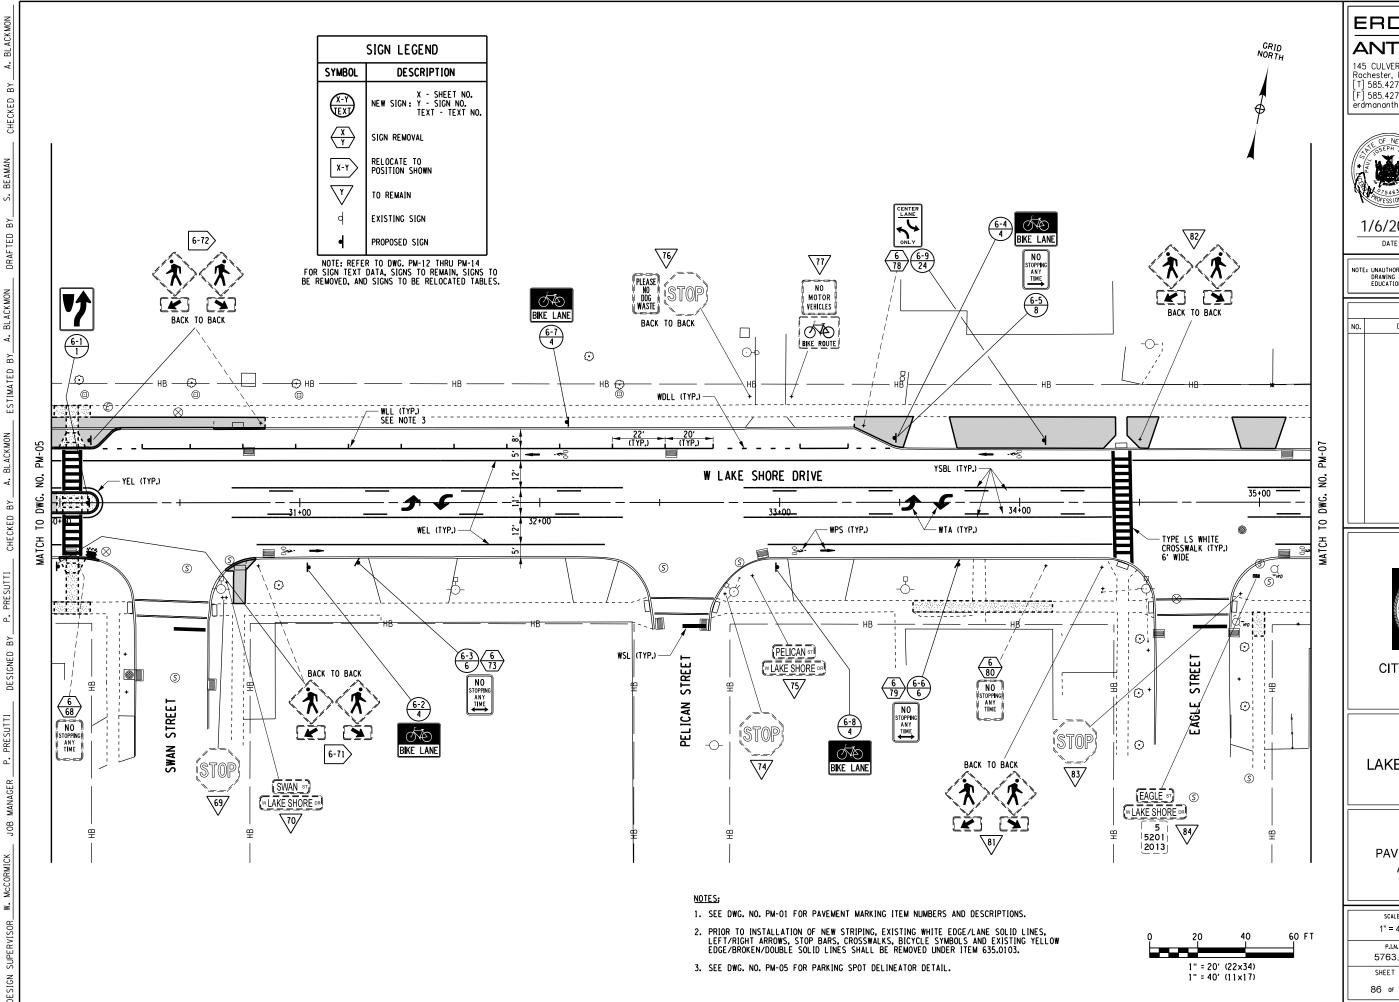


PROJECT NAME

LAKE SHORE DRIVE

DRAWING TITLE

SCALE	DATE
1" = 40'	DECEMBER 2021
p.i.n. 5763.53	FEDERAL AID PROJECT NO.
SHEET NO.	DRAWING NO.
85 or 94	PM-05



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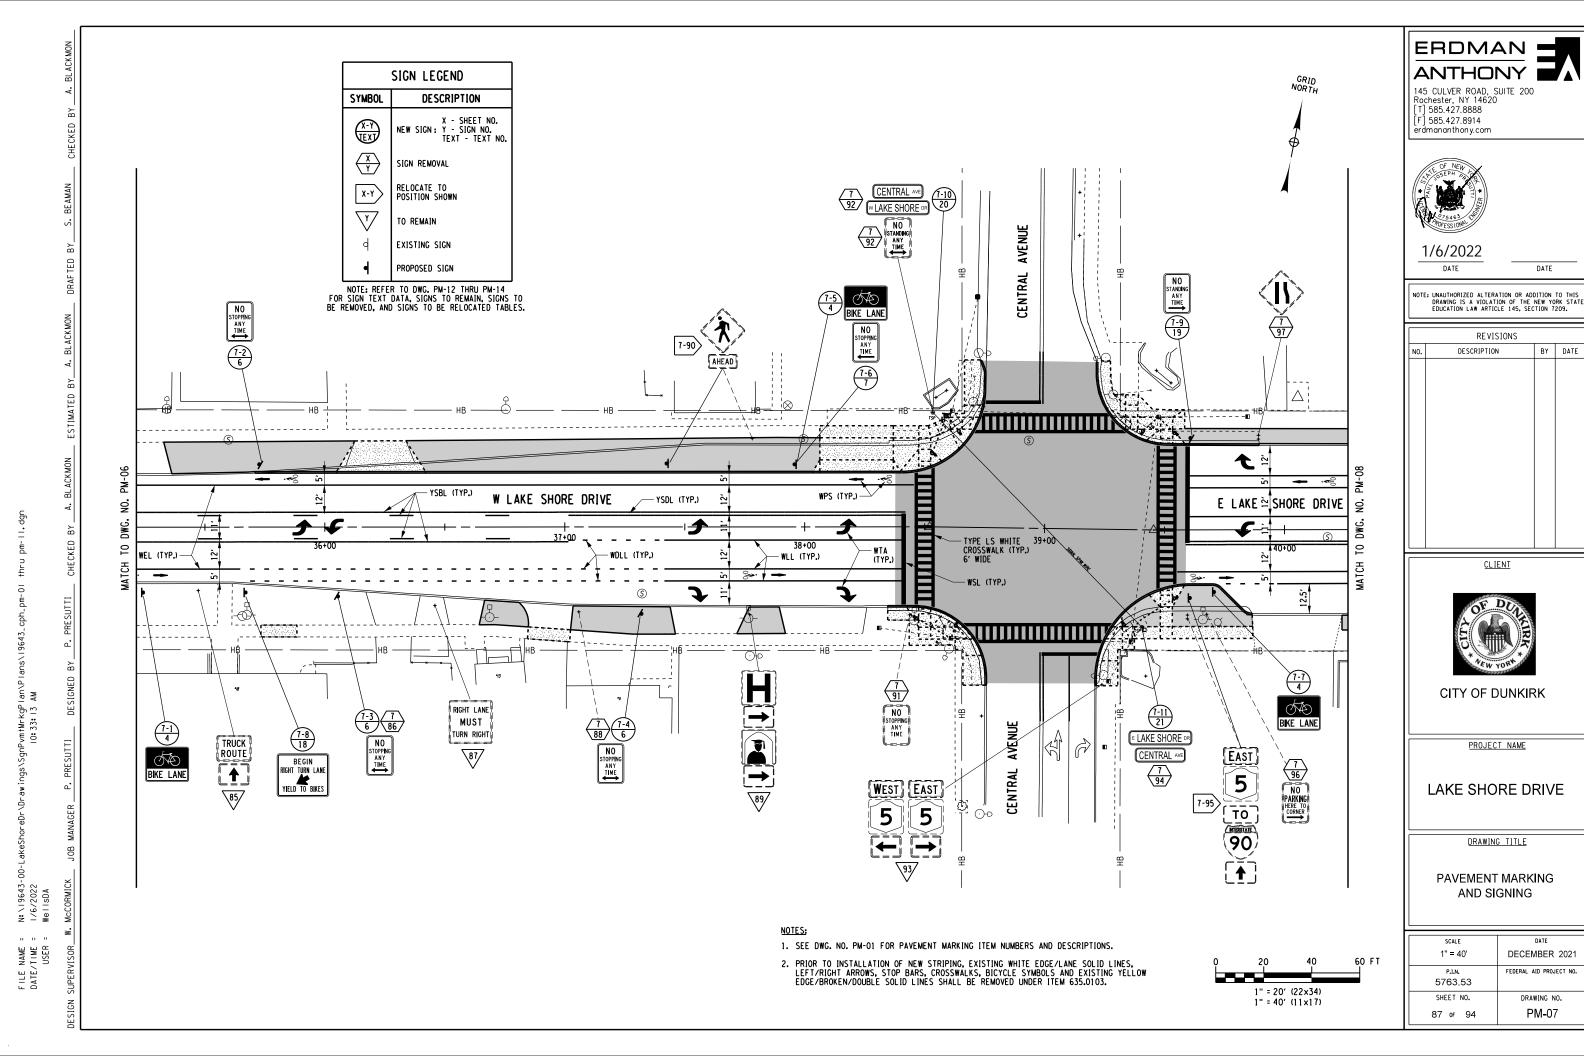


PROJECT NAME

LAKE SHORE DRIVE

DRAWING TITLE

SCALE	DATE
1" = 40'	DECEMBER 2021
P.1.N.	FEDERAL AID PROJECT NO.
5763.53	
SHEET NO.	DRAWING NO.
86 of 94	PM-06



DATE


BY DATE

DECEMBER 2021

FEDERAL AID PROJECT NO.

DRAWING NO.

PM-07

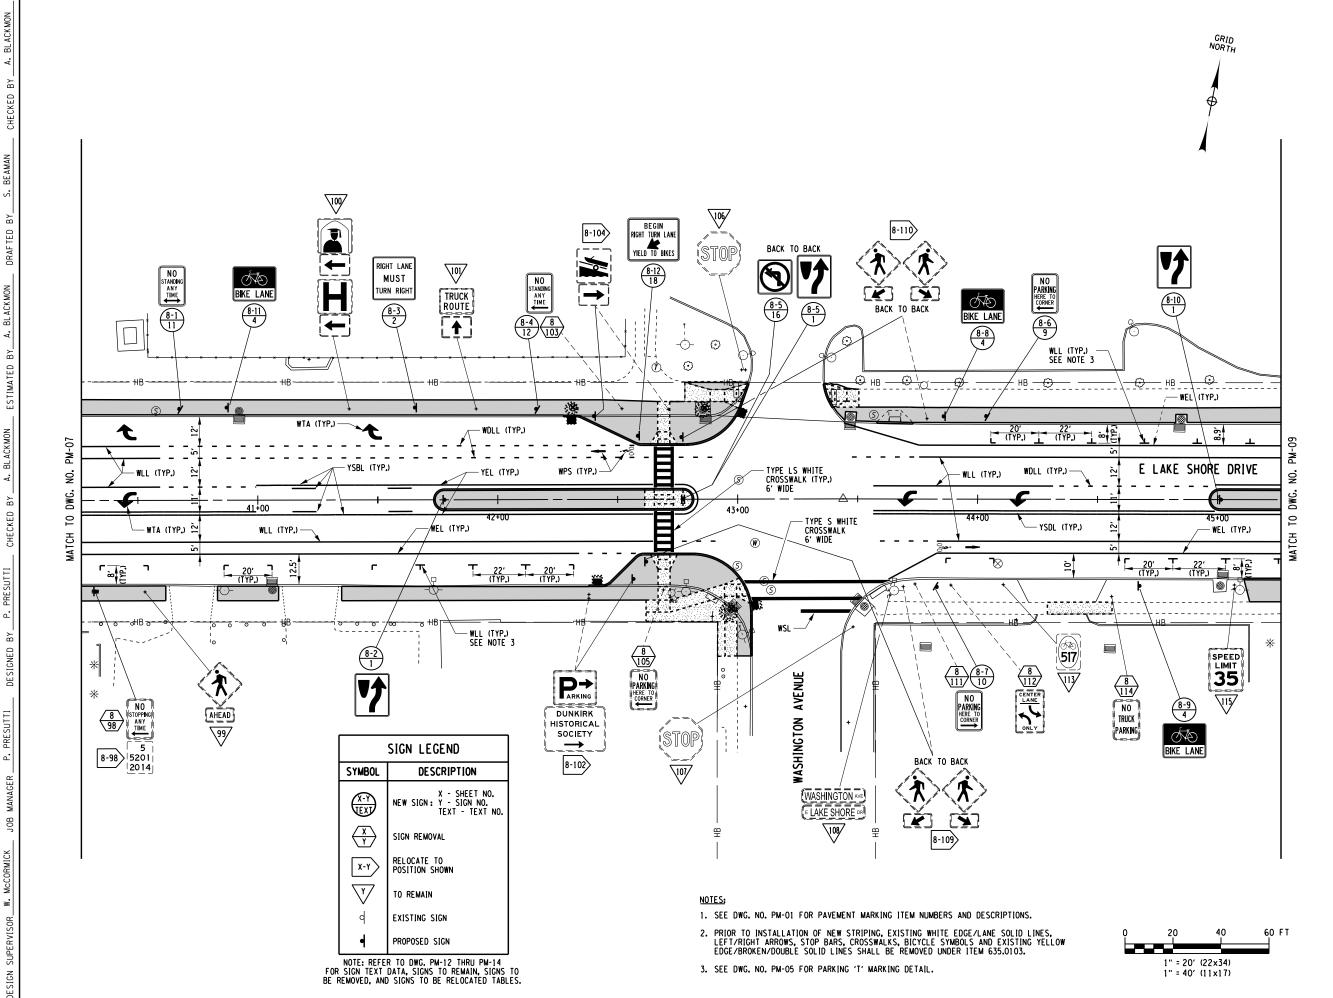

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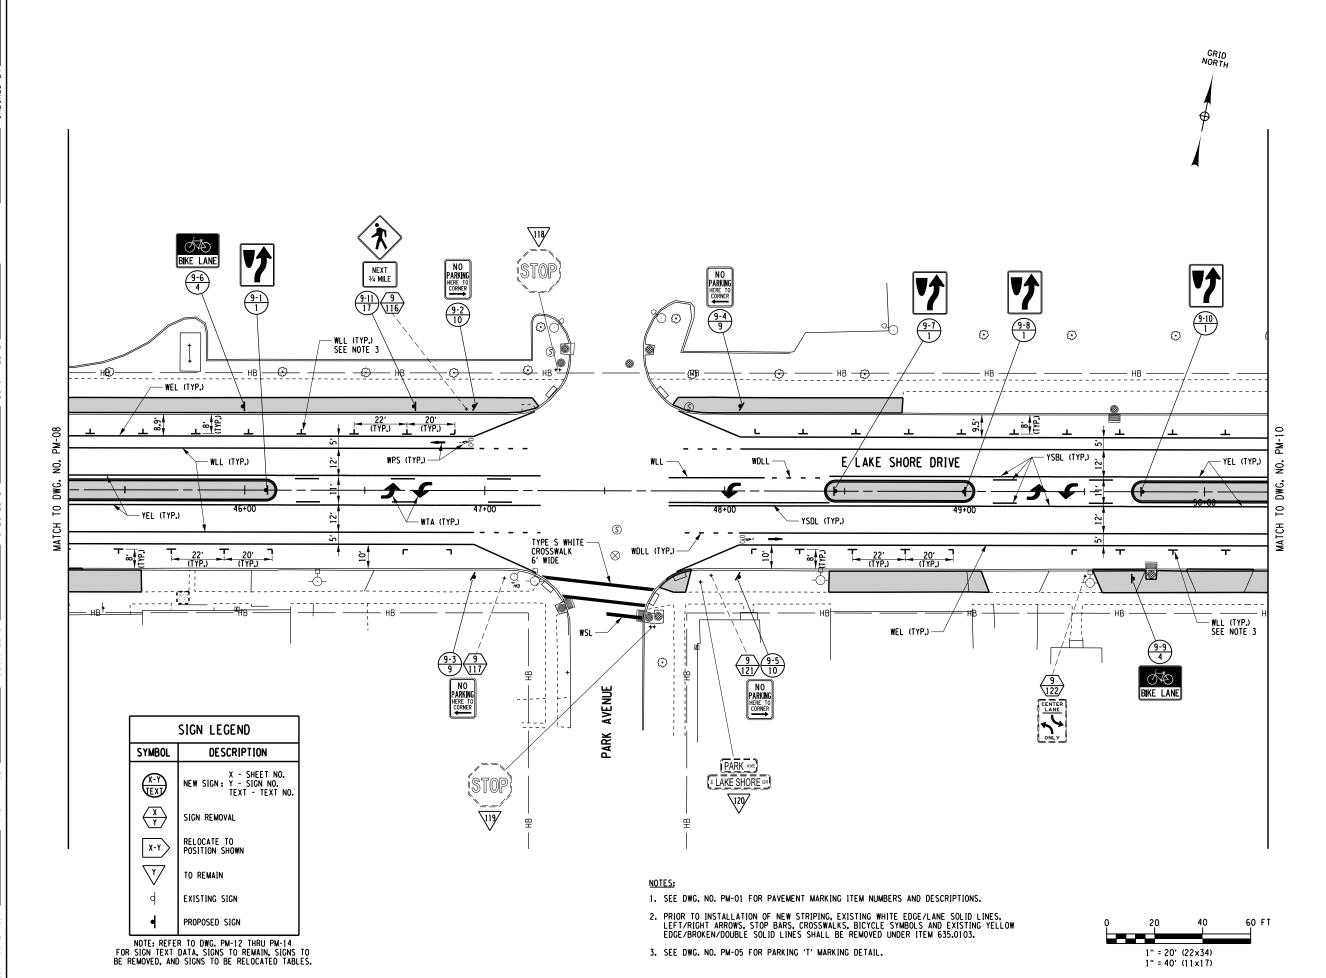


PROJECT NAME

LAKE SHORE DRIVE

DRAWING TITLE

SCALE 1" = 40'	DATE DECEMBER 2021
P.I.N. 5763.53	FEDERAL AID PROJECT NO.
SHEET NO.	DRAWING NO.
88 of 94	PM-08



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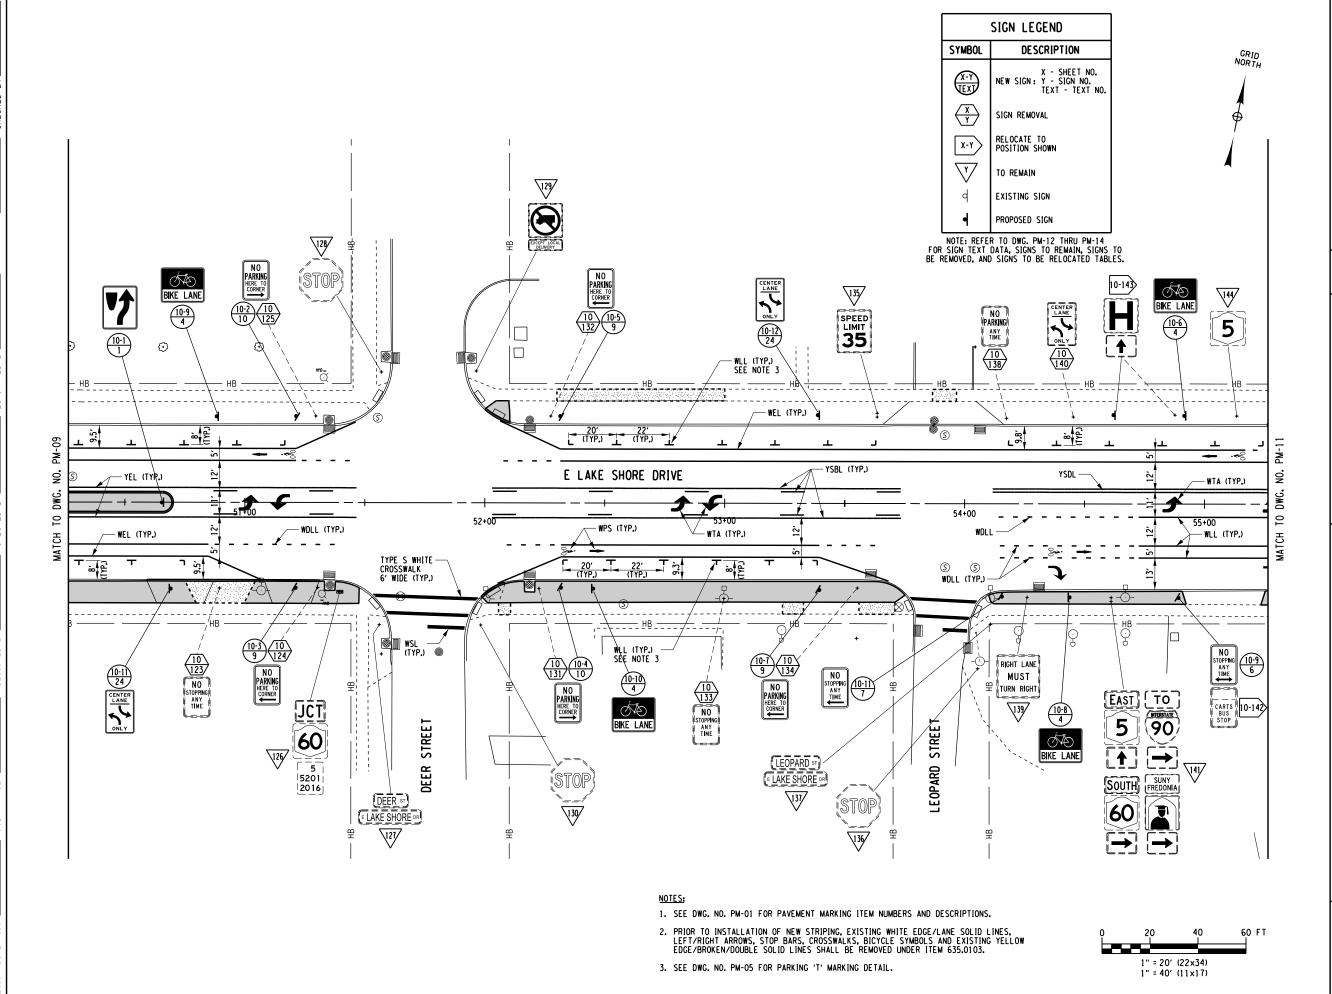


PROJECT NAME

LAKE SHORE DRIVE

DRAWING TITLE

SCALE	DATE
1" = 40'	DECEMBER 2021
p.i.n. 5763.53	FEDERAL AID PROJECT NO.
SHEET NO.	DRAWING NO.
89 or 94	PM-09



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	REVISIONS		
NO.	DESCRIPTION	BY	DATE




PROJECT NAME

LAKE SHORE DRIVE

DRAWING TITLE

scale 1" = 40'	DATE DECEMBER 2021
p.i.n. 5763.53	FEDERAL AID PROJECT NO.
SHEET NO.	DRAWING NO.
90 of 94	PM-10

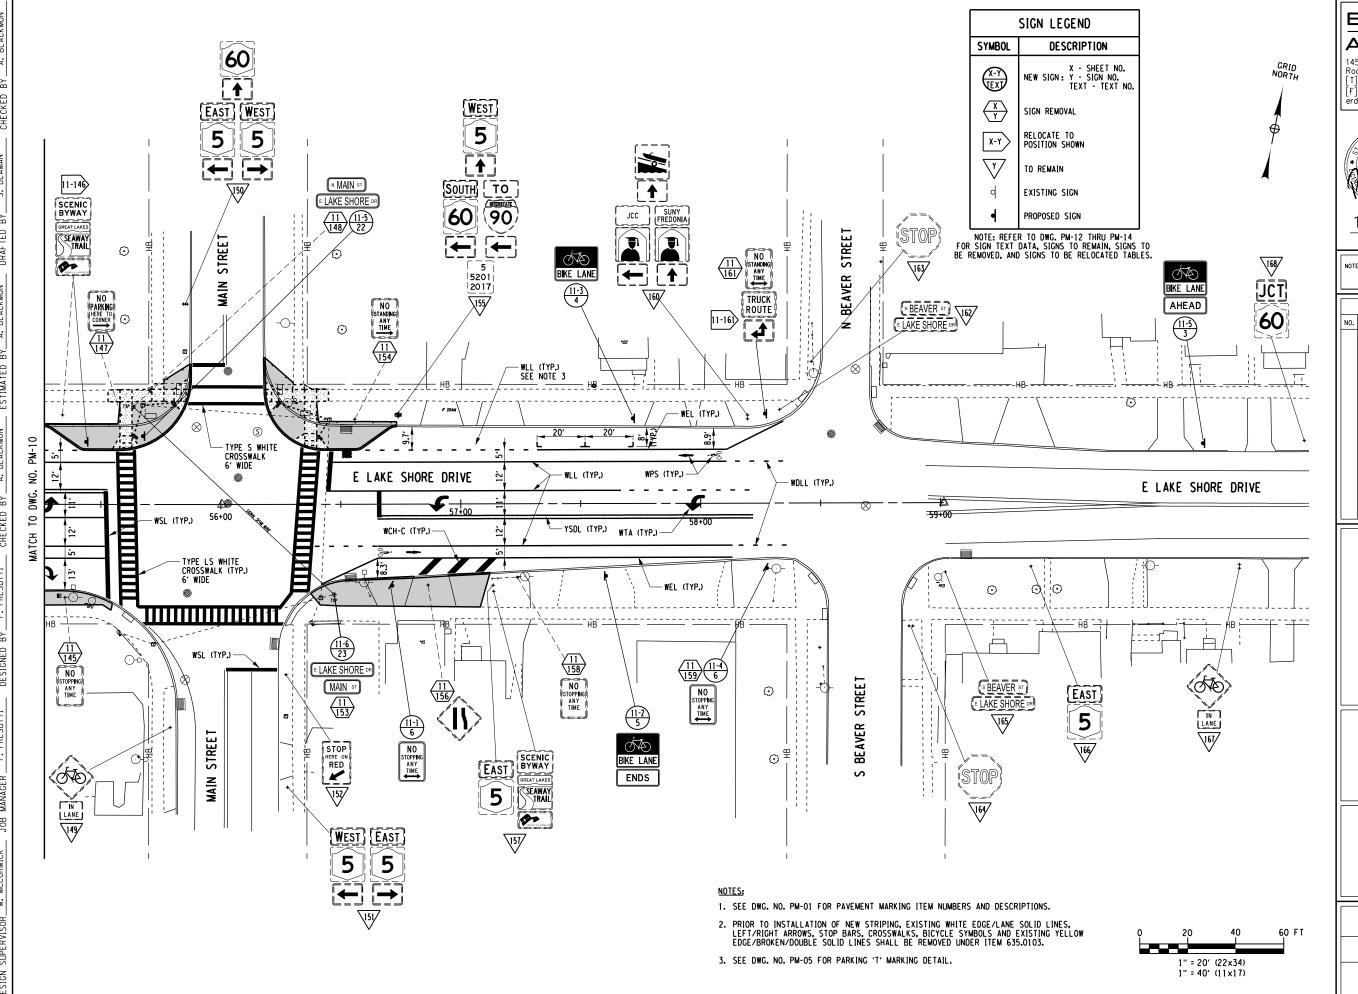

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USER

ERDMAN
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145 CULVER ROAD, SUITE 200
Rochester, NY 14620
[T] 585.427.8888

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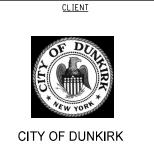


1/6/2022 DATE

DATE

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	REVISIONS						
NO.	DESCRIPTION	ВҮ	DATE				



PROJECT NAME

LAKE SHORE DRIVE

DRAWING TITLE

SCALE	DATE
1" = 40'	DECEMBER 2021
p.i.n. 5763.53	FEDERAL AID PROJECT NO.
SHEET NO.	DRAWING NO.
91 or 94	PM-11

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TEXT Number

LOCATION NUMBER

ITEM NUMBER

7707/11/1	beamans	
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	3-6, 3-8, 3-11, 4-3, 4-6, 4-8, 4-10, 5-1, 5-4, 5-7, 5-8, 6-1,	645.5102	5.00 SF	100 . 00 SF		R4-7	GR MTD
	8-2, 8-5, 8-10, 9-1, 9-7, 9-8, 9-10, 10-1	645.81	1 EA	20 EA		24" x 30"	GR MID
2	8-3	645.5102	2.25 SF	2.25 SF	RIGHT LANE MUST	R3-7R	GR MTD
	1	645.81	1 EA	1 EA	TURN RIGHT	30" × 30"	OK WITD
3	1-1, 11-5	645.5102	4.33 SF	8.66 SF	OVA DIVE LANG	R3-17 24" × 18"	GR MTD
	2	645.81	1 EA	2 EA	BIKE LANE AHEAD	R3-17aP 24" × 8"	GIV MID
4	1-5, 2-3, 2-4, 3-3, 3-5, 3-12, 3-13, 4-4, 4-7, 4-11, 4-12, 5-3, 5-6, 5-9, 6-2, 6-4, 6-7, 6-8,	645.5102	3.00 SF	93.00 SF	(NA)	R3-17	GR MTD
	7-1, 7-5, 7-7, 8-8, 8-9, 8-11, 9-6, 9-9, 10-6, 10-8, 10-9, 10-10, 11-3	645.81	1 EA	31 EA	BIKE LANE	24" x 18"	GR MID
5	1-3, 11-2	645.5102	4.33 SF	8.66 SF	BIKE LANE	R3-17 24" × 18"	GR MTD
	2	645.81	1 EA	2 EA	ENDS	R3-17aP 24" × 8"	OIV WID
6	1-2, 1-4, 2-1, 2-2, 2-5, 3-1, 3-2, 3-9, 4-1, 4-5, 4-9, 5-2, 5-5, 6-3,	645.5101	1.50 SF	31 . 50 SF	NO STOPPING	NYP1-7	GR MTD
	6-6, 7-2, 7-3, 7-4, 10-9, 11-1, 11-4	645.81	1 EA	21 EA	ANY TIME	12" × 18"	OK MID
7	3-4, •7-6, 10-11	645.5101	1.50 SF	4.50 SF	NO STOPPING	NYP1-7L	GR MTD
, 	• NO POST 3	645.81	1 EA	2 EA	ANY TIME	12" × 18"	OK WID
8	* 6-5	645.5101	1.50 SF	1,50 SF	NO STOPPING	NYP1-7R	GR MTD
	* NO POST 1	645.81	-	-	ANY	12" × 18"	GIV WITD
9	8-6, 9-3, 9-4, 10-3,	645.5101	1.50 SF	9.00 SF	N O Parking	NYP1-9L	GR MTD
J	10-5, 10-7	645.81	1 EA	6 EA	PARKING HERE TO CORNER	12" × 18"	ON MID
10	8-7, 9-2, 9-5, 10-2, 10-4,	645.5101	1.50 SF	7.50 SF	N O PARKING	NYP1-9R	00 1170
		645.81	1 EA	5 EA	PARKING HERE TO CORNER	12" × 18"	GR MTD
11	8-1	645.5101	1.50 SF	1.50 SF	NO STANDING	R7-4 12" × 18"	GR MTD
	1	645.81	1 EA	1 EA	ANY TIME	12" × 18"	UN MID
						<u> </u>	

SIGN TEXT DATA

TOTAL QUANTITY

MUTCD Number

MOUNT

TEXT

PAYMENT FACTOR

TEXT NUMBER	LOCATION NUMBER	ITEM NUMBER	PAYMENT FACTOR	TOTAL QUANTITY	TEXT	MUTCD Number	MOUNT	
	8-4	645,5101	1.50 SF	1.50 SF	NO STANDING	R7-4L	OD MTD	
12	0-4	645.81	1 EA	1 EA	ANY TIME	12" × 18"	GR MTD	
13	3-7	645.5101	1.50 SF	1.50 SF	NO Truck	NYP1-15R (MOD.)	GR MTD	
15	1	645.81	1 EA	1 EA	PARKING	12" × 18"	OK WID	
14	4-2	645,5101	1.50 SF	1.50 SF	RESTRICTED AREA OFFICAL DSE ONLY NO STOPPING	NYP1-8L (MOD.)	GR MITD	
	1	645.81	1 EA	1 EA	ANY TINE	12" × 18"	ON WID	
15	3-10	645,5101	3.00 SF	3.00 SF	PERMITTER AND GOILE, WILL GO. W. ST. STOPPE AND TOTAL AND TOTAL	NYP1-8R (MOD.) 12" × 18"	GR MITD	
15	1	645.81	1 EA	1 EA	NO TRUCK PARKING	NYP1-15L (MOD.) 12" × 18"	ON WID	
16 -0.5	16	•8-5	645.5102	2.25 SF	2.25 SF		R3-2	GR MTD
	• NO POST 1	645.81	-	-		30" × 30"		
17	1-6, 9-11	645.5102	9.25 SF	18.50 SF		W11-2L 30" x 30"	GR MITD	
	2	645.81	2 EA	2 EA	NEXT 3/4 MILE	₩7-3aP 24" × 18"		
18	7-8, 8-12	645,5102	7.50 SF	15.00 SF	BEGIN RIGHT TURN LANE	R4-4	GR MITD	
. 0	2	645.81	2 EA	2 EA	YIELD TO BIKES	36" × 30"		
19	7-9	645,5101	1.50 SF	1.50 SF	NO STANDING	R7-4R	GR MITD	
	1	645.81	1 EA	1 EA	ANY	12" × 18"		
20	7-10	645,5102	20.00 SF	20.00 SF	CENTRAL AVE	(2) 48 × 12" D3-1	POLE MT	
	1	645.85	2 EA	2 EA	W LAKE SHORE DR	D3-1 (2) 72" x 12" (SEE NOTE 4)		
21	7-11	645.5102	19.00 SF	19.00 SF	E LAKE SHORE DR	(2) 72 x 12"	POLE MT	
-1	7-11	645.85	2 EA	2 EA	CENTRAL AVE	(2) 72 x 12" D3-1 (2) 42" x 12" (SEE NOTE 4)	I OLE MI	

SIGNING NOTES:

- SIGN LOCATIONS AS SHOWN ON PLANS ARE APPROXIMATE. THE CONTRACTOR SHALL INSTALL NEW SIGNS AND RELOCATE EXISTING SIGNS IN ACCORDANCE WITH THE MUTCD AND NYS SUPPLEMENT.
- 2. THE COLOR IS ONLY SHOWN WHEN THERE IS AN OPTION THAT MUST BE SPECIFIED.
- 3. THE AREA AND PAYMENT AREA FOR SIGNS ARE FROM THE APPLICABLE STANDARD SHEETS OR SIGN FACE LAYOUTS.

4. ALL STREET SIGNS SHALL HAVE BLUE BACKGROUND AND WHITE FOR LETTERS.



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NO.	DESCRIPTION	BY	DATE

CLIENT



CITY OF DUNKIRK

PROJECT NAME

LAKE SHORE DRIVE

DRAWING TITLE

PAVEMENT MARKING AND SIGNING

SIGN FACE DATA

SCALE	DATE
NONE	DECEMBER 2021
P.I.N. 5763.53	FEDERAL AID PROJECT NO.
SHEET NO.	DRAWING NO.
92 of 94	PM-12

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			SIGN TEX	KT DATA			
TEXT NUMBER	LOCATION NUMBER	ITEM NUMBER	PAYMENT FACTOR	TOTAL QUANTITY	TEXT	MUTCD NUMBER	MOUNT
22	11-5	645.5102	19.00 SF	19 . 00 SF	N MAIN ST	(2) 42 × 12" D3-1	POLE MTD
	11 3	645.85	2 EA	2 EA	E LAKE SHORE DR	(2) 72" × 12" (SEE NOTE 4)	FULE MID
23	11-6	645.5102	18.00 SF	18.00 SF	E LAKE SHORE DR	(2) 72 x 12" D3-1 POLE MTD	
	25 11-6	645.85	2 EA	2 EA	MAIN ST	(2) 36" × 12" (SEE NOTE 4)	FOLE MID
24	2-6, 3-14, 4-13, 5-10,	645.5102	6.00 SF	42.00 SF	CENTER LANE	R3-9b	GR MTD
27	6-9, 10-11, 10-12	645.81	1 EA	7 EA	ONLY	24" × 36"	GR MID
25							
25					1		
	<u> </u>		1	ı	1	I	

SIGNING NOTES:

SIGN LOCATIONS AS SHOWN ON PLANS ARE APPROXIMATE. THE CONTRACTOR SHALL INSTALL NEW SIGNS AND RELOCATE EXISTING SIGNS IN ACCORDANCE WITH THE MUTCD AND NYS SUPPLEMENT.

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4. ALL STREET SIGNS SHALL HAVE BLUE BACKGROUND AND WHITE FOR LETTERS.

	SIGN RELOCATION TABLE					
ID#	STATION	SIDE	DESCRIPTION	ITEM 645.81 (EA)	ITEM 647.31 (EA)	
2-18	12+75	LT	REFERENCE MARKER: 5 / 5201 / 2009		1	
6-71	30+00	RT	PEDESTRIAN CROSSING / LEFT DIAGIONAL DOWN ARROW PEDESTRIAN CROSSING / RIGHT DIAGIONAL DOWN ARROW	1	1	
6-72	30+15	LT	PEDESTRIAN CROSSING / LEFT DIAGIONAL DOWN ARROW PEDESTRIAN CROSSING / RIGHT DIAGIONAL DOWN ARROW	1	1	
7-90	37+44	LT	PEDESTRIAN CROSSING / AHEAD	1	1	
7-95	39+60	RT	EAST / STATE ROUTE 5 TO / INTERSTATE ROUTE 90 / STRAIGHT UP ARROW	1	1	
8-98	40+33	RT	REFERENCE MARKER: 5 / 5201 / 2014	1	1	
8-102	42+56	RT	PARKING RIGHT ARROW / DUNKIRK HISTORY SOCIETY (RIGHT ARROW)	1	1	
8-104	42+50	LT	BOAT RAMP / RIGHT ARROW	1	1	
8-109	42+62	RT	PEDESTRIAN CROSSING / LEFT DIAGIONAL DOWN ARROW PEDESTRIAN CROSSING / RIGHT DIAGIONAL DOWN ARROW	1	1	
8-110	42+77	LT	PEDESTRIAN CROSSING / LEFT DIAGIONAL DOWN ARROW PEDESTRIAN CROSSING / RIGHT DIAGIONAL DOWN ARROW	1	1	
10-142	54+90	RT	CARTS BUS STOP		1	
10-143	54+63	LT	HOSPITAL / STRAIGHT UP ARROW	1	1	
11-146	55+45	LT	SCENIC BYWAY / SEAWAY TRAIL / AMERICA'S BYWAYS	1	1	
11-161	58+28	LT	TRUCK ROUTE / STRAIGHT UP - LEFT ARROWS	1	1	
			TOTAL	12	14	

EXISTING LOCATIONS SHOWN. REFER TO SPM DRAWINGS FOR NEW LOCATIONS. ITEM 645.81 - TYPE A SIGN POSTS ITEM 647.31 - RELOCATE SIGN PANEL, SIGN PANEL ASSEMBLY SIZE I (UNDER 30 SQUARE FEET)

ID#	STATION	SIDE	DESCRIPTION	ITEM 647 (EA)
1-7	10+50	LT	NO STOPPING ANY TIME	1
1-11	10+85	RT	NO STOPPING ANY TIME	1
1-12	10+92	RT	PEDESTRIAN CROSSING / NEXT 1/2 MILE	1
2-17	12+68	RT	NO STOPPING ANY TIME	1
2-18	12+75	LT	NO STOPPING ANY TIME	1
2-19	13+06	RT	CENTER LANE (2 LEFT ARROWS) ONLY	1
2-28	15+21	LT	NO STOPPING ANY TIME	1
3-29	16+29	LT	NO STOPPING ANY TIME	1
3-35	17+02	RT	NO STOPPING ANY TIME	1
3-38	17+41	LT	CENTER LANE (2 LEFT ARROWS) ONLY	1
3-40	18+19	LT	NO STOPPING ANY TIME	1
3-42	18+81	LT	NO TRUCK PARKING (RIGHT ARROW)	1
3-43	18+88	RT	NO STOPPING ANY TIME	1
244	40 : 42		RESTRICTED AREA - OFFICAL USE ONLY	4
3-44	19+43	LT	NO TRUCK PARKING (LEFT ARROW)	1
4-48	20+62	RT	NO STOPPING ANY TIME	1
4-49	20+72	LT	NO TRUCK PARKING (RIGHT ARROW)	1
4-53	22+72	RT	NO STOPPING ANY TIME	1
4-54	23+19	RT	CENTER LANE (2 LEFT ARROWS) ONLY	1
4-59	24+54	RT	NO STOPPING ANY TIME	1
5-65	26+59	RT	NO STOPPING ANY TIME	1
5-66	28+01	RT	NO STOPPING ANY TIME	1
6-68	30+08	RT	NO STOPPING ANY TIME	1
6-73	31+24	RT	NO STOPPING ANY TIME	1
6-78	33+35	LT	CENTER LANE (2 LEFT ARROWS) ONLY	1
6-79	33+74	RT	NO STOPPING ANY TIME	1
6-80	34+11	RT	NO STOPPING ANY TIME	1
7-86	36+05	RT	NO STOPPING ANY TIME	1
7-88	37+06	RT	NO STOPPING ANY TIME	1
7-91	38+44	RT	NO STOPPING ANY TIME	1
			STREET SIGN: CENTRAL AVE / W LAKE SHORE DR	+
7-92	38+53	LT	NO STOPPING ANY TIME	1
7-94	39+41	RT	STREET SIGN: CENTRAL AVE	1
7-96	39+67	RT	NO PARKING HERE TO CORNER (RIGHT ARROW)	1
7-97	39+89	LT	RIGHT LANE ENDS	1
8-98	40+32	RT	NO STOPPING ANY TIME (LEFT ARROW)	1
B-103	42+52	LT	NO STANDING ANY TIME (LEFT ARROW)	1
8-105	42+69	RT	NO PARKING HERE TO CORNER (LEFT ARROW)	1
8-111	43+74	RT	NO PARKING HERE TO CORNER (RIGHT ARROW)	1
B-112	43+89	RT	CENTER LANE (2 LEFT ARROWS) ONLY	1
8-114	44+56	RT	NO TRUCK PARKING	1
9-116	46+92	LT	PEDESTRIAN CROSSING / NEXT 1/2 MILE	1
9-117	47+08	RT	NO PARKING HERE TO CORNER (LEFT ARROW)	1
9-117	47+94	RT	NO PARKING HERE TO CORNER (RIGHT ARROW)	1
9-121	49+50	RT	CENTER LANE (2 LEFT ARROWS) ONLY	1
0-123	50+90	RT	NO STOPPING ANY TIME	1
0-123	51+30	RT	NO PARKING HERE TO CORNER (LEFT ARROW)	1
0-124	51+30	LT	NO PARKING HERE TO CORNER (RIGHT ARROW)	1
0-123	52+23	RT	NO PARKING HERE TO CORNER (RIGHT ARROW)	1
0-131	52+23	LT	NO PARKING HERE TO CORNER (KIGHT ARROW)	1
0-132	53+00	RT	NO STOPPING ANY TIME	1
0-133	53+55	RT	NO PARKING HERE TO CORNER (LEFT ARROW)	1
0-134	53+55		NO PARKING HERE TO CORNER (LEFT ARROW) NO PARKING ANY TIME	
0-136	54+17	LT LT	CENTER LANE (2 LEFT ARROWS) ONLY	1
1-145	55+35	RT	NO STOPPING ANY TIME	1
1-145	55+58	LT	NO PARKING HERE TO CORNER (RIGHT ARROW)	1
1-147	55+64		STREET SIGN: MAIN ST / E LAKE SHORE DR	1
		LT		
1-153	56+47	RT	STREET SIGN: MAIN ST	1
1-154	56+56	LT	NO STANDING ANY TIME (RIGHT ARROW)	1
1-156	56+86	RT	RIGHT LANE ENDS	1
1-158	57+23	RT	NO STOPPING ANY TIME	1
1-159	58+27	RT	NO STOPPING ANY TIME	1
11-161	58+27	LT	NO STOPPING ANY TIME (DOUBLE ARROWS)	1

ITEM 647.61 - REMOVE AND DISPOSE GROUND MOUNTED TYPE A SIGN SUPPORT(S), FDNS AND ANY ATTACHED SIGNS - SIZE I (UNDER 30 SQUARE FEET)



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CITY OF DUNKIRK

PROJECT NAME

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DRAWING TITLE

PAVEMENT MARKING AND SIGNING

SIGN FACE DATA

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P.I.N. 5763.53	FEDERAL AID PROJECT NO.
SHEET NO.	DRAWING NO.
93 of 94	PM-13

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SIGN NO.	DESCRIPTION
1	NO STANDING ANY TIME (DOUBLE ARROWS)
2	NO STANDING ANY TIME (DOUBLE ARROWS)
3	REFERENCE MARKER: 5 / 5201 / 2008
4	TRUCK ROUTE / STRAIGHT UP ARROW
5	NO STANDING ANY TIME (DOUBLE ARROWS) / BUS STOP
6 8	WEST / STATE ROUTE 5 SCHOOL / SPEED LIMIT 15 / RESTRICTIVE HOURS
9	NO TURN ON RED / RESTRICTIVE HOURS
10	STREET SIGN: BRIGHAM RD / W LAKE SHORE DR
	EAST / STATE ROUTE 5
13	TO / INTERSTATE 90 / STRAIGHT UP ARROW
	TO / THRUWAY / STRAIGHT UP ARROW
14	DEAF CHILD AREA
15 16	HOSPITAL / STRAIGHT UP ARROW TRUCK ROUTE / STRAIGHT UP ARROW
20	SUNY FREDONIA / COLLEGE / STRAIGHT UP ARROW
21	STOP
22	DEAD END
23	STOP
24	PEDESTRIAN CROSSING / LEFT DIAGONAL DOWN ARROW
25	PEDESTRIAN CROSSING / RIGHT DIAGONAL DOWN ARROW STREET SIGN: MULLET ST / W LAKE SHORE DR
	PEDESTRIAN CROSSING / LEFT DOWN ARROW
26	PEDESTRIAN CROSSING / RIGHT DOWN ARROW
27	SPEED LIMIT 35
30	STOP
31	DEAD END
32	STREET SIGN: WOODROW AVE / W LAKE SHORE DR
33	STOP PEDESTRIAN CROSSING / LEFT DOWN ARROW
34	PEDESTRIAN CROSSING / RIGHT DOWN ARROW
36	STREET SIGN: WOODROW AVE / W LAKE SHORE DR
37	PEDESTRIAN CROSSING / LEFT DIAGONAL DOWN ARROW
	PEDESTRIAN CROSSING / RIGHT DIAGONAL DOWN ARROW
39	SPEED LIMIT 35
41 45	REFERENCE MARKER: 5 / 5201 / 2010 STOP
46	STREET SIGN: PIKE ST / W LAKE SHORE DR
47	PEDESTRIAN CROSSING / AHEAD
50	STATE ROUTE 5
51	STREET SIGN: ROBIN ST / W LAKE SHORE DR
52	STOP
55	PEDESTRIAN CROSSING / AHEAD
56 57	STOP STREET SIGN: PLOVER ST / W LAKE SHORE DR
58	REFERENCE MARKER: 5 / 5201 / 2011
60	SPEED LIMIT 35
61	STOP
62	STREET SIGN: DOVE ST / W LAKE SHORE DR
63	PEDESTRIAN CROSSING / LEFT DIAGONAL DOWN ARROW
	PEDESTRIAN CROSSING / RIGHT DIAGONAL DOWN ARROW PEDESTRIAN CROSSING / LEFT DIAGONAL DOWN ARROW
64	PEDESTRIAN CROSSING / RIGHT DIAGONAL DOWN ARROW
67	REFERENCE MARKER: 5 / 5201 / 2012
69	STOP
70	STREET SIGN: SWAN ST / W LAKE SHORE DR
74	STOP
75 76	STREET SIGN: PELICAN ST / W LAKE SHORE DR STOP / PLEASE NO DOG WASTE
77	NO MOTOR VEHICLES / BIKE ROUTE
	PEDESTRIAN CROSSING / LEFT DIAGONAL DOWN ARROW
81	PEDESTRIAN CROSSING / RIGHT DIAGONAL DOWN ARROW
82	PEDESTRIAN CROSSING / LEFT DIAGONAL DOWN ARROW
02	PEDESTRIAN CROSSING / RIGHT DIAGONAL DOWN ARROW
83	STOP STREET SIGN: EAGLE ST / W LAKE SHORE DR
84	REFERENCE MARKER: 5 / 5201 / 2013
85	TRUCK ROUTE / STRAIGHT UP ARROW
87	RIGHT LANE MUST TURN RIGHT
89	HOSPITAL / RIGHT ARROW // COLLEGE / RIGHT ARROW
93	WEST / STATE ROUTE 5 / DICHT ARROW
99	EAST / STATE ROUTE 5 / RIGHT ARROW PEDESTRIAN CROSSING / AHEAD
100	HOSPITAL / LEFT ARROW // COLLEGE / LEFT ARROW
101	TRUCK ROUTE / STRAIGHT UP ARROW
106	STOP
107	STOP
108	STREET SIGN: WASHINGTON AVE / E LAKE SHORE DR
113	BIKE ROUTE 517
115 118	SPEED LIMIT 35 STOP
119	STOP
120	STREET SIGN: PARK AVE / E LAKE SHORE DR

SIGNS TO REMAIN TABLE

IGN NO.	DESCRIPTION	
126	JCT / STATE ROUTE 60 // REFERENCE MARKER: 5 / 5201 / 2016	
127	STREET SIGN: DEER ST / E LAKE SHORE DR	
128	STOP	
129	NO TRUCK PROHIBITION / EXCEPT LOCAL DELIVERY	
130	STOP	
135	SPEED LIMIT 35	
136	STOP	
137	STREET SIGN: LEOPARD ST / E LAKE SHORE DR	
139	RIGHT LANE MUST TURN RIGHT	
	EAST / STATE 5 / STRAIGHT UP ARROW	
141	TO / INTERSTATE ROUTE 90 / RIGHT ARROW	
141	SOUTH / STATE ROUTE 60 / RIGHT ARROW	
	SUNY FREDONIA / COLLEGE / RIGHT ARROW	
144	STATE ROUTE 5	
149	BICYCLE / IN LANE	
	STATE ROUTE 60	
150	EAST / STATE ROUTE 5 / LEFT ARROW	
	WEST / STATE ROUTE 5 / RIGHT ARROW	
151	WEST / STATE ROUTE 5 / LEFT ARROW	
	EAST / STATE ROUTE 5 / RIGHT ARROW	
152	STOP HERE ON RED (LEFT DIAGONAL DOWN ARROW)	
	WEST / STATE ROUTE 5 / STRAIGHT UP ARROW	
155	SOUTH / STATE ROUTE 60 / LEFT ARROW	
	TO / INTERSTATE ROUTE 90 / LEFT ARROW	
	REFERENCE MARKER: 5 / 5201 / 2017	
157	EAST / STATE ROUTE 5	
107	SCENIC BYWAY / SEAWAY TRAIL / AMERICA'S BYWAYS	
	BOAT RAMP / STAIGHT UP ARROW	
160	JCC / COLLEGE / LEFT ARROW	
	SUNY FREDONIA / COLLEGE / STRAIGHT UP ARROW	
162	STREET SIGN: N BEAVER ST / E LAKE SHORE DR	
163	STOP	
164	STOP	
165	STREET SIGN: S BEAVER ST / E LAKE SHORE DR	
166	EAST / STATE ROUTE 5	
167	BICYCLE / IN LANE	
168	JCT / STATE ROUTE 60	



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94 of 94	PM-14			