# **GENERAL CONSTRUCTION NOTES**

- 1. EXISTING UTILITIES AND EXISTING IMPROVEMENTS MAY BE SHOWN AT APPROXIMATED LOCATIONS DUE TO THE AVAILABLE RECORD INFORMATION AT THE TIME OF PLAN PREPARATION. OTHER UTILITY LINES MAY EXIST. IT SHALL BE THE RESPONSIBILITY OF THE CONTRACTOR TO FIELD VERIFY ALL EXISTING UTILITIES BY POTHOLING OR LOCATING SERVICES "811" IF FOUND NECESSARY.
- 2. THE CONTRACTOR SHALL NOTIFY ALL CORRESPONDING UTILITY COMPANIES AND CALL "811" AT LEAST 48 HOURS BEFORE THE COMMENCEMENT OF ANY WORK WHICH MAY REQUIRE UTILITY VERIFICATION.
- 3. THE EXISTENCE AND LOCATION OF ANY UNDERGROUND UTILITY OR SUBSTRUCTURE SHOWN ON THESE PLANS WERE OBTAINED BY A SEARCH OF AVAILABLE RECORDS. NO CERTIFICATION IS MADE AS TO THE ACCURACY OR THOROUGHNESS OF THESE RECORDS. APPROVAL OF THESE PLANS BY THE CITY OF CORCORAN DOES NOT CONSTITUTE A REPRESENTATION AS THE ACCURACY OR COMPLETENESS OF LOCATION OR THE EXISTENCE OR NONEXISTENCE OF ANY UNDERGROUND UTILITY OR SUBSTRUCTURE WITHIN THE LIMITS OF THE PROJECT.
- 4. IT IS THE RESPONSIBILITY OF THE CONTRACTOR TO REVIEW THE FULL SET OF PLANS FOR ANY DISCREPANCIES AND OMISSIONS PRIOR TO THE COMMENCEMENT OF WORK, IF ANY DISCREPANCIES BETWEEN THESE PLANS AND THE FIELD ARE IDENTIFIED, THE CONTRACTOR SHALL NOTIFY THE ENGINEER. THE CONTRACTOR SHALL BE RESPONSIBLE FOR ANY WORK NOT IN CONFORMANCE WITH THE PLANS OR IN CONFLICT WITH ANY CODE.
- 5. AN APPROVED SET OF PLANS MUST BE AVAILABLE ON THE JOB SITE AT ALL TIMES.
- 6. THE CONTRACTOR SHALL POSSESS THE CLASS (OR CLASSES) OF LICENSE AS SPECIFIED IN THE "NOTICE TO
- ALL WORK SHALL BE PERFORMED IN CONFORMANCE WITH THE PROVISIONS IN THE CALTRANS STANDARD SPECIFICATIONS AND PLANS DATED 2018, ALONG WITH THE CITY OF CORCORAN STANDARD DRAWINGS.
- 8. THE CONTRACTOR SHALL BE RESPONSIBLE FOR PROVIDING ALL MATERIALS, FABRICATIONS, EQUIPMENT, APPLIANCES, TRANSPORTATION, SERVICES AND LABOR NECESSARY FOR THE CONSTRUCTION, ERECTION AND INSTALLATION OF ALL WORK INDICATED ON THESE DRAWINGS AND/OR OUTLINED IN EACH SECTION OF THE
- 9. FOR THE DURATION OF THE WORK, THE CONTRACTOR SHALL PROVIDE, INSTALL AND MAINTAIN, AS MAY BE REQUIRED, ALL NECESSARY BARRICADES AND RAILINGS, LIGHTS, WARNING SIGNS AND SIGNALS, AND SHALL TAKE ALL OTHER PRECAUTIONS AS MAY BE REQUIRED TO SAFEGUARD PERSONS, THE JOB SITE AND ADJOINING PROPERTY, AGAINST INJURIES AND DAMAGE OF ANY NATURE.
- 10. THE CONTRACTOR AND EACH SUBCONTRACTOR SHALL GIVE THEIR PERSONAL ATTENTION TO THE WORK; BE RESPONSIBLE FOR THE LAYOUT AND CORRECTNESS OF THEIR WORK AND COOPERATE WITH EACH OF THE VARIOUS TRADES TO OBTAIN A NEAT FINISHED JOB.
- 11. THE CONTRACTOR AGREES THAT IN ACCORDANCE WITH GENERALLY ACCEPTED CONSTRUCTION PRACTICES, THE CONTRACTOR WILL BE REQUIRED TO ASSUME SOLE AND COMPLETE RESPONSIBILITY FOR JOB SITE CONDITIONS DURING THE COURSE OF CONSTRUCTION OF THE PROJECT, INCLUDING SAFETY OF ALL PERSONS AND PROPERTY; THAT THIS REQUIREMENT SHALL BE MADE TO APPLY CONTINUOUSLY AND NOT BE LIMITED TO
- 12. TO THE FULLEST EXTENT PERMITTED BY LAWS AND REGULATIONS, THE CONTRACTOR SHALL INDEMNIFY AND HOLD HARMLESS THE OWNER AND ENGINEER, AND THE OFFICERS, DIRECTORS, MEMBERS, PARTNERS, EMPLOYEES, AGENTS, CONSULTANTS AND SUBCONTRACTORS OF EACH AND ANY OF THEM FROM AND AGAINST ALL CLAIMS, COSTS, LOSSES, AND DAMAGES (INCLUDING BUT NOT LIMITED TO ALL FEES AND CHARGES OF ENGINEERS, ARCHITECTS, ATTORNEYS, AND OTHER PROFESSIONALS AND ALL COURT OR ARBITRATION OR OTHER DISPUTE RESOLUTION COSTS) ARISING OUT OF OR RELATING TO THE PERFORMANCE OF THE WORK PROVIDED THAT ANY SUCH CLAIM, COST, LOSS, OR DAMAGE IS ATTRIBUTABLE TO BODILY INJURY, SICKNESS, DISEASE, OR DEATH, OR TO INJURY TO OR DESTRUCTION OF TANGIBLE PROPERTY (OTHER THAN THE WORK ITSELF), INCLUDING THE LOSS OF USE RESULTING THEREFROM BUT ONLY TO THE EXTENT CAUSED BY ANY NEGLIGENT ACT OR OMISSION OF CONTRACTOR, ANY SUBCONTRACTOR, ANY SUPPLIER, OR ANY INDIVIDUAL OR ENTITY DIRECTLY OR INDIRECTLY EMPLOYED BY ANY OF THEM TO PERFORM ANY OF THE WORK OR ANYONE FOR WHOSE ACTS ANY OF THEM MAY BE LIABLE.
- 13. SHOULD A CONSTRUCTION SURVEY OR CONSTRUCTION STAKING BE NECESSARY, THE CONTRACTOR SHALL BE RESPONSIBLE FOR PROVIDING THIS SERVICE.
- 14. DO NOT SCALE DRAWINGS, IF UNABLE TO LOCATE DIMENSIONS FOR ANY ITEM OF WORK, CONTACT THE ENGINEER FOR DIRECTION BEFORE PROCEEDING.
- 15. ALL DAMAGE TO AREAS AND/OR PROPERTY NOT SPECIFICALLY PART OF THE PROJECT SITE CAUSED DURING CONSTRUCTION ACTIVITIES WILL BE THE RESPONSIBILITY OF THE CONTRACTOR TO RETURN TO PRE-CONSTRUCTION CONDITIONS.
- 16. CHANGES TO THE APPROVED DRAWINGS SHALL BE MADE BY ADDENDUM OR A CHANGE ORDER SIGNED BY THE ENGINEER AND APPROVED BY THE PUBLIC WORKS/ENGINEERING OFFICIALS
- 17. DUST AND DEBRIS CONTROL MEASURES SHALL BE IMPLEMENTED IN ACCORDANCE WITH THE REQUIREMENTS OF THE SAN JOAQUIN VALLEY UNIFIED AIR POLLUTION CONTROL DISTRICT - DISTRICT REGULATION VIII - FUGITIVE DUST RULES.
- 18. THE CONTRACTOR SHALL PREPARE AND SUBMIT A TEMPORARY TRAFFIC CONTROL PLAN FOR REVIEW AND APPROVAL BY THE CITY AND THE ENGINEER PRIOR TO ANY WORK IN THE STREET RIGHT-OF-WAY. CONSTRUCTION AREA SIGNS FOR TEMPORARY TRAFFIC CONTROL SHALL BE FURNISHED, INSTALLED, MAINTAINED, AND REMOVED WHEN NO LONGER REQUIRED IN CONFORMANCE WITH THE PROVISIONS IN SECTION 12, "TEMPORARY TRAFFIC CONTROL DEVICES," OF THE 2018 CALTRANS STANDARD SPECIFICATIONS AND THE
- 19. THE CONTRACTOR SHALL BE RESPONSIBLE FOR SWEEPING PAVED PUBLIC ROADS, CONSTRUCTION ENTRANCE/EXIT LOCATIONS AND ONSITE PAVED AREAS, SWEEPING SHALL OCCUR WITHIN ONE HOUR OF EARTHWORK, TRENCHING, AND OTHER SOIL-DISTURBING ACTIVITIES, AND WHEN VEHICLES ARE ENTERING AND
- 20. THE CONTRACTOR SHALL GIVE A MINIMUM OF 3 WORKING DAYS NOTICE FOR ALL TESTING, INSPECTIONS, OR SURVEYING WORK TO BE COMPLETED.

# **MAP KEY**


CLM 5223(019) - PHASE 1

CLM 5223(020) - PHASE 2

BIKE ROUTE/LANE

# CITY OF CORCORAN

PEDESTRIAN AND BICYCLE FACILITY IMPROVEMENTS CONGESTION MITIGATION AND AIR QUALITY PROGRAM (CMAQ) PHASE 1 & PHASE 2 CML 5223(019) & CML 5223(020)

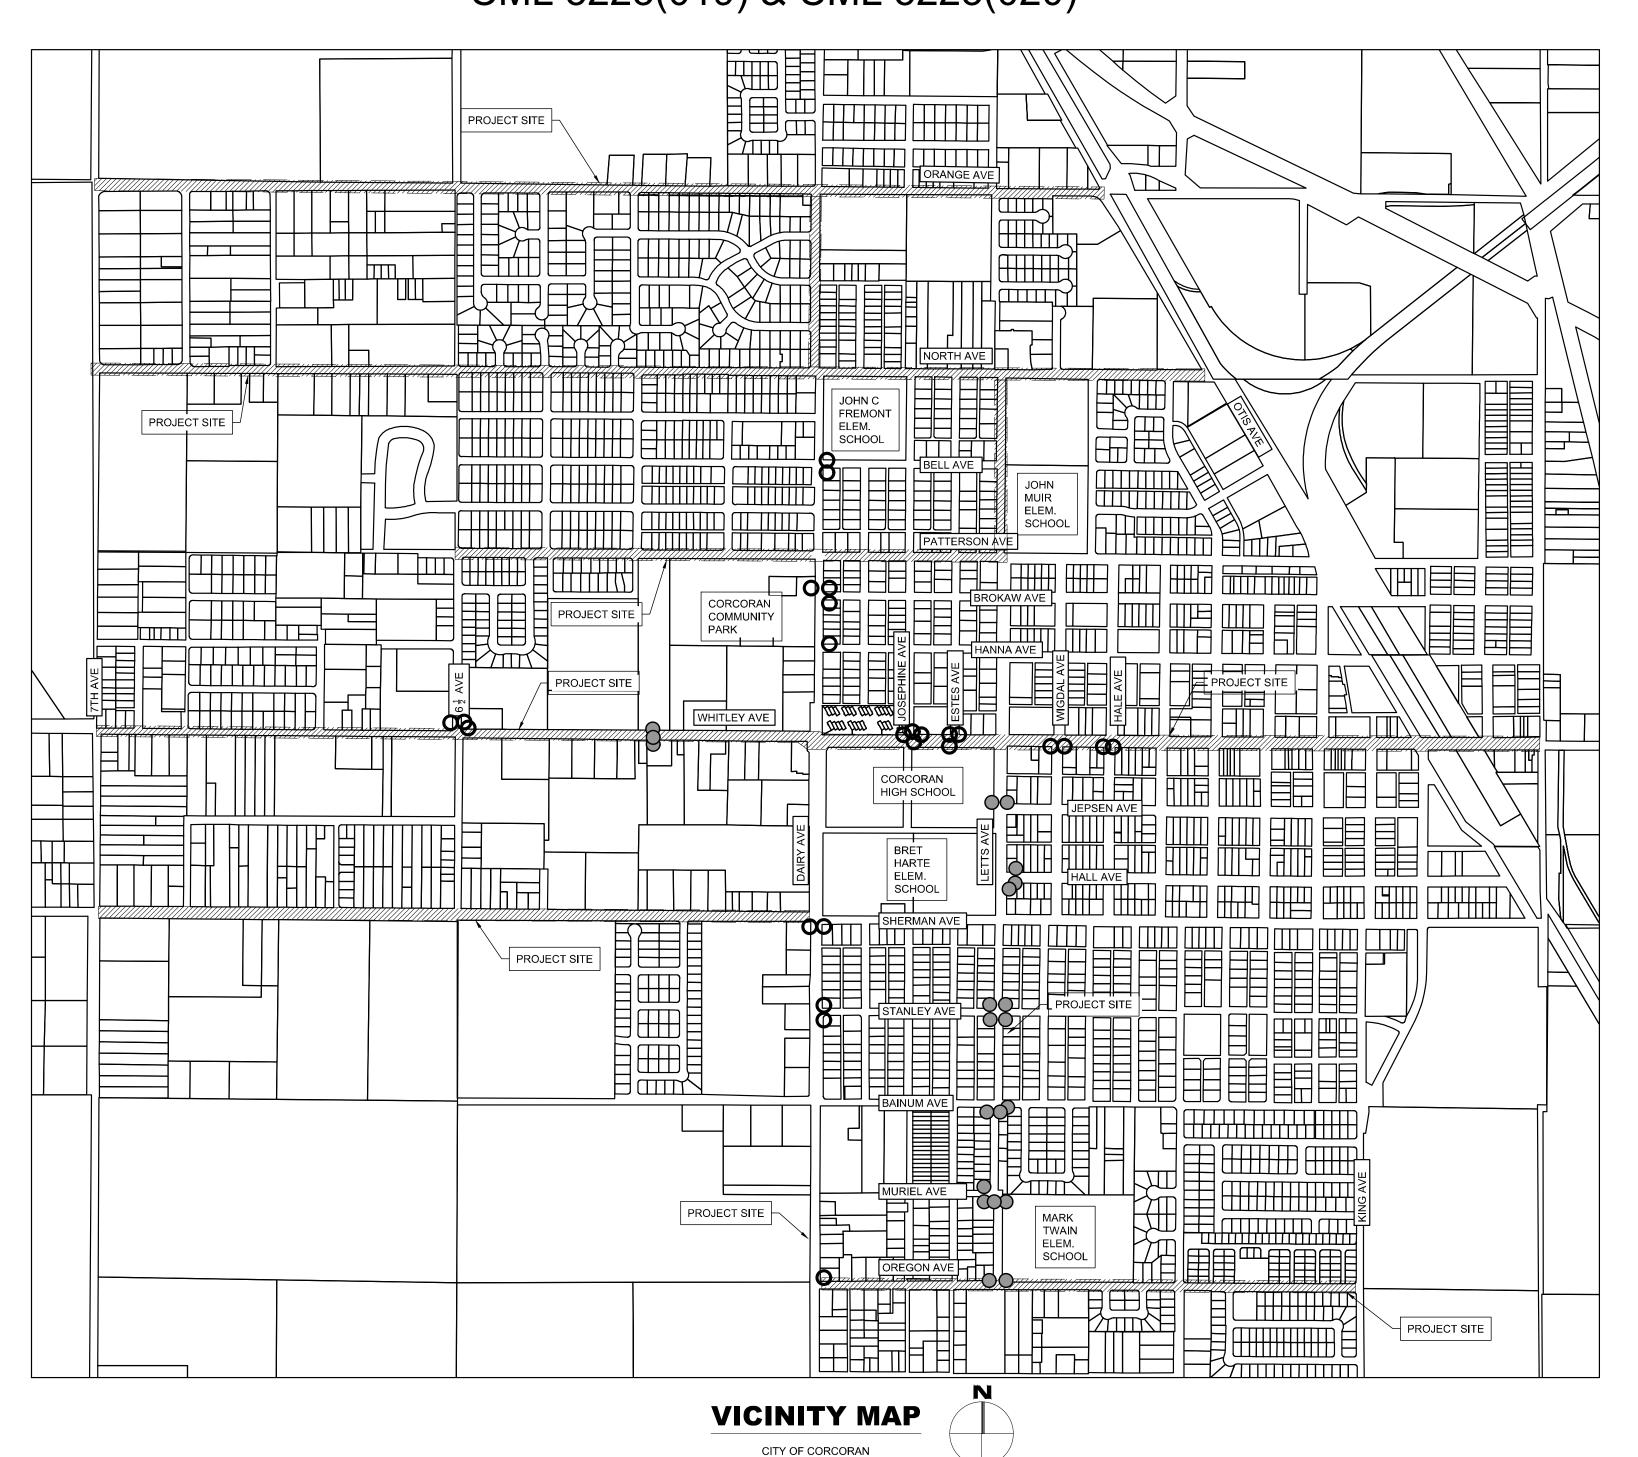

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4 - SIDEWALK IMPROVEMENTS SHEET INDEX

5 - SIDEWALK IMPROVEMENTS SHEET INDEX 6 - SIDEWALK IMPROVEMENTS SHEET INDEX

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22 - SHERMAN AVE & DAIRY AVE SIGNAGE, STRIPING, & MARKING PLAN 23 - STANLEY AVE & DAIRY AVE DEMOLITION, IMPROVEMENT, & STRIPING PLAN

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26 - WIGDAL AVE & WHITLEY AVE DEMOLITION, IMPROVEMENT, & STRIPING PLA 27 - ESTES AVE & WHITLEY AVE DEMOLITION PLAN

28 - ESTES AVE & WHITLEY AVE IMPROVEMENT PLAN

29 - ESTES AVE & WHITLEY AVE SIGNAGE, STRIPING, & MARKING PLAN 30 - JOSEPHINE AVE & WHITLEY AVE DEMOLITION PLAN

31 - JOSEPHINE AVE & WHITLEY AVE IMPROVEMENT PLAN

32 - JOSEPHINE AVE & WHITLEY AVE SIGNAGE, STRIPING, & MARKING PLAN 33 - 6 AND HALF AVE & WHITLEY AVE DEMOLITION & IMPROVEMENT PLAN

34 - 6 AND HALF AVE & WHITLEY AVE IMPROVEMENT PLAN

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36 - BELL AVE & DAIRY AVE IMPROVEMENTS 37 - BELL AVE & DAIRY AVE ELECTRICAL PLAN

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54 - MURIEL AVE & LETTS AVE DEMOLITION PLAN 55 - MURIEL AVE & LETTS AVE IMPROVEMENT PLAN

56 - MURIEL AVE & LETTS AVE SIGNAGE, STRIPING, & MARKING PLAN

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# 58 - SIGNAGE, STRIPING, & MARKING DETAILS

60 - CITY STANDARD DETAILS 61 - CITY STANDARD DETAILS

# **BENCHMARK**

TEMPORARY CONTROL POINT: LOCAL

ELEVATION: 100' DESCRIPTION: CHISLED X ON TOP OF CURB LOCALLY LOCATED AT EACH INTERSECTION AS SHOWN IN LOCATION MAP

# **CITY & ENGINEER CONTACTS**

PUBLIC WORKS DIRECTOR CIVIL ENGINEER

JOSEPH FAULKNER JAVIER ANDRADE, PE, QSD CITY OF CORCORAN A&M CONSULTING ENGINEERS 832 WHITLEY AVE 310 W MURRAY AVE CORCORAN, CA 93212 VISALIA, CA 93291 (559) 992-2151 EXT. 2210 (559) 429-4747

# **PROJECT UTILITY CONTACTS**

JEFF HEIDNGER 705 "P" ST., FRESNO, CA 93760

JOSEPH FAULKNER 832 WHITLEY AVE CORCORAN, CA 93212 (559) 992-2151 EXT. 2210

SOUTHERN CALIFORNIA GAS CO CHAD MUELLER 404 N TIPTON STREET VISALIA, CA 93292

FRONTIER COMMUNICATION SOCRATES LUNA 1359 "G" STREET, REEDLEY, CA 93654 (559) 637-0666

CITY OF CORCORAN WATER AND WASTEWATER











SIDEWAL

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# **LEGEND**

AP	ANGLE POINT		EXISTING RIGHT-OF-WAY
DIP	DUCTILE IRON PIPE		
EP	EDGE OF PAVEMENT		SAWCUT LIMITS
ELEV	ELEVATION		
FL	FLOW LINE	(GAS4)	EXISTING 4" GAS UTILITY
GB	GRADE BREAK		
INV	INVERT	(UU)	EXISTING UNDERGROUND UTILITY
LT	LEFT		
LIP	LIP	(OU)	EXISTING OVERHEAD UTILITY
OG	ORIGINAL GROUND		
Р	PAVEMENT	(E)	EXISTING ELECTRICITY UTILITY
PCR	POINT OF CURVE RADIUS		
PUE	PUBLIC UTILITY EASEMENT	(OE)	EXISTING OVERHEAD ELECTRICITY
R	RADIUS		
RT	RIGHT	———— (W12) ————	EXISTING 12" WATER LINE
R/W	RIGHT-OF-WAY		
R(XX.X)	RADIUS	(SD12)	EXISTING 12" STORM DRAIN
SS	SANITARY SEWER		EVICTING AGE CANETA BY OFWED
SSFM	SANITARY SEWER FORCE MAIN	——— (SS10) ———	EXISTING 10" SANITARY SEWER
SSMH STA	SANITARY SEWER MANHOLE		
SIA	STATION STORM BRAIN		
SDMH	STORM DRAIN STORM DRAIN MANHOLE		
TC	TOP OF CURB		
WS	WATER SERVICE		
(XXX.XX)	EXISTING ELEVATION		
S=0.XXXX	PROPOSED SLOPE IN DECIMAL		
0-0.////	THOI GOLD SECT E IN DECIMAL		
	STREET SIGN		
	EXISTING AC PAVEMENT		
	PROPOSED DEMOLITION AREA		
	PROPOSED AC PAVEMENT		
	PROPOSED GUTTER CONCRETE		

PROPOSED SIDEWALK CONCRETE

PROPOSED DETECTABLE WARNING SURFACE

# **CONTRACTOR NOTES**

- 1. THE CONTRACTOR SHALL PERFORM ALL EXCAVATION, BACKFILLING, GRUBBING AND GRADING REQUIRED FOR CONSTRUCTION AND INSTALLATION OF PIPELINES, STRUCTURES AND APPURTENANCES. EXCAVATION SHALL INCLUDE REMOVAL OF PAVEMENT, CONCRETE, ROCK, EARTH AND DEBRIS, REGARDLESS OF CHARACTER. ADDITIONALLY, THE CONTRACTOR SHALL BE RESPONSIBLE FOR LOCATING AND PROTECTING EXISTING UTILITIES AND STRUCTURES ENCOUNTERED IN THE WORK, PROVIDE TRAFFIC CONTROL, DISPOSE OF SURPLUS AND UNSUITABLE EXCAVATED MATERIALS AND RESTORE BACKFILLED AREAS TO ORIGINAL CONDITION OR AS REQUIRED BY THE RESPECTIVE CONTRACT DRAWINGS AND SPECIFICATIONS. ALL BACKFILLED AND RESTORED AREAS SHALL BE MAINTAINED BY THE CONTRACTOR, IN A PROPER CONDITION, FOR THE DURATION OF THE PROJECT.
- 2. LOCATIONS OF EXISTING UTILITIES ARE APPROXIMATED. CONTRACTOR TO FIELD VERIFY ALL EXISTING UTILITIES BEFORE COMMENCEMENT OF WORK.
- 3. THE CONTRACTOR IS RESPONSIBLE FOR DIRECT OR INDIRECT DAMAGE TO EXISTING STRUCTURES, PIPELINES, CONDUITS, POLES, WIRES OF EVERY DESCRIPTION IN THE VICINITY OF HIS WORK WHETHER ABOVE OR BELOW GROUND, OR THAT MAY BE ENCOUNTERED IN TRENCH OR STRUCTURE EXCAVATION. THIS RESPONSIBILITY SHALL INCLUDE THE COST TO REPAIR OR REPLACE ANY EXISTING FACILITY DAMAGED DIRECTLY OR INDIRECTLY BY CONSTRUCTION ACTIVITIES, WHETHER SUCH FACILITY IS OR IS NOT SHOWN ON THE DRAWINGS.
- 4. IT IS THE RESPONSIBILITY OF THE CONTRACTOR TO PRESERVE ALL SURVEY MONUMENTS. ANY MONUMENT DISTURBED DURING CONSTRUCTION SHALL BE PERPETUATED PER THE PROFESSIONAL LAND SURVEYOR'S ACT, BUSINESS AND PROFESSIONS CODE 8771, AT THE CONTRACTORS EXPENSE.

# **GENERAL CONCRETE NOTES**

- 1. ALL CONCRETE SHALL BE CLASS 3 CONCRETE, UNLESS OTHERWISE SPECIFIED.
- 2. CLASS 3 CONCRETE SHALL CONTAIN NOT LESS THAN 505 POUNDS OF PORTLAND CEMENT PER CUBIC YARD WITH 1 IN AGGREGATE. 5 INCH MAXIMUM SLUMP. 2500 P.S.I. AT 28 DAYS.
- 3. WHEN MAXIMUM DAYTIME TEMPERATURE EXCEEDS 50° F. ALL NEWLY PLACED CONCRETE SHALL BE SPRAYED UNIFORMLY WITH A CURING COMPOUND. CURING COMPOUND SHALL BE APPLIED AT A NOMINAL RATE OF ONE GALLON PER 150 SQUARE FEET, UNLESS OTHERWISE SPECIFIED.
- 4. ALL WORK CONSTRUCTED BY THESE PLANS SHALL BE IN COMPLIANCE WITH ALL CURRENT ADA REGULATIONS.

# SIDEWALK AND RAMP NOTES

- 1. MAXIMUM SLOPES OF ADJOINING GUTTERS, THE ROAD SURFACE IMMEDIATELY ADJACENT TO THE CURB RAMP OR ACCESSIBLE ROUTE SHALL NOT EXCEED 5% WITHIN 4 FT OF THE BOTTOM OF THE CURB RAMP.
- 2. NO CROSS SLOPE IN THE PATH OF TRAVEL SHALL EXCEED 1.5%.
- 3. SIDEWALKS SHALL BE STEEL TOWELED AND HAVE A LIGHT BROOM FINISH, UNLESS OTHERWISE NOTED. RAMPS SHALL ALSO BE STEEL TOWELED AND HAVE A HEAVY BROOM FINISH ACROSS THE SLOPE OF THE RAMP, UNLESS OTHERWISE NOTED.
- 4. SIDEWALKS AND RAMPS SHALL HAVE WEAKENED PLANE JOINTS CONSTRUCTED WHERE SHOWN IN THESE IMPROVEMENT PLANS. WEAKENED PLANE JOINTS SHALL BE A MINIMUM OF 1 INCH IN DEPTH AND SHALL BE FINISHED WITH A SCORING TOOL LEAVING THE EDGES ROUNDED.
- 5. SIDEWALKS AND RAMPS SHALL BE PLACED ON 6 INCH MOIST AND COMPACTED BASE MATERIALS. 90% RELATIVE COMPACTION UNDER SIDEWALKS.

# SIGNING, STRIPING & MARKINGS NOTES

- 1. ALL WORK AND MATERIALS SHALL CONFORM TO CALTRANS STANDARD PLANS (2018 REVISED STANDARD PLAN RSP) AND THE CA 2014 MANUAL ON UNIFORM TRAFFIC CONTROL DEVICES FOR STREETS AND HIGHWAYS MUTCD (REVISION 5).
- 2. ANY CONTRACTOR PERFORMING WORK ON THIS PROJECT SHALL FAMILIARIZE HIMSELF WITH THE SITE AND SHALL BE SOLELY RESPONSIBLE FOR ANY DAMAGE TO EXISTING FACILITIES RESULTING DIRECTLY OR INDIRECTLY FROM HIS OPERATIONS, WHETHER OR NOT SUCH FACILITIES ARE SHOWN ON THESE PLANS.
- 3. NEW BIKE LANE STRIPING SHALL BE 5 FEET WIDE.
- 4. FOR THE STANDARD CROSSWALK DETAIL, REFER TO CITY STANDARD DETAIL ST-10 ON SHEET 60.
- 5. ALL CROSSWALK MARKINGS MUST BE WHITE. EXCEPT THAT THOSE NEAR SCHOOLS MUST BE YELLOW AS SHOWN ON PLANS.







SAN SIDEWALK I SHEETTITE:

TES & LEGEND






SHEET NO.

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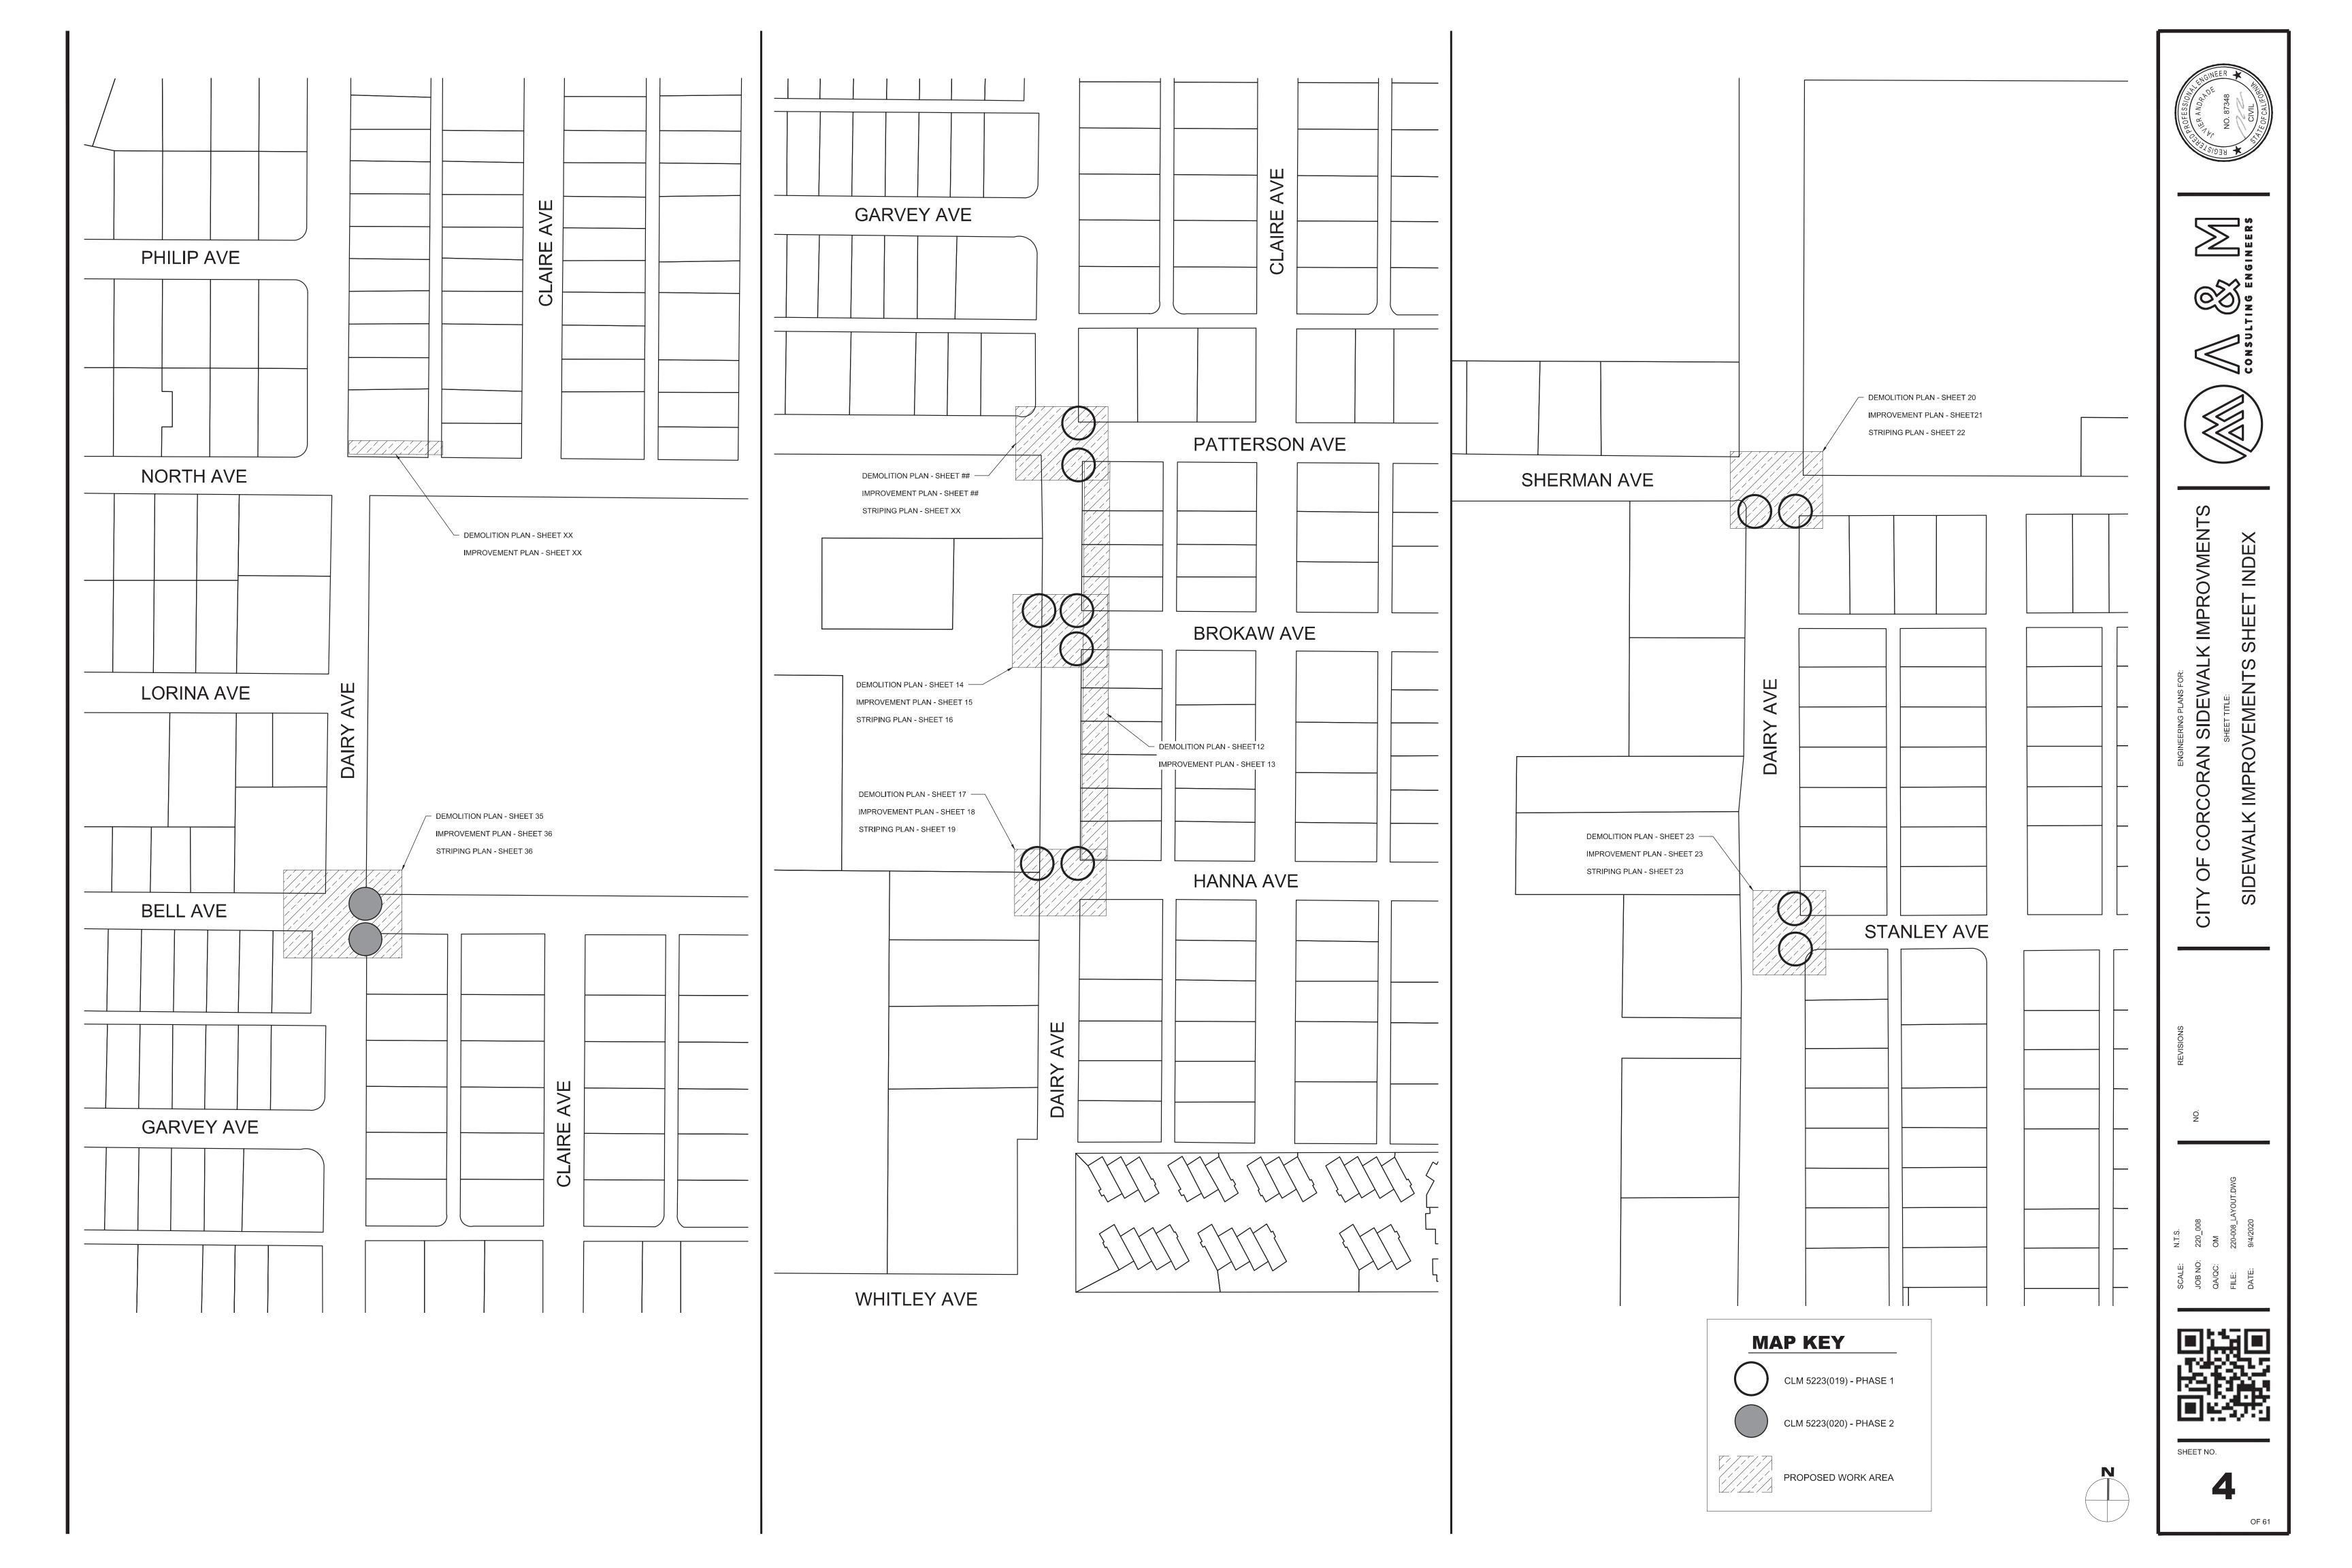
**IMPROVMENTS** SHEET INDEX SIDEWALK IMPROVEMEN RCORAN ROL COF BICYCLE OF CH


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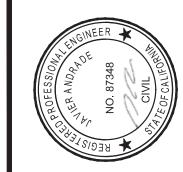
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OF 61

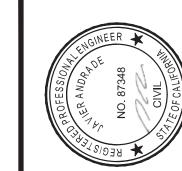







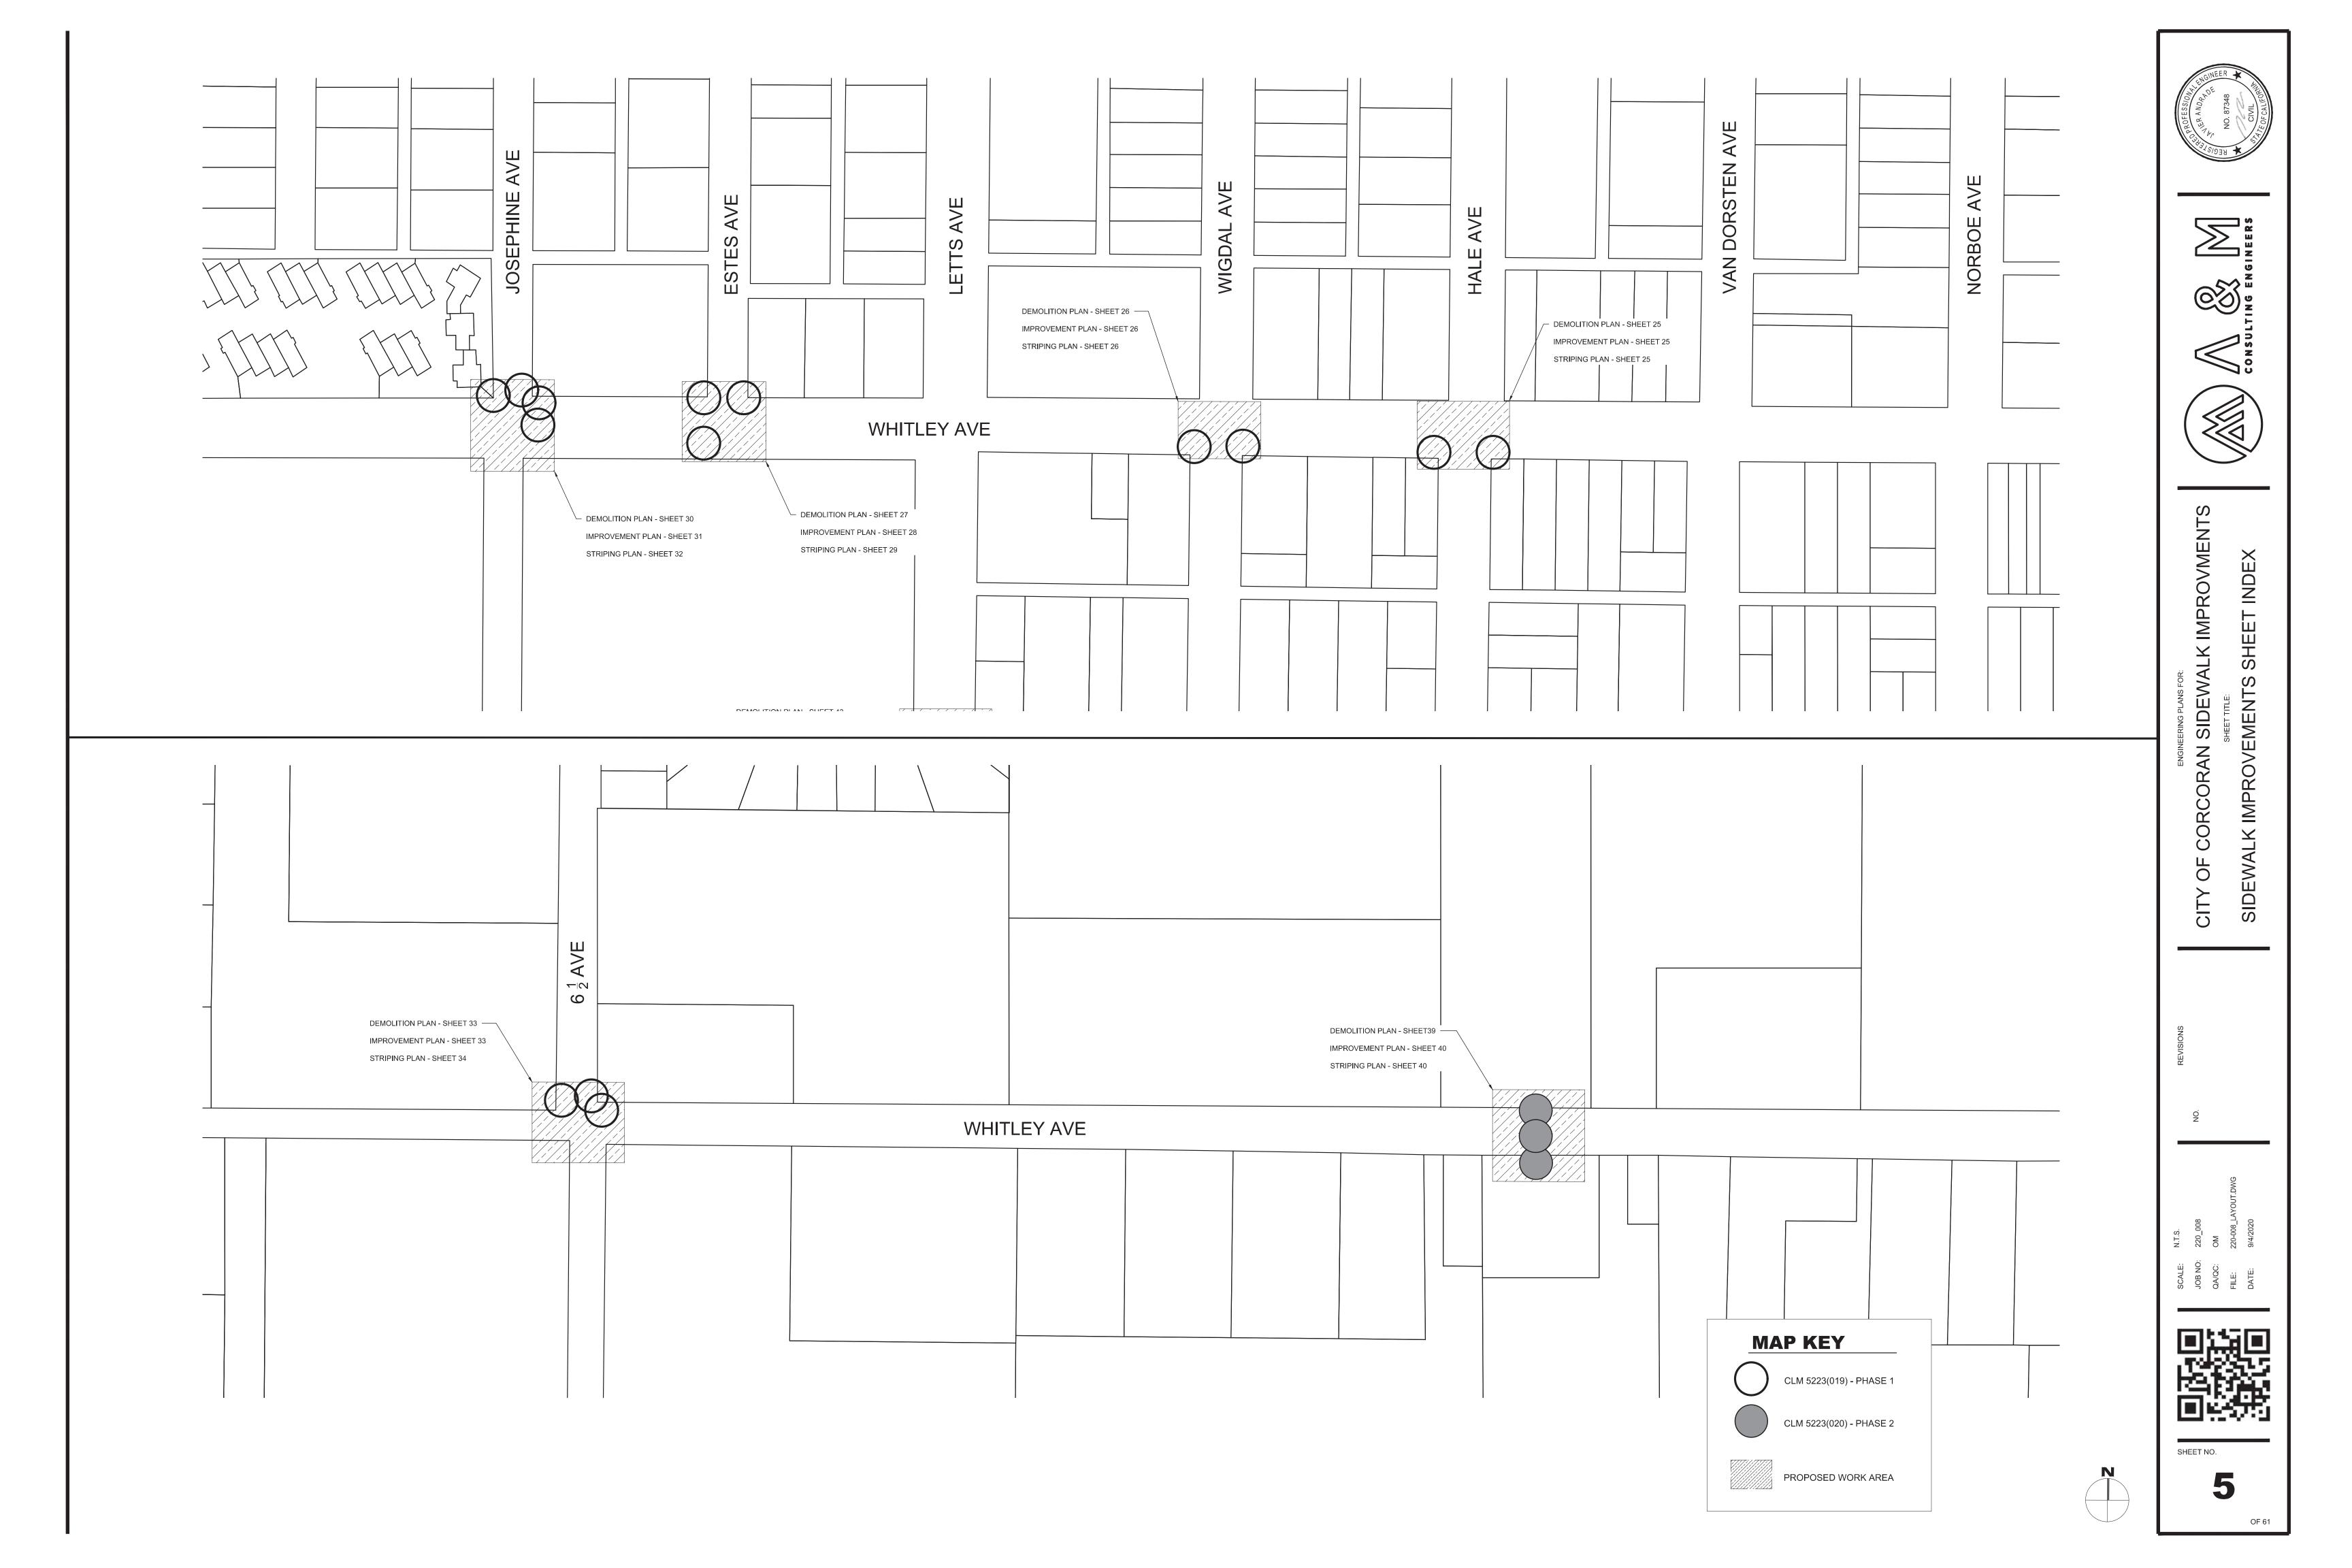




- 1. PAVEMENT MARKINGS AND SIGNAGE DIMENSIONS SHALL BE OBTAINED FROM THE LATEST VERSION OF THE CALIFORNIA MANUAL
- 2. SHARED LANE MARKING SHALL BE PAINTED PER FIGURE 9C-9 AND 9C-108(CA) OF THE CA MUTCD (SEE SHEET 59). WHERE PROPOSED SHARED LANE MARKING WILL OVERLAP WITH EXISTING ROADWAY MARKINGS, THE SHARED LANE MARKING HSALL BE INSTALLED 20 FT TO 30 FT BEFORE OR AFTER THE EXISTING ROADWAY MARKING.
- 3. MEASUREMENTS WHERE THE INTERSECTION IS USED AS THE STARTING POINT ARE FROM THE BEGINNING OF CENTERLINE OF THE ROADWAY PAST THE INTERSECTION.
- 4. WHERE PROPOSED SIGNS FALL WITHIN 25 FEET OF AN EXISTING SIGN, THE CONTRACTOR SHALL INSTALL THE PROPOSED SIGN FURTHER AWAY FROM THE EXISTING SIGN SO THAT THE PROPOSED SIGN IS NOT CLOSER THAN 25 FEET FROM AN EXISTING SIGN.
- PROPOSED SIGNS MUST NOT BE INSTALLED IN THE PATH OF VEHICLES INTO EXISTING DRIVE APPROACHES, IN THE PATH OF PEDESTRIAN WALKWAYS INTO PROPERTIES, OR DIRECTLY IN FRONT OF EXISTING UTILITIES. WHERE PROPOSED SIGNS MAY BLOCK DRIVE APPROACHES OR WALKWAYS OR ACCESS TO UTILITIES, THE CONTRACTOR SHALL INSTALL THE PROPOSED SIGN BETWEEN 5FT TO 10 FT AWAY FROM THE DRIVE APPROACH, WALKWAY, OR UTILITY.




PAINT THE SHARED LANE MARKING 50 FT WEST OF THE INTERSECTION IN THE



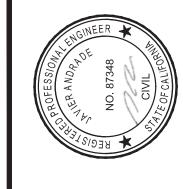


**IMPROVMENT** SIDEWALK

SHEET NO.

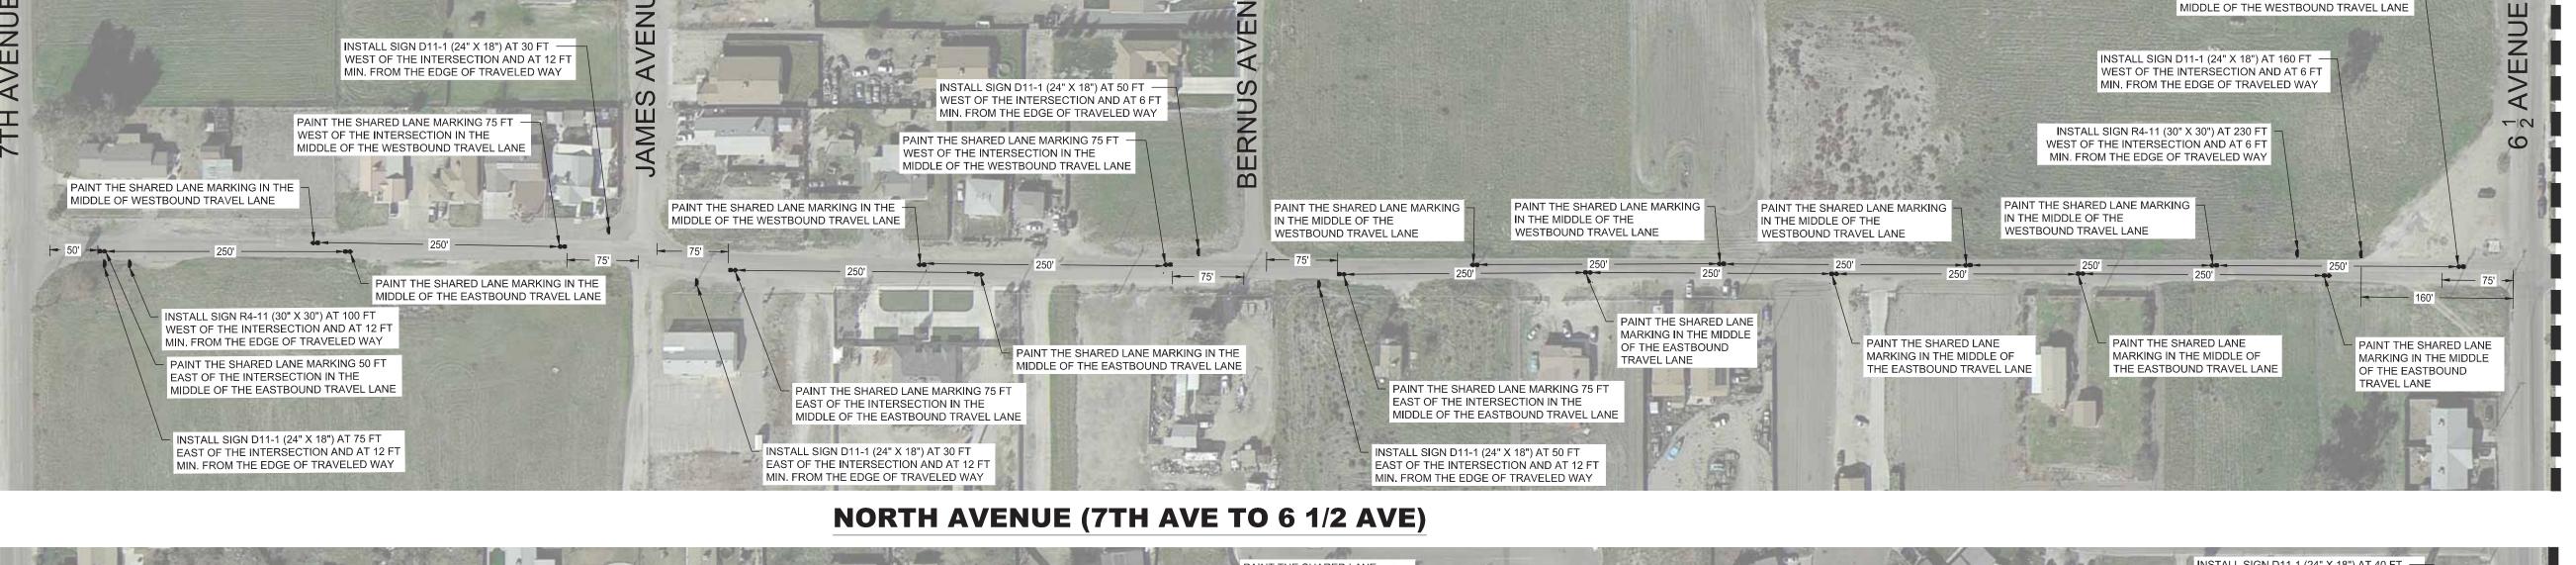




# **NORTH AVENUE (6 1/2 AVE TO DAIRY AVE)**

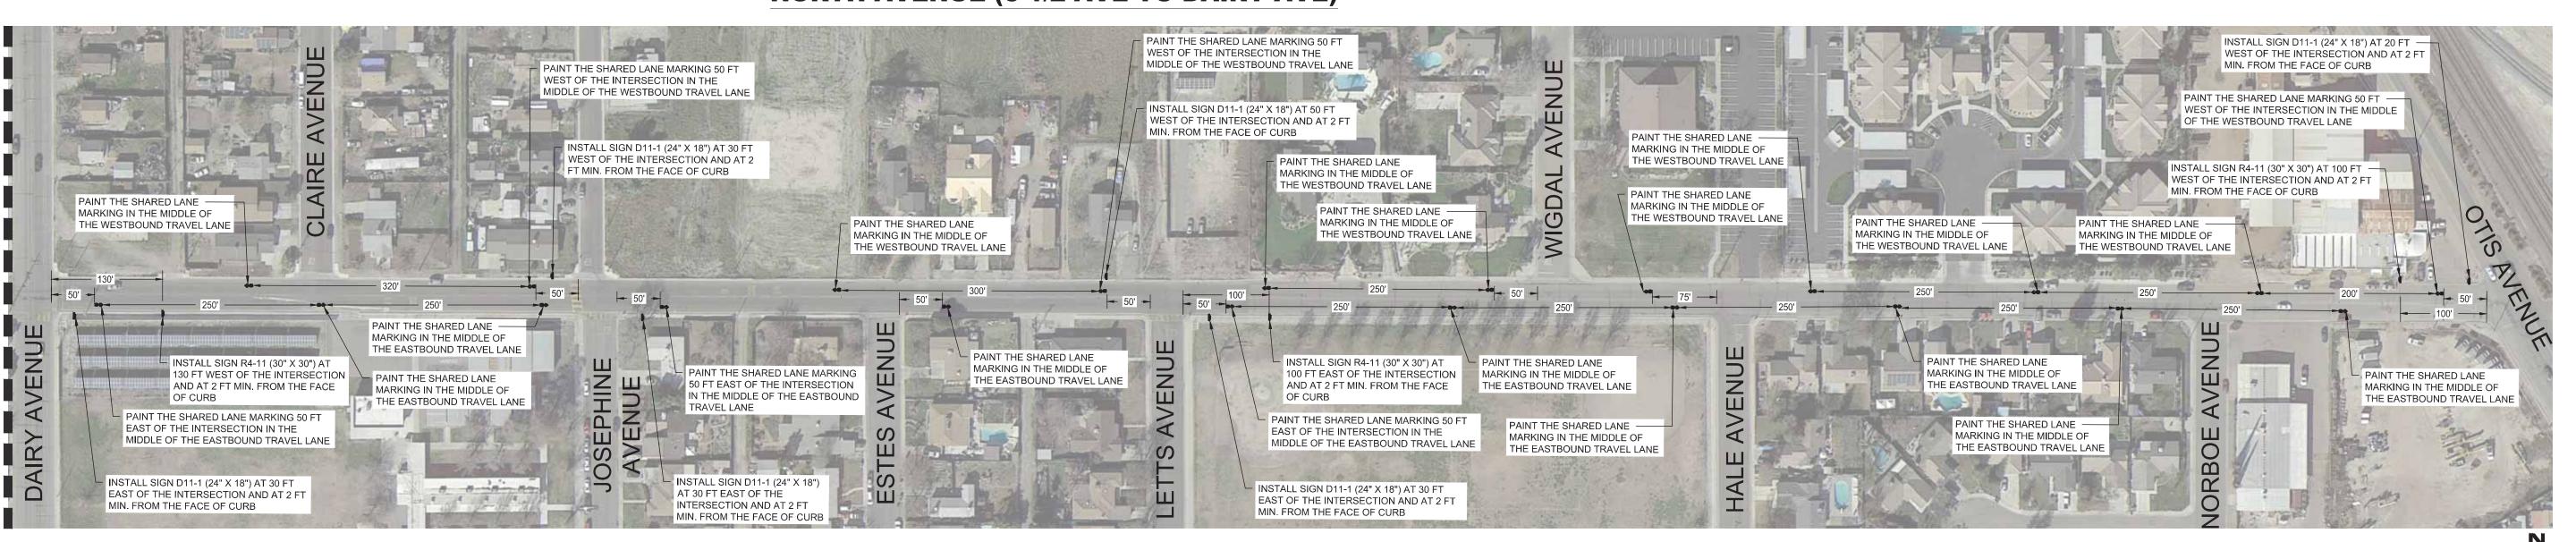


- 1. PAVEMENT MARKINGS AND SIGNAGE DIMENSIONS SHALL BE OBTAINED FROM THE LATEST VERSION OF THE CALIFORNIA MANUAL ON UNIFORM TRAFFIC CONTROL DEVICES.
- 2. SSHARED LANE MARKING SHALL BE PAINTED PER FIGURE 9C-9 AND 9C-108(CA) OF THE CA MUTCD (SEE SHEET 59). WHERE PROPOSED SHARED LANE MARKING WILL OVERLAP WITH EXISTING ROADWAY MARKINGS, THE SHARED LANE MARKING HSALL BE INSTALLED 20 FT TO 30 FT BEFORE OR AFTER THE EXISTING ROADWAY MARKING.
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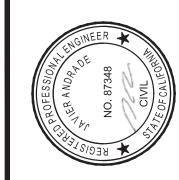


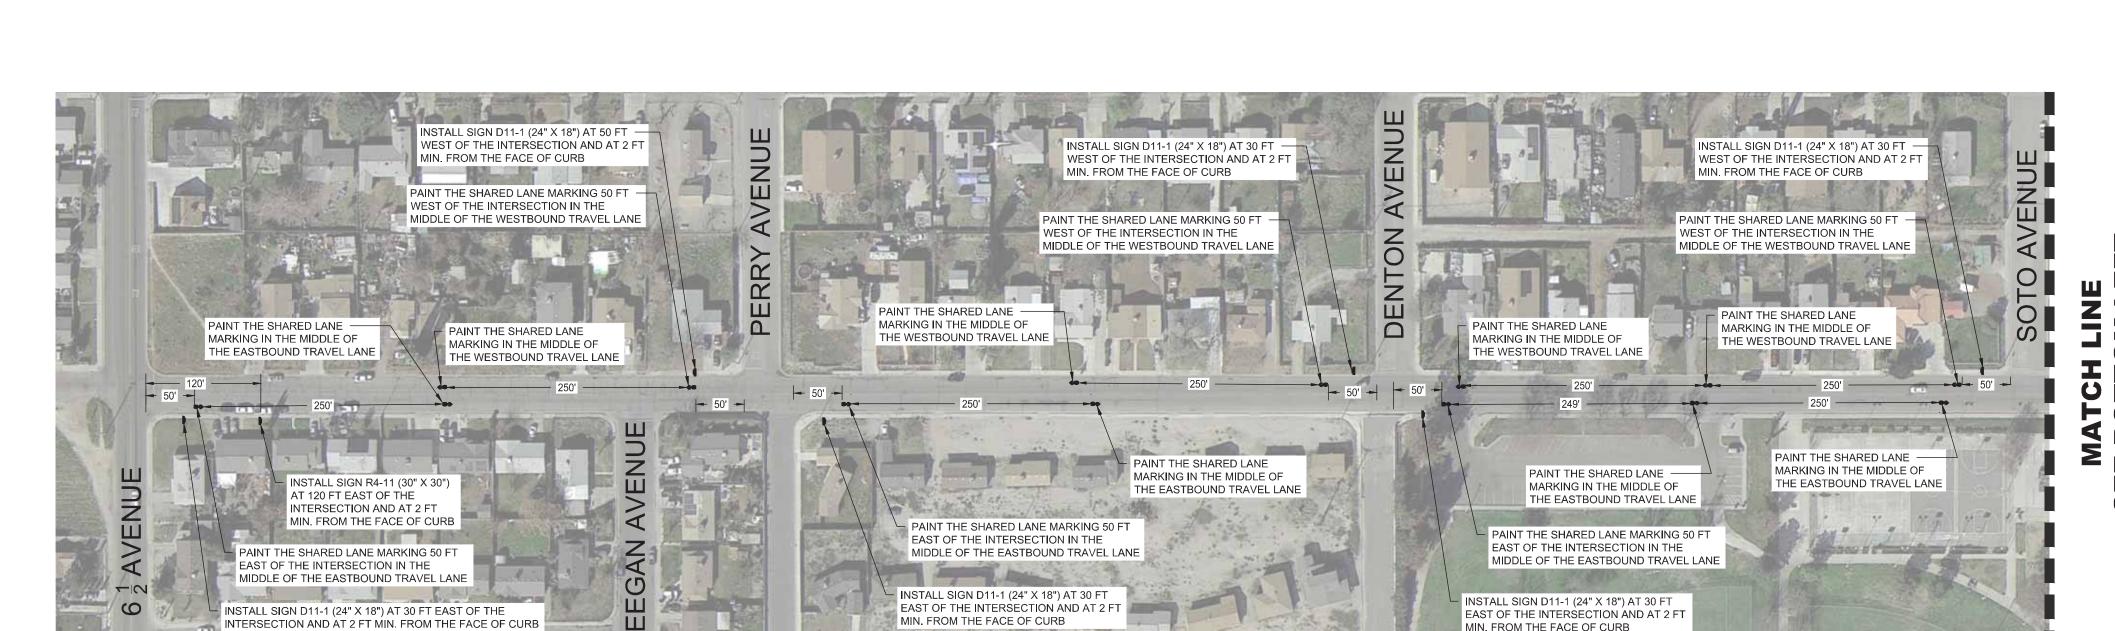

# PATTERSON AVENUE (6 1/2 AVE TO SOTO AVE)

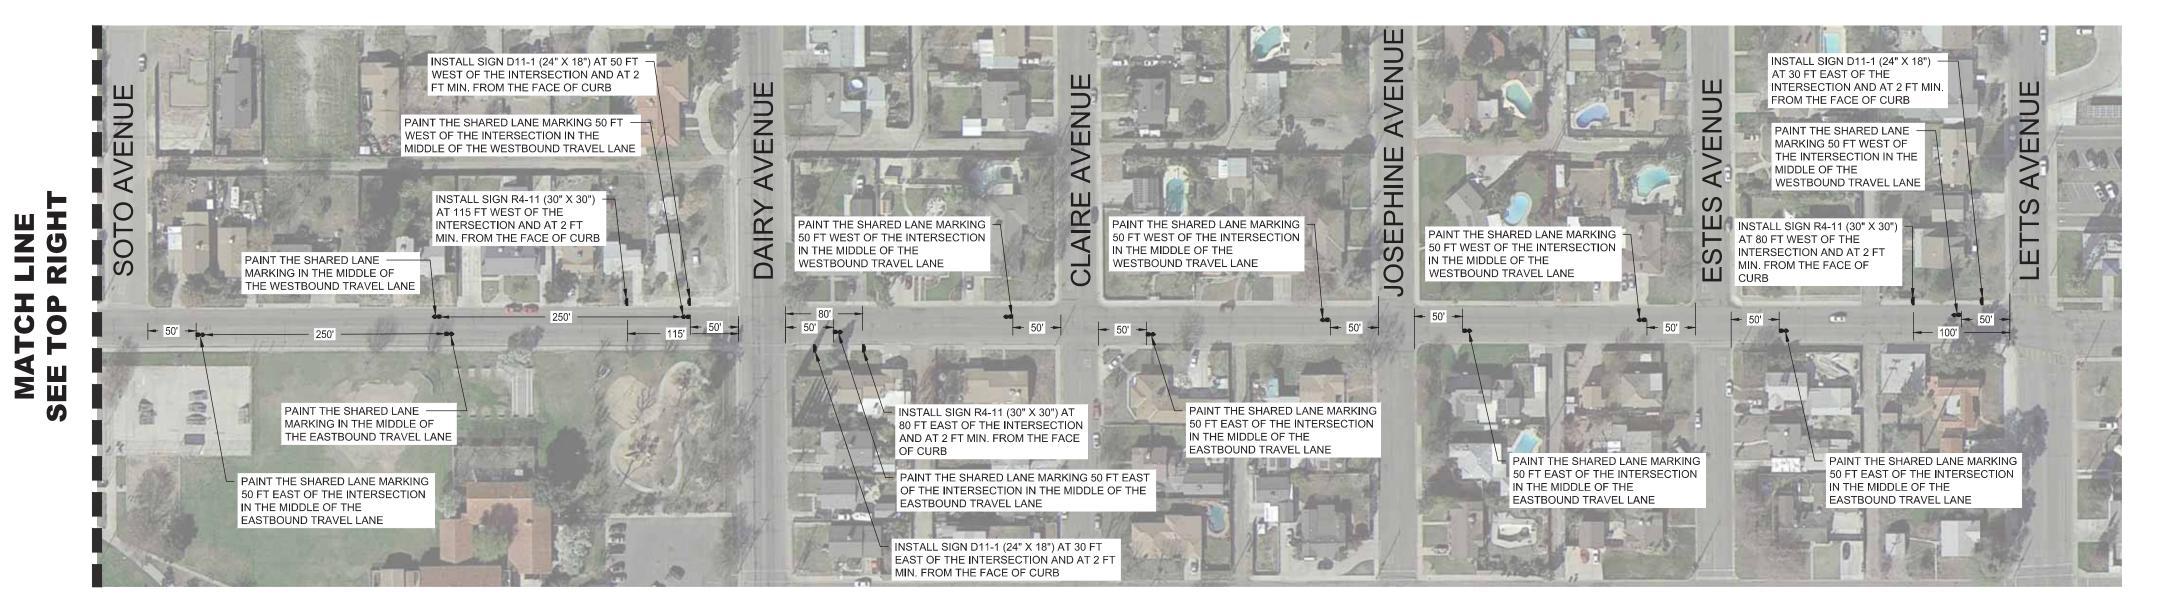

PATTERSON AVENUE (SOTO AVE TO LETTS AVE)









**IMPROVMENTS** SIDEWALK COF OF




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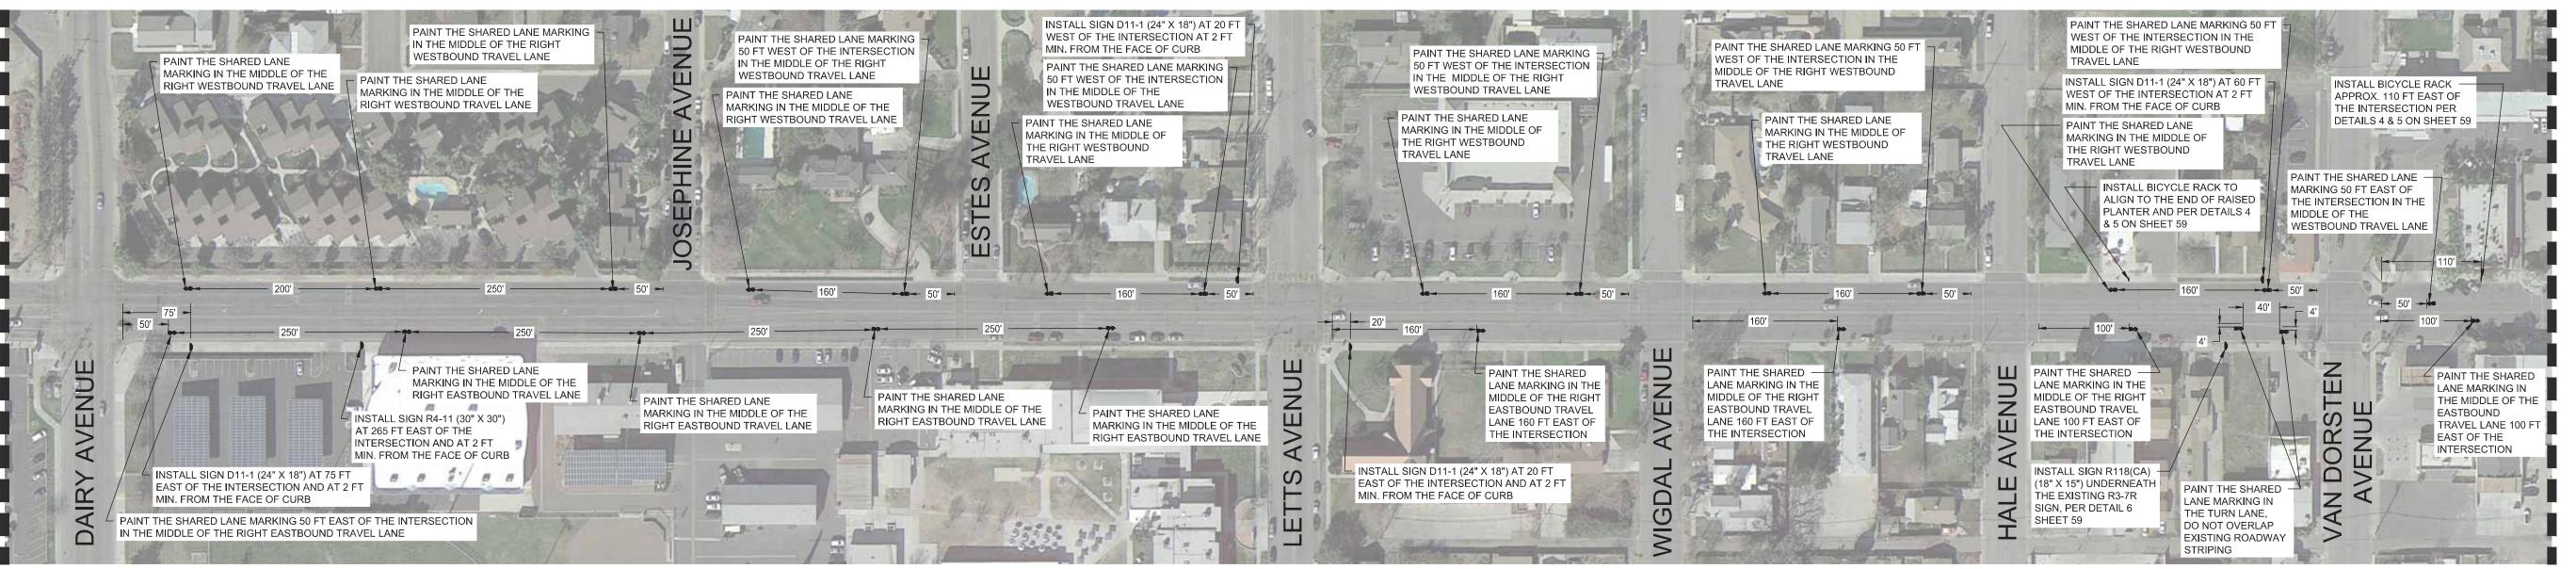
- 1. PAVEMENT MARKINGS AND SIGNAGE DIMENSIONS SHALL BE OBTAINED FROM THE LATEST VERSION OF THE CALIFORNIA MANUAL ON UNIFORM TRAFFIC CONTROL DEVICES.
- SHARED LANE MARKING SHALL BE PAINTED PER FIGURE 9C-9 AND 9C-108(CA) OF THE CA MUTCD (SEE SHEET 59). WHERE PROPOSED SHARED LANE MARKING WILL OVERLAP WITH EXISTING ROADWAY MARKINGS, THE SHARED LANE MARKING HSALL BE INSTALLED 20 FT TO 30 FT BEFORE OR AFTER THE EXISTING ROADWAY MARKING.
- MEASUREMENTS WHERE THE INTERSECTION IS USED AS THE STARTING POINT ARE FROM THE BEGINNING OF CENTERLINE OF THE ROADWAY PAST THE INTERSECTION. WHERE PROPOSED SIGNS FALL WITHIN 25 FEET OF AN EXISTING SIGN, THE CONTRACTOR SHALL INSTALL THE PROPOSED SIGN FURTHER AWAY FROM THE EXISTING SIGN
- SO THAT THE PROPOSED SIGN IS NOT CLOSER THAN 25 FEET FROM AN EXISTING SIGN. 5. PROPOSED SIGNS MUST NOT BE INSTALLED IN THE PATH OF VEHICLES INTO EXISTING DRIVE APPROACHES, IN THE PATH OF PEDESTRIAN WALKWAYS INTO PROPERTIES, OR DIRECTLY IN FRONT OF EXISTING UTILITIES. WHERE PROPOSED SIGNS MAY BLOCK DRIVE APPROACHES OR WALKWAYS OR ACCESS TO UTILITIES, THE CONTRACTOR SHALL INSTALL THE PROPOSED SIGN BETWEEN 5FT TO 10 FT AWAY FROM THE DRIVE APPROACH, WALKWAY, OR UTILITY.






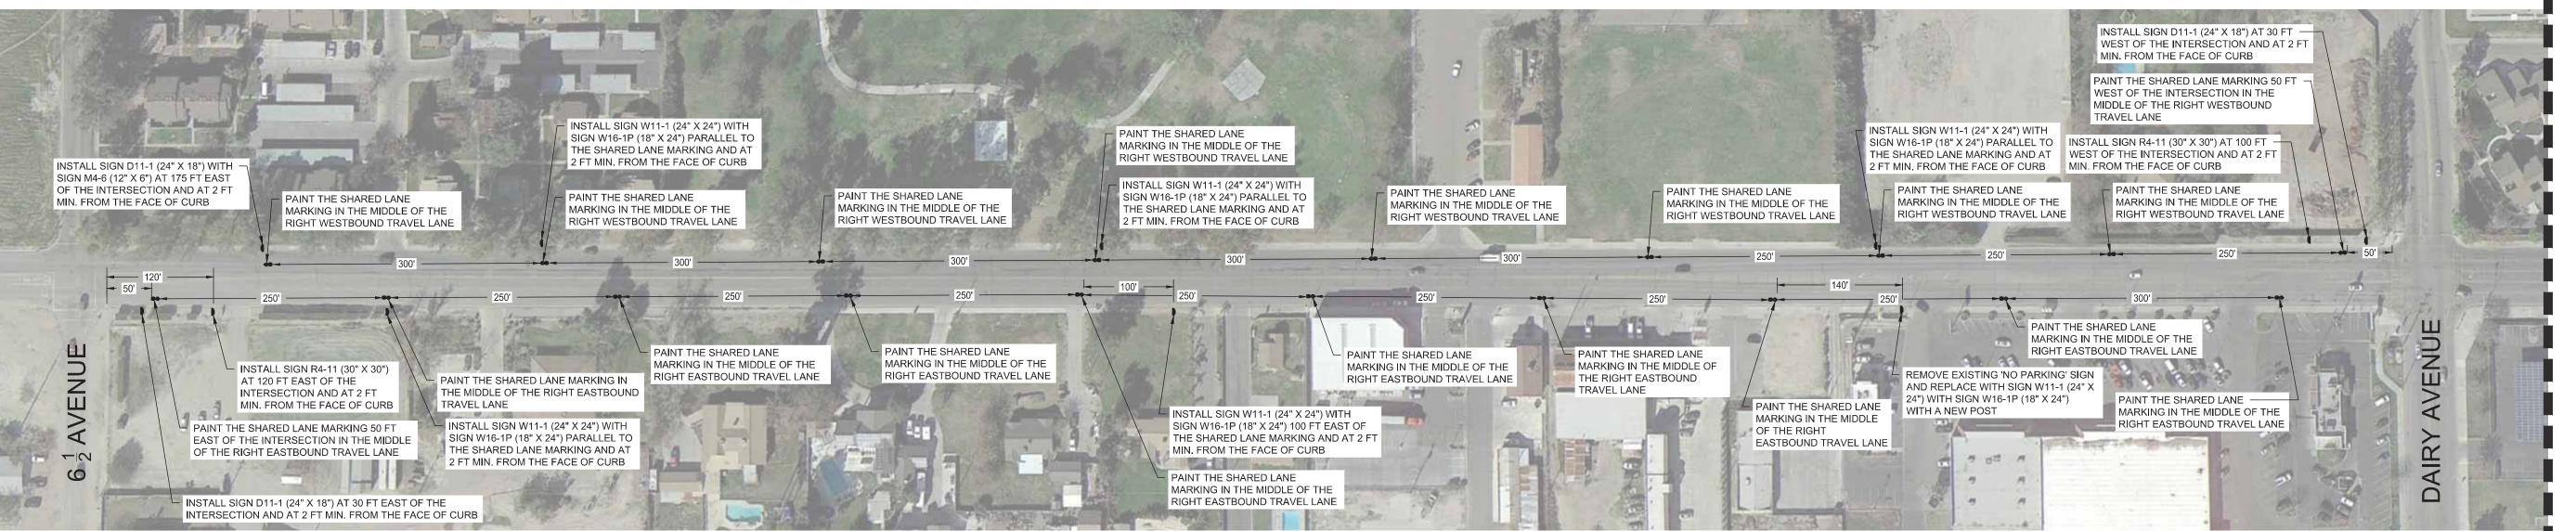

# WHITLEY AVENUE (6 1/2 AVE TO DAIRY AVE)



# WHITLEY AVENUE (DAIRY AVE TO VAN DORSTEN AVE)

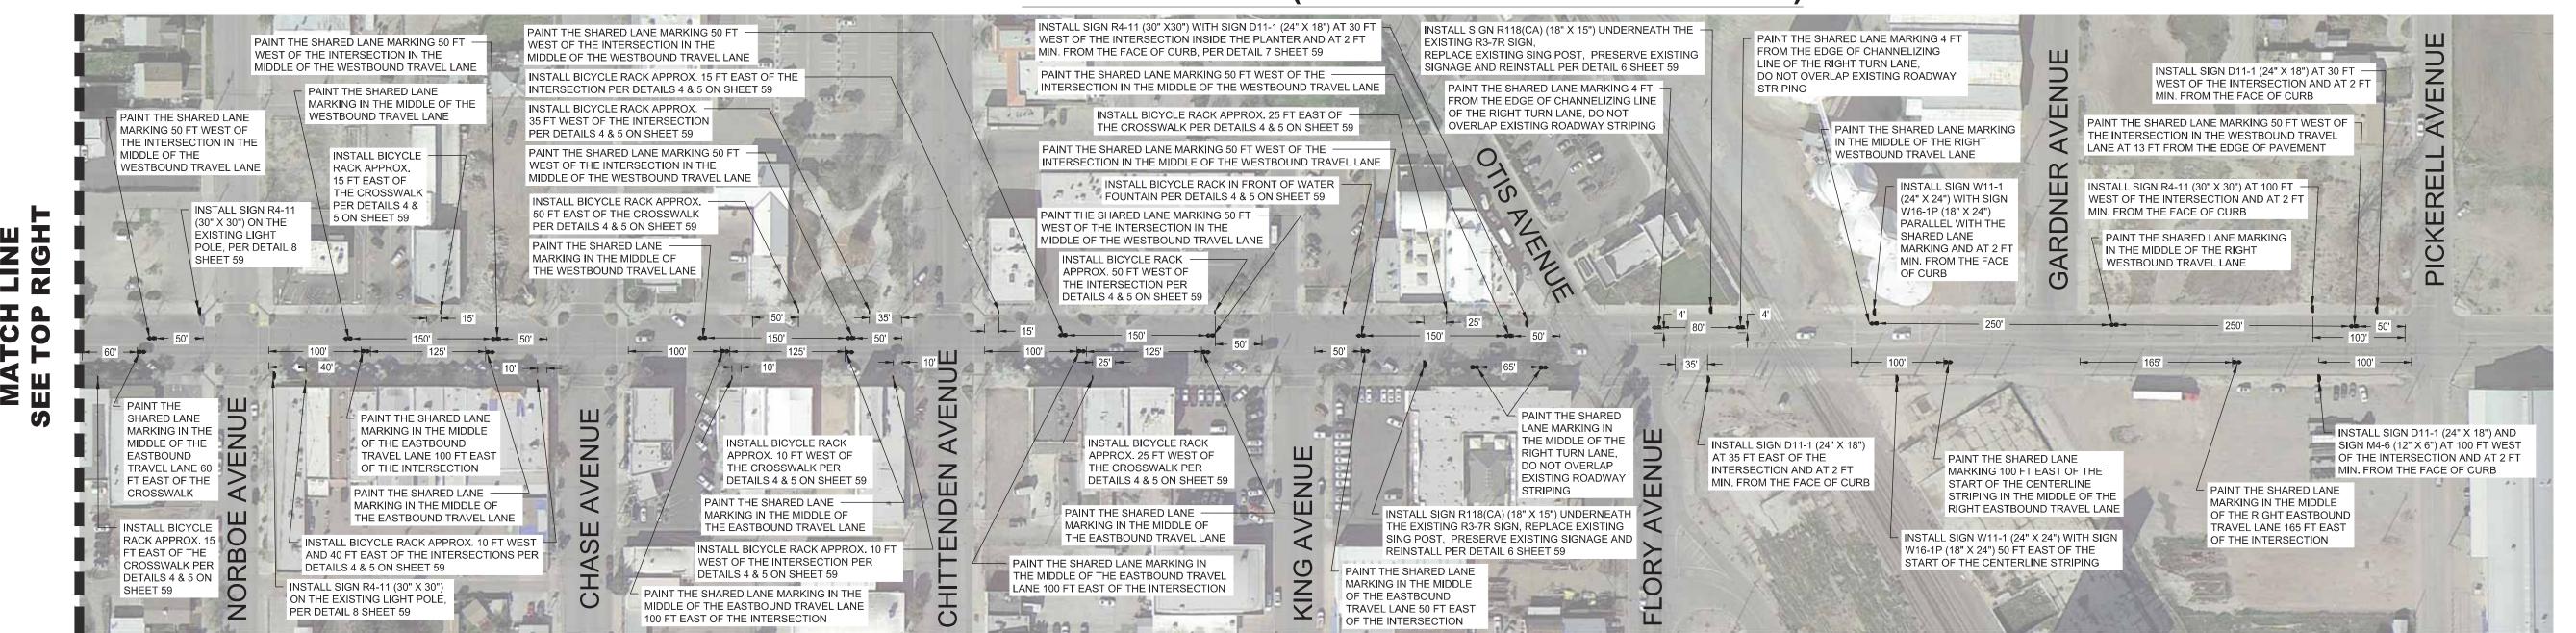



OVMENT SIDEWAL




- 1. PAVEMENT MARKINGS AND SIGNAGE DIMENSIONS SHALL BE OBTAINED FROM THE LATEST VERSION OF THE CALIFORNIA MANUAL ON UNIFORM TRAFFIC CONTROL DEVICES.
- 2. SHARED LANE MARKING SHALL BE PAINTED PER FIGURE 9C-9 AND 9C-108(CA) OF THE CA MUTCD (SEE SHEET 59). WHERE PROPOSED SHARED LANE MARKING WILL OVERLAP WITH EXISTING ROADWAY MARKINGS, THE SHARED LANE MARKING HSALL BE INSTALLED 20 FT TO 30 FT BEFORE OR AFTER THE EXISTING ROADWAY MARKING.
- 3. MEASUREMENTS WHERE THE INTERSECTION IS USED AS THE STARTING POINT ARE FROM THE BEGINNING OF CENTERLINE OF THE ROADWAY PAST THE INTERSECTION.

MATCH SEE TOP

- 4. WHERE PROPOSED SIGNS FALL WITHIN 25 FEET OF AN EXISTING SIGN, THE CONTRACTOR SHALL INSTALL THE PROPOSED SIGN FURTHER AWAY FROM THE EXISTING SIGN SO THAT THE PROPOSED SIGN IS NOT CLOSER THAN 25 FEET FROM AN EXISTING SIGN.
- PROPOSED SIGNS MUST NOT BE INSTALLED IN THE PATH OF VEHICLES INTO EXISTING DRIVE APPROACHES, IN THE PATH OF PEDESTRIAN WALKWAYS INTO PROPERTIES, OR DIRECTLY IN FRONT OF EXISTING UTILITIES. WHERE PROPOSED SIGNS MAY BLOCK DRIVE APPROACHES OR WALKWAYS OR ACCESS TO UTILITIES, THE CONTRACTOR SHALL INSTALL THE PROPOSED SIGN BETWEEN 5FT TO 10 FT AWAY FROM THE DRIVE APPROACH, WALKWAY, OR UTILITY.





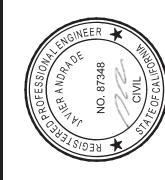




**IMPROVMENT** 

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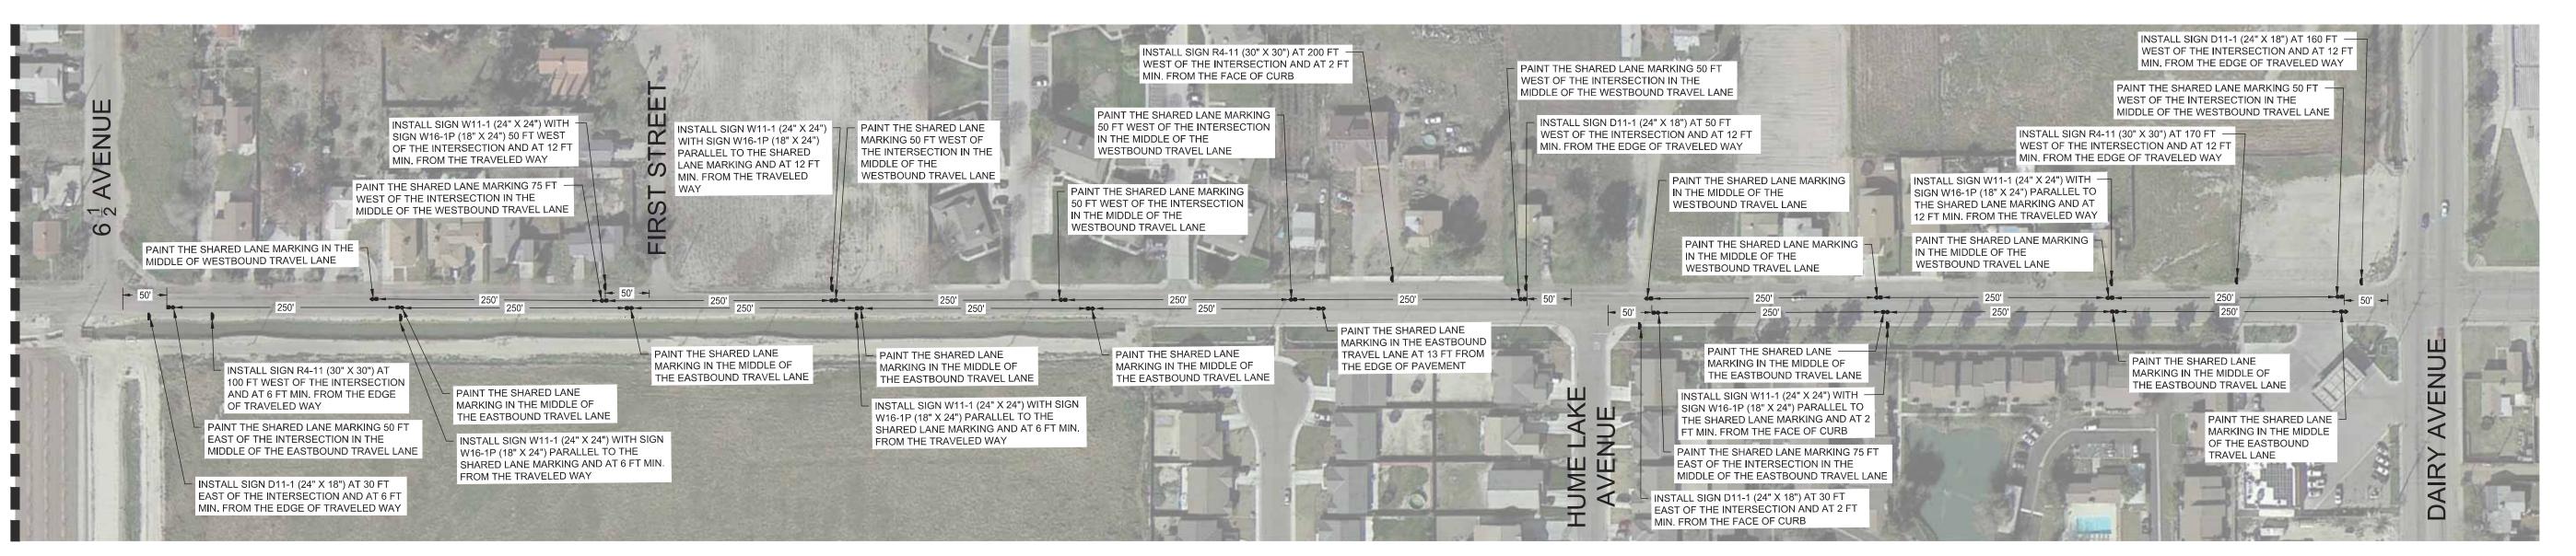
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# **SHERMAN AVENUE (7TH AVE TO 6 1/2 AVE)**



**SHERMAN AVENUE (6 1/2 AVE TO DAIRY AVE)** 


- 1. PAVEMENT MARKINGS AND SIGNAGE DIMENSIONS SHALL BE OBTAINED FROM THE LATEST VERSION OF THE CALIFORNIA MANUAL ON UNIFORM TRAFFIC CONTROL DEVICES 2. SHARED LANE MARKING SHALL BE PAINTED PER FIGURE 9C-9 AND 9C-108(CA) OF THE CA MUTCD (SEE SHEET 59). WHERE PROPOSED SHARED LANE MARKING WILL
- OVERLAP WITH EXISTING ROADWAY MARKINGS, THE SHARED LANE MARKING HSALL BE INSTALLED 20 FT TO 30 FT BEFORE OR AFTER THE EXISTING ROADWAY MARKING.
- 3. MEASUREMENTS WHERE THE INTERSECTION IS USED AS THE STARTING POINT ARE FROM THE BEGINNING OF CENTERLINE OF THE ROADWAY PAST THE INTERSECTION. 4. WHERE PROPOSED SIGNS FALL WITHIN 25 FEET OF AN EXISTING SIGN, THE CONTRACTOR SHALL INSTALL THE PROPOSED SIGN FURTHER AWAY FROM THE EXISTING SIGN SO THAT THE PROPOSED SIGN IS NOT CLOSER THAN 25 FEET FROM AN EXISTING SIGN.
- PROPOSED SIGNS MUST NOT BE INSTALLED IN THE PATH OF VEHICLES INTO EXISTING DRIVE APPROACHES, IN THE PATH OF PEDESTRIAN WALKWAYS INTO PROPERTIES, OR DIRECTLY IN FRONT OF EXISTING UTILITIES. WHERE PROPOSED SIGNS MAY BLOCK DRIVE APPROACHES OR WALKWAYS OR ACCESS TO UTILITIES, THE CONTRACTOR SHALL INSTALL THE PROPOSED SIGN BETWEEN 5FT TO 10 FT AWAY FROM THE DRIVE APPROACH, WALKWAY, OR UTILITY.

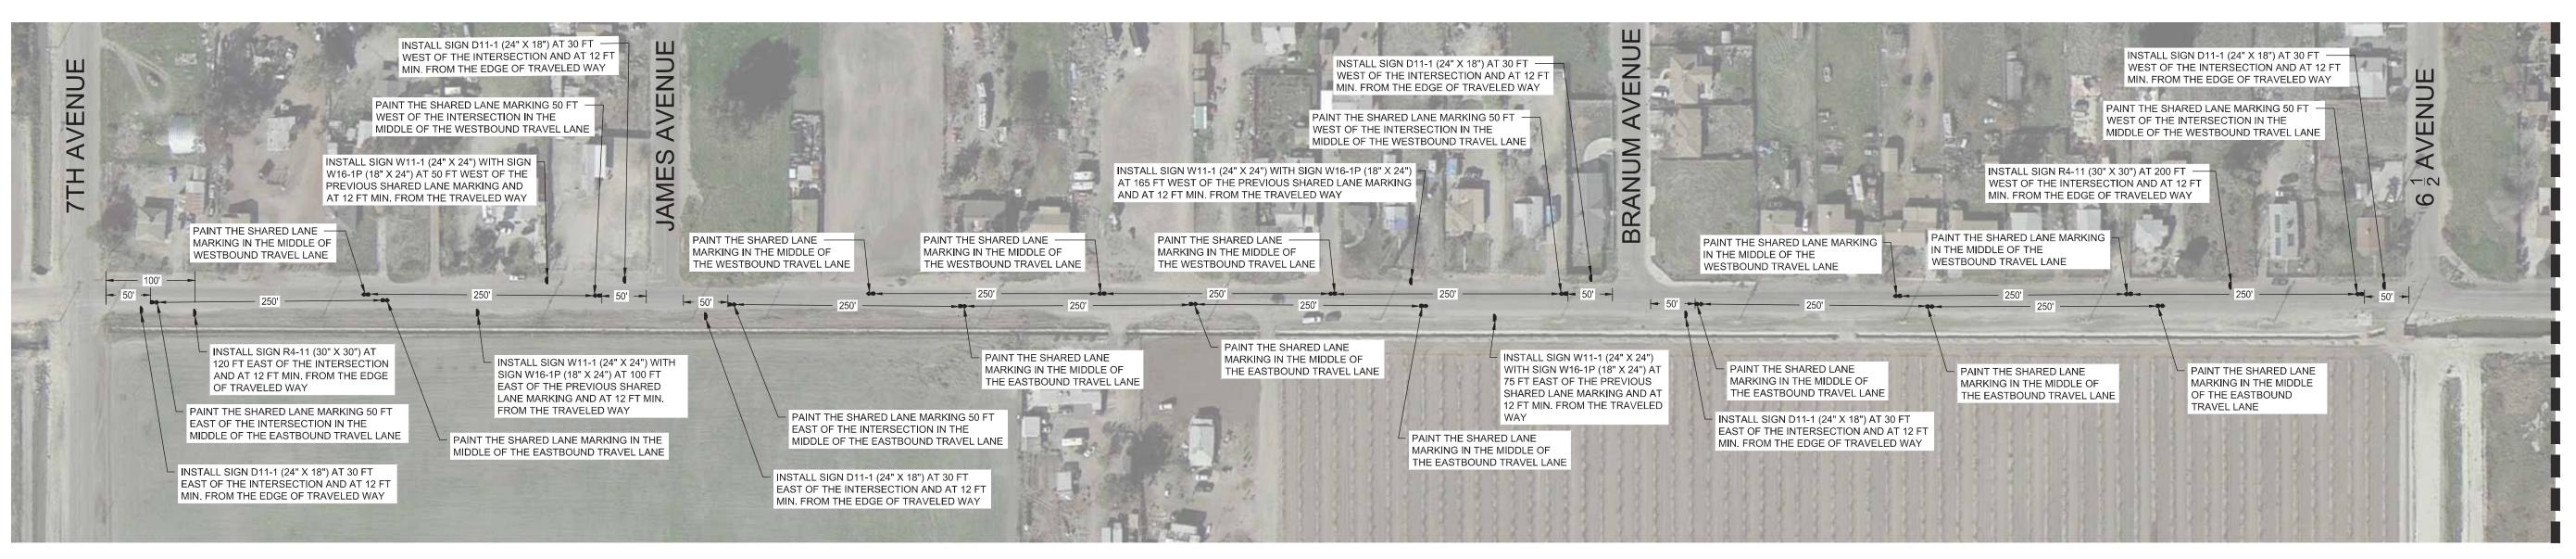









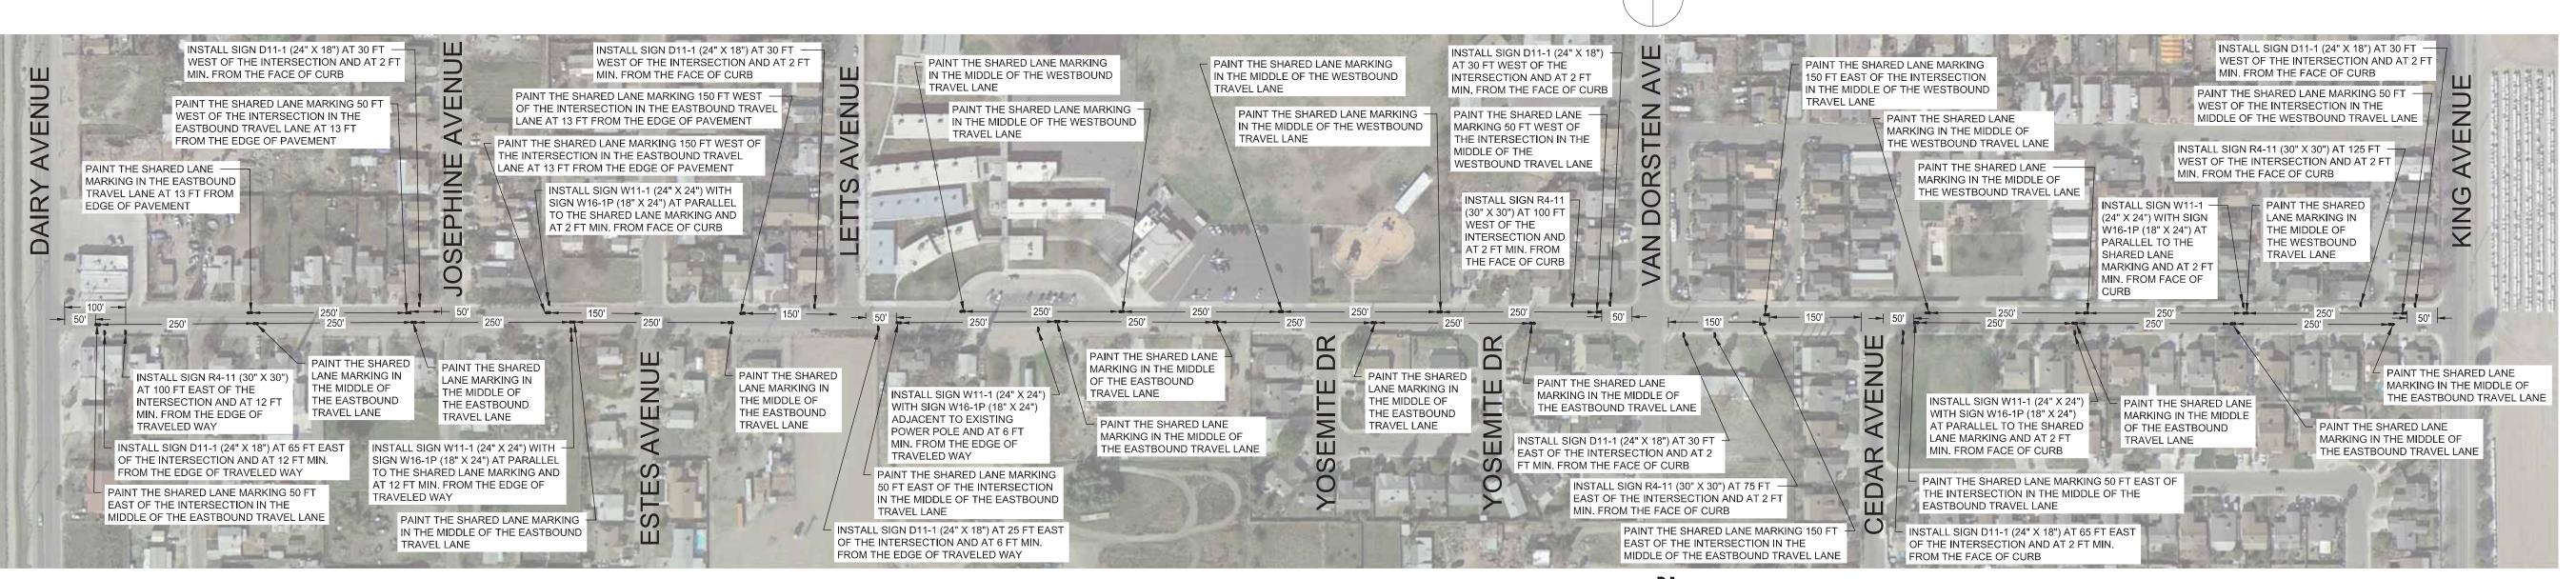


# **OREGON AVENUE (DAIRY AVE TO KING AVE)**

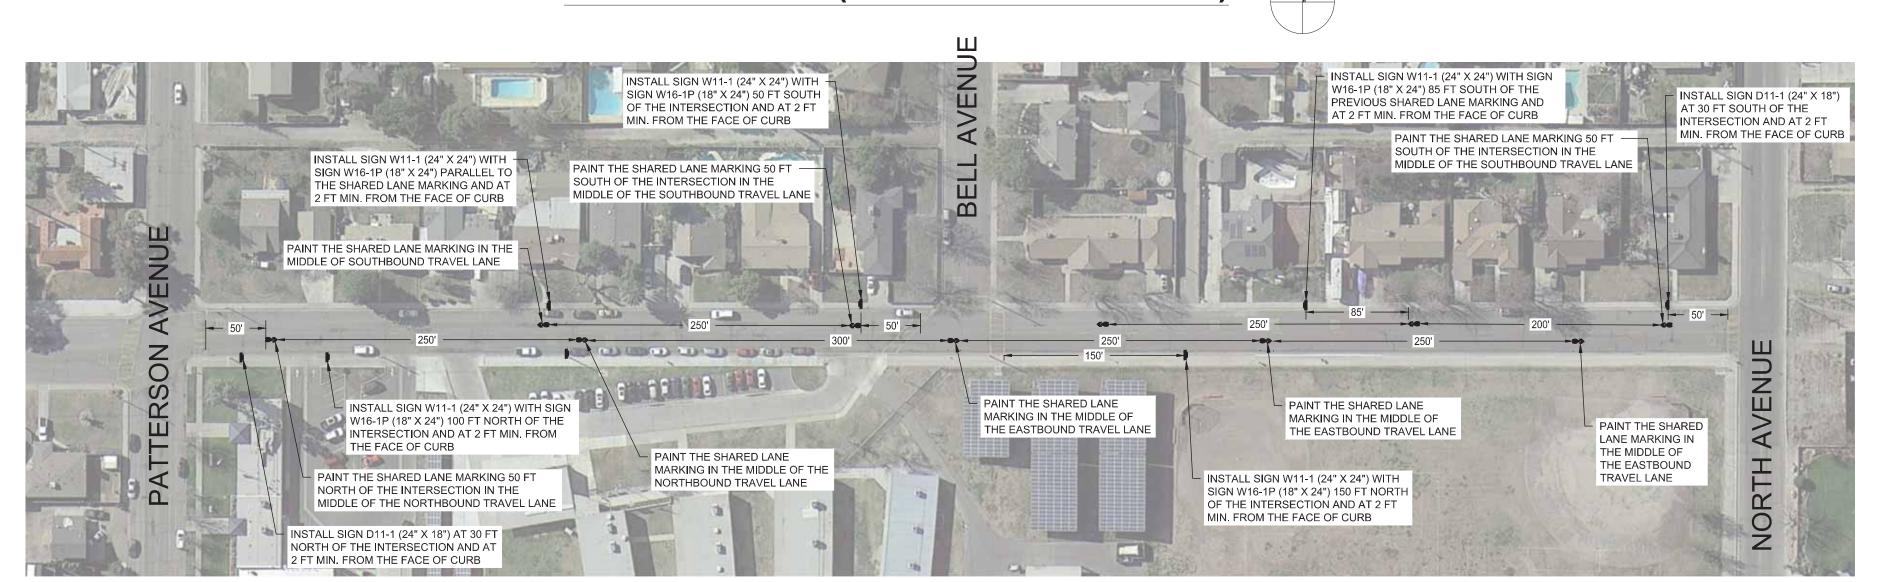

**LETTS AVENUE (PATTERSON AVE TO NORTH AVE)** 

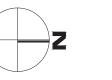


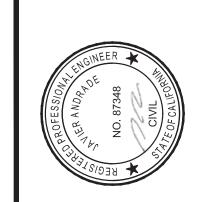

**IMPROVMENT** SIDEWAL CO





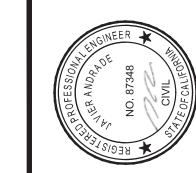

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CONSULTING EN

CORCORAN SIDEWALK IMPROVMENTS
SHEETTITE:

7 AVE SIDEWALK DEMOLITION PLAN

REVISIONS

220\_008 OM 9/4/2020


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**ROLL CURB DETAIL** 

SECTION A-A

A WEAKENED PLANE JOINT OR COLD JOINT SHALL BE INSTALLED AT THE END OF CURB RETURNS AND AT THE CENTERLINE OF PROPOSED DRIVE APPROACHES.

NOTES:

**PATTERSON AVE.** 

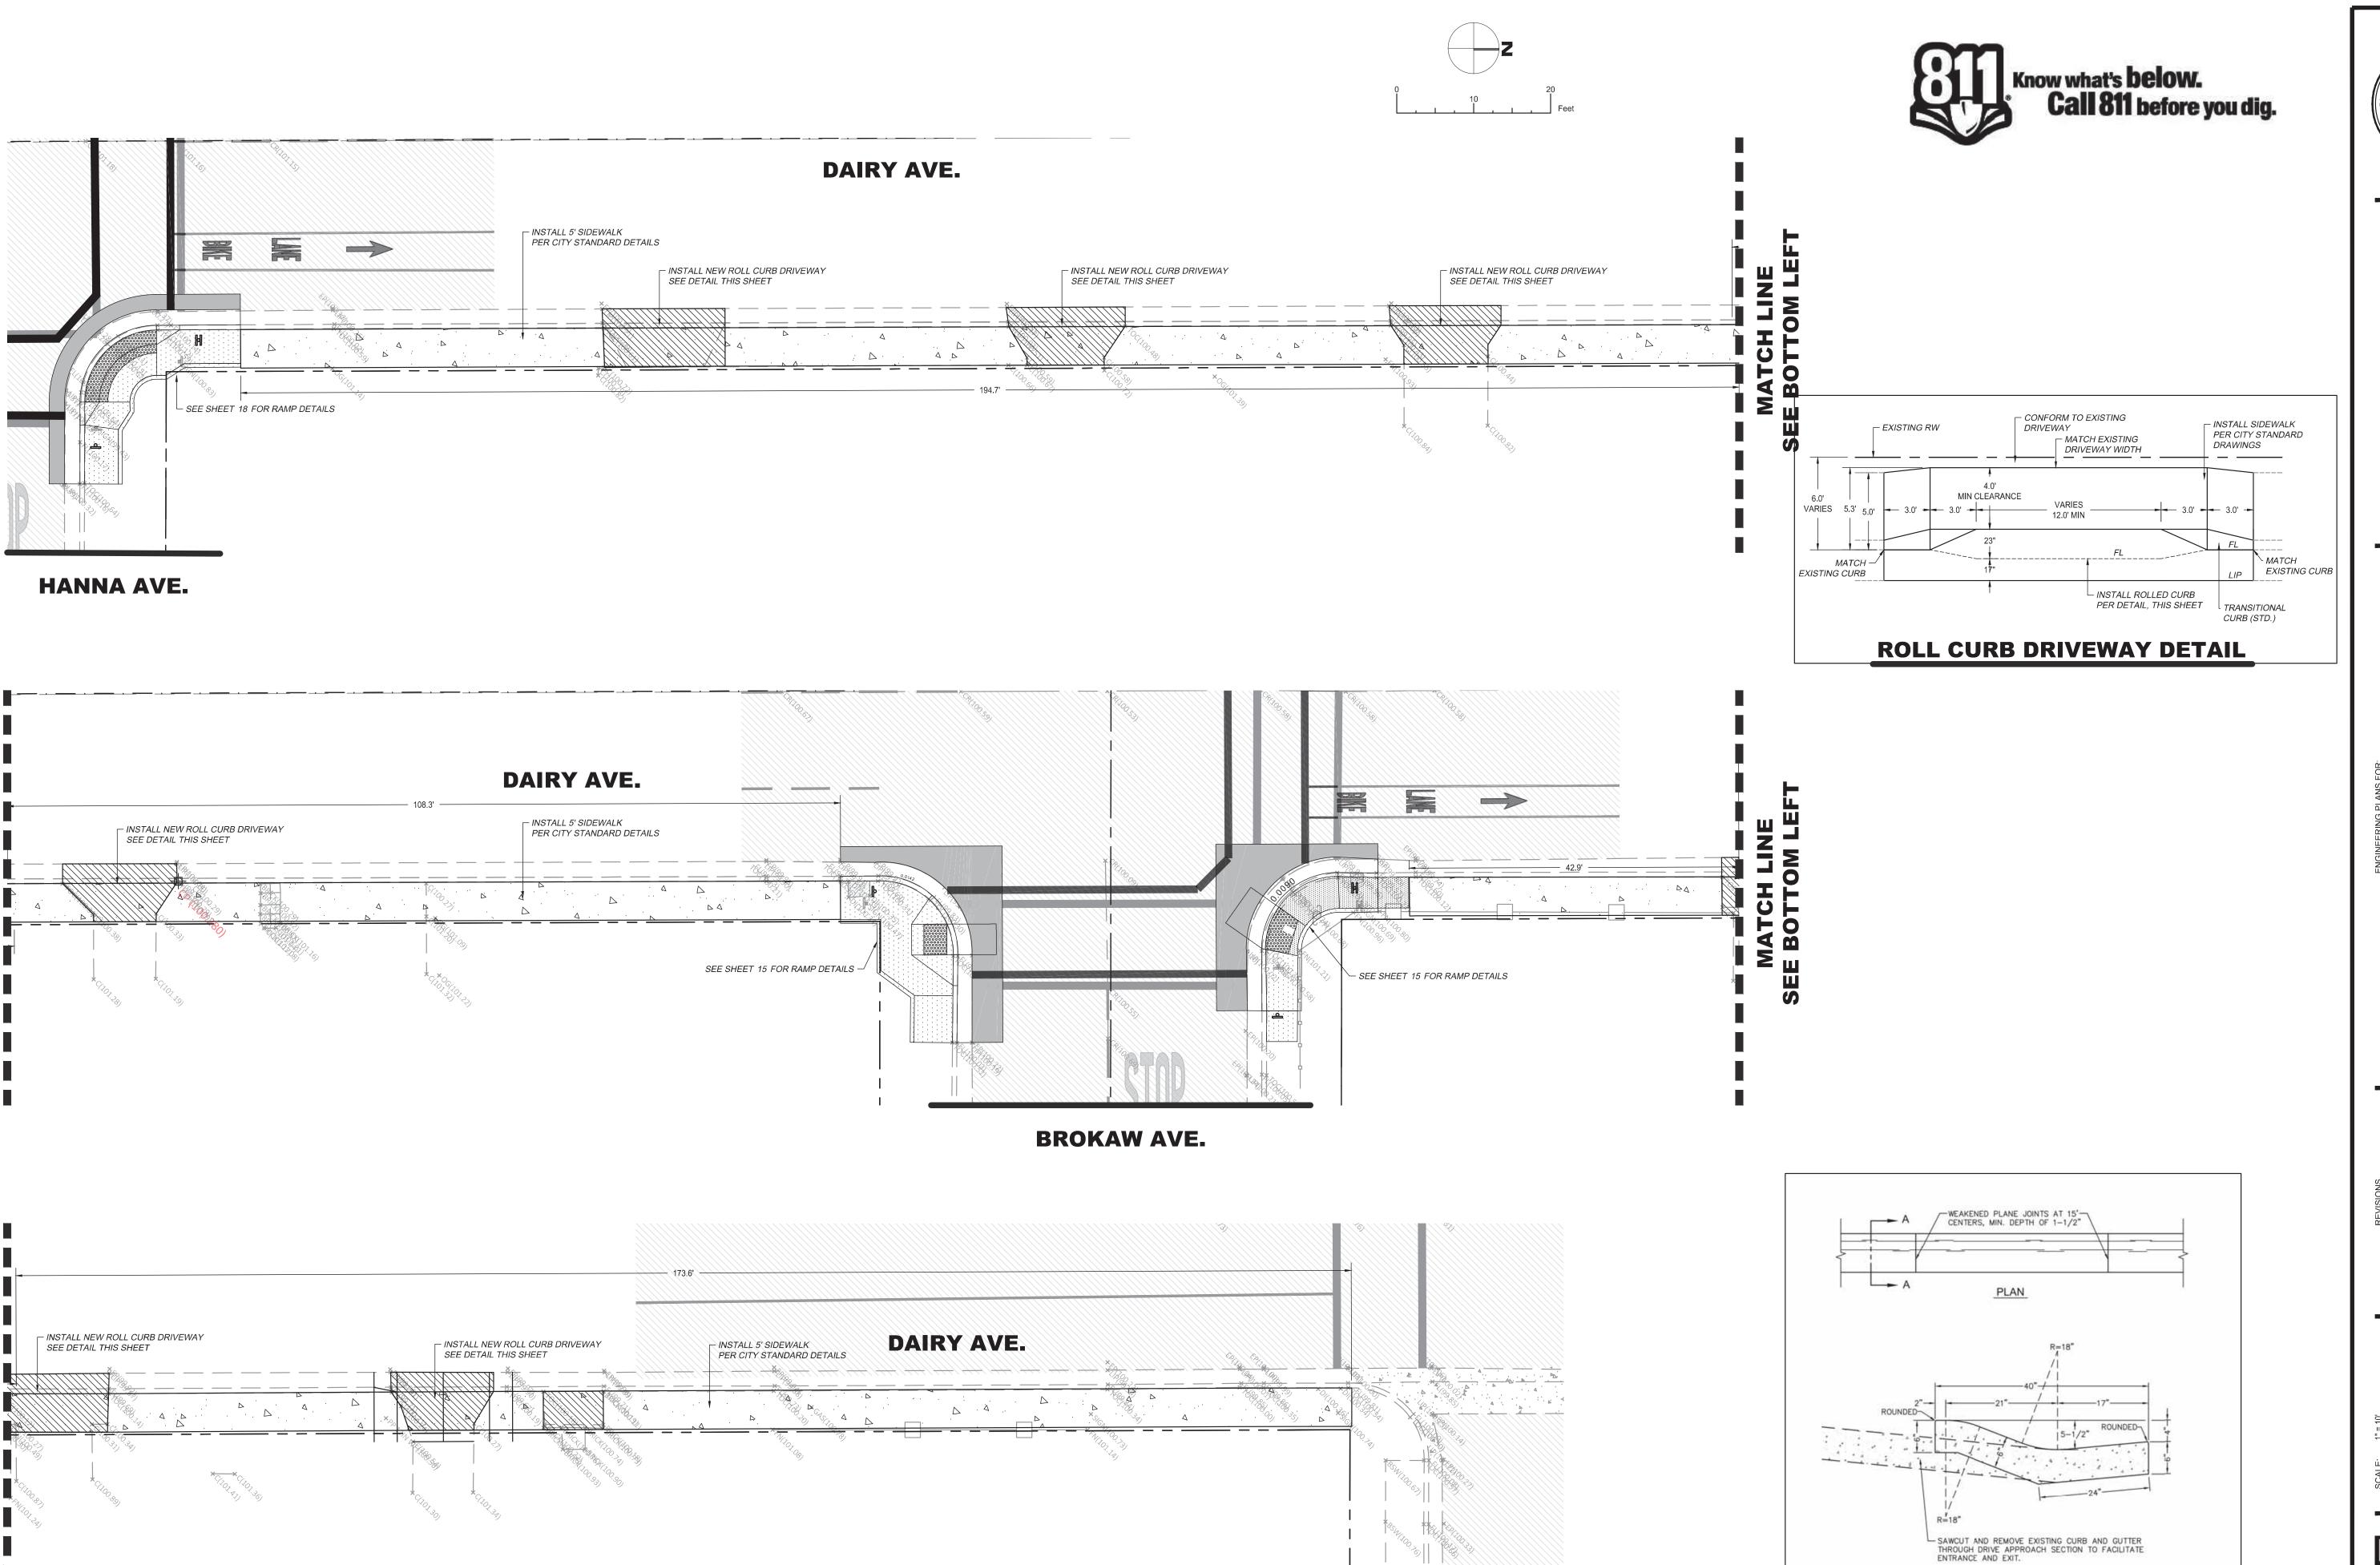1. ALL CONCRETE SHALL BE CLASS 3 CONCRETE.

SIDEWALK COF OF




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# **CONTRACTOR NOTES**


- 1. IT IS THE RESPONSIBILITY OF THE CONTRACTOR TO PRESERVE ALL SURVEY MONUMENTS. ANY MONUMENT DISTURBED DURING CONSTRUCTION SHALL BE PERPETUATED PER THE PROFESSIONAL LAND SURVEYOR'S ACT, BUSINESS AND PROFESSIONS CODE 8771, AT THE CONTRACTORS EXPENSE.
- 2. LOCATIONS OF EXISTING UTILITIES ARE APPROXIMATED. CONTRACTOR TO FIELD VERIFY ALL EXISTING UTILITIES BEFORE COMMENCEMENT OF WORK.

# **DEMOLITION NOTES**

- 1. SAWCUT EXISTING CONCRETE TO A NEAT CLEAN EDGE LINE
- 2. SAWCUT EXISTING PAVEMENT TO A NEAT CLEAN EDGE LINE
- 3. EXISTING STRIPING OR MARKING TO BE REMOVED BY SANDING OR WATER BLASTING
- 4. REMOVE AND RELOCATE EXISTING STREET SIGN

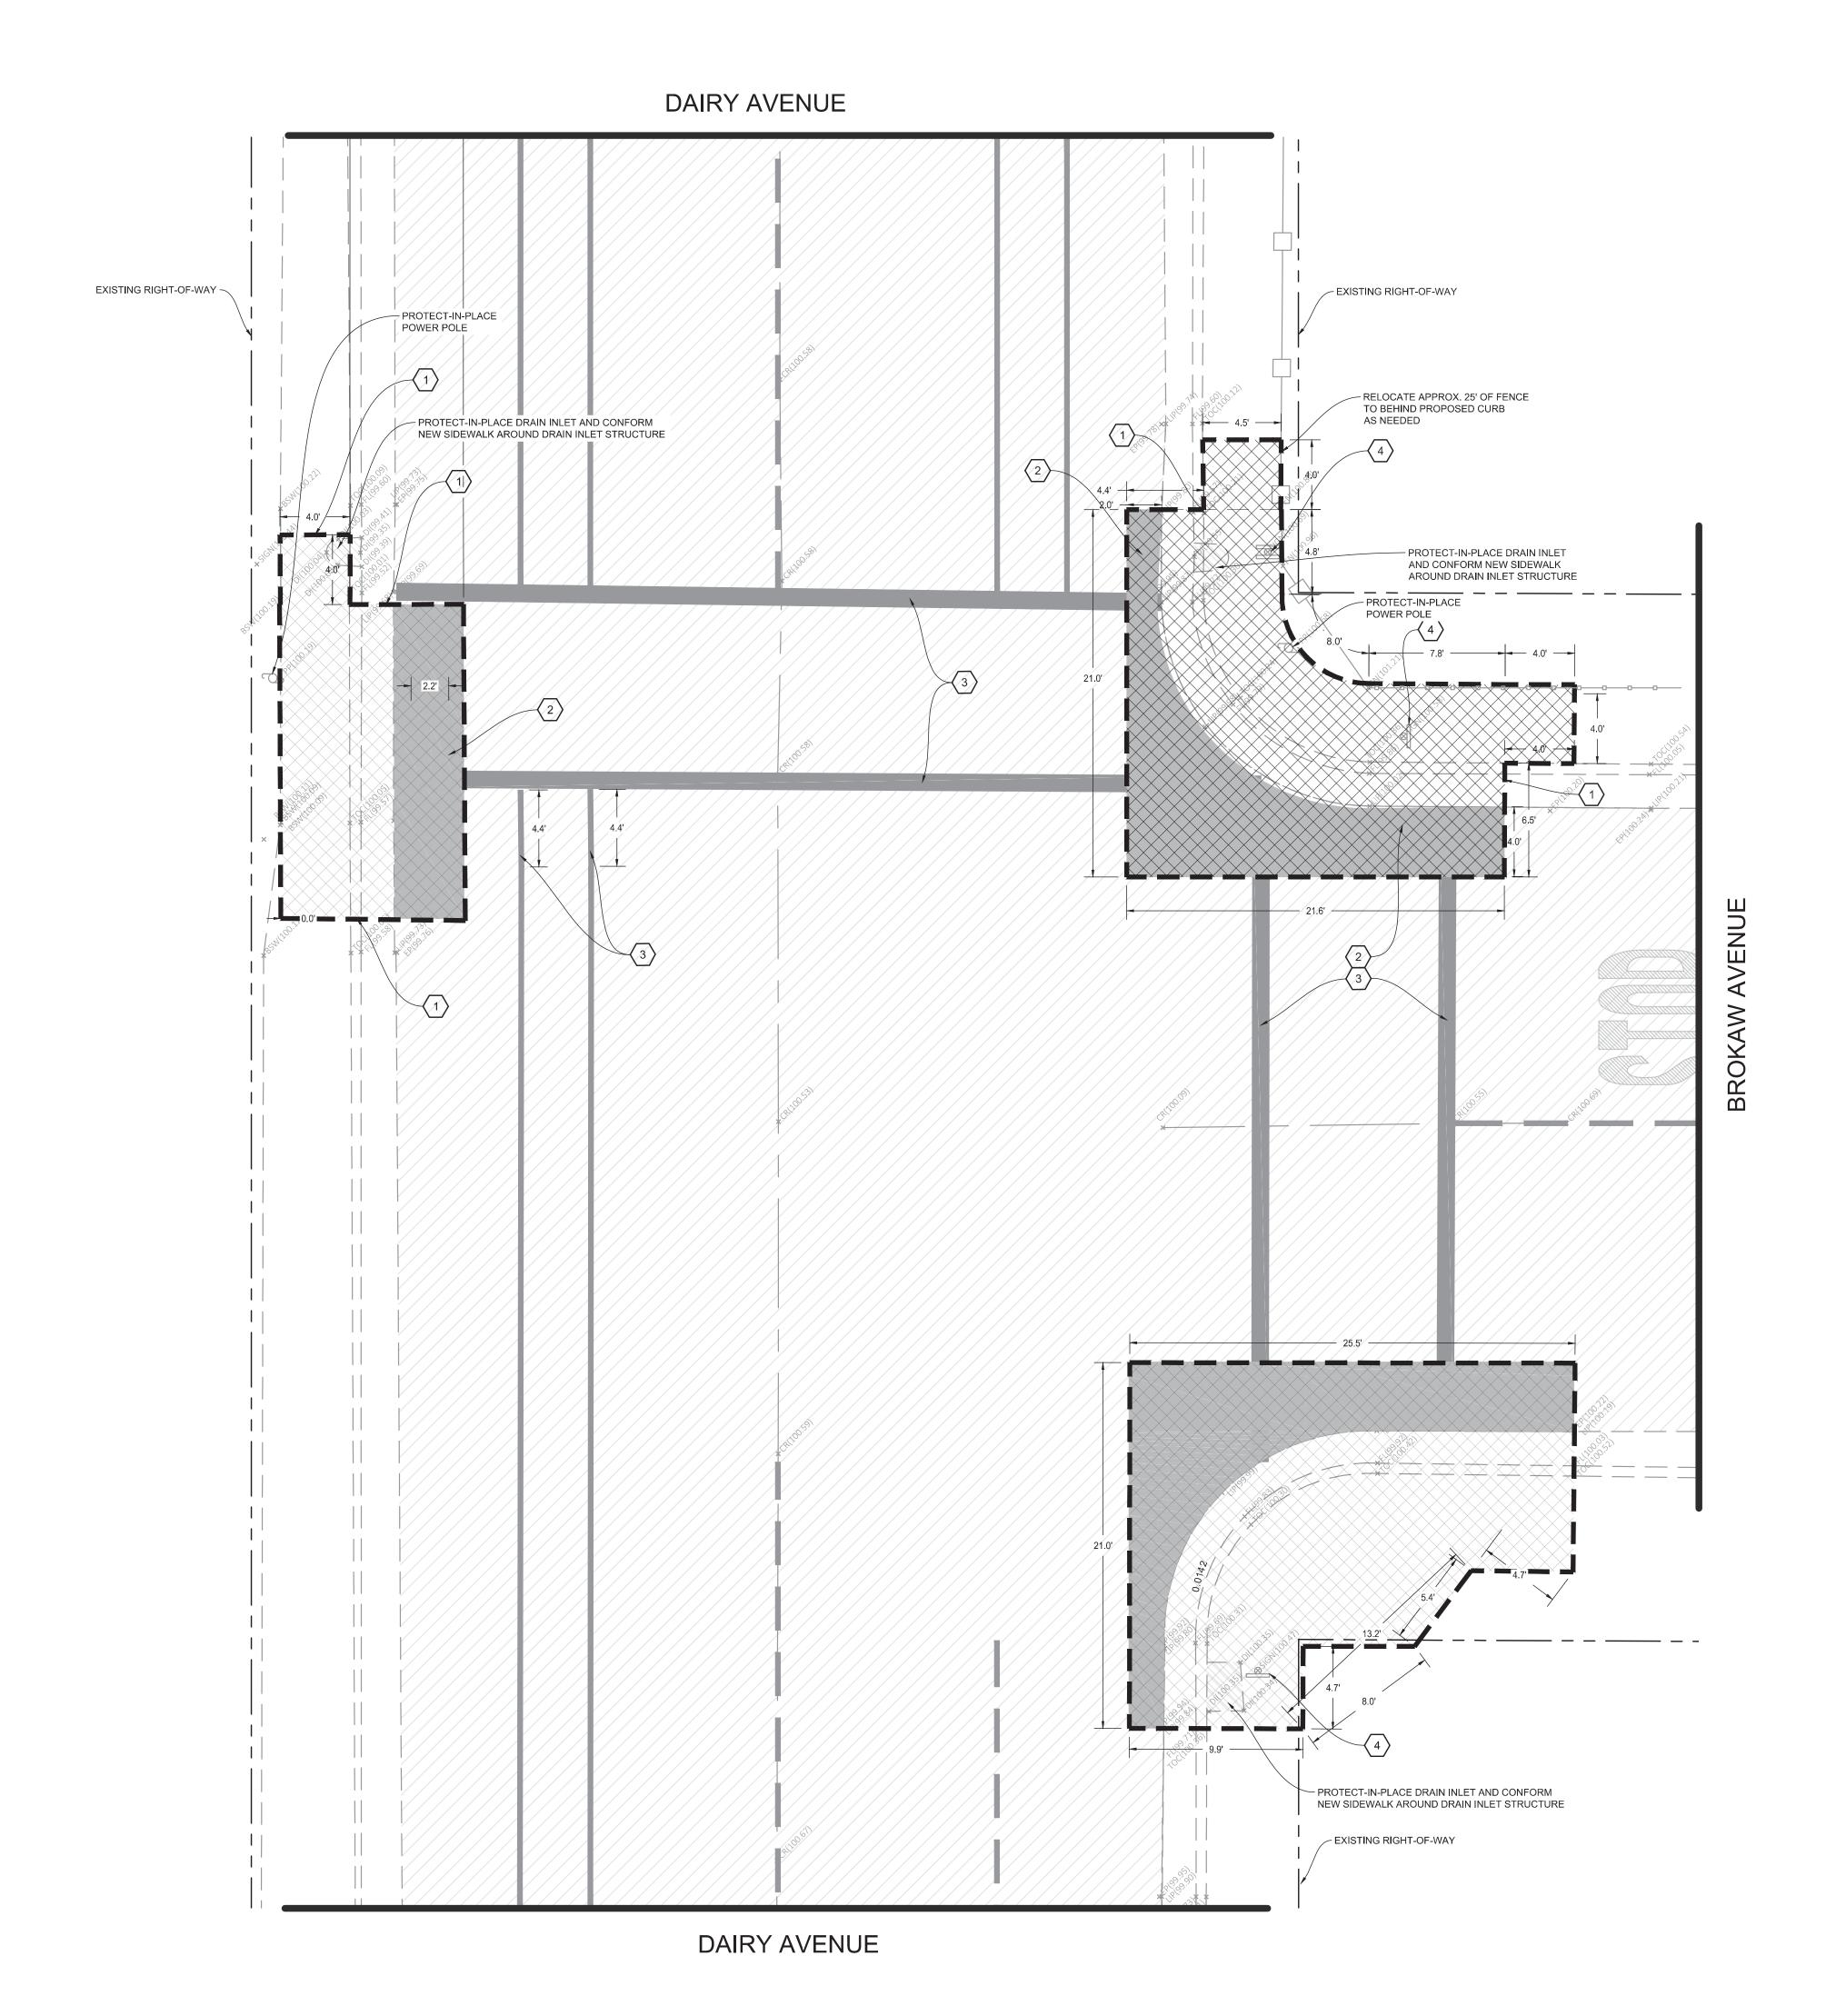

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# **CONTRACTOR NOTES**

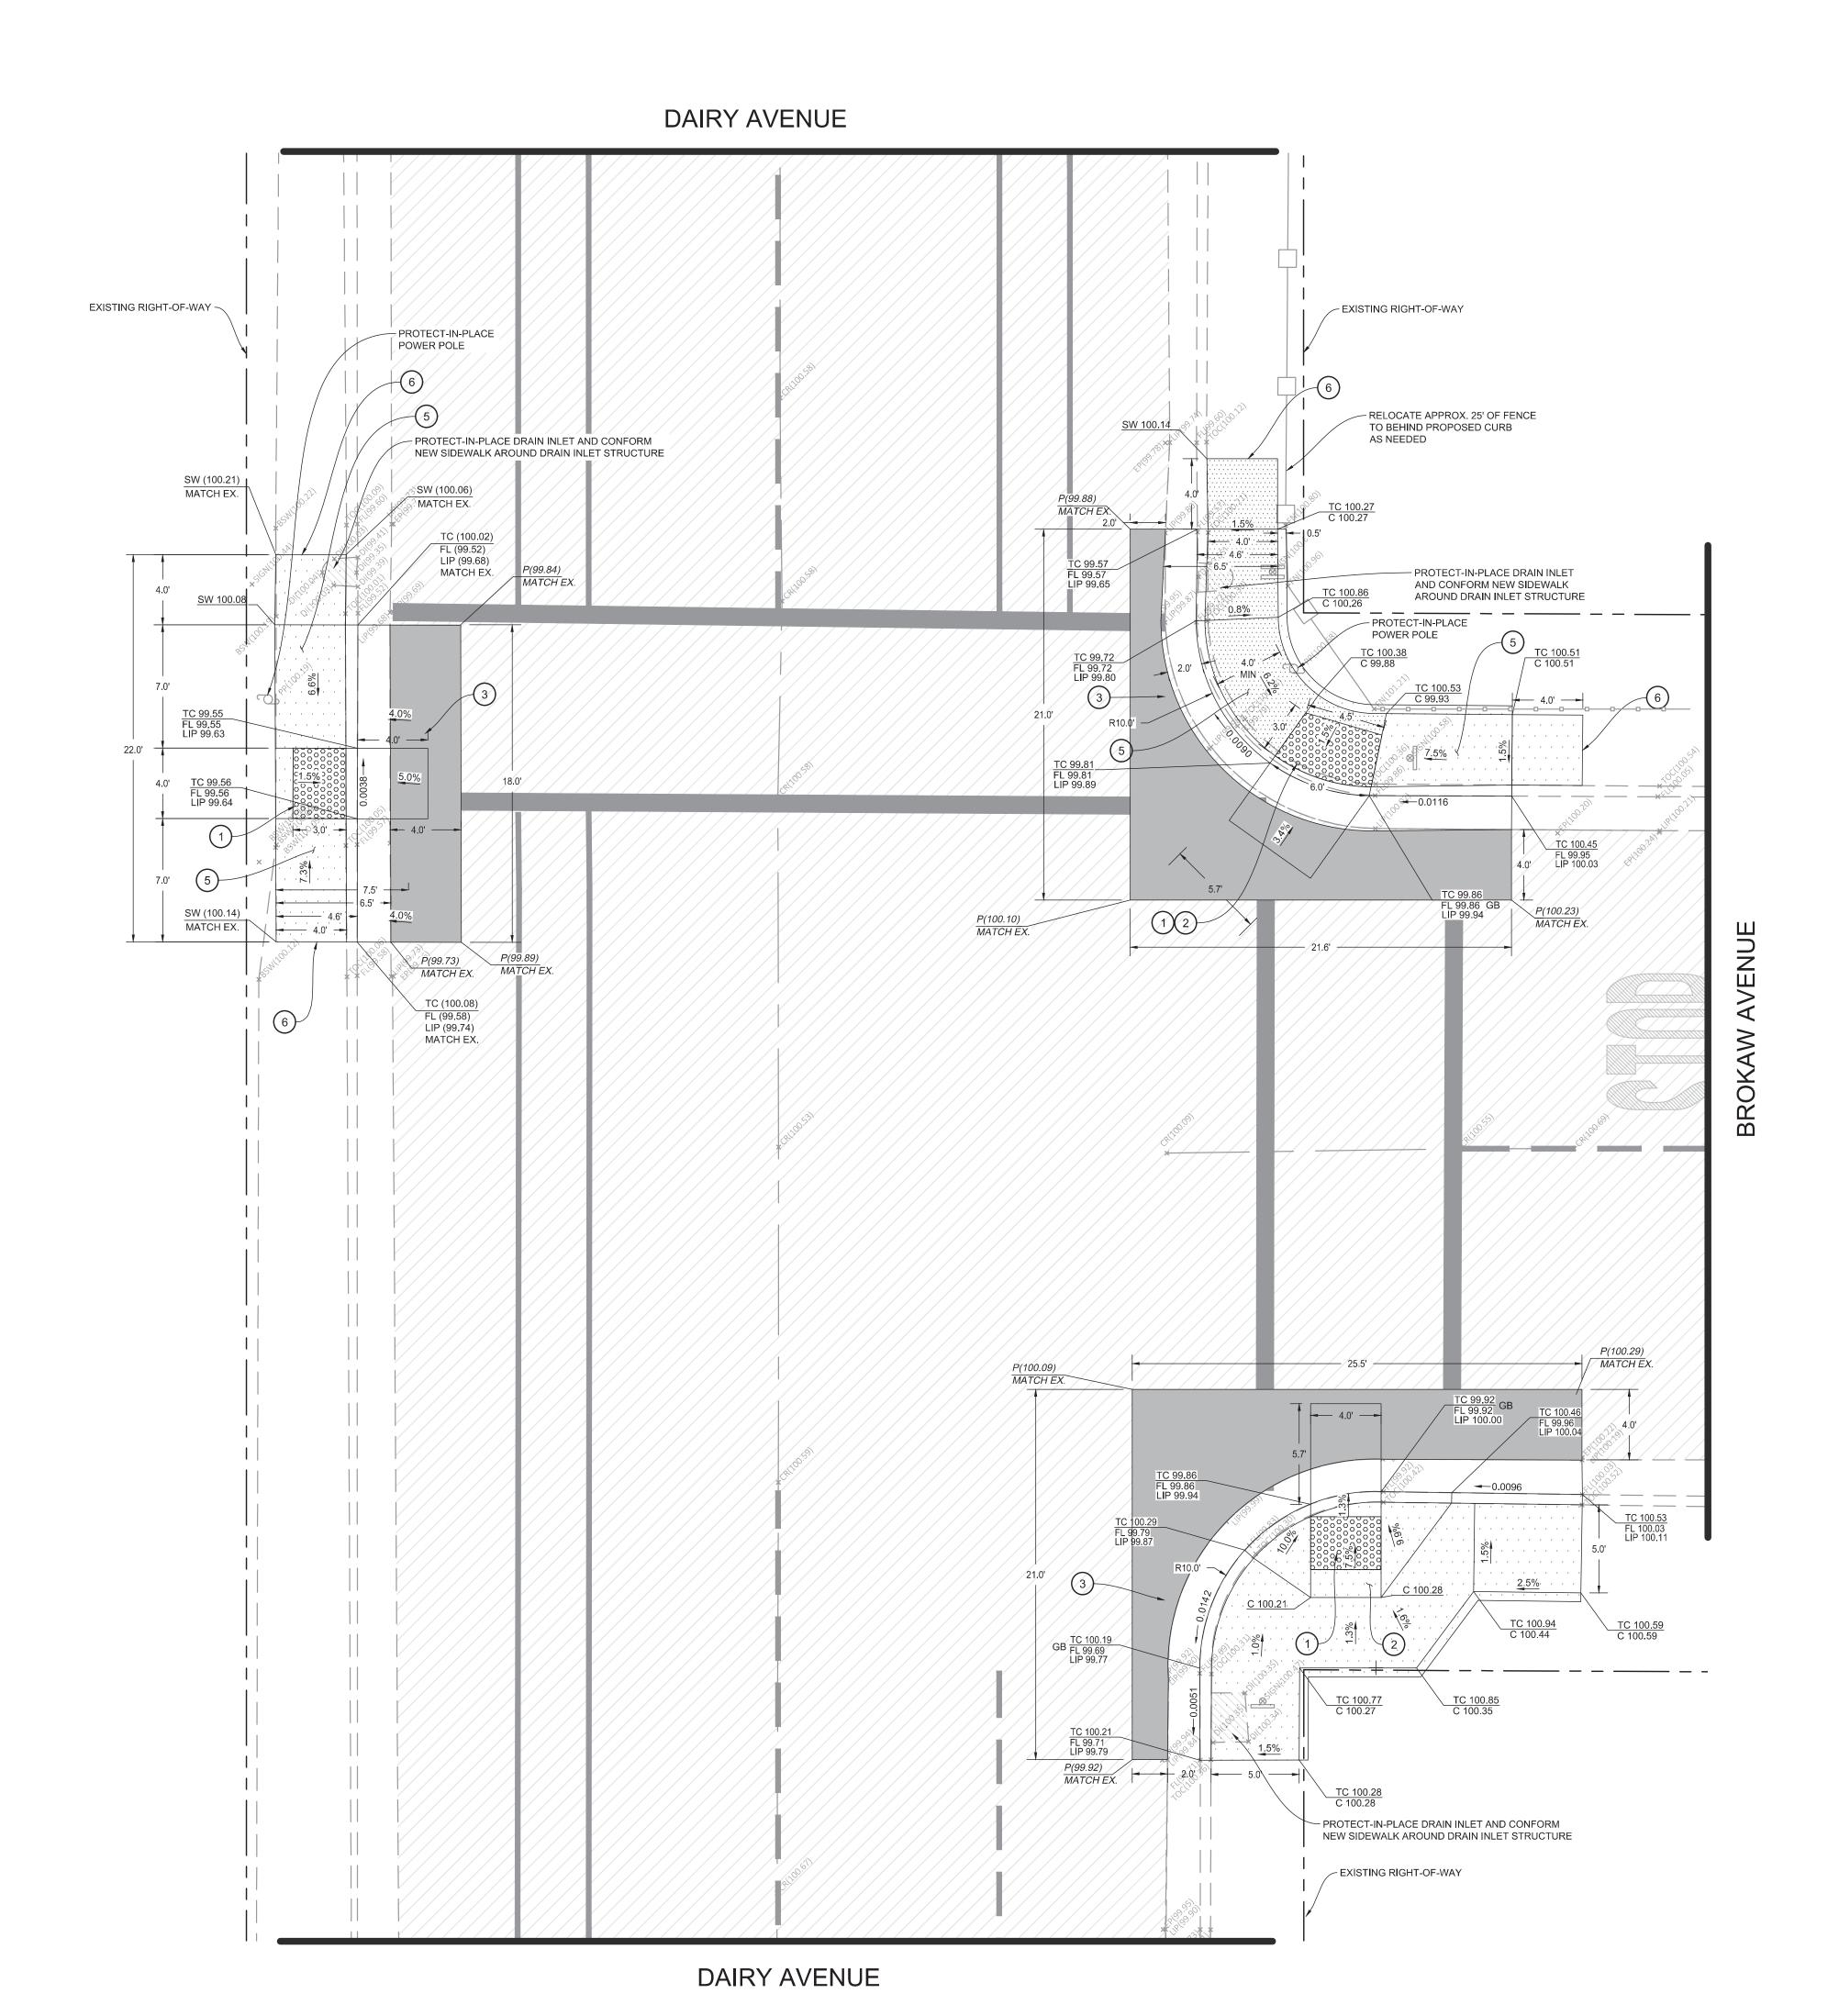
- 1. IT IS THE RESPONSIBILITY OF THE CONTRACTOR TO PRESERVE ALL SURVEY MONUMENTS. ANY MONUMENT DISTURBED DURING CONSTRUCTION SHALL BE PERPETUATED PER THE PROFESSIONAL LAND SURVEYOR'S ACT, BUSINESS AND PROFESSIONS CODE 8771, AT THE CONTRACTORS EXPENSE.
- 2. LOCATIONS OF EXISTING UTILITIES ARE APPROXIMATED. CONTRACTOR TO FIELD VERIFY ALL EXISTING UTILITIES BEFORE COMMENCEMENT OF WORK.


# **CONSTRUCTION NOTES**

- 1.) INSTALL 3' DEEP BY 4' WIDE DETECTABLE WARNING SURFACE (RAISED TRUNCATED DOMES)
- (2.) CONSTRUCT NEW ACCESSIBLE RAMPS AS SHOWN AND PER CITY STANDARD DETAIL C-6, SEE SHEET 61
- (3.) CONSTRUCT PAVEMENT PATCH PER DETAIL 01, SEE SHEET 59

6.) INSTALL WEAKENED PLANE JOINT AROUND RAMP PERIMETER (TYPICAL)

- (4.) CONSTRUCT CONCRETE CURB AND GUTTER PER DETAIL 10, SEE SHEET 59
- (5.) HEAVY BROOM FINISH ACROSS SLOPE OF RAMPS (TYPICAL)

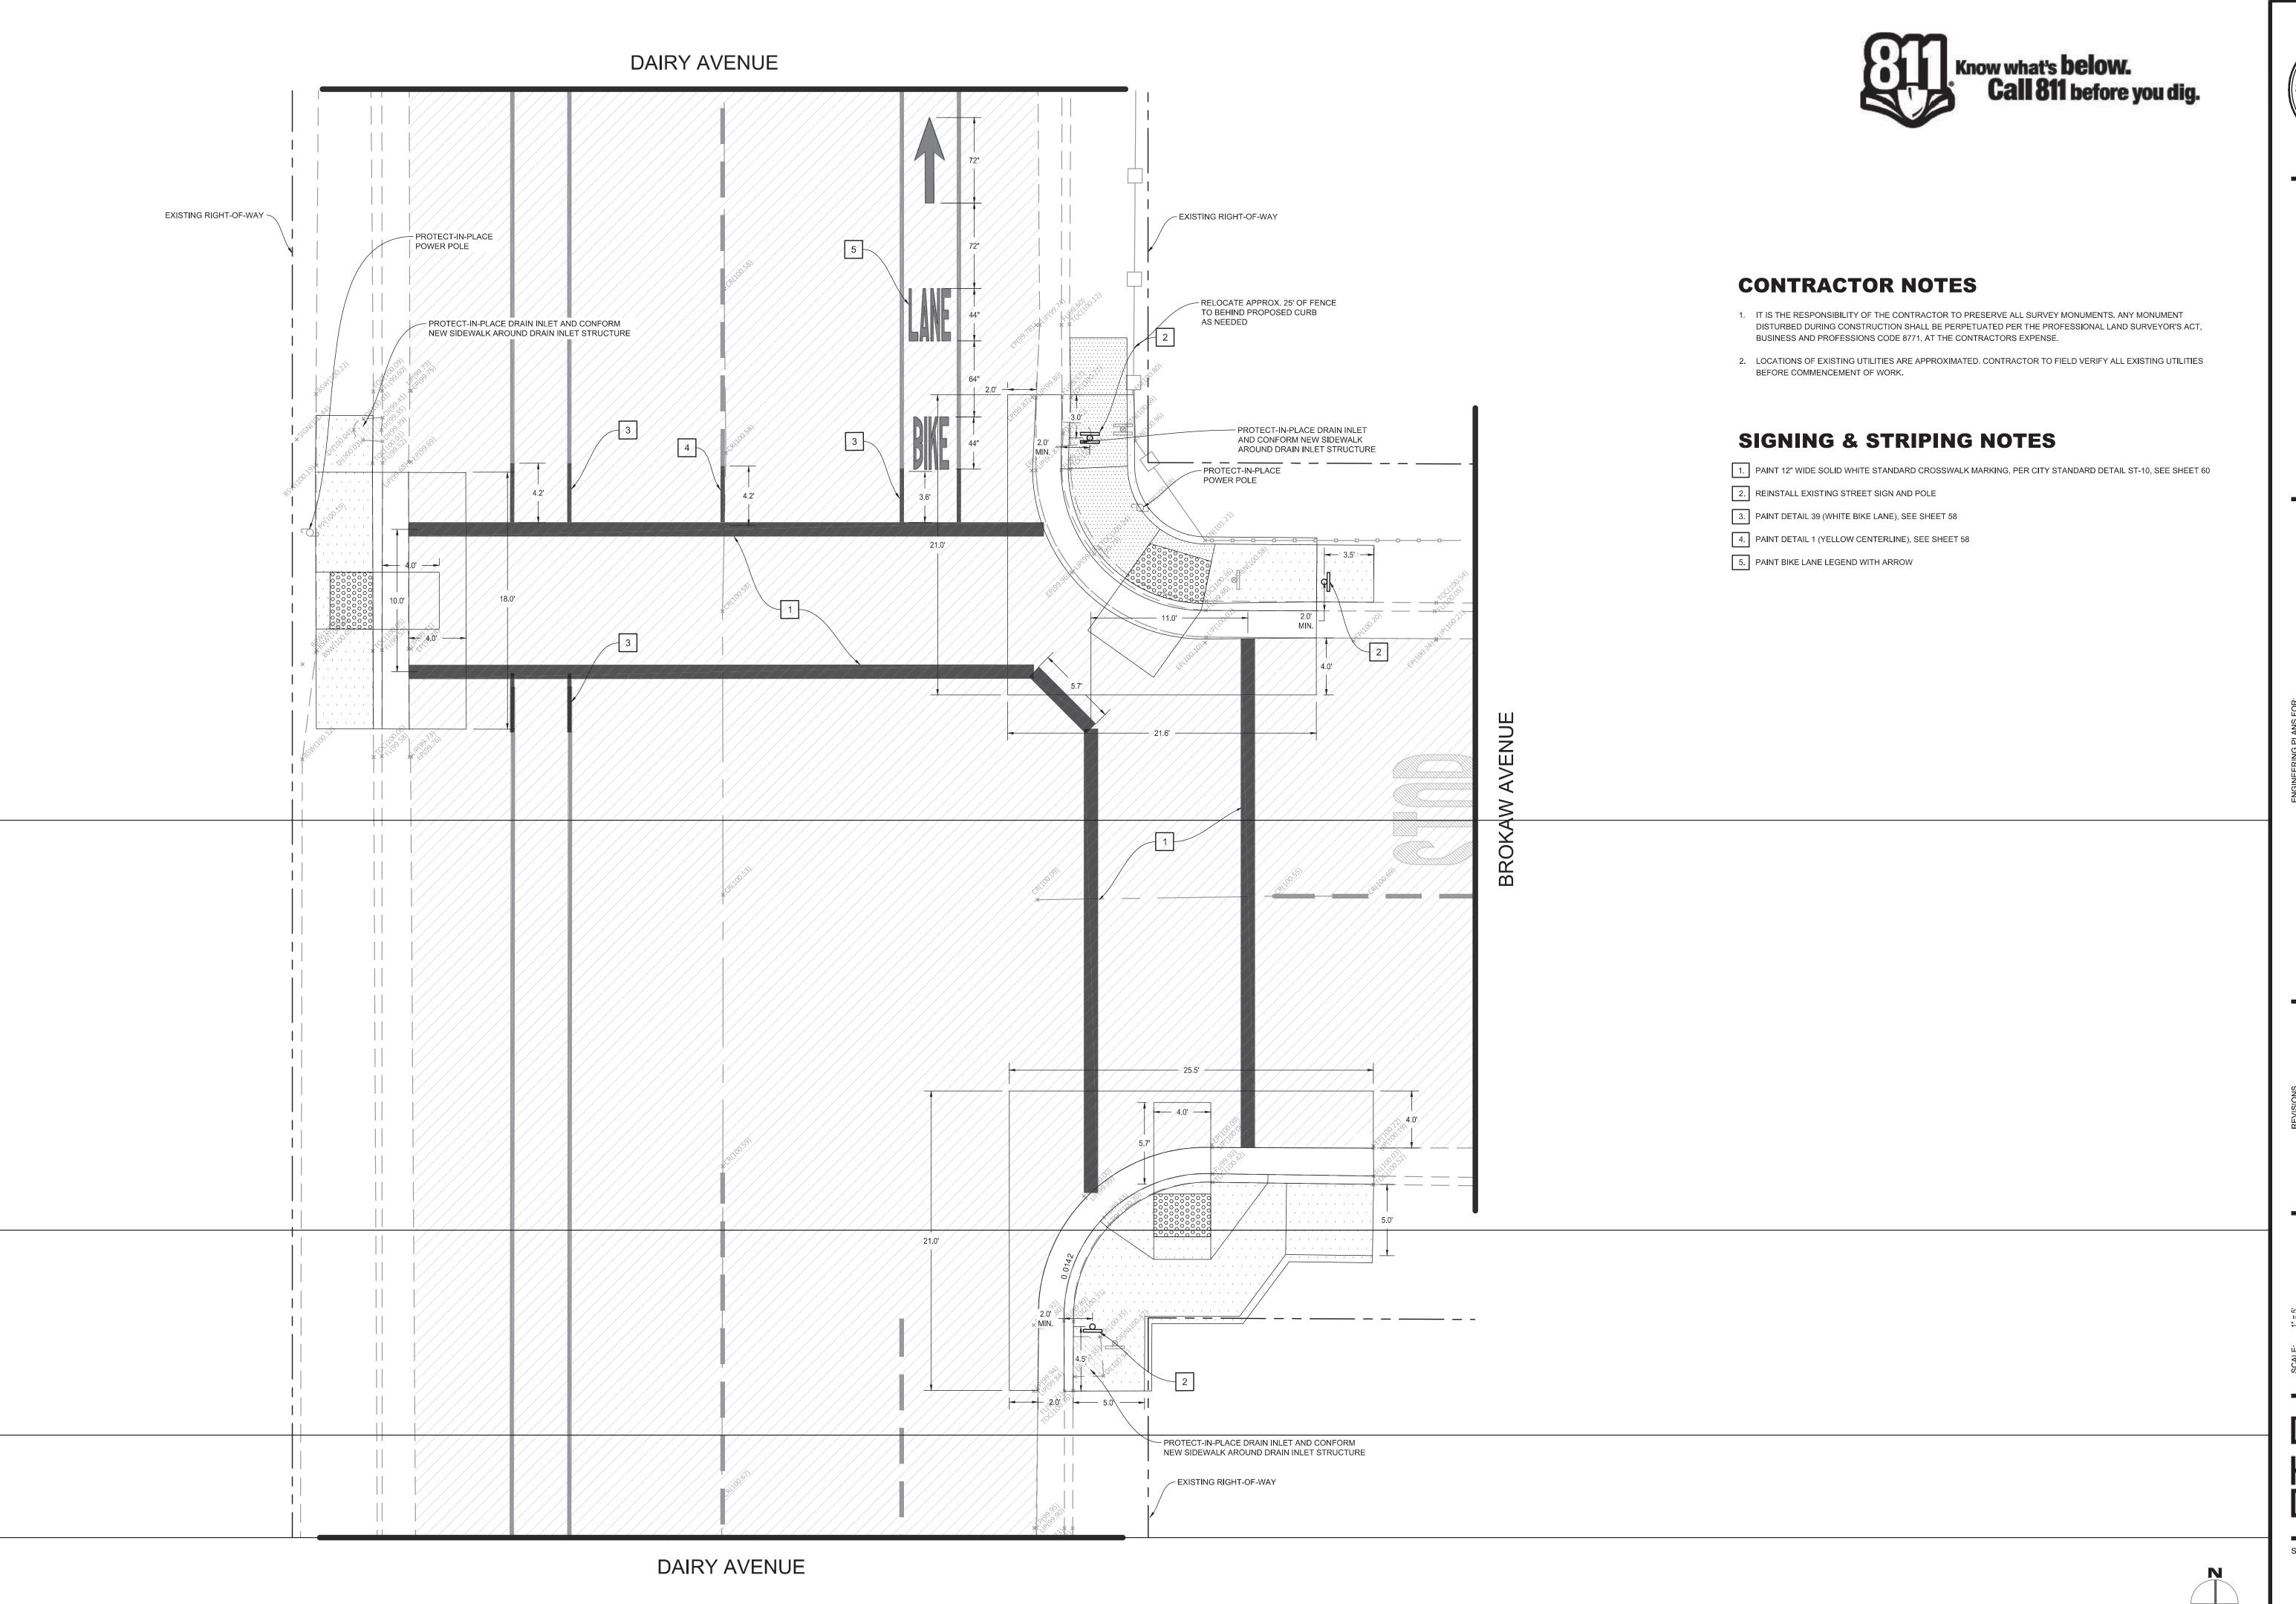

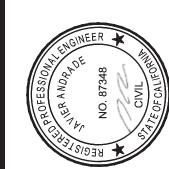





SIDEWALK IMPROVMENTS COF





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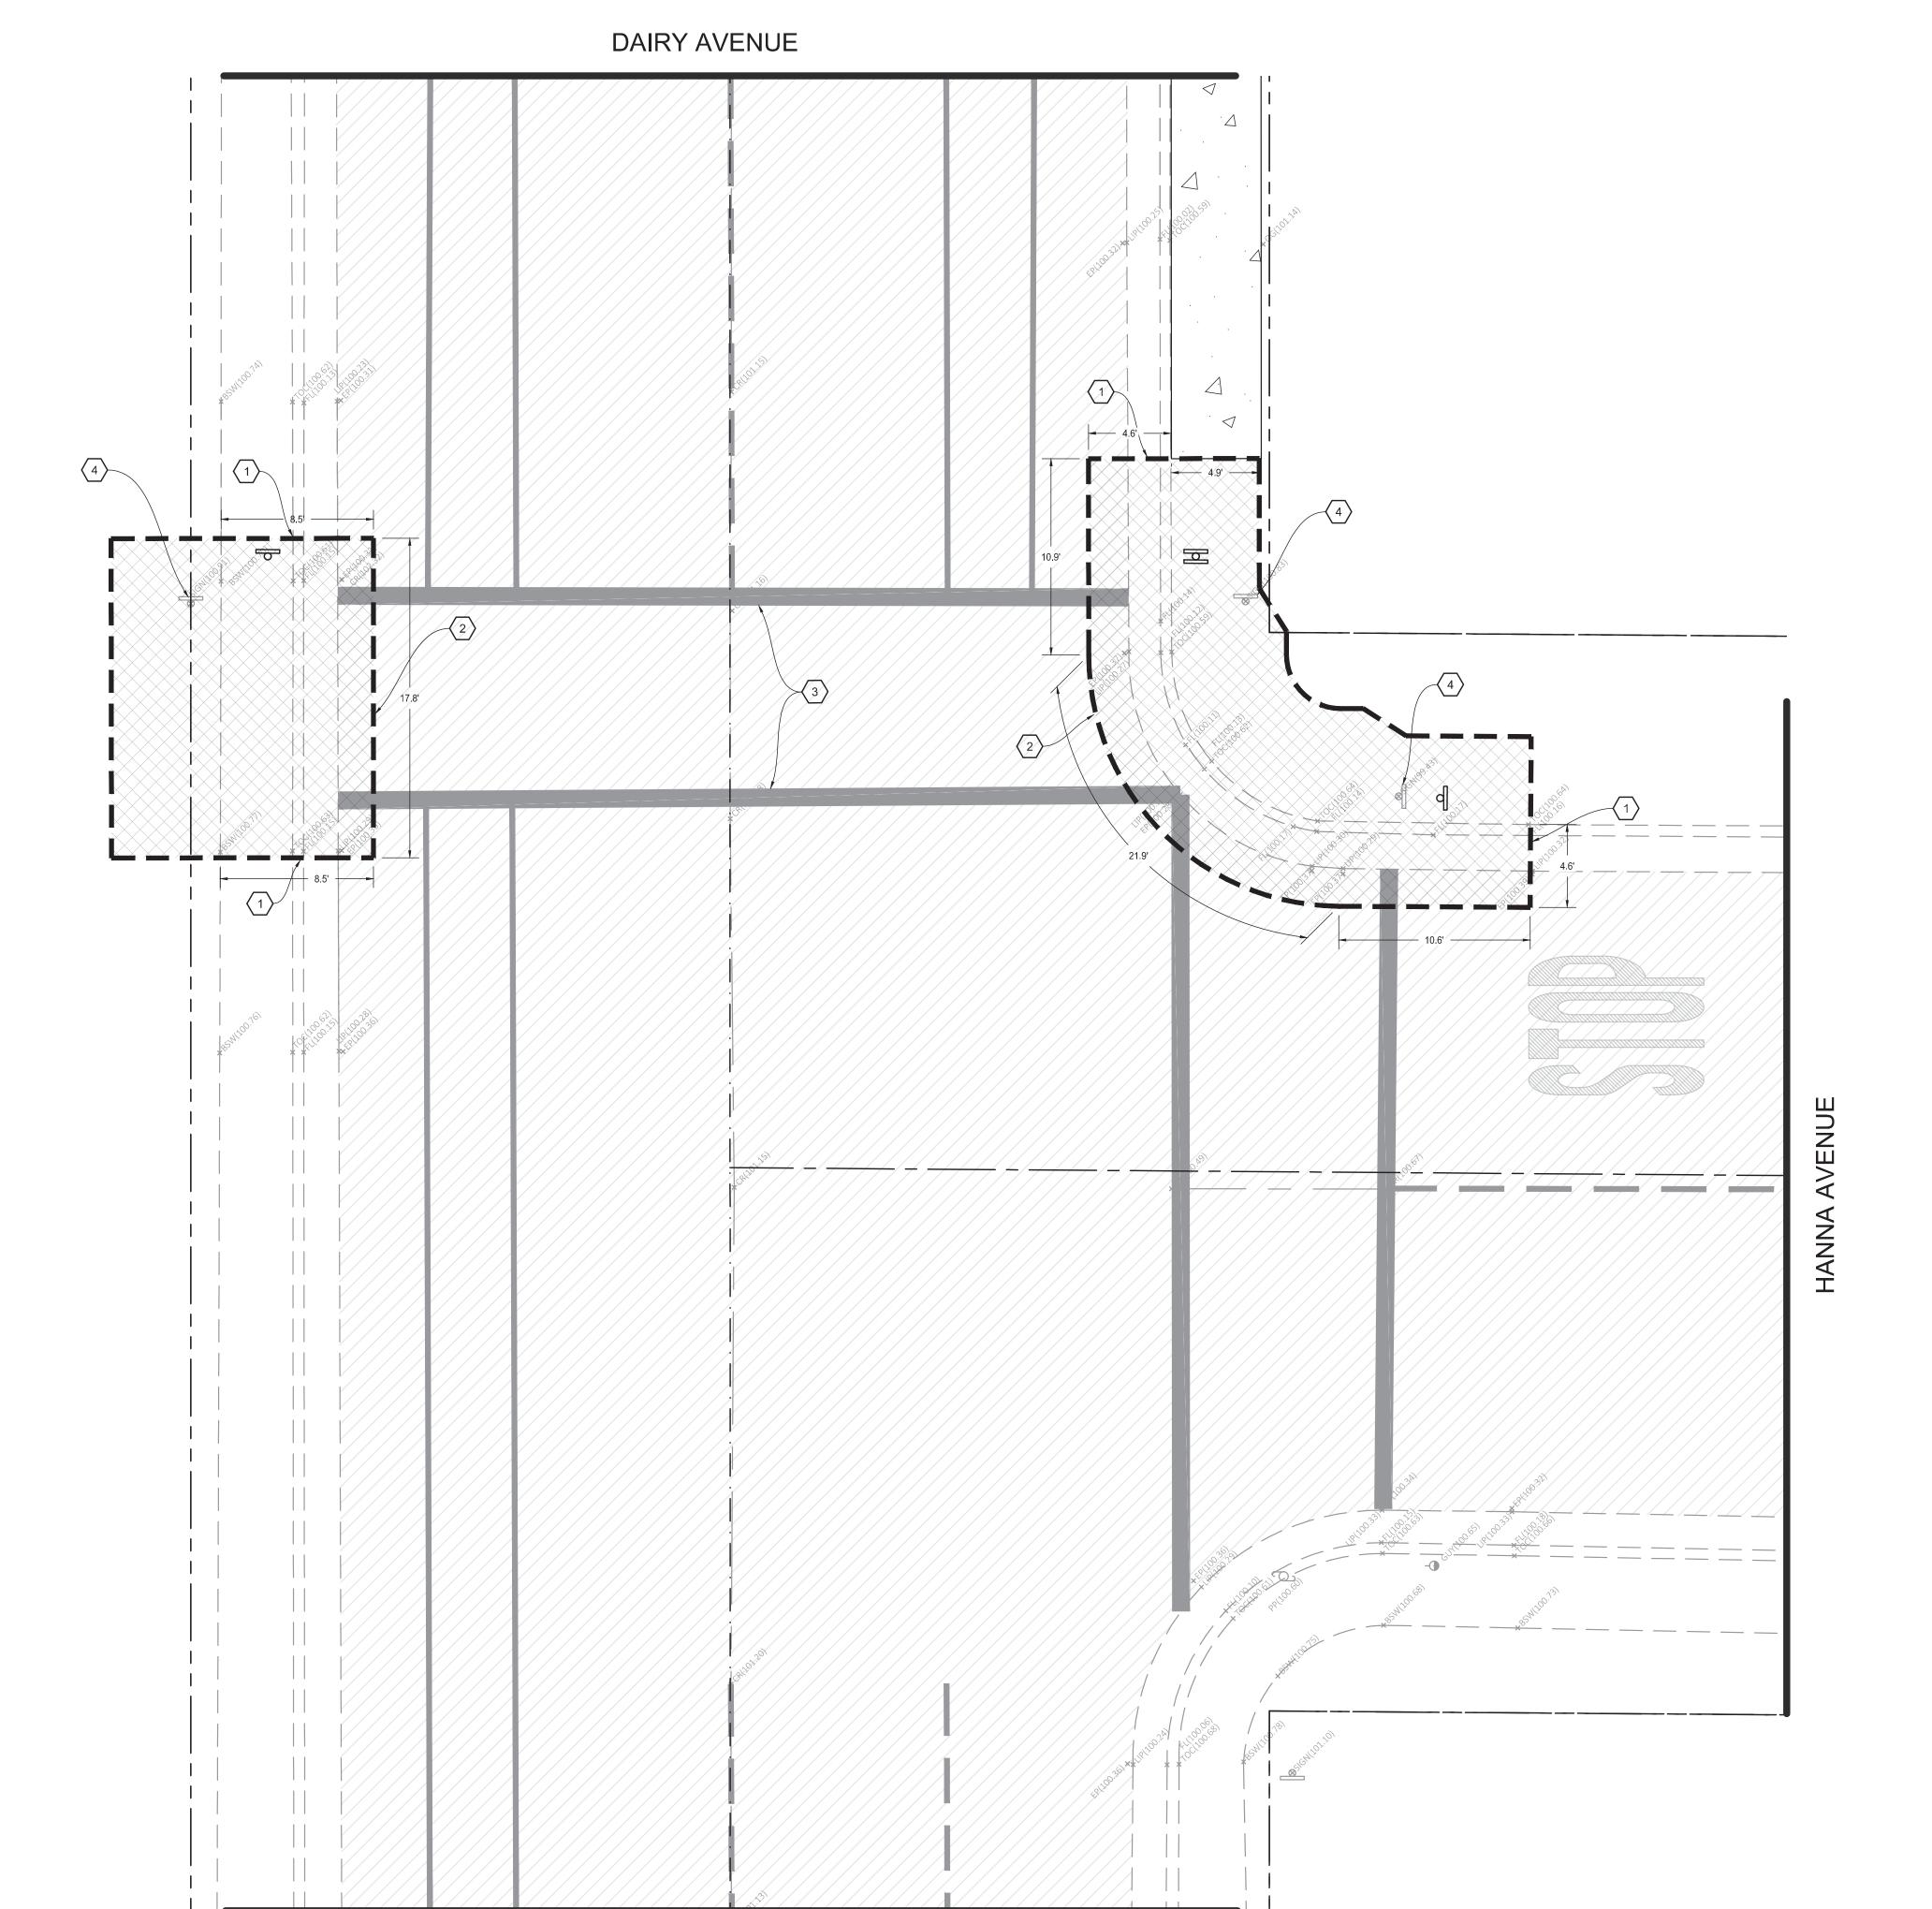


**CONTRACTOR NOTES** 

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- 2. LOCATIONS OF EXISTING UTILITIES ARE APPROXIMATED. CONTRACTOR TO FIELD VERIFY ALL EXISTING UTILITIES BEFORE COMMENCEMENT OF WORK.

# **DEMOLITION NOTES**

- 1. SAWCUT EXISTING CONCRETE TO A NEAT CLEAN EDGE LINE
- 2. SAWCUT EXISTING PAVEMENT TO A NEAT CLEAN EDGE LINE
- 3. EXISTING STRIPING OR MARKING TO BE REMOVED BY SANDING OR WATER BLASTING
- 4. REMOVE AND PRESERVE EXISTING STREET SIGN




DAIRY AVENUE

SCALE: TE JOB NO: 22 QA/QC: OI FILE:



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# **CONTRACTOR NOTES**

- 1. IT IS THE RESPONSIBILITY OF THE CONTRACTOR TO PRESERVE ALL SURVEY MONUMENTS. ANY MONUMENT DISTURBED DURING CONSTRUCTION SHALL BE PERPETUATED PER THE PROFESSIONAL LAND SURVEYOR'S ACT, BUSINESS AND PROFESSIONS CODE 8771, AT THE CONTRACTORS EXPENSE.
- 2. LOCATIONS OF EXISTING UTILITIES ARE APPROXIMATED. CONTRACTOR TO FIELD VERIFY ALL EXISTING UTILITIES BEFORE COMMENCEMENT OF WORK.
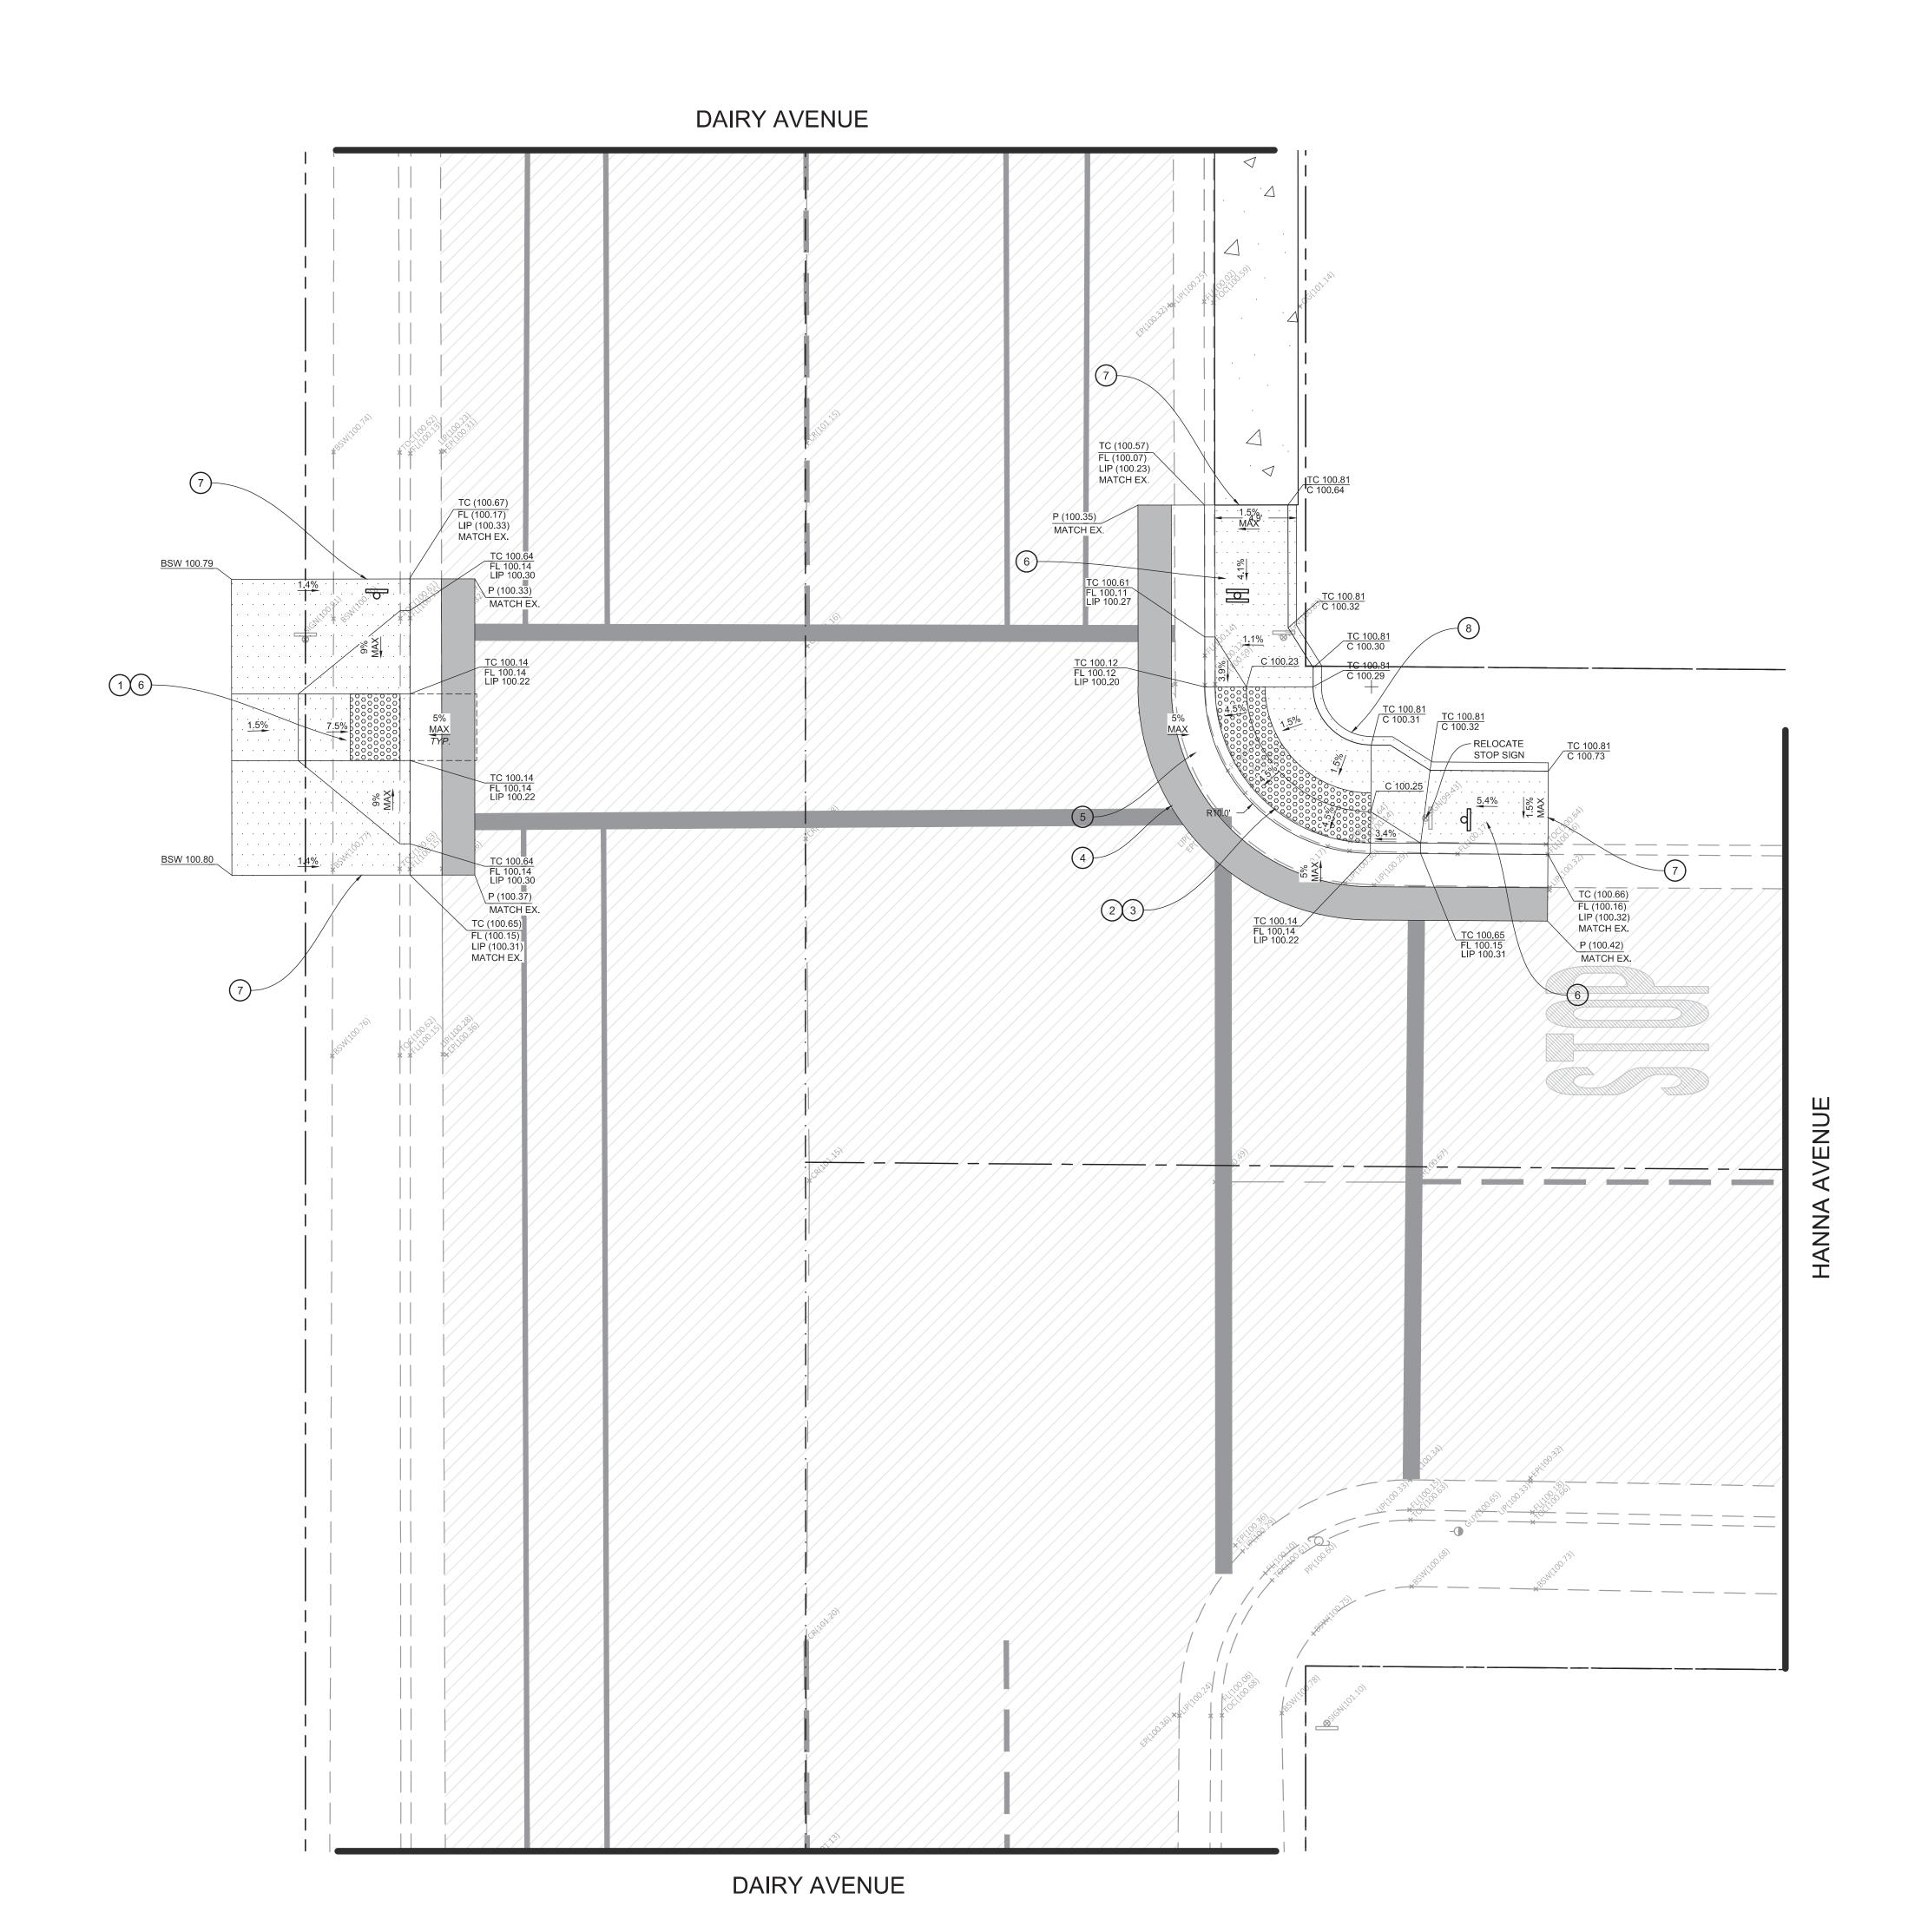
# **CONSTRUCTION NOTES**


- 1.) INSTALL 3' DEEP BY 4' WIDE DETECTABLE WARNING SURFACE (RAISED TRUNCATED DOMES)
- 2.) INSTALL 3' DEEP DETECTABLE WARNING SURFACE (RAISED TRUNCATED DOMES) ALONG THE RADIUS OF THE CURB
- 3.) CONSTRUCT NEW ACCESSIBLE RAMPS AS SHOWN AND PER CITY STANDARD DETAIL C-6, SEE SHEET 61
- 4.) CONSTRUCT PAVEMENT PATCH PER DETAIL 1, SEE SHEET 59
- 5.) CONSTRUCT CONCRETE CURB AND GUTTER PER DETAIL 10, SEE SHEET 59

7.) INSTALL WEAKENED PLANE JOINT AROUND RAMP PERIMETER (TYPICAL)

- 6. HEAVY BROOM FINISH ACROSS SLOPE OF RAMPS (TYPICAL)
- 8.) CONSTRUCT RETAINING CURB AS SHOWN



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# **CONTRACTOR NOTES**

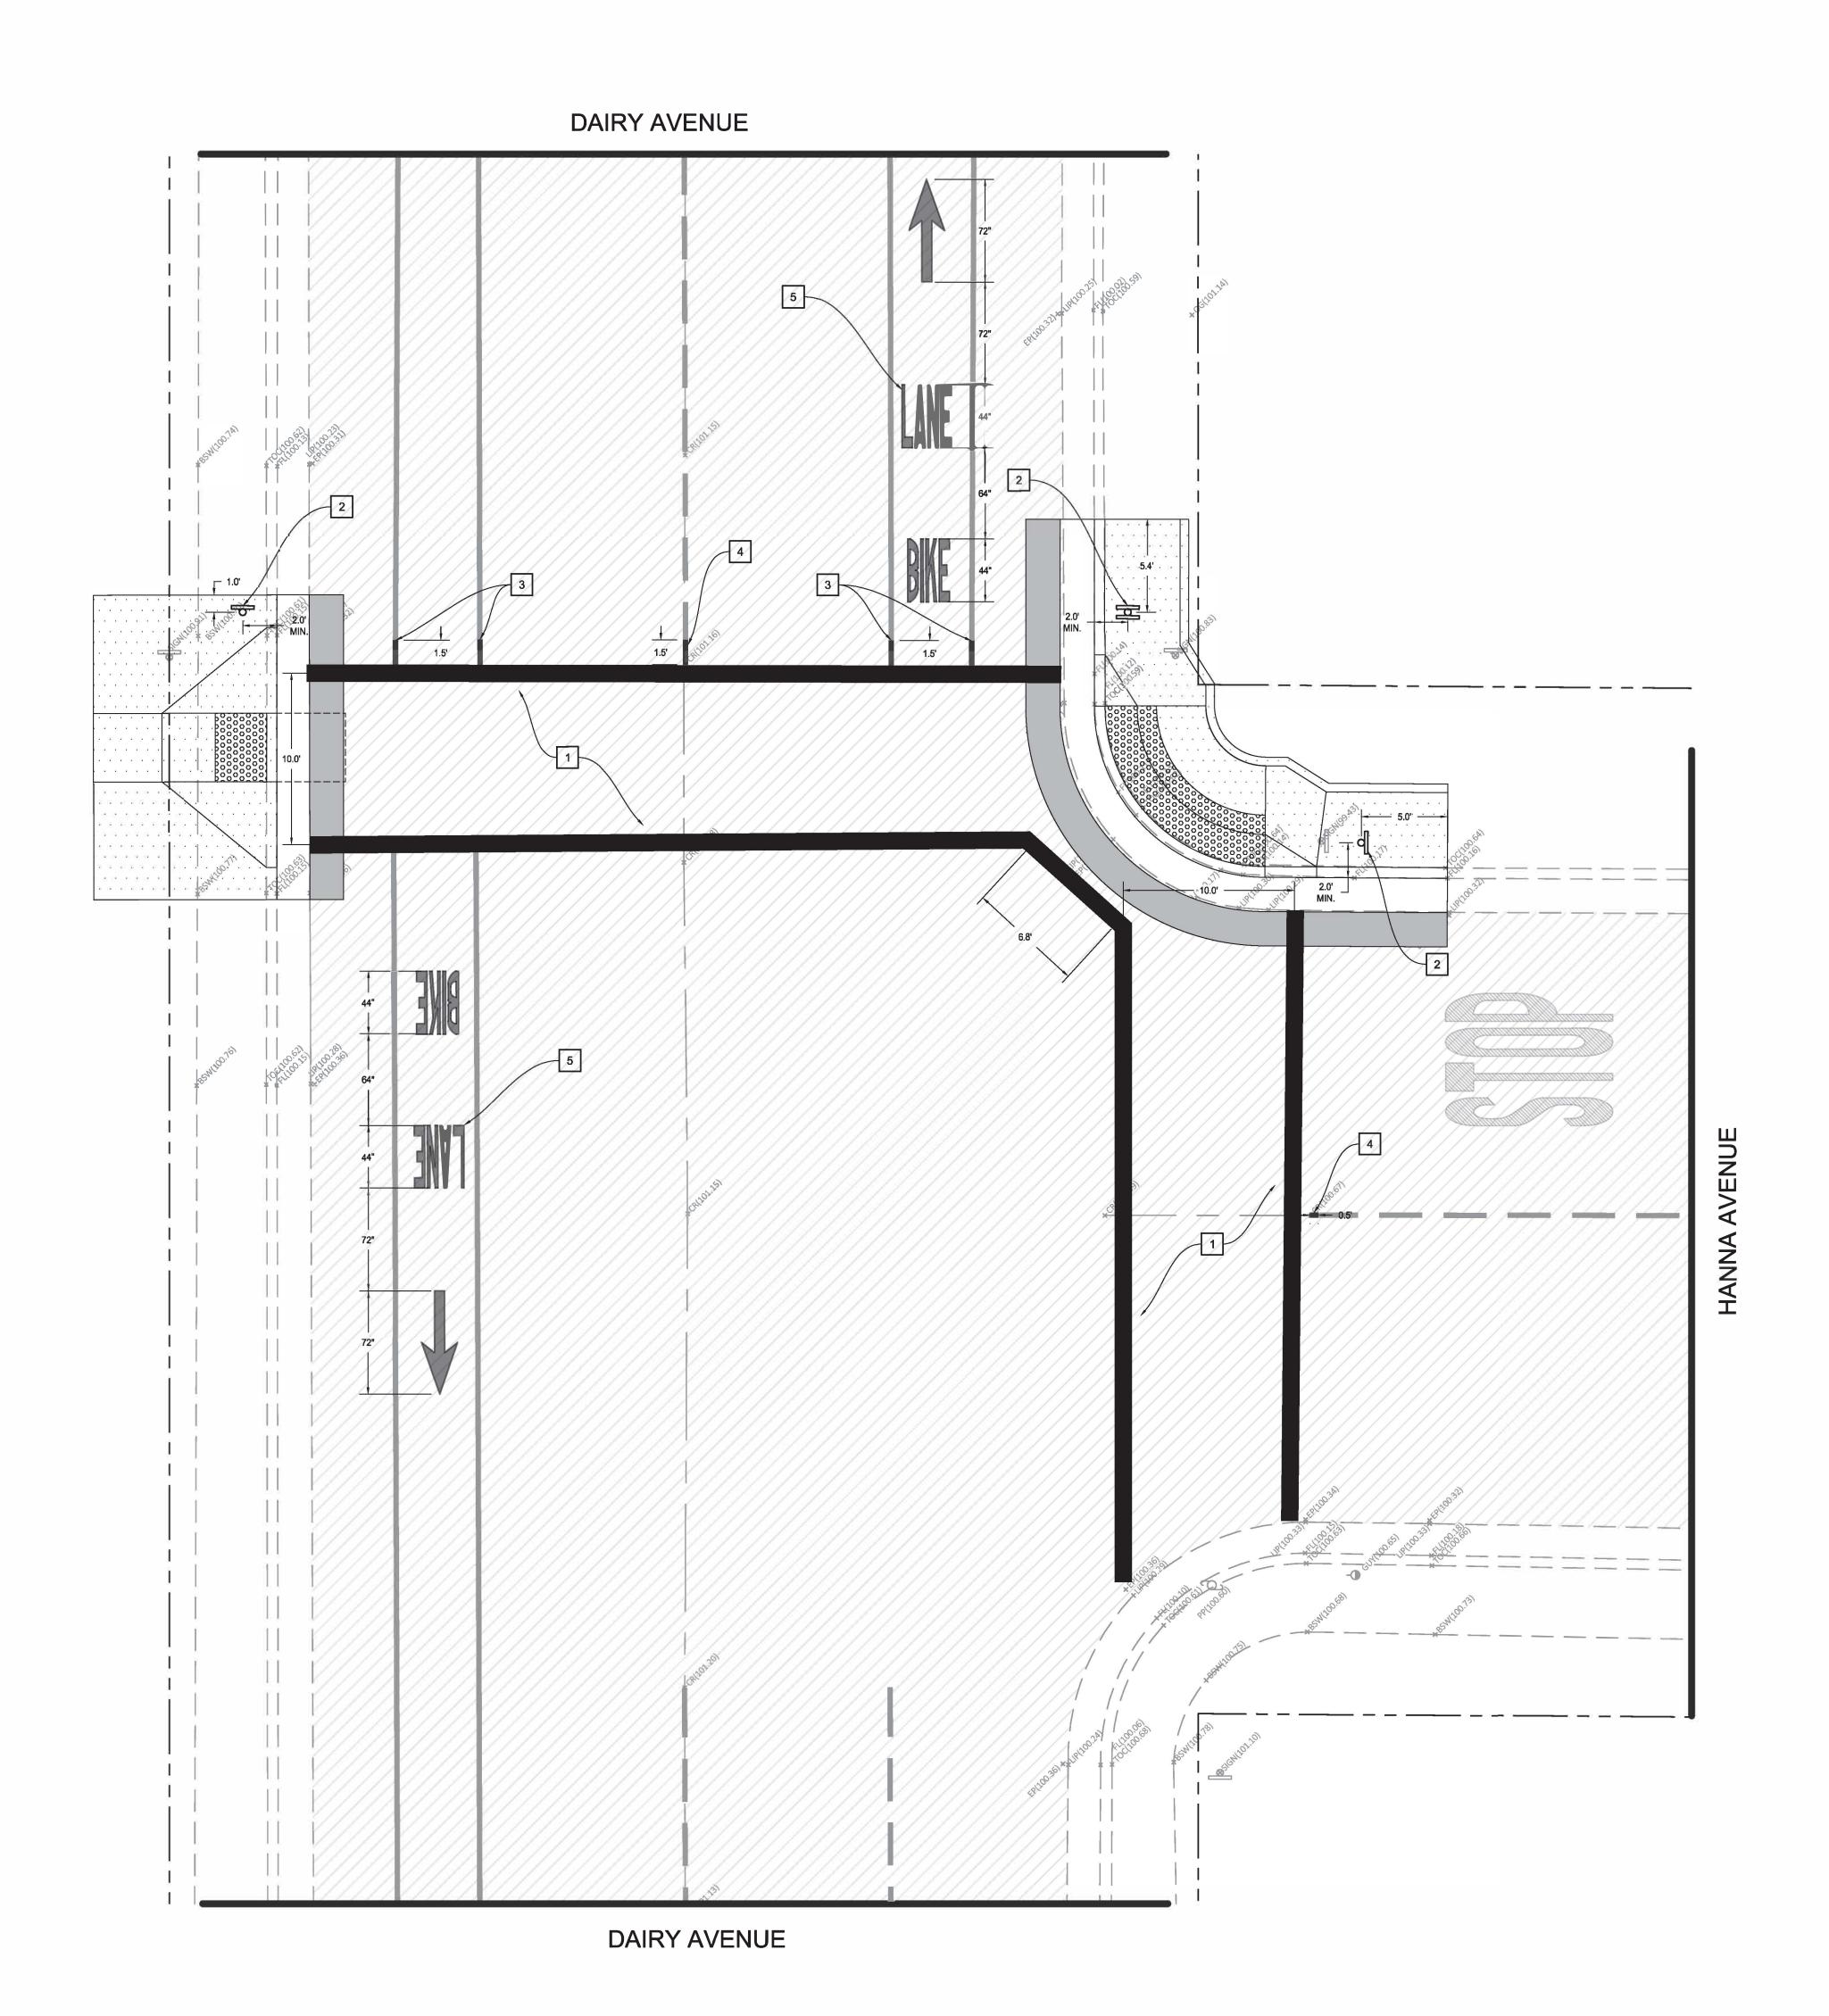- ALL EXISTING PAVEMENT STRIPING & MARKINGS (CROSSWALKS, STOP BARS, STOP MARKING LEGENDS, CENTERLINE, ETC.) SHALL BE REPAINTED WHEN DISTURBED BY IMPROVEMENTS, UNLESS SPECIFIED OTHERWISE
- LOCATIONS OF EXISTING UTILITIES ARE APPROXIMATED. CONTRACTOR TO FIELD VERIFY ALL EXISTING UTILITIES BEFORE COMMENCEMENT OF WORK.

# **SIGNING & STRIPING NOTES**

- 1. PAINT 12" WIDE SOLID WHITE STANDARD CROSSWALK MARKING, PER CITY STANDARD DETAIL ST-10, SEE SHEET 60
- 2. REINSTALL EXISTING STREET SIGN AND POLE
- 3. PAINT DETAIL 39 (WHITE BIKE LANE), SEE SHEET 58
- 4. PAINT DETAIL 1 (YELLOW CENTERLINE), SEE SHEET 58
- 5. PAINT BIKE LANE LEGEND WITH ARROW



1. IT IS THE RESPONSIBILITY OF THE CONTRACTOR TO PRESERVE ALL SURVEY MONUMENTS. ANY MONUMENT DISTURBED DURING CONSTRUCTION SHALL BE PERPETUATED PER THE PROFESSIONAL LAND SURVEYOR'S ACT, BUSINESS AND

2. LOCATIONS OF EXISTING UTILITIES ARE APPROXIMATED. CONTRACTOR TO FIELD VERIFY ALL EXISTING UTILITIES BEFORE



**DEMOLITION NOTES** 

**CONTRACTOR NOTES** 

PROFESSIONS CODE 8771, AT THE CONTRACTORS EXPENSE.

COMMENCEMENT OF WORK.

1. SAWCUT EXISTING CONCRETE TO A NEAT CLEAN EDGE LINE

2. SAWCUT EXISTING PAVEMENT TO A NEAT CLEAN EDGE LINE

3. EXISTING STRIPING OR MARKING TO BE REMOVED BY SANDING OR WATER BLASTING

4. REMOVE AND PRESERVE EXISTING STOP SIGN

CORCORAN SIDEWALK IMPROVMENTS



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# SIGNING & STRIPING NOTES

1. PAINT STANDARD 24" YELLOW CROSSWALK MARKING

2. REINSTALL EXISTING STOP SIGN









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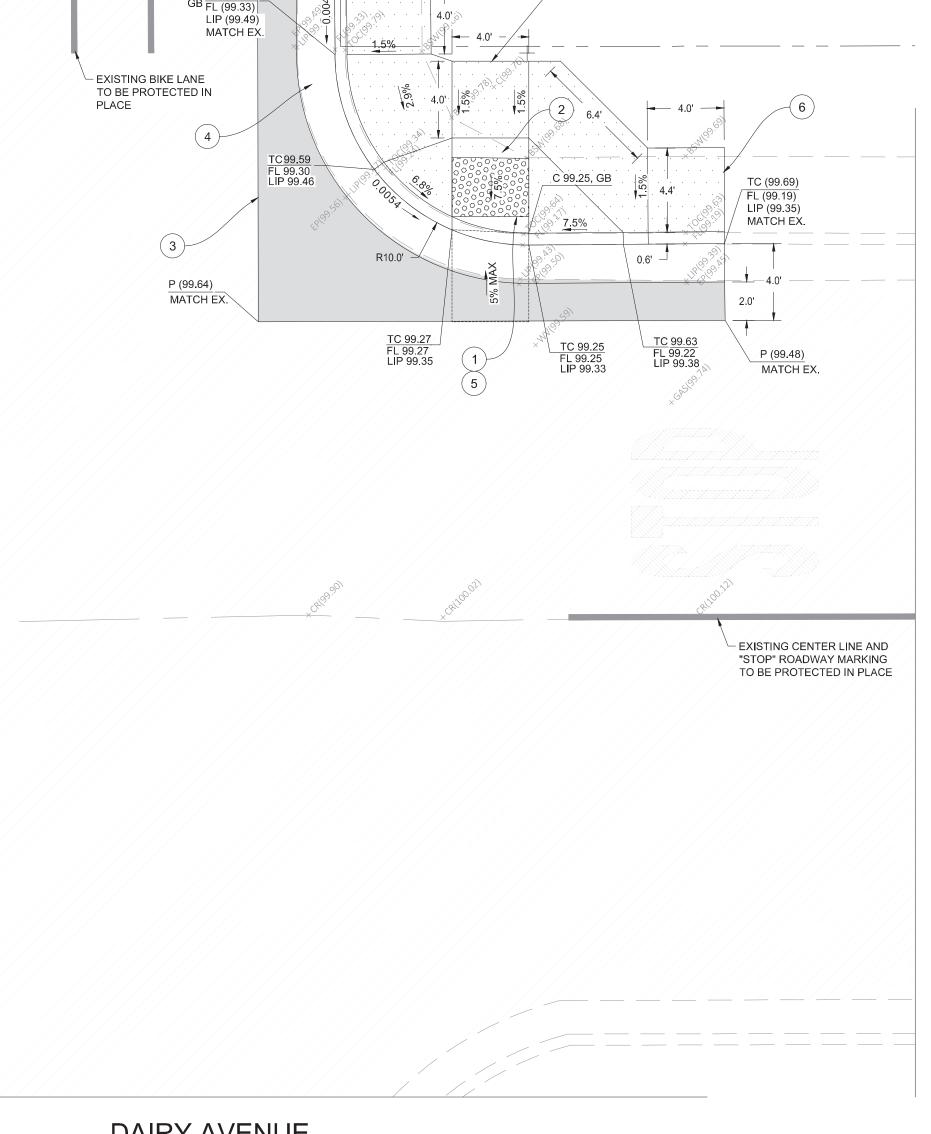




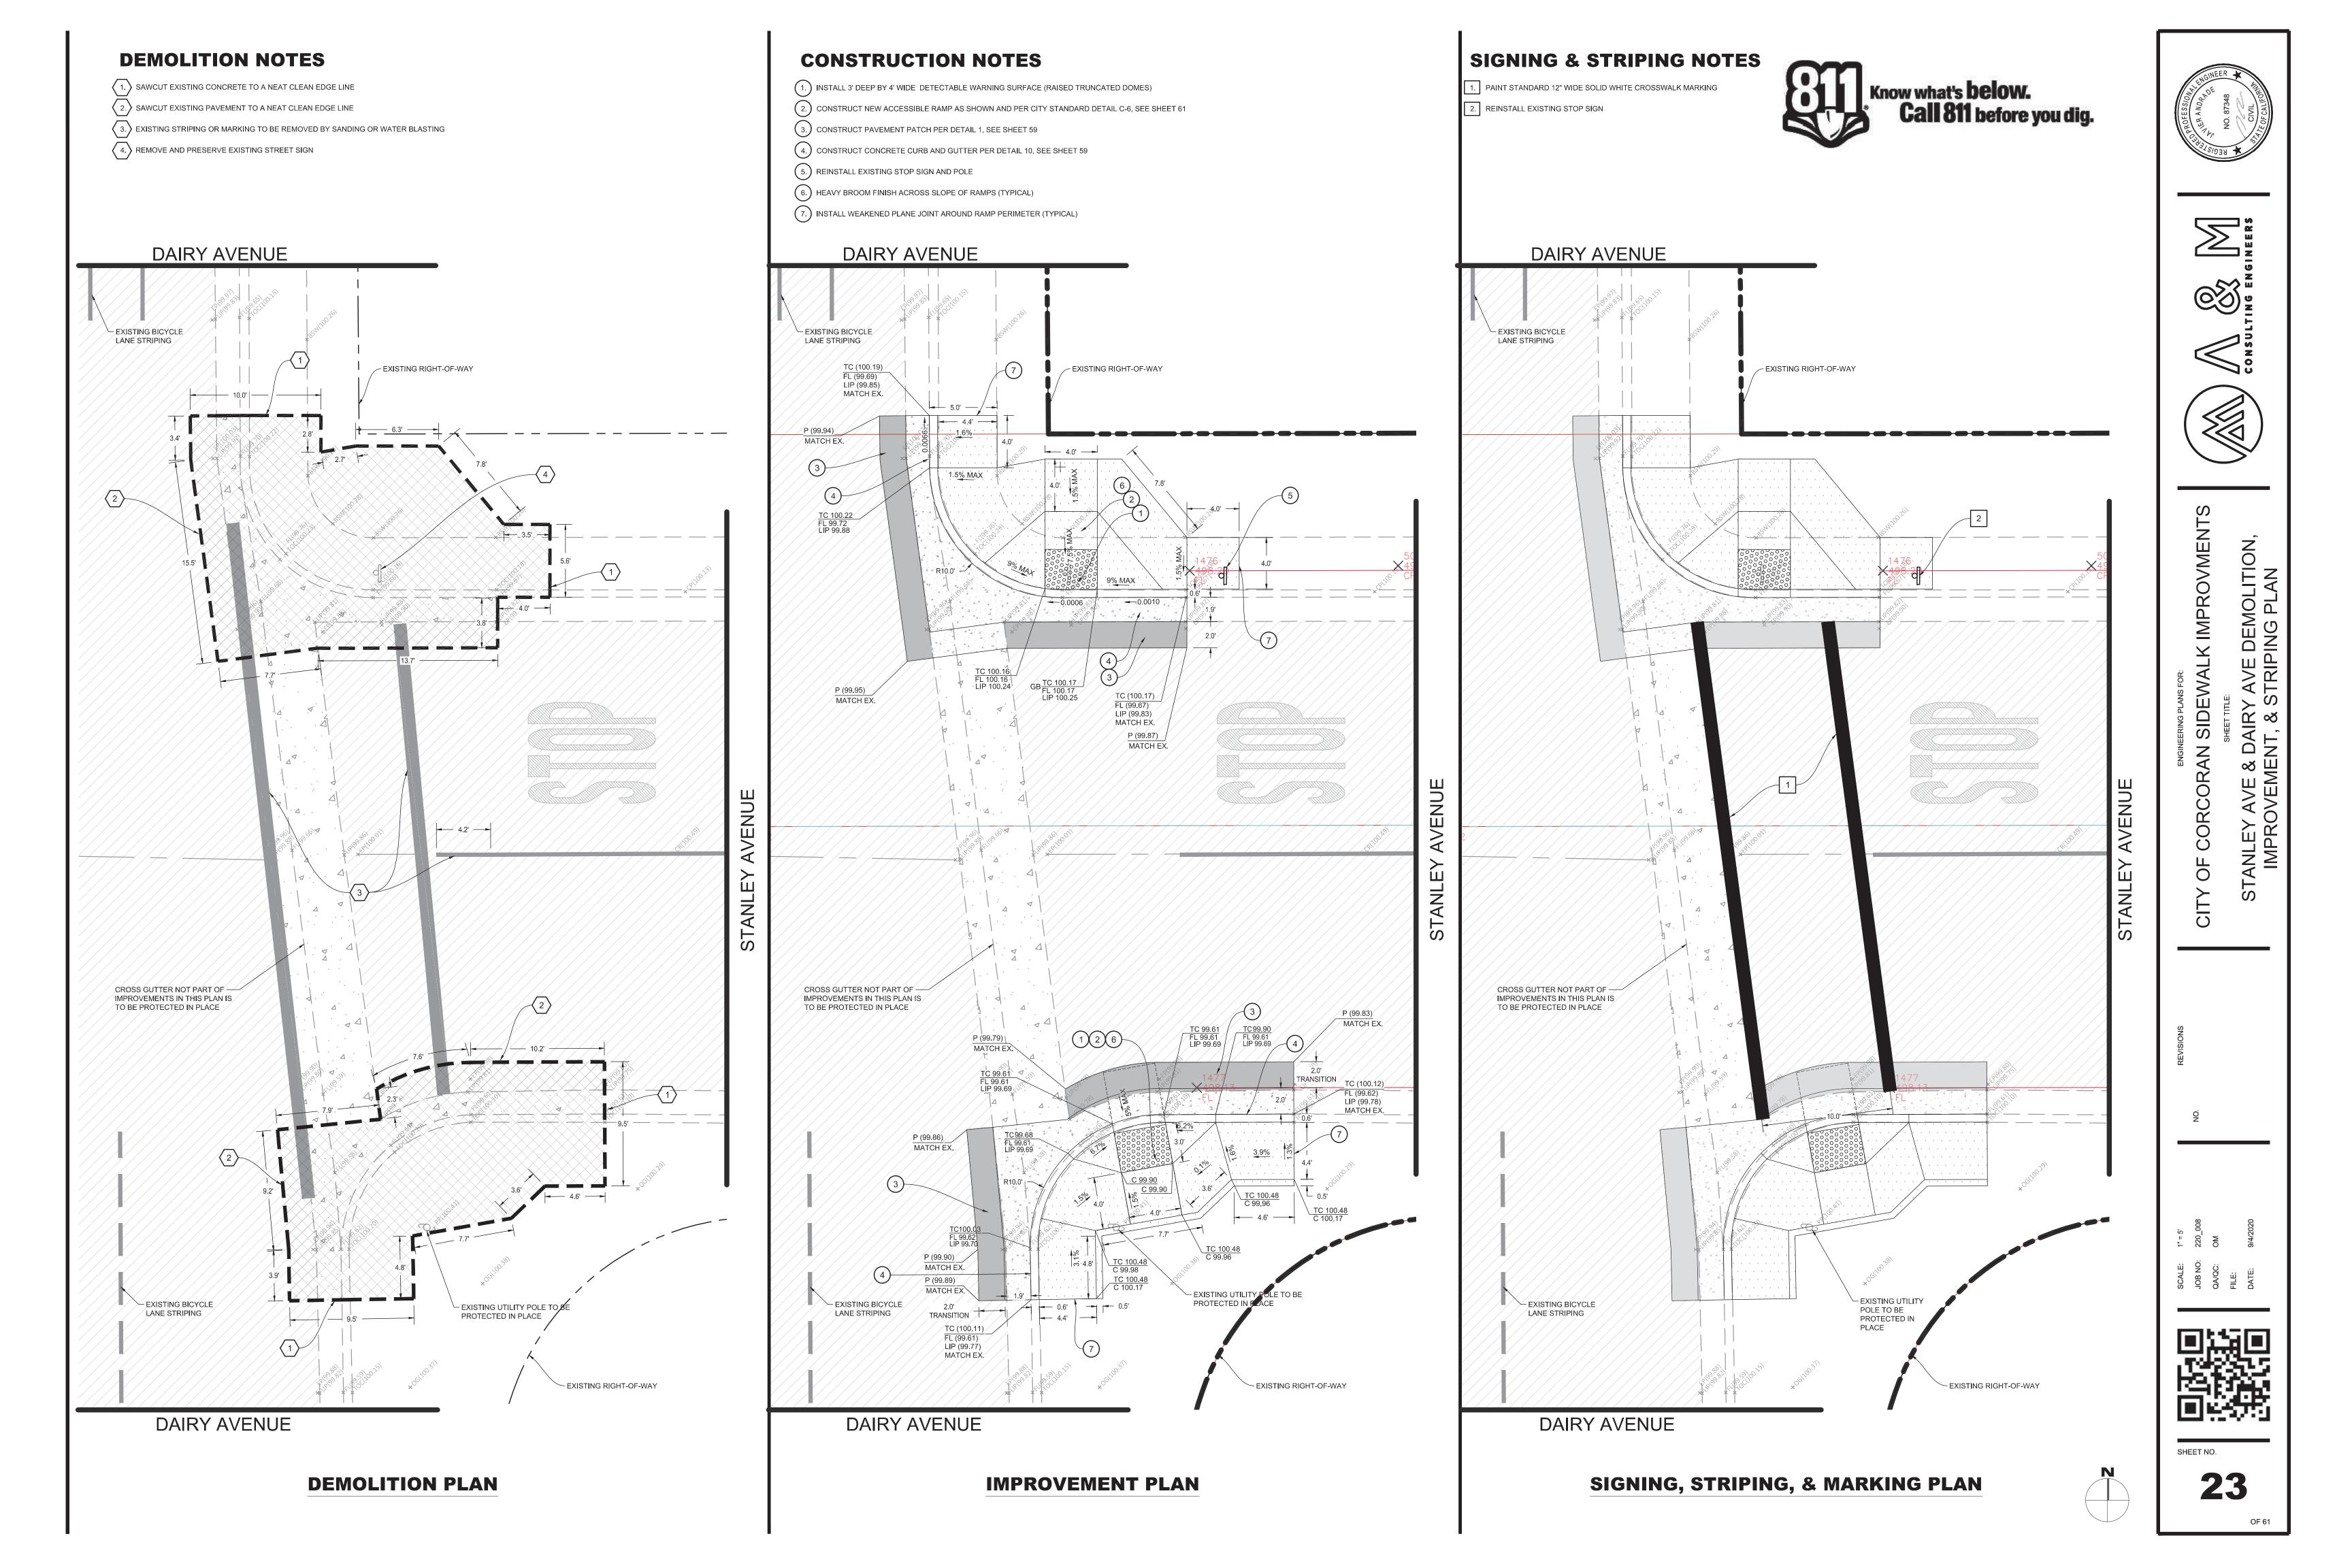
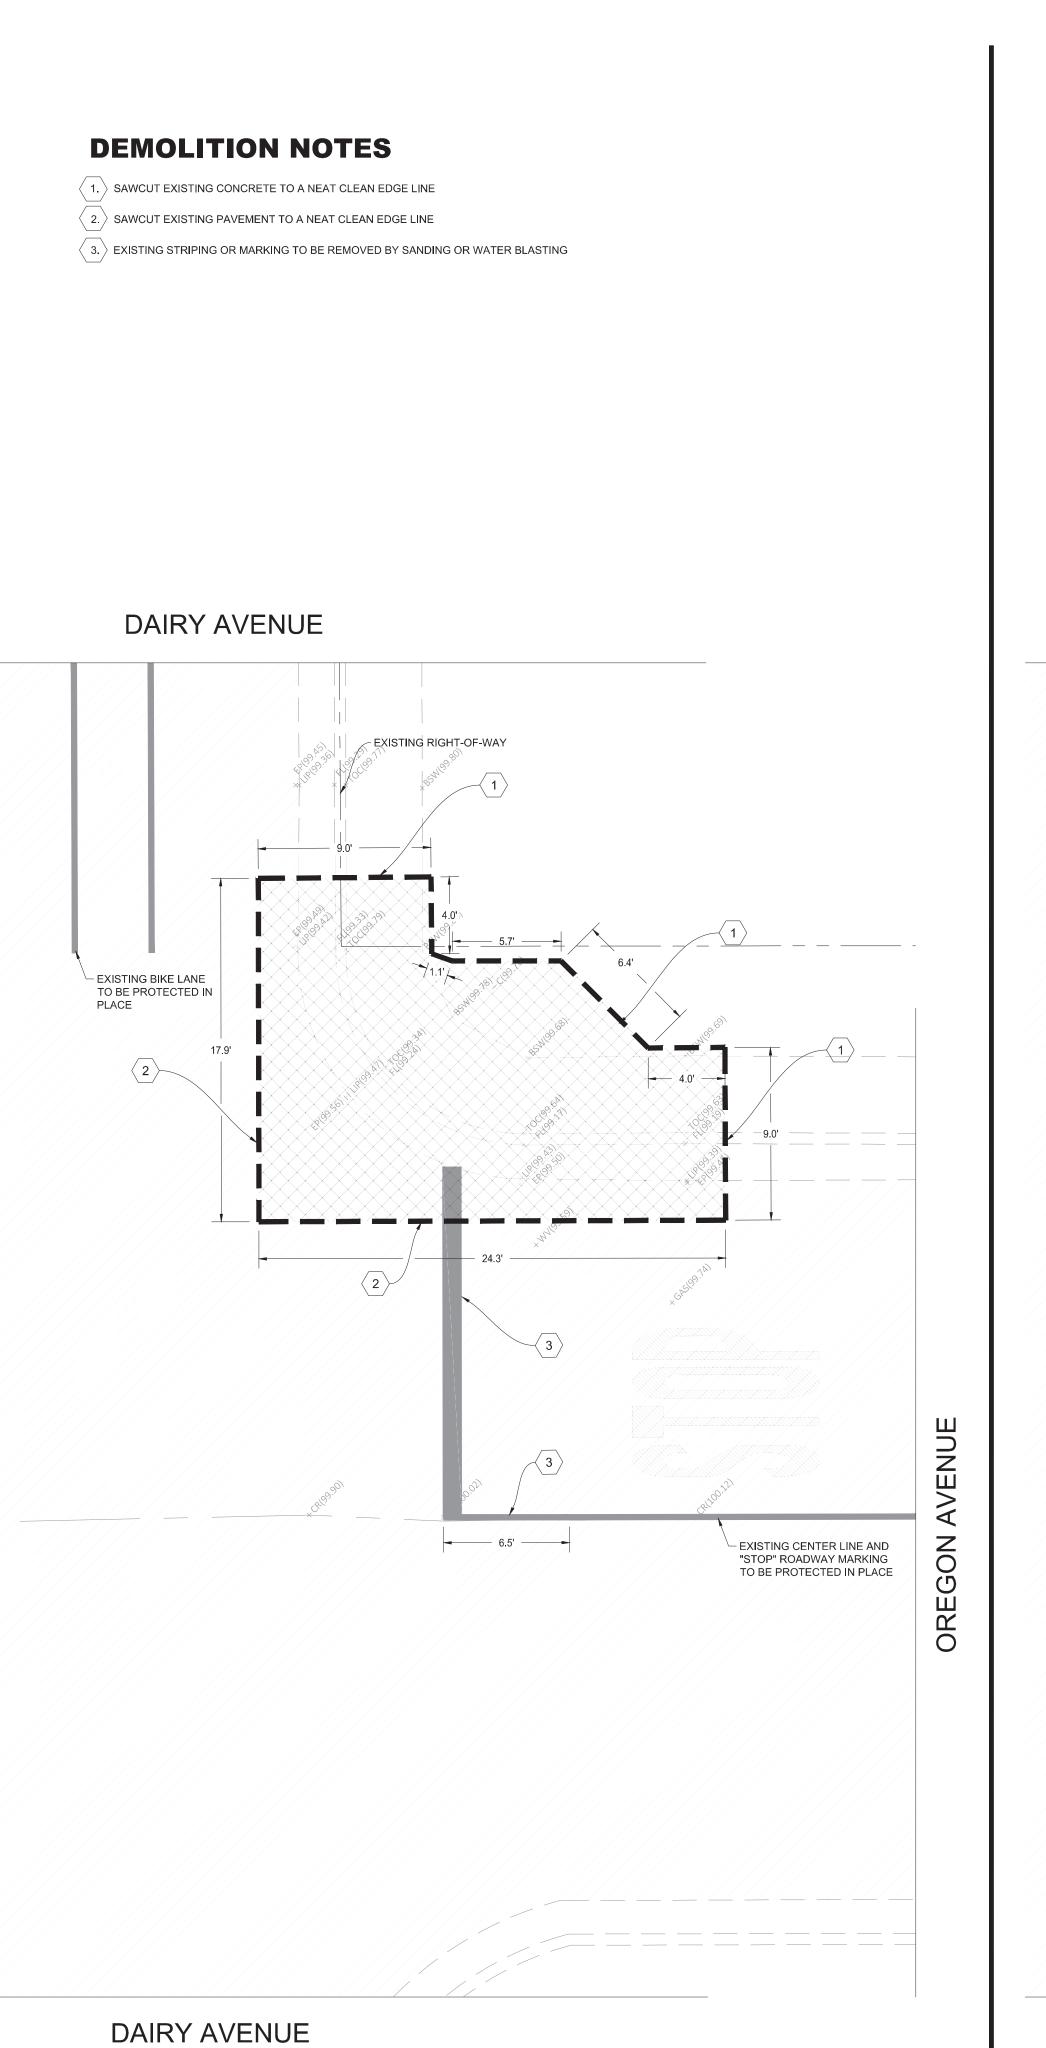
# **DEMOLITION PLAN**

# **CONSTRUCTION NOTES** (1.) INSTALL 3' DEEP BY 4' WIDE DETECTABLE WARNING SURFACE (RAISED TRUNCATED DOMES) ( 2. ) CONSTRUCT NEW ACCESSIBLE RAMP AS SHOWN AND PER CITY STANDARD DETAIL C-6, SEE SHEET 61 (3.) CONSTRUCT PAVEMENT PATCH PER DETAIL 01, SEE SHEET 59 (4.) CONSTRUCT CONCRETE CURB AND GUTTER PER DETAIL 10, SEE SHEET 59 (5.) HEAVY BROOM FINISH ACROSS SLOPE OF RAMPS (TYPICAL) (6.) INSTALL WEAKENED PLANE JOINT AROUND RAMP PERIMETER (TYPICAL) DAIRY AVENUE CONFORM TO EXISTING CONCRETE SURFACE GB FL (99.33) | LIP (99.49) MATCH EX. EXISTING BIKE LANE TO BE PROTECTED IN PLACE EXISTING CENTER LINE AND "STOP" ROADWAY MARKING TO BE PROTECTED IN PLACE



DAIRY AVENUE

**IMPROVEMENT PLAN** 



DAIRY AVENUE

EXISTING BIKE LANE
TO BE PROTECTED IN


DAIRY AVENUE

SIGNAGE, STRIPING, & MARKING PLAN

1. PAINT STANDARD 12" WIDE SOLID WHITE CROSSWALK MARKING





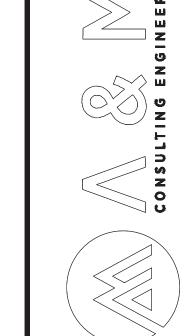


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EXISTING CENTER LINE AND "STOP" ROADWAY MARKING TO BE PROTECTED IN PLACE



**IMPROVEMENT PLAN** 

(2.) CONSTRUCT NEW ACCESSIBLE RAMP AS SHOWN AND PER CITY STANDARD DETAIL C-6, SEE SHEET 61

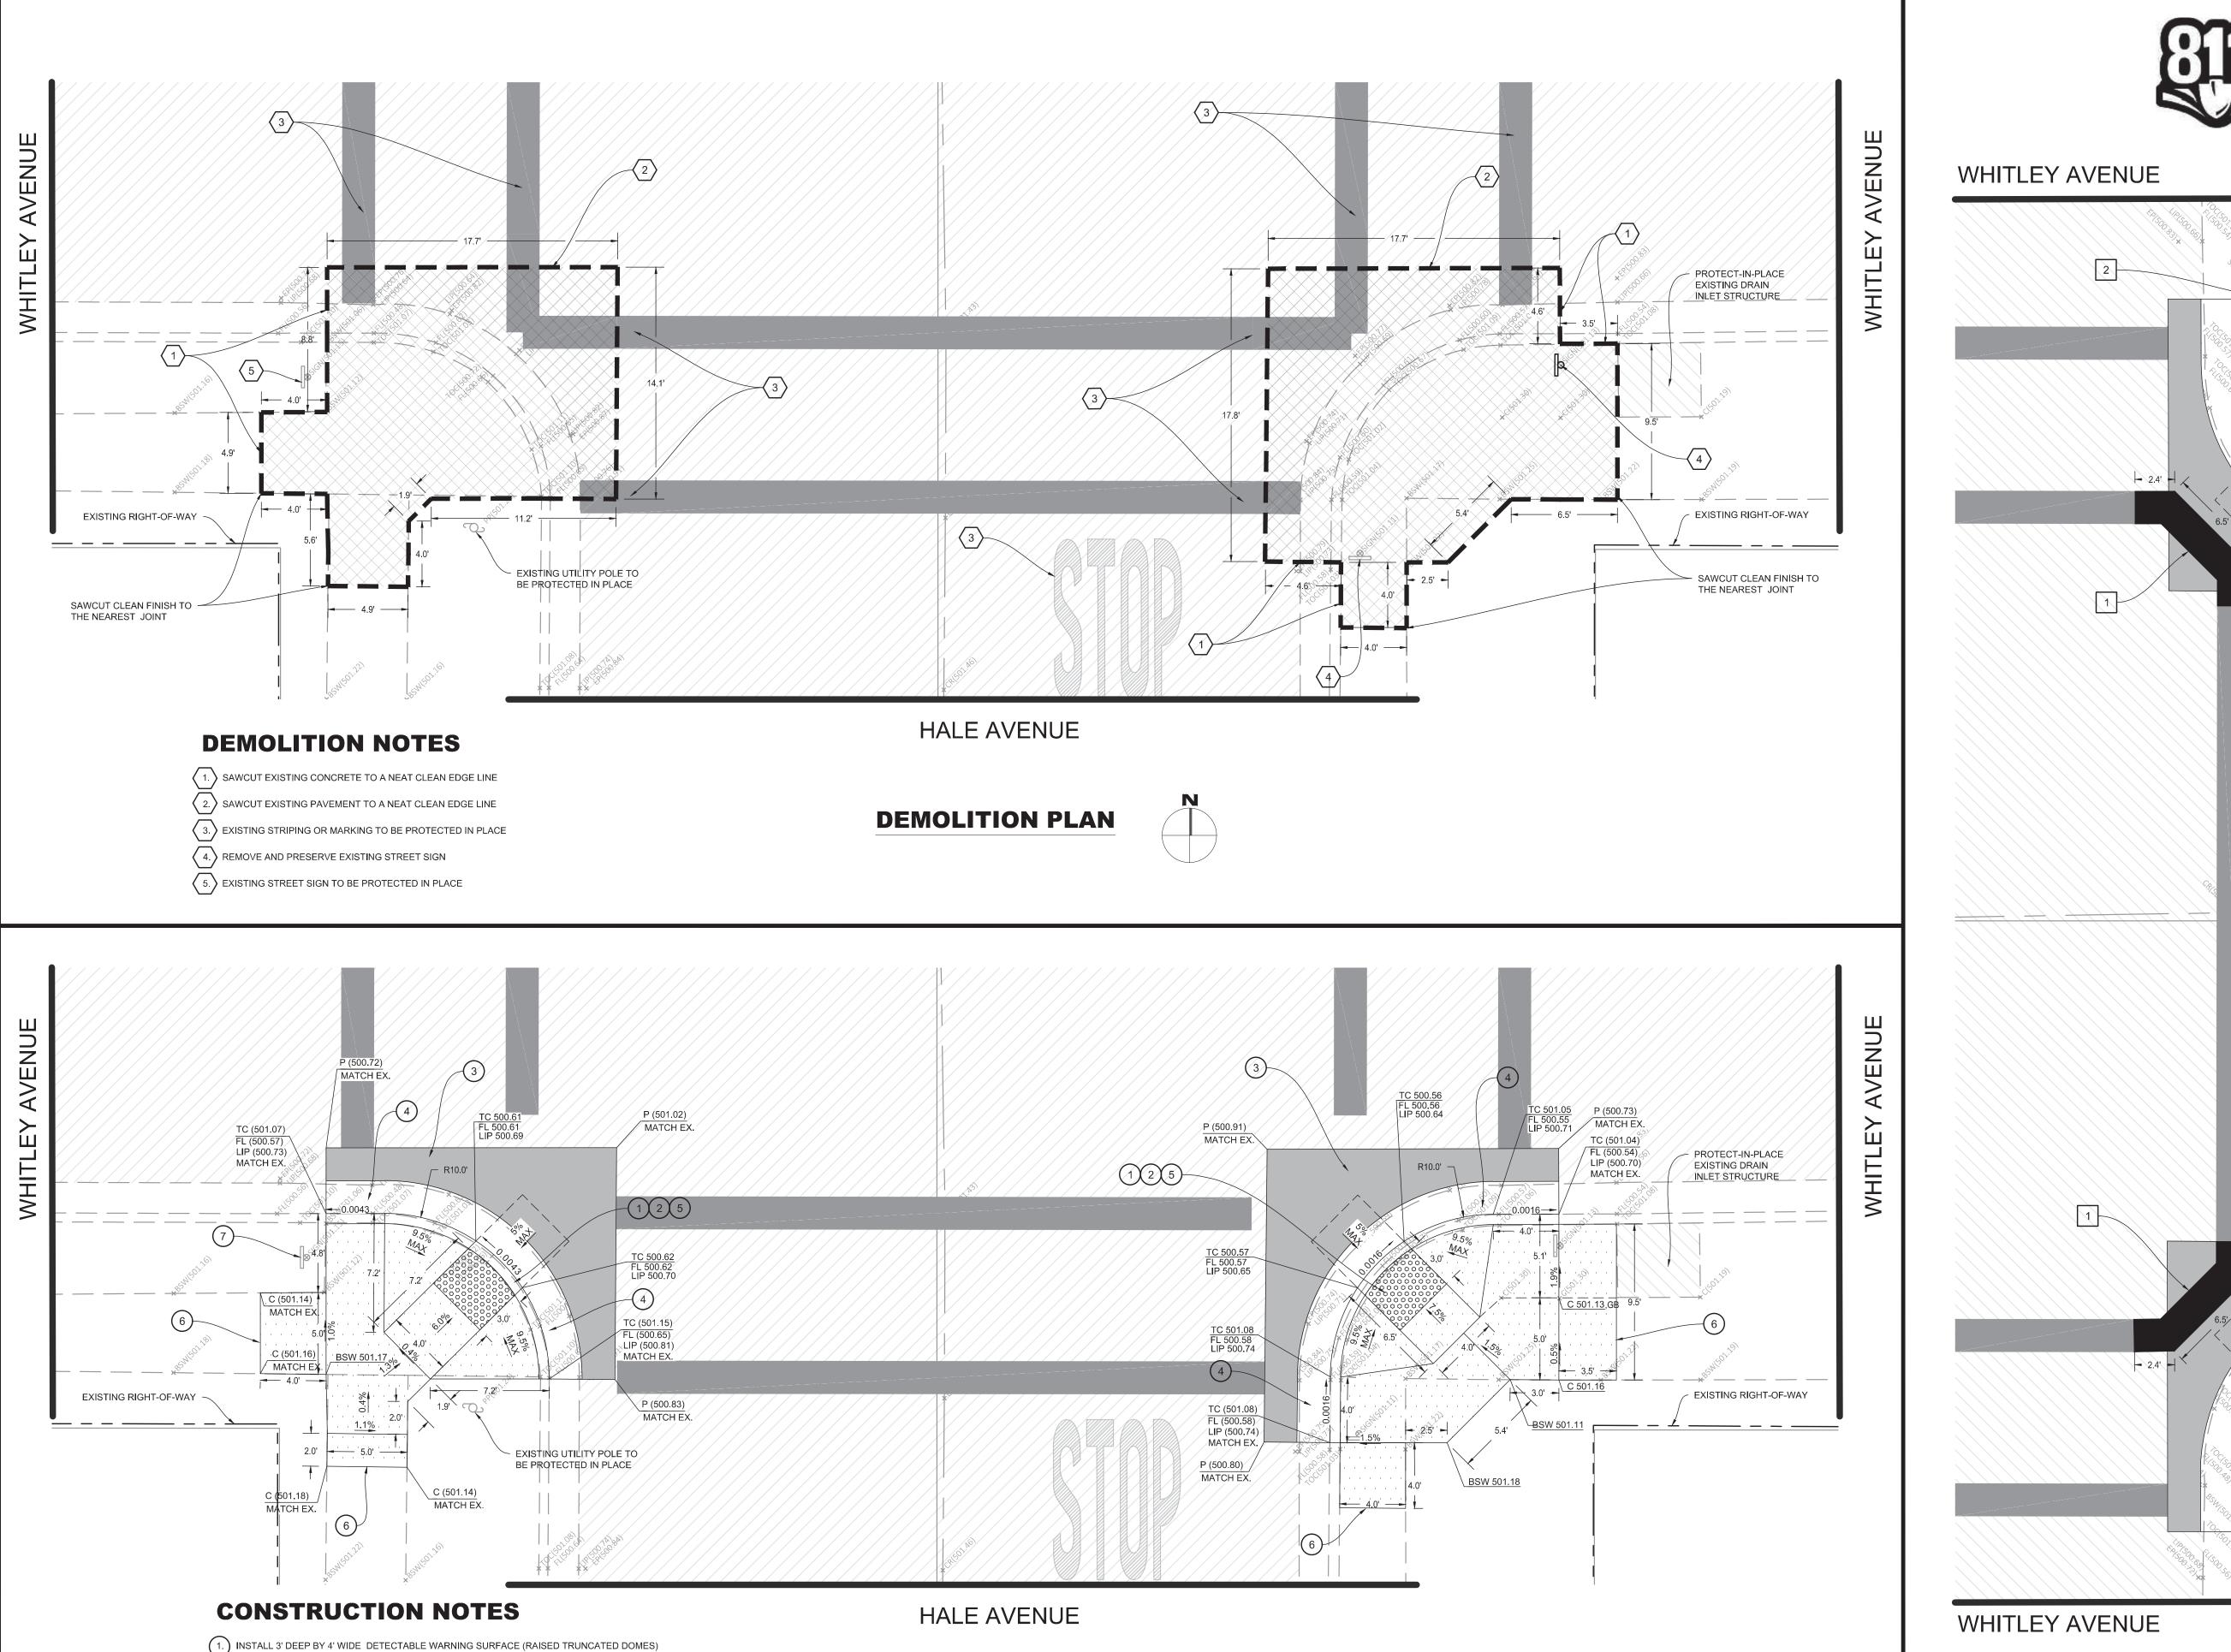(3.) CONSTRUCT PAVEMENT PATCH PER DETAIL 01, SEE SHEET 59


5.) HEAVY BROOM FINISH ACROSS SLOPE OF RAMPS (TYPICAL)

7. EXISTING STREET SIGN TO BE PROTECTED IN PLACE

4.) CONSTRUCT CONCRETE CURB AND GUTTER PER DETAIL 10, SEE SHEET 59

6.) INSTALL WEAKENED PLANE JOINT AROUND RAMP PERIMETER (TYPICAL)



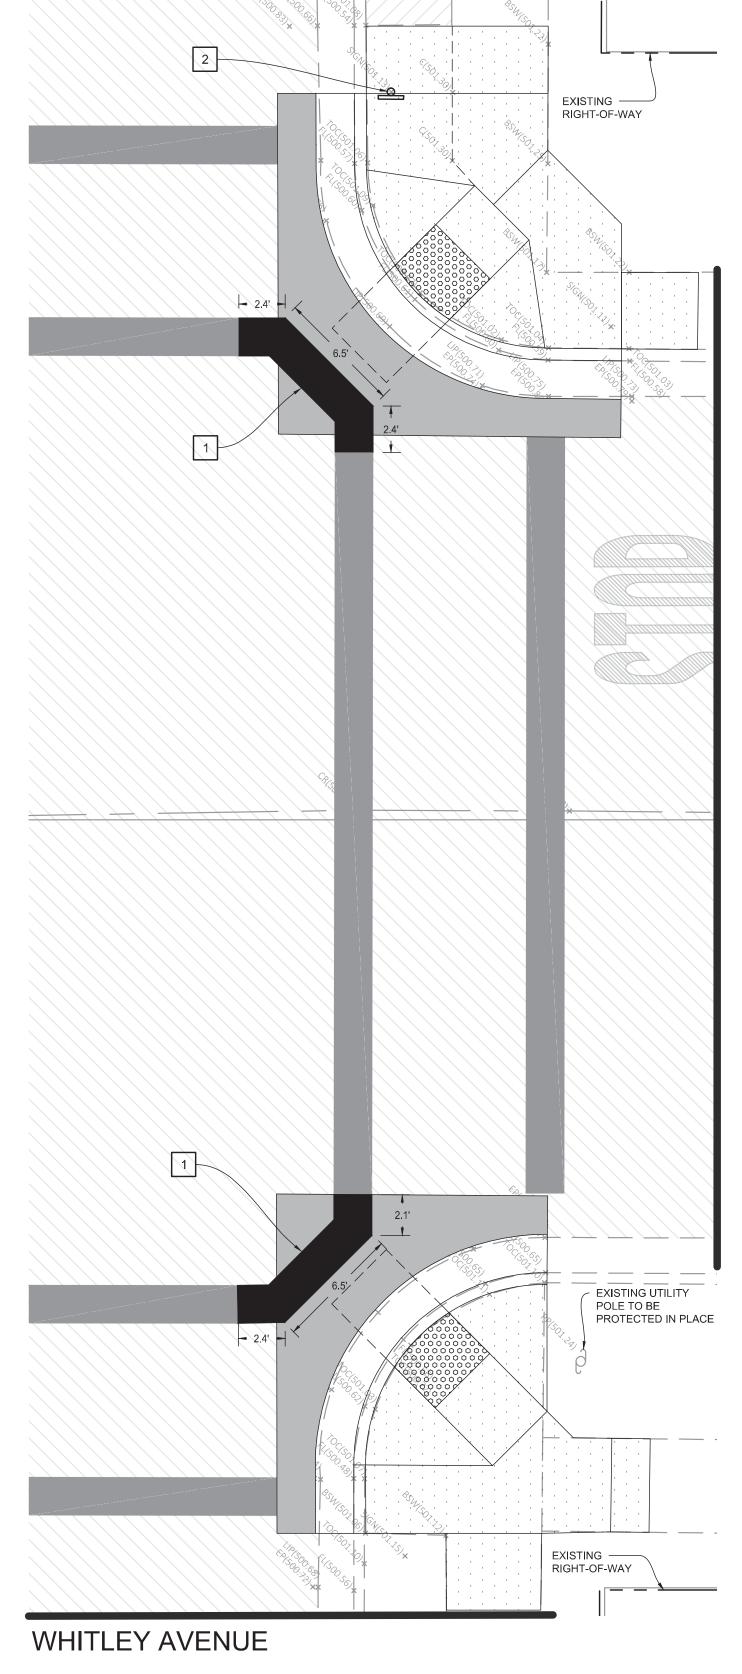

# **SIGNING & STRIPING NOTES**

1. PAINT STANDARD 24" WIDE SOLID WHITE CROSSWALK MARKING


2. REINSTALL EXISTING STREET SIGN AND POLE

SIGNAGE, STRIPING, & MARKING PLAN



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OF 6

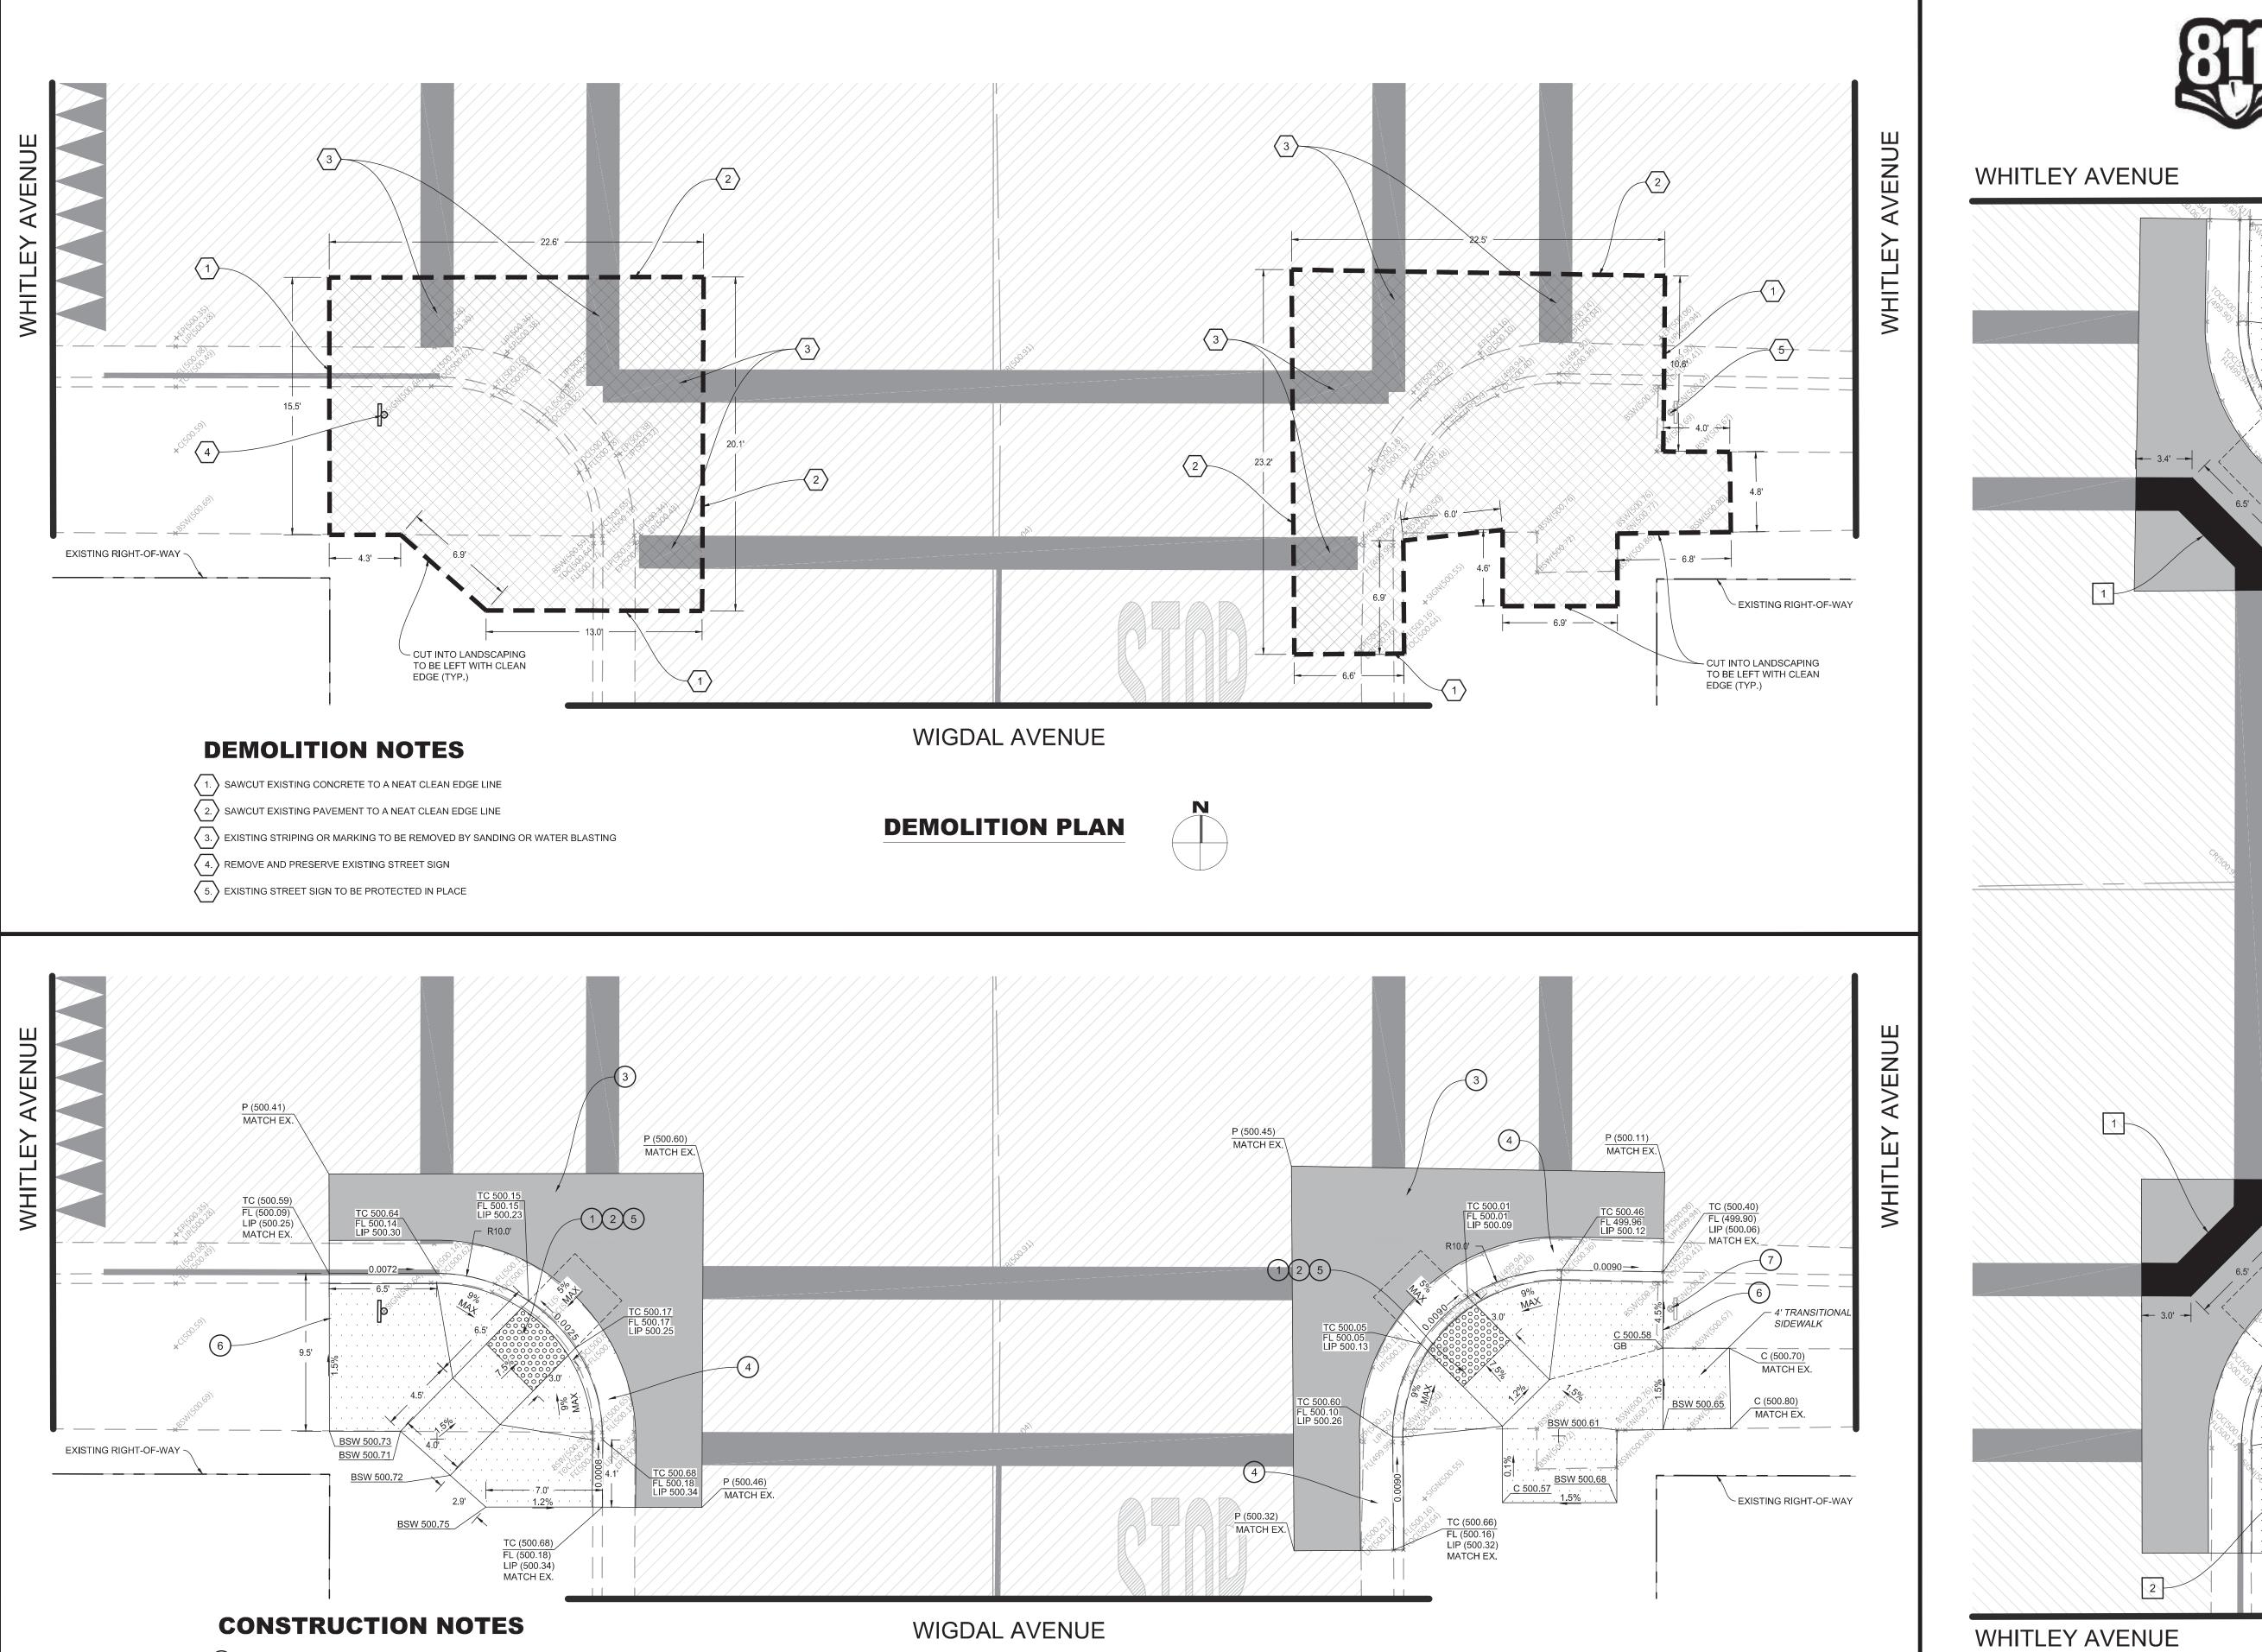

**IMPROVEMENT PLAN** 

(1.) INSTALL 3' DEEP BY 4' WIDE DETECTABLE WARNING SURFACE (RAISED TRUNCATED DOMES)

(3.) CONSTRUCT PAVEMENT PATCH PER DETAIL 01, SEE SHEET 59

5.) HEAVY BROOM FINISH ACROSS SLOPE OF RAMPS (TYPICAL)


7. EXISTING STREET SIGN TO BE PROTECTED IN PLACE

4.) CONSTRUCT CONCRETE CURB AND GUTTER PER DETAIL 10, SEE SHEET 59

6.) INSTALL WEAKENED PLANE JOINT AROUND RAMP PERIMETER (TYPICAL)

(2.) CONSTRUCT NEW ACCESSIBLE RAMP AS SHOWN AND PER CITY STANDARD DETAIL C-6, SEE SHEET 61

Know what's **below.**Call 811 before you dig.

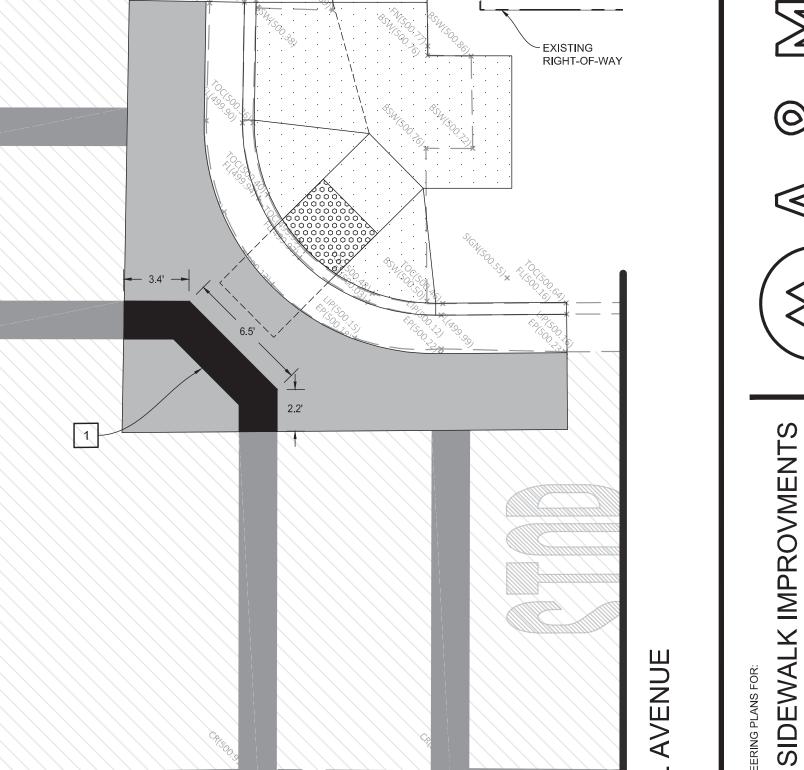

# **SIGNING & STRIPING NOTES**

1. PAINT STANDARD 24" WIDE SOLID WHITE CROSSWALK MARKING

2. REINSTALL EXISTING STREET SIGN AND POLE

SIGNAGE, STRIPING, & MARKING PLAN



EXISTING RIGHT-OF-WAY





- 1. IT IS THE RESPONSIBILITY OF THE CONTRACTOR TO PRESERVE ALL SURVEY MONUMENTS. ANY MONUMENT DISTURBED DURING CONSTRUCTION SHALL BE PERPETUATED PER THE PROFESSIONAL LAND SURVEYOR'S ACT, BUSINESS AND PROFESSIONS CODE 8771, AT THE CONTRACTORS EXPENSE.
- 2. LOCATIONS OF EXISTING UTILITIES ARE APPROXIMATED. CONTRACTOR TO FIELD VERIFY ALL EXISTING UTILITIES BEFORE COMMENCEMENT OF WORK.

# **DEMOLITION NOTES**

- 1. SAWCUT EXISTING CONCRETE TO A NEAT CLEAN EDGE LINE
- (2.) SAWCUT EXISTING SIDEWALK CONCRETE ONLY AND PROTECT EXISTING CURB AND GUTTER IN PLACE
- 3. SAWCUT EXISTING PAVEMENT TO A NEAT CLEAN EDGE LINE
- 4. EXISTING STRIPING OR MARKING TO BE REMOVED BY SANDING OR WATER BLASTING
- 5. REMOVE AND PRESERVE EXISTING STREET SIGN
- 6. EXISTING STREET SIGN TO BE PROTECTED IN PLACE









SIDEWALK COR



EXISTING RIGHT-OF-WAY



# **CONTRACTOR NOTES**

- 1. IT IS THE RESPONSIBILITY OF THE CONTRACTOR TO PRESERVE ALL SURVEY MONUMENTS. ANY MONUMENT DISTURBED DURING CONSTRUCTION SHALL BE PERPETUATED PER THE PROFESSIONAL LAND SURVEYOR'S ACT, BUSINESS AND PROFESSIONS CODE 8771, AT THE CONTRACTORS EXPENSE.
- 2. LOCATIONS OF EXISTING UTILITIES ARE APPROXIMATED. CONTRACTOR TO FIELD VERIFY ALL EXISTING UTILITIES BEFORE COMMENCEMENT OF WORK.

# **CONSTRUCTION NOTES**

- 1. INSTALL DETECTABLE WARNING SURFACE (RAISED TRUNCATED DOMES) AS SHOWN AND EXTENDING THE FULL WIDTH OF EACH PASSAGEWAY
- (2.) CONSTRUCT NEW ACCESSIBLE RAMPS AS SHOWN AND PER CITY STANDARD DETAIL C-6, SEE SHEET 61
- 3.) CONSTRUCT PAVEMENT PATCH PER DETAIL 01, SEE SHEET 59
- (5.) HEAVY BROOM FINISH ACROSS SLOPE OF RAMPS (TYPICAL)

(4.) CONSTRUCT CONCRETE CURB AND GUTTER PER DETAIL 10, SEE SHEET 59

- (6.) INSTALL WEAKENED PLANE JOINT AROUND RAMP PERIMETER (TYPICAL)
- (7.) EXISTING STREET SIGN TO BE PROTECTED IN PLACE
- 8.) INSTALL 4" THICK STAMPED CONCRETE SURFACE WITH "BRICK" PATTERN. COLOR SHALL BE "BRICK RED". A LIQUID RELEASE AGENT SHALL BE USED. A CURE AND SEAL PRODUCT SHALL BE APPLIED IN ACCORDANCE WITH THE MANUFACTURER'S RECOMMENDATIONS IMMEDIATELY AFTER COMPLETING THE IMPRINTING PROCESS. GRADE TO ACCOMMODATE DRAINAGE (2% MIN). STAMPED CONCRETE SHALL BE PLACED ON 6" MOIST AND COMPACTED NATIVE SOIL TO 90% RELATIVE COMPACTION.









**IMPROVMENT** SIDEWALK COR





- 1. IT IS THE RESPONSIBILITY OF THE CONTRACTOR TO PRESERVE ALL SURVEY MONUMENTS. ANY MONUMENT DISTURBED DURING CONSTRUCTION SHALL BE PERPETUATED PER THE PROFESSIONAL LAND SURVEYOR'S ACT, BUSINESS AND PROFESSIONS CODE 8771, AT THE CONTRACTORS EXPENSE.
- 2. LOCATIONS OF EXISTING UTILITIES ARE APPROXIMATED. CONTRACTOR TO FIELD VERIFY ALL EXISTING UTILITIES BEFORE COMMENCEMENT OF WORK.

# **SIGNING & STRIPING NOTES**

1. PAINT 24" WIDE SOLID YELLOW STANDARD CROSSWALK MARKING

2. PAINT 12" WIDE SOLID YELLOW LADDER CROSSWALK MARKING, INSIDE LINES TO BE 24" WIDE AND SPACED TO AVOID WHEEL PATH

3. PAINT 6" WIDE WHITE DIAGONAL CROSSHATCH MARKINGS AS SHOWN

4. REINSTALL EXISTING STREET SIGN AND POLE





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- IT IS THE RESPONSIBILITY OF THE CONTRACTOR TO PRESERVE ALL SURVEY MONUMENTS. ANY MONUMENT DISTURBED DURING CONSTRUCTION SHALL BE PERPETUATED PER THE PROFESSIONAL LAND SURVEYOR'S ACT, BUSINESS AND PROFESSIONS CODE 8771, AT THE CONTRACTORS EXPENSE.
- LOCATIONS OF EXISTING UTILITIES ARE APPROXIMATED. CONTRACTOR TO FIELD VERIFY ALL EXISTING UTILITIES BEFORE COMMENCEMENT OF WORK.

# **DEMOLITION NOTES**

- 1. SAWCUT EXISTING CONCRETE TO A NEAT CLEAN EDGE LINE
- 2. SAWCUT EXISTING PAVEMENT TO A NEAT CLEAN EDGE LINE
- 3. EXISTING STRIPING OR MARKING TO BE REMOVED BY SANDING OR WATER BLASTING







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- IT IS THE RESPONSIBILITY OF THE CONTRACTOR TO PRESERVE ALL SURVEY MONUMENTS. ANY MONUMENT DISTURBED DURING CONSTRUCTION SHALL BE PERPETUATED PER THE PROFESSIONAL LAND SURVEYOR'S ACT, BUSINESS AND PROFESSIONS CODE 8771, AT THE CONTRACTORS EXPENSE.
- 2. LOCATIONS OF EXISTING UTILITIES ARE APPROXIMATED. CONTRACTOR TO FIELD VERIFY ALL EXISTING UTILITIES BEFORE COMMENCEMENT OF WORK.

# **CONSTRUCTION NOTES**

- 1.) INSTALL DETECTABLE WARNING SURFACE (RAISED TRUNCATED DOMES) AS SHOWN AND EXTENDING THE FULL WIDTH OF EACH PASSAGEWAY
- (2.) CONSTRUCT NEW ACCESSIBLE RAMPS AS SHOWN AND PER CITY STANDARD DETAIL C-6, SEE SHEET 61
- 3.) CONSTRUCT PAVEMENT PATCH PER DETAIL 01, SEE SHEET 59
- 4.) CONSTRUCT CONCRETE CURB AND GUTTER PER DETAIL 10, SEE SHEET 59
- 5.) HEAVY BROOM FINISH ACROSS SLOPE OF RAMPS (TYPICAL)
- (6.) INSTALL WEAKENED PLANE JOINT AROUND RAMP PERIMETER (TYPICAL)
- (7.) INSTALL 4" THICK STAMPED CONCRETE SURFACE WITH "BRICK" PATTERN. COLOR SHALL BE "BRICK RED". A LIQUID RELEASE AGENT SHALL BE USED. A CURE AND SEAL PRODUCT SHALL BE APPLIED IN ACCORDANCE WITH THE MANUFACTURER'S RECOMMENDATIONS IMMEDIATELY AFTER COMPLETING THE IMPRINTING PROCESS. GRADE TO ACCOMMODATE DRAINAGE (2% MIN). STAMPED CONCRETE SHALL BE PLACED ON 6" MOIST AND COMPACTED NATIVE SOIL TO 90% RELATIVE COMPACTION.







CORCORAN SIDEWALK IMPROVMENTS
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NE AVE & WHITLEY AVE IMPROVEMENT

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- 1. IT IS THE RESPONSIBILITY OF THE CONTRACTOR TO PRESERVE ALL SURVEY MONUMENTS. ANY MONUMENT DISTURBED DURING CONSTRUCTION SHALL BE PERPETUATED PER THE PROFESSIONAL LAND SURVEYOR'S ACT, BUSINESS AND PROFESSIONS CODE 8771, AT THE CONTRACTORS EXPENSE.
- 2. LOCATIONS OF EXISTING UTILITIES ARE APPROXIMATED. CONTRACTOR TO FIELD VERIFY ALL EXISTING UTILITIES BEFORE COMMENCEMENT OF WORK.

# **SIGNING & STRIPING NOTES**

- 1. PAINT 24" WIDE SOLID YELLOW STANDARD CROSSWALK MARKING
- 2. PAINT 12" WIDE SOLID YELLOW LADDER CROSSWALK MARKING, INSIDE LINES TO BE 24" WIDE AND SPACED TO AVOID WHEEL PATH
- 3. RESTRIPE DOUBLE YELLOW CENTERLINE AS SHOWN AND PER DETAIL 21, SEE SHEET 58
- 4. RESTRIPE PEDESTRIAN YIELD LINE AS SHOWN AND PER FIGURE 3B-16, SEE SHEET 58
- 5. REINSTALL EXISTING STREET SIGN AND POLE













- 1. IT IS THE RESPONSIBILITY OF THE CONTRACTOR TO PRESERVE ALL SURVEY MONUMENTS, ANY MONUMENT DISTURBED DURING CONSTRUCTION SHALL BE PERPETUATED PER THE PROFESSIONAL LAND SURVEYOR'S ACT, BUSINESS AND PROFESSIONS CODE 8771, AT THE CONTRACTORS EXPENSE.
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# **DEMOLITION NOTES**


- 1. SAWCUT EXISTING CONCRETE TO A NEAT CLEAN EDGE LINE
- 2. SAWCUT EXISTING PAVEMENT TO A NEAT CLEAN EDGE LINE
- (3.) EXISTING STRIPING OR MARKING TO BE REMOVED BY SANDING OR WATER BLASTING
- 4. REMOVE AND PRESERVE EXISTING STREET SIGN


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CIT



SHEET NO.



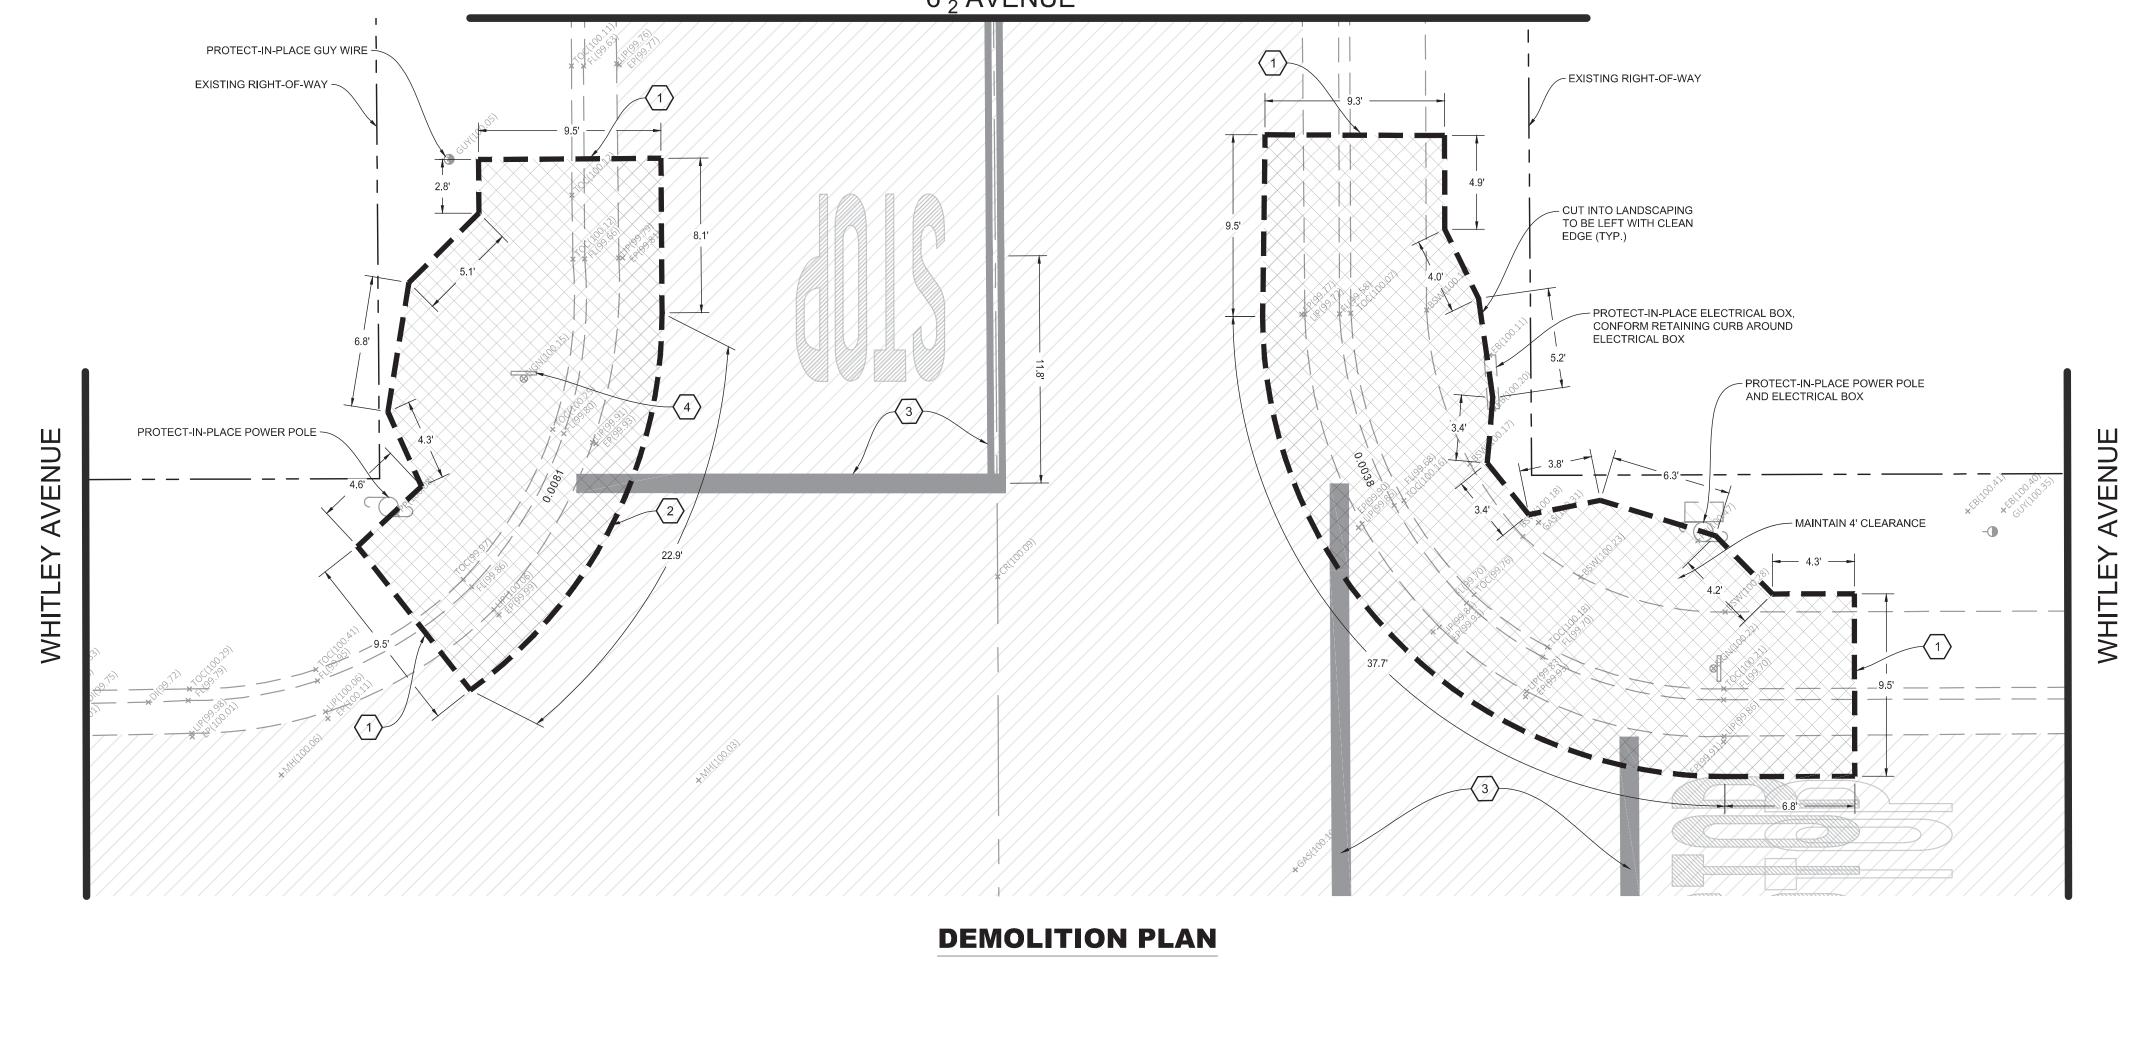
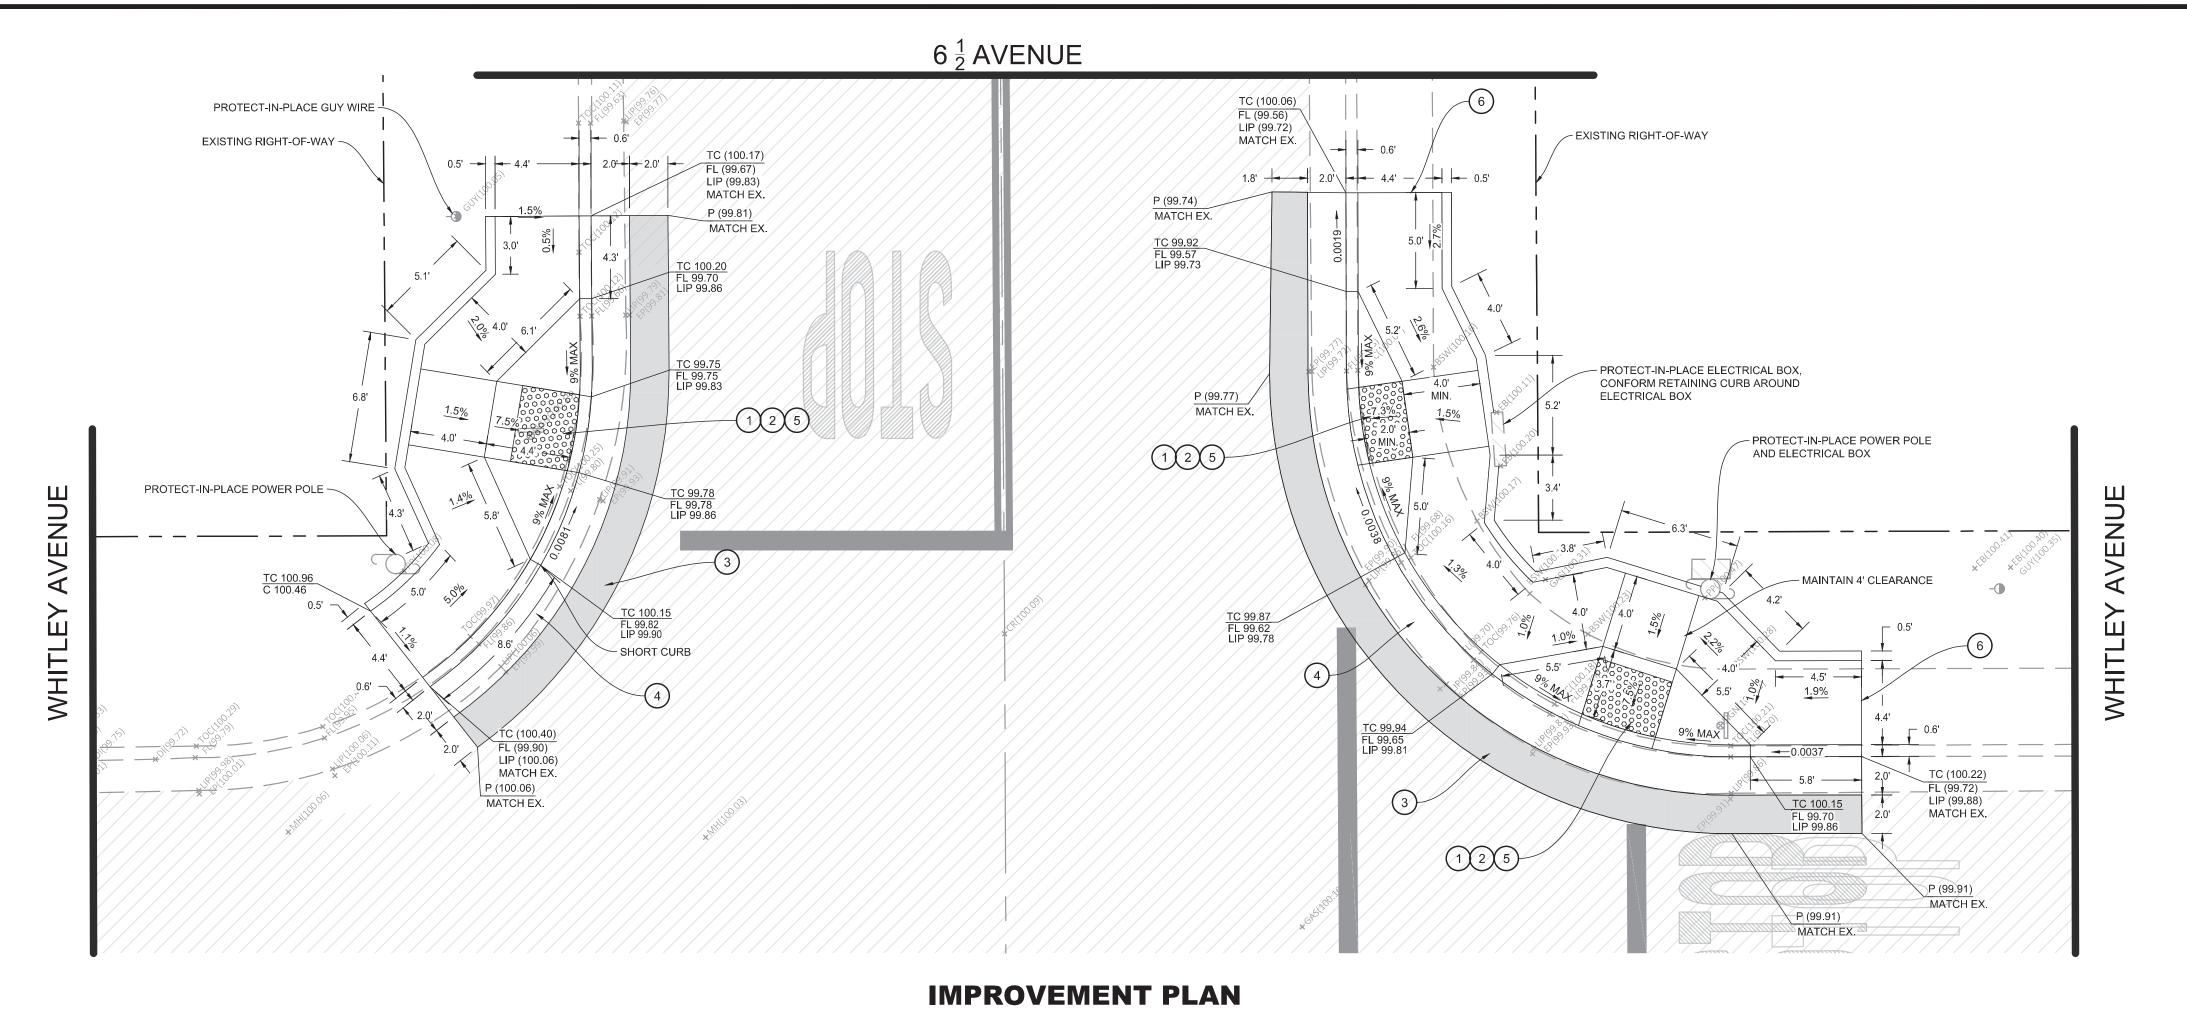
# **CONSTRUCTION NOTES**


- 1.) INSTALL DETECTABLE WARNING SURFACE (RAISED TRUNCATED DOMES) AS SHOWN AND EXTENDING THE FULL WIDTH OF THE RAMP
- 2.) CONSTRUCT NEW ACCESSIBLE RAMP AS SHOWN AND PER CITY STANDARD DETAIL C-6, SEE SHEET 61
- (3.) CONSTRUCT PAVEMENT PATCH PER DETAIL 01, SEE SHEET 59
- 4.) CONSTRUCT CONCRETE CURB AND GUTTER PER DETAIL 10, SEE SHEET 59
- 5.) HEAVY BROOM FINISH ACROSS SLOPE OF RAMPS (TYPICAL)

- 1. IT IS THE RESPONSIBILITY OF THE CONTRACTOR TO PRESERVE ALL SURVEY MONUMENTS. ANY MONUMENT DISTURBED DURING CONSTRUCTION SHALL BE PERPETUATED PER THE PROFESSIONAL LAND SURVEYOR'S ACT, BUSINESS AND PROFESSIONS CODE 8771, AT THE CONTRACTORS EXPENSE.
- 2. LOCATIONS OF EXISTING UTILITIES ARE APPROXIMATED. CONTRACTOR TO FIELD VERIFY ALL EXISTING UTILITIES BEFORE COMMENCEMENT OF WORK.


# **SIGNING & STRIPING NOTES**

- 1. PAINT 12" WIDE SOLID WHITE STANDARD CROSSWALK MARKING, PER PER CITY STANDARD DETAIL ST-10, SEE SHEET 60
- 2. PAINT DETAIL 1 (YELLOW CENTERLINE), SEE SHEET 58
- 3. PAINT "STOP" ROADWAY MARKINGS PER FIGURE 3B-23 (CA) AND CITY STANDARD DETAIL ST-11, SEE SHEET 58 AND 60
- 4. REINSTALL EXISTING STREET SIGN AND POLE
- 5. EXISTING STRIPING OR MARKING TO BE REMOVED BY SANDING OR WATER BLASTING




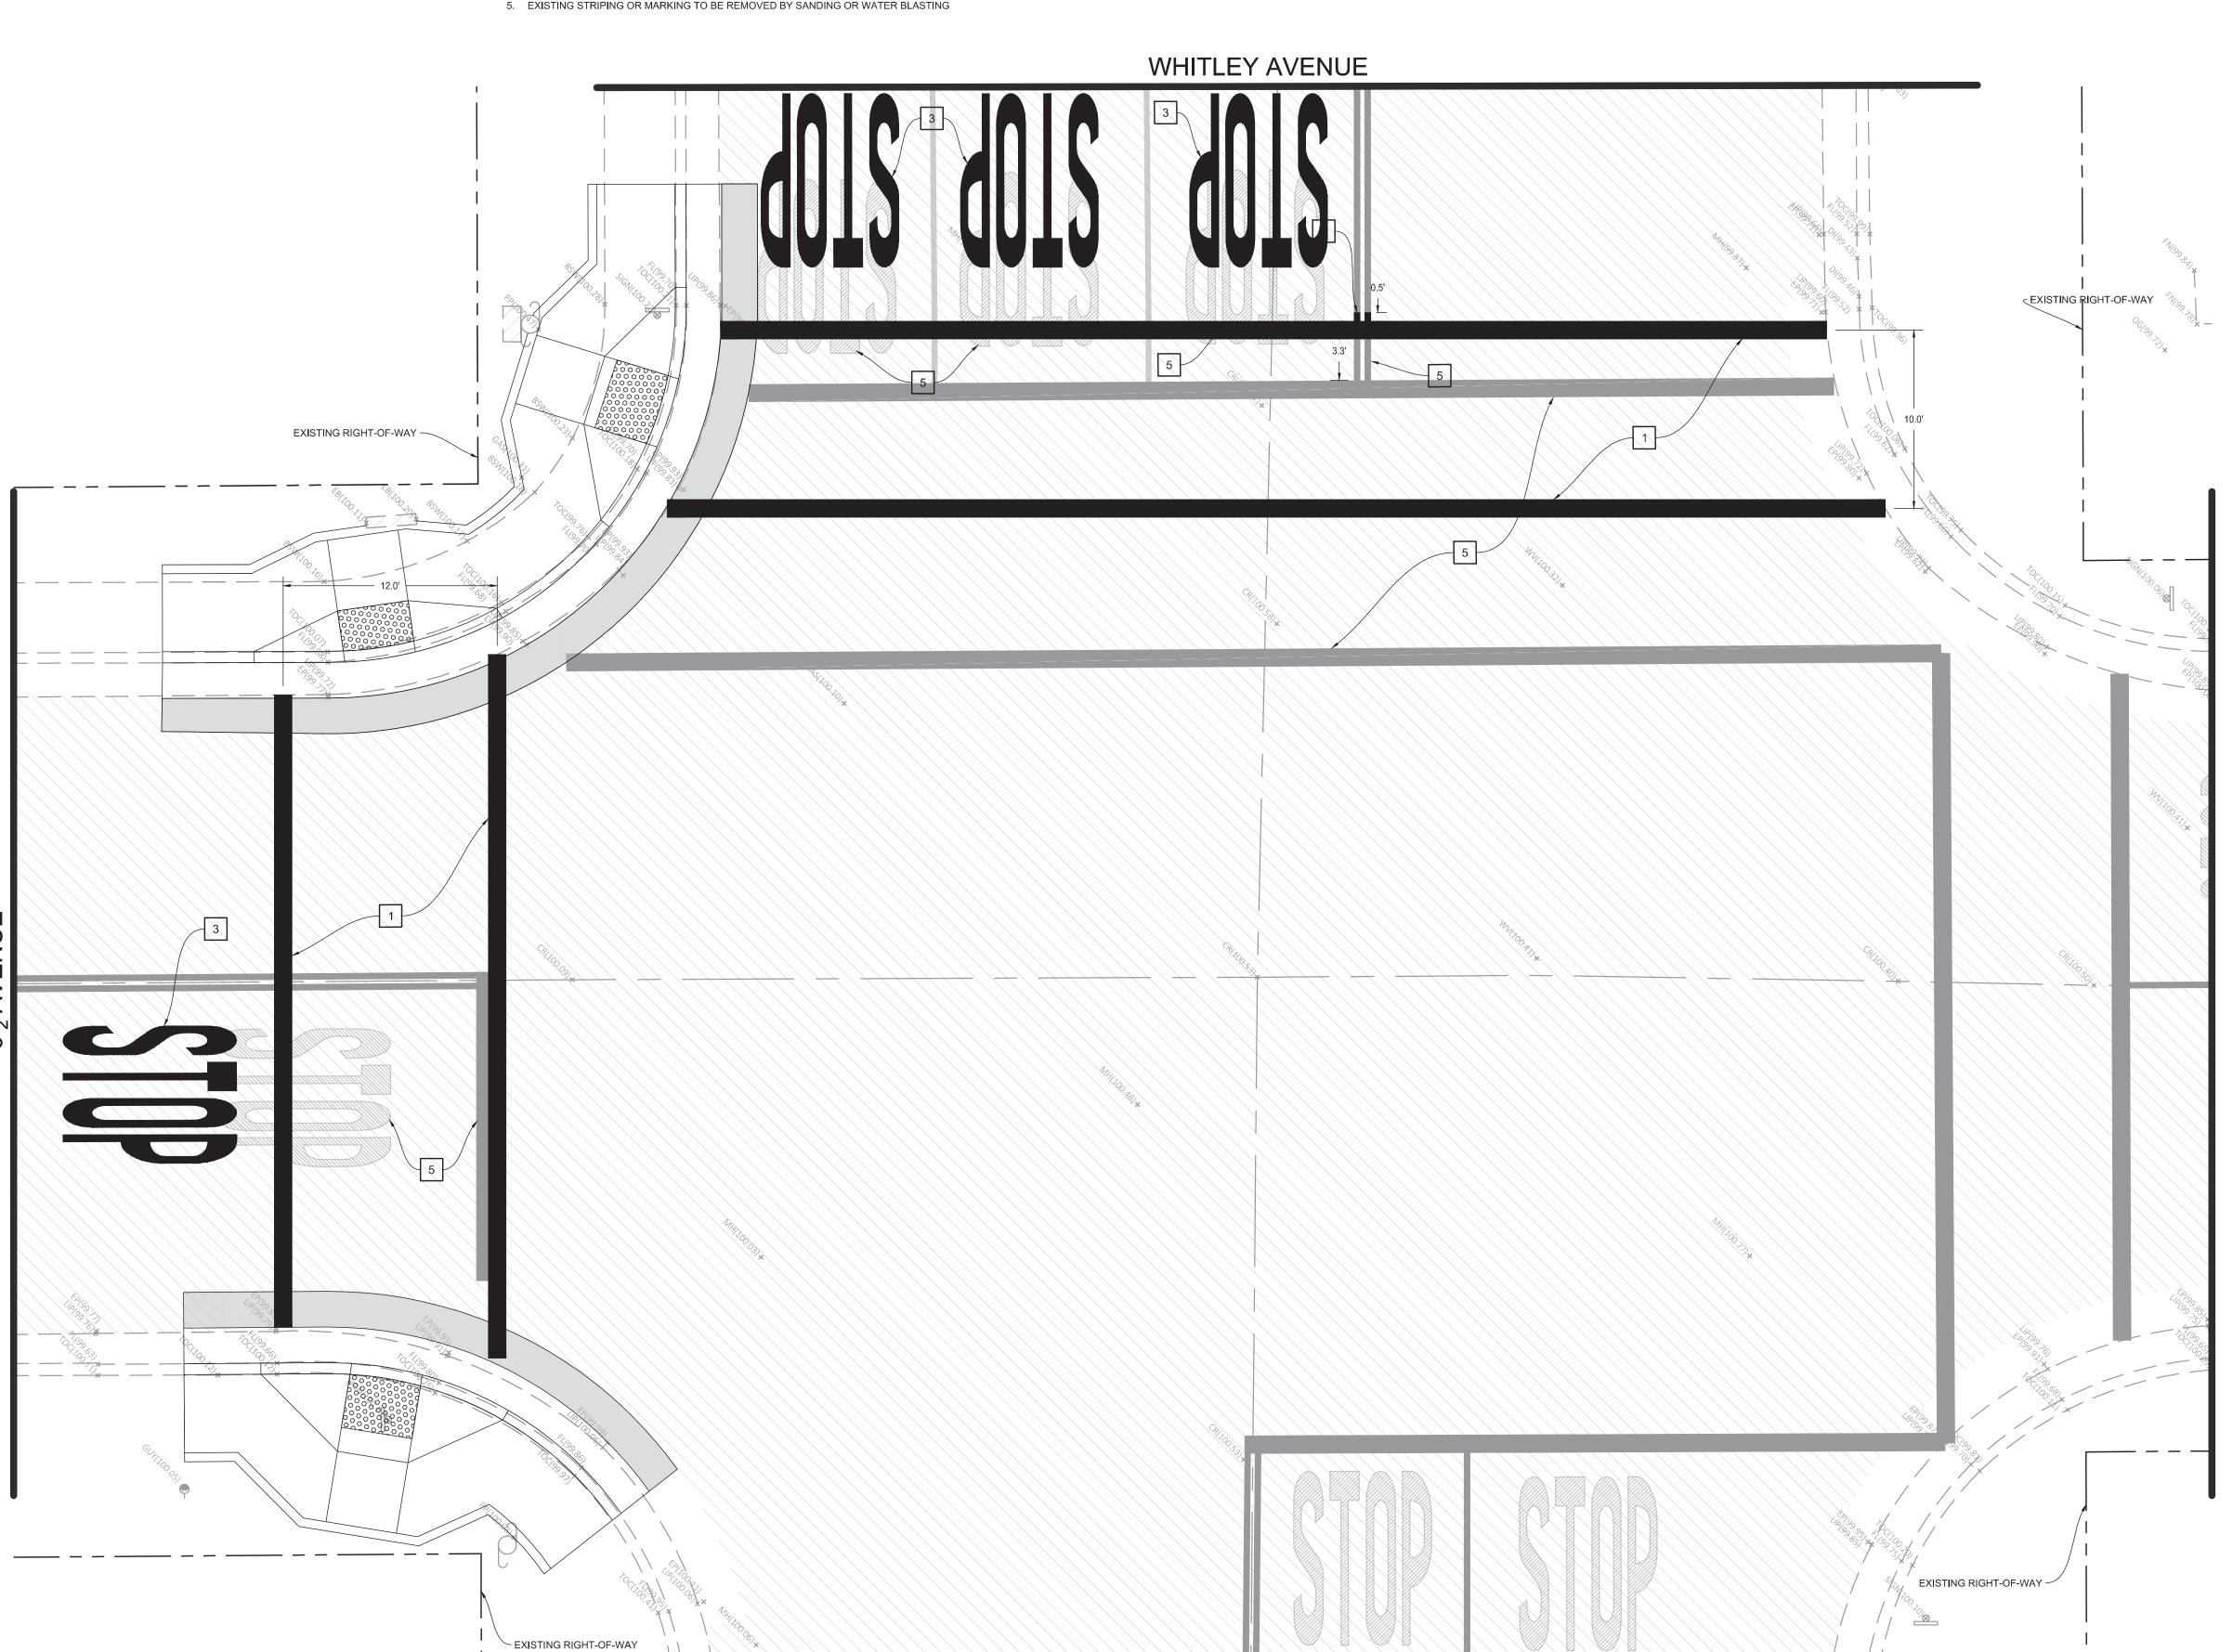



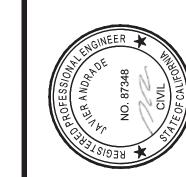




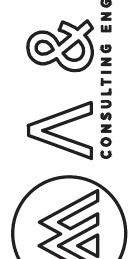

COR





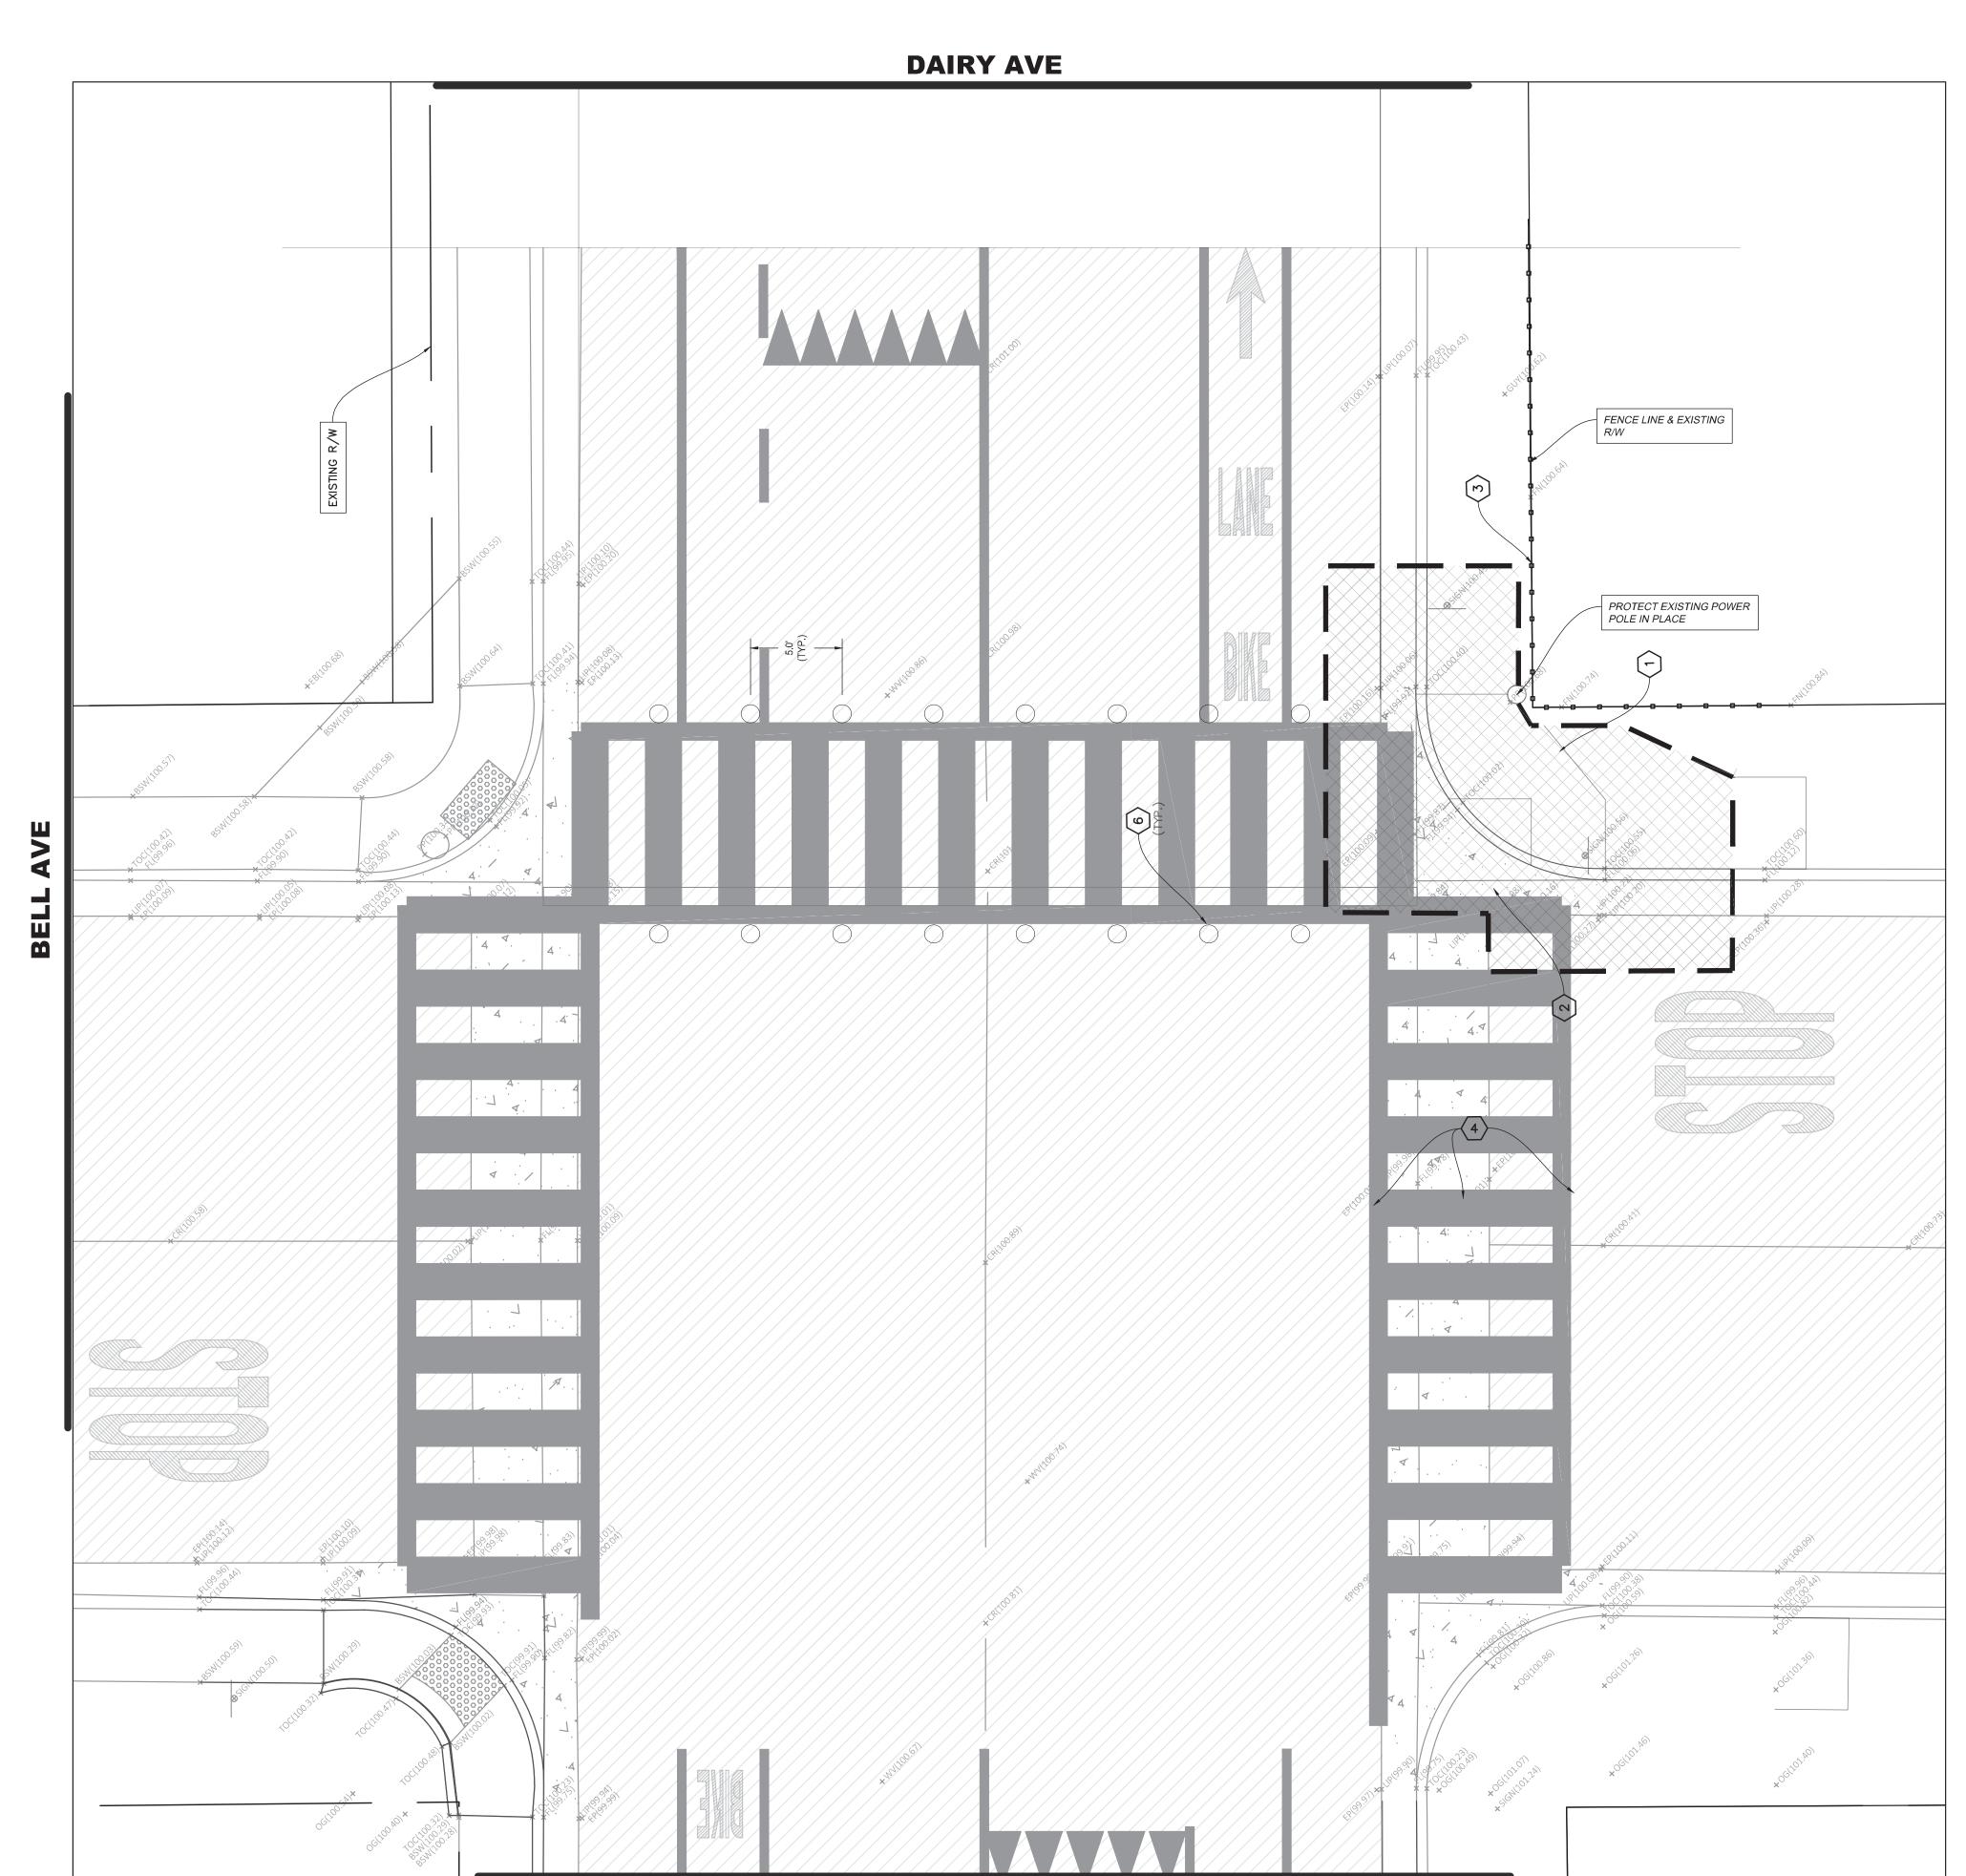

**DAIRY AVE** 


**CONTRACTOR NOTES** 

- 1. IT IS THE RESPONSIBILITY OF THE CONTRACTOR TO PRESERVE ALL SURVEY MONUMENTS. ANY MONUMENT DISTURBED DURING CONSTRUCTION SHALL BE PERPETUATED PER THE PROFESSIONAL LAND SURVEYOR'S ACT, BUSINESS AND PROFESSIONS CODE 8771, AT THE CONTRACTORS EXPENSE.
- 2. LOCATIONS OF EXISTING UTILITIES ARE APPROXIMATED. CONTRACTOR TO FIELD VERIFY ALL EXISTING UTILITIES BEFORE

# **DEMOLITION NOTES**

- 1. SAWCUT EXISTING CONCRETE TO A NEAT CLEAN EDGE LINE
- 2. SAWCUT EXISTING PAVEMENT TO A NEAT CLEAN EDGE LINE
- 3. EXISTING CHAIN LINK FENCE TO BE PROTECTED IN PLACE.
- 4. EXISTING STRIPING OR MARKING TO BE REMOVED BY SANDING OR WATER BLASTING.
- 5. EXISTING BIKE LANE TO BE REMOVED ALL THE WAY TO THE INTERSECTION OF DAIRY AND WHITLEY AVE
- 6. CORE DRILL HOLE, SEE SHEET 5 FOR IN-ROADWAY WARNING LIGHT (IRWL) INSTALLATION

# **LEGEND**

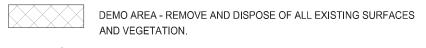

EXISTING STRIPING OR MARKING TO BE REMOVED BY SANDING OR WATER

—— (OU) —— EXISTING OVERHEAD COMMUNICATIONS UTILITY LINE —— (UU) —— EXISTING UNDERGROUND COMMUNICATIONS UTILITY LINE

—— (SS15)—— EXISTING SANITARY SEWER LINE

—— (GAS4) —— EXISTING 4" SERVICE GAS LINE

K BLINKER

EXISTING PAVEMEN

		LIGHTING ASSEMBLY MATERIAL LIST (FOR REFERENCE ONLY)				
38	CALLOUT	DESCRIPTION	UNIT	ESTIMATED QUANTITY		
	A	IN-ROADWAY WARNING LIGHT (IRWL), LIGHTS 5 FEET OF SPACING, UNIDIRECTIONAL AMBER, 50 FEET LEAD, LEFT	EA	8		
	В	IN-ROADWAY WARNING LIGHT (IRWL), LIGHTS 5 FEET OF SPACING, UNIDIRECTIONAL AMBER, 50 FEET LEAD, RIGHT	EA	8		
	©	EPOXY FOR IN-ROADWAY WARNING LIGHT (IRWL) STUDS	EA	16		
	D	CONTROLLER, IRWL, 12V, PROSTAR (OR EQUIVALENT)	EA	1		
	E	120625, RADIO HOLLOW, RELAY-DRIVEN IRWL CONTROLLOER (OR EQUIVALENT)	EA	1		
	F	CABINET BRACKET SET, FITS ROUND POLES 2-3/8 & UP, WITH STANDARD HARDWARE & SNAP LOCKS FOR 120625. (OR EQUIVALENT)	EA	2		
	G	85W/12V SOLAR PANEL PACKAGE, TOP OF POLE MOUNT 4.5" DIAMETER.	EA	2		
	Н	BATTERY 35AH, 12V AGM LEAD ACID. (OR EQUIVALENT)	EA	3		
		WIRE 2C 18AWG 16TC 2464 (OR EQUIVALENT)	FT	250		
	J	SPOOL 300V CM BRN/BLU	FT	1000		

# SIGNING, STRIPING & MARKINGS NOTES

- 1. ALL WORK AND MATERIALS SHALL CONFORM TO CALTRANS STANDARD PLANS (2015 REVISED STANDARD PLAN RSP) AND THE CA 2014 MANUAL ON UNIFORM TRAFFIC CONTROL DEVICES FOR STREETS AND HIGHWAYS MUTCD (REVISION 3).
- 2. ANY CONTRACTOR PERFORMING WORK ON THIS PROJECT SHALL FAMILIARIZE HIMSELF WITH THIS SITE AND SHALL BE SOLELY RESPONSIBLE FOR ANY DAMAGE TO EXISTING FACILITIES RESULTING DIRECTLY OR INDIRECTLY FROM HIS OPERATIONS, WHETHER OR NOT SUCH FACILITIES ARE SHOWN ON THESE PLANS.
- 3. FOR CROSSWALK DETAILS, PLEASE REFER TO THE DETAILS ON THIS SHEET. THE GAP BETWEEN THE LINES ON THE YELLOW SCHOOL CROSSWALK SHOULD BE 10 FEET WITH HIGH VISIBILITY 24" CONTINENTAL PATTERN AS SHOWN ON THE PLANS.
- 4. ALL EXISTING PAVEMENT STRIPING & MARKINGS ( CROSSWALKS, STOP BARS, STOP MARKING LEGENDS, CENTERLINE, ETC.) SHALL BE REPAINTED WHEN DISTURBED BY IMPROVEMENTS, UNLESS SPECIFIED OTHERWISE.

# Know what's below. Call 811 before you dig.

# **CONTRACTOR NOTES**

- 1. IT IS THE RESPONSIBILITY OF THE CONTRACTOR TO PRESERVE ALL SURVEY MONUMENTS. ANY MONUMENT DISTURBED DURING CONSTRUCTION SHALL BE PERPETUATED PER THE PROFESSIONAL LAND SURVEYOR'S ACT, BUSINESS AND PROFESSIONS CODE 8771, AT THE CONTRACTORS EXPENSE.
- 2. LOCATIONS OF EXISTING UTILITIES ARE APPROXIMATED. CONTRACTOR TO FIELD VERIFY ALL EXISTING UTILITIES BEFORE COMMENCEMENT OF WORK.

# **BENCHMARK**

LOCAL BENCHMARK:

CHISELED X ON CURB

# **CONTRACTOR NOTES**

- 1. IT IS THE RESPONSIBILITY OF THE CONTRACTOR TO PRESERVE ALL SURVEY MONUMENTS. ANY MONUMENT DISTURBED DURING CONSTRUCTION SHALL BE PERPETUATED PER THE PROFESSIONAL LAND SURVEYOR'S ACT, BUSINESS AND PROFESSIONS CODE 8771, AT THE CONTRACTORS EXPENSE.
- 2. LOCATIONS OF EXISTING UTILITIES ARE APPROXIMATED. CONTRACTOR TO FIELD VERIFY ALL EXISTING UTILITIES BEFORE COMMENCEMENT OF WORK.

# **SIDEWALK AND RAMP NOTES**

- 1. MAXIMUM SLOPES OF ADJOINING GUTTERS, THE ROAD SURFACE IMMEDIATELY ADJACENT TO THE CURB RAMP OR ACCESSIBLE ROUTE SHALL NOT EXCEED 5% WITHIN 4' OF THE BOTTOM OF THE CURB RAMP.
- 2. NO CROSS SLOPE IN THE PATH OF TRAVEL TO EXCEED 1.5%
- 3. SIDEWALKS AND RAMPS SHALL BE STEEL TOWELED AND HAVE A LIGHT BROOM FINISH UNLESS OTHERWISE NOTED. RAMPS SHALL HAVE A HEAVY BROOM FINISH ACROSS THE SLOPE OF THE RAMP.
- 4. SIDEWALKS AND RAMPS SHALL HAVE WEAKEN PLANE JOINTS CONSTRUCTED WHERE SHOWN IN THESE IMPROVEMENT PLANS. WEAKENED PLANE JOINTS SHALL BE A MINIMUM OF 1 INCH IN DEPTH AND SHALL BE FINISHED WITH A SCORING TOOL LEAVING THE EDGES ROUNDED.
- 5. SIDEWALKS AND RAMPS SHALL BE PLACED ON 6 INCH MOIST AND COMPACTED BASE MATERIALS. 90% RELATIVE COMPACTION UNDER SIDEWALKS. 95 PERCENT RELATIVE COMPACTION UNDER RAMPS AND SIDEWALKS.


# **GENERAL CONCRETE NOTES**

- 1. ALL CONCRETE SHALL BE CLASS 3 CONCRETE UNLESS OTHERWISE SPECIFIED.
- 2. CLASS 3 CONCRETE SHALL CONTAIN NOT LESS THAN 505 POUNDS OF PORTLAND CEMENT PER CUBIC YARD WITH 1 IN AGGREGATE, 5 INCH MAXIMUM SLUMP, 2500 P.S.I. AT 28 DAYS.
- 3. WHEN MAXIMUM DAYTIME TEMPERATURE EXCEEDS 50° F. ALL NEWLY PLACED CONCRETE SHALL BE SPRAYED UNIFORMLY WITH A CURING COMPOUND. CURING COMPOUND SHALL BE APPLIED AT A NOMINAL RATE OF ONE GALLON PER 150 SQUARE FEET, UNLESS OTHERWISE SPECIFIED.
- 4. ALL WORK CONSTRUCTED BY THESE PLANS SHALL BE IN COMPLIANCE WITH ALL CURRENT ADA REGULATIONS.

# **CONSTRUCTION NOTES**


- 1. INSTALL TAPCO FLASHING SOLAR LED SIGN (SN: J-528763-1601), (SKU: C-DBB-1ABFPBWNNAA) WITH POST, SEE SHEET 38 FOR DETAILS
- (2.) INSTALL 3' DEEP BY 10 WIDE DETECTABLE WARNING SURFACE (RAISED TRUNCATED DOMES)
- 3. CONSTRUCT NEW ACCESSIBLE RAMP PER CITY STANDARDS AND AS SHOWN
- 4. CONSTRUCT PAVEMENT PATCH PER DETAIL 1 ON SHEET 38
- (7.) INSTALL SOLAR LED IN-ROAD WARNING LIGHTS PER MANUFACTURER'S RECOMMENDATIONS.
- 8. THE TOP FACE OF THE CURB SHALL BE PAINTED WITH YELLOW WATERBORNE PAINT AND APPLY GLASS BEADS FOR
- RETROFLECTIVITY IN ACCORDANCE TO CALTRANS STANDARD SPECIFICATIONS

  (9.) INSTALL WEAKENED PLANE JOINT AROUND RAMP PERIMETER TYPICAL.
- 10.) HEAVY BROOM FINISH ACROSS SLOPE OF RAMPS TYPICAL.
- 11.) PROTECT IN PLACE DRAIN INLET (DI)
- (12.) ALIGN IRWL AT A POINT OF CONVERGENCE OF 200' RELATIVE TO EACH LANE FOR EACH TRAVEL LANE DIRECTION (CONTRACTOR TO VERIFY LOCATION WITH DESIGN ENGINEER BEFORE PROCEEDING)

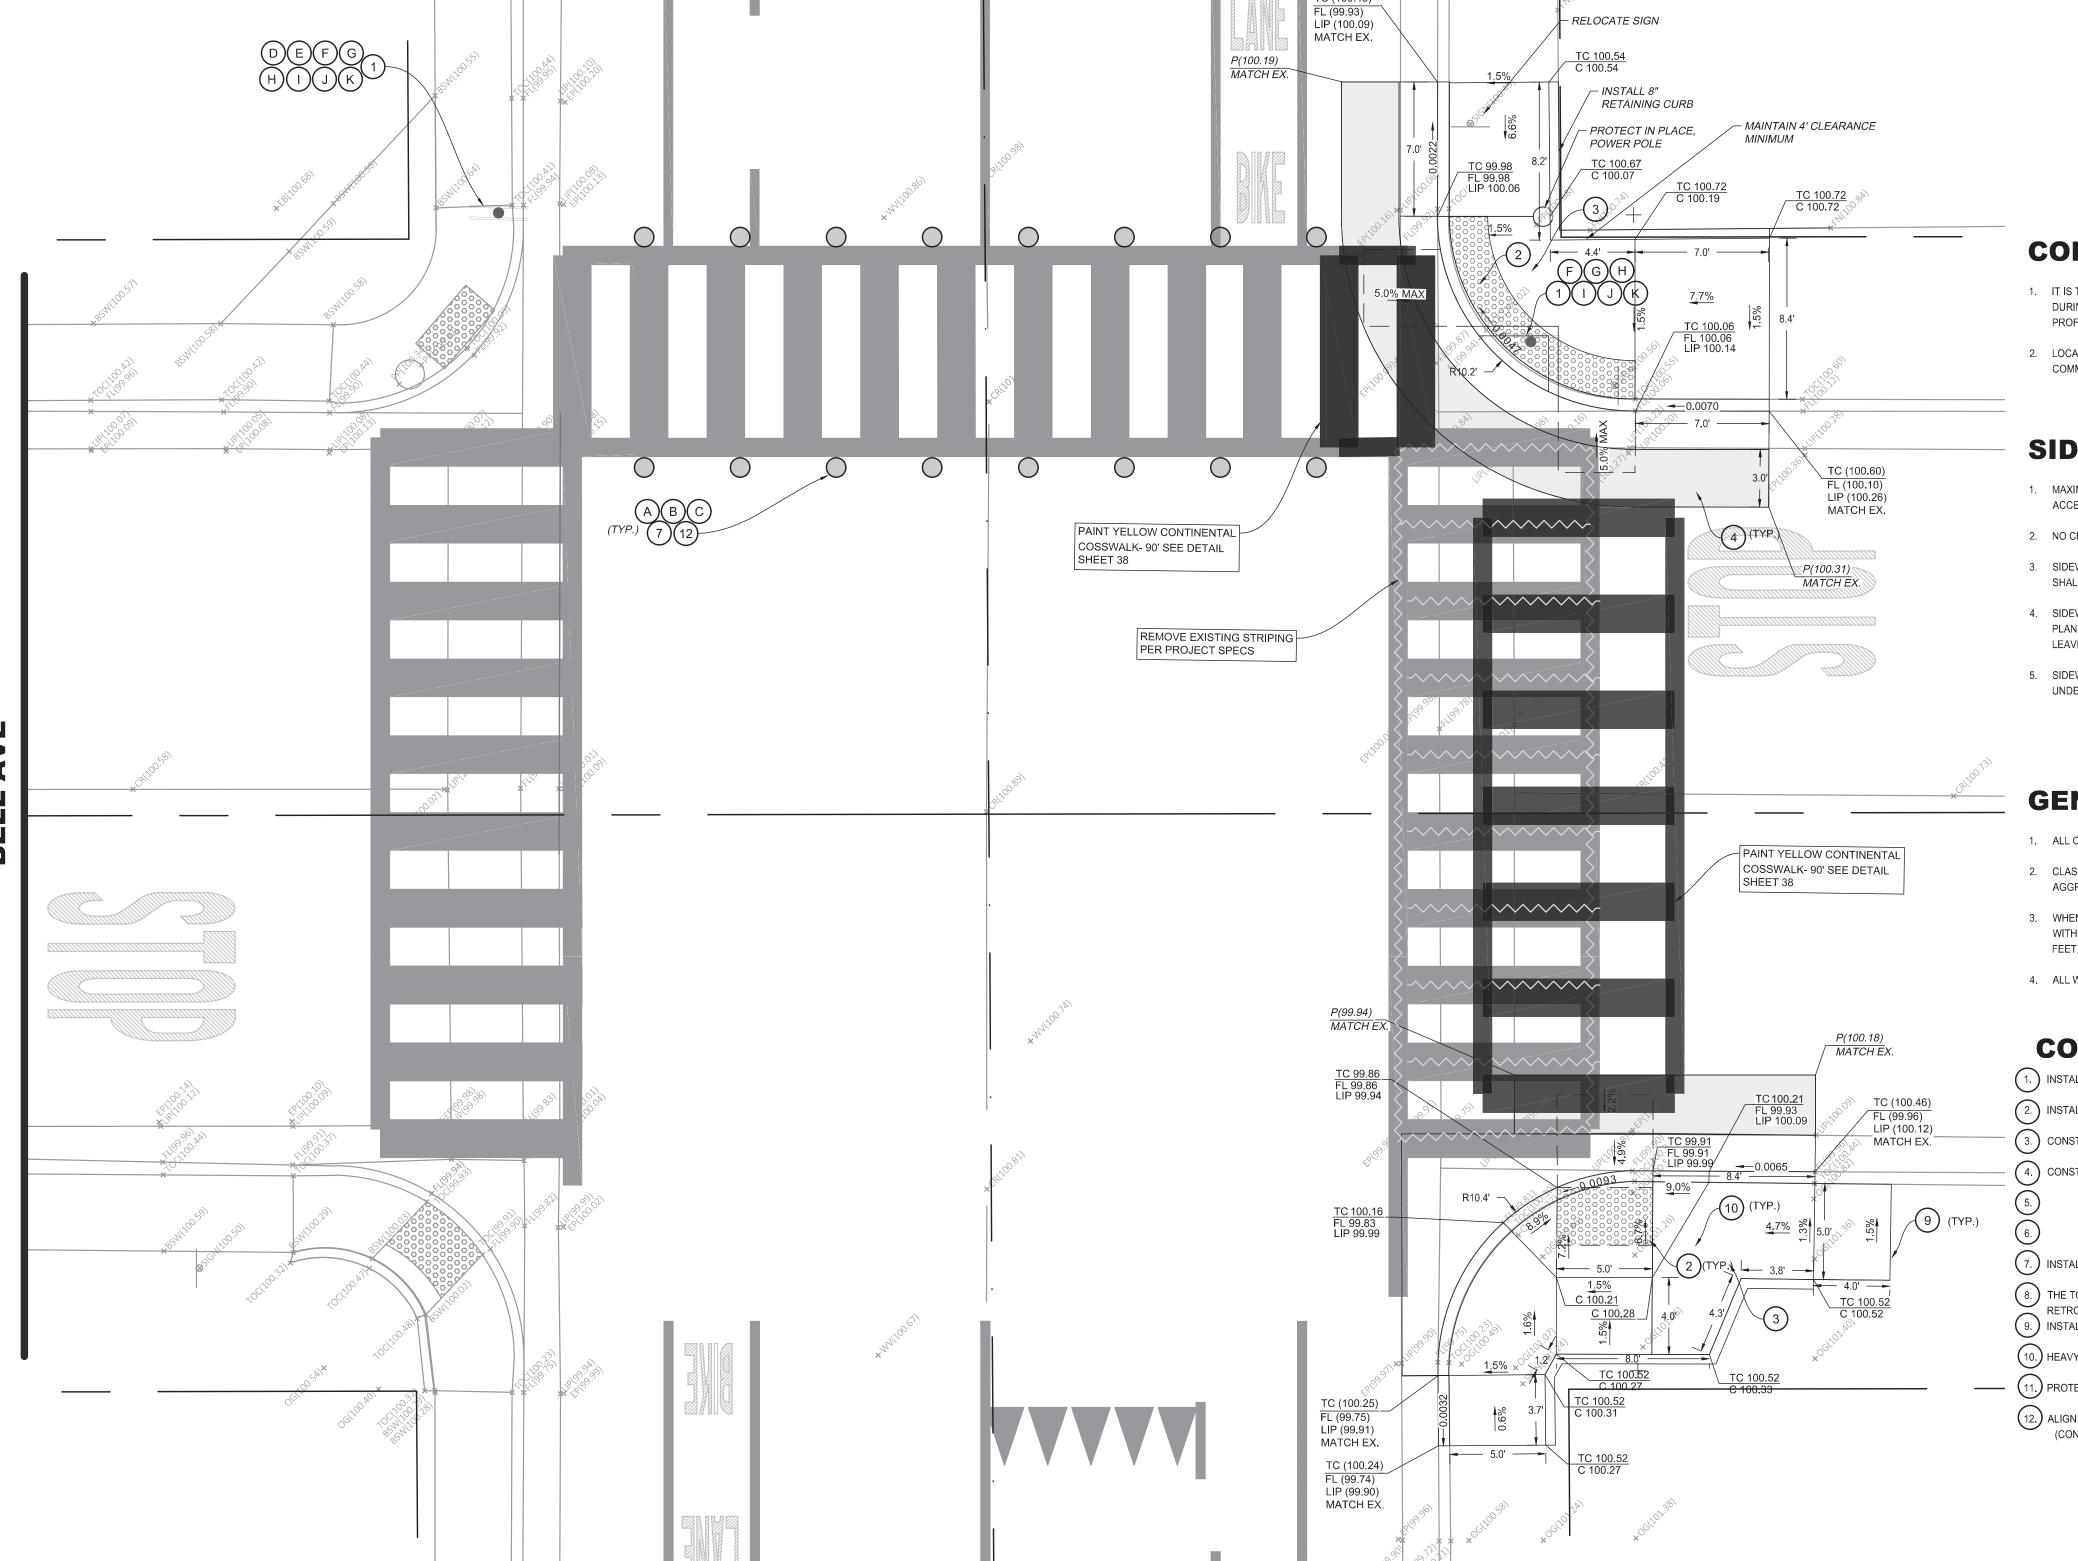

**DAIRY AVE** 

**DAIRY AVE** 

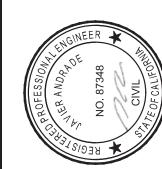

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PROVEMENTS

SHEETTITE:

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> 220\_008 OM

SCALE:

JOB NO: 220\_00

QA/QC: OM

FILE:

DATE: 9/4/203




SHEET NO.

36


OF 61




SHEET NO

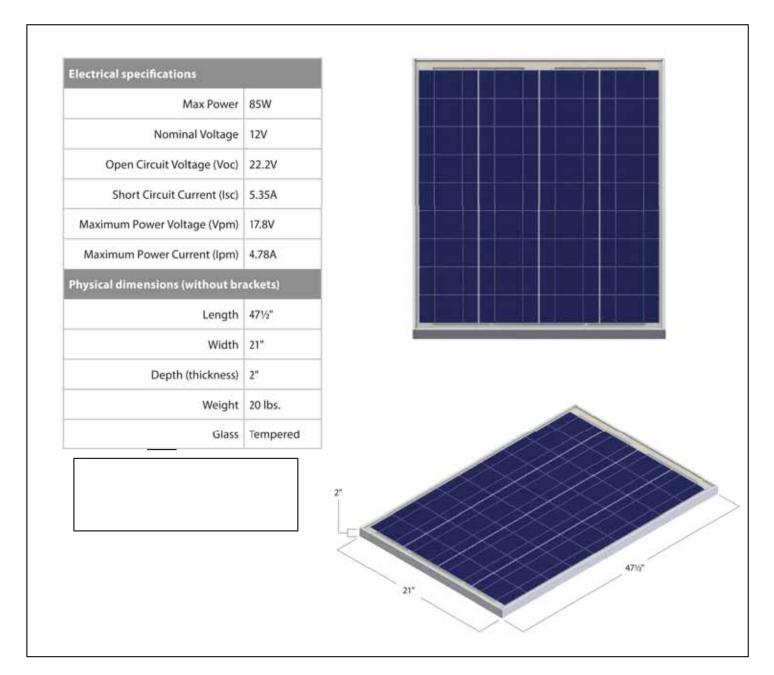


TYPICAL 85W SOLAR PANEL N.T.S.

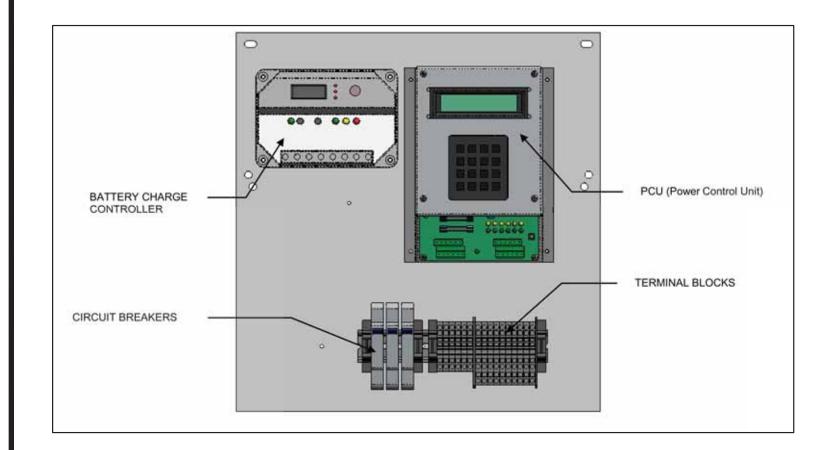

TYPICAL SOLAR BACK PANEL LAYOUT N.T.S.

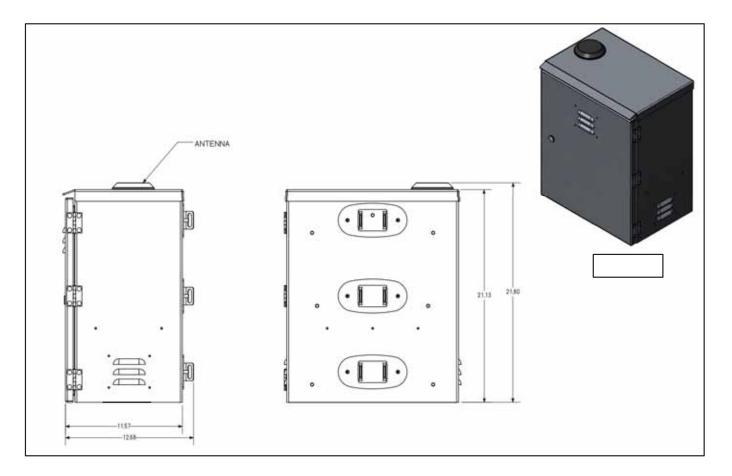

TYPICAL SOLAR ENCLOSURE N.T.S.

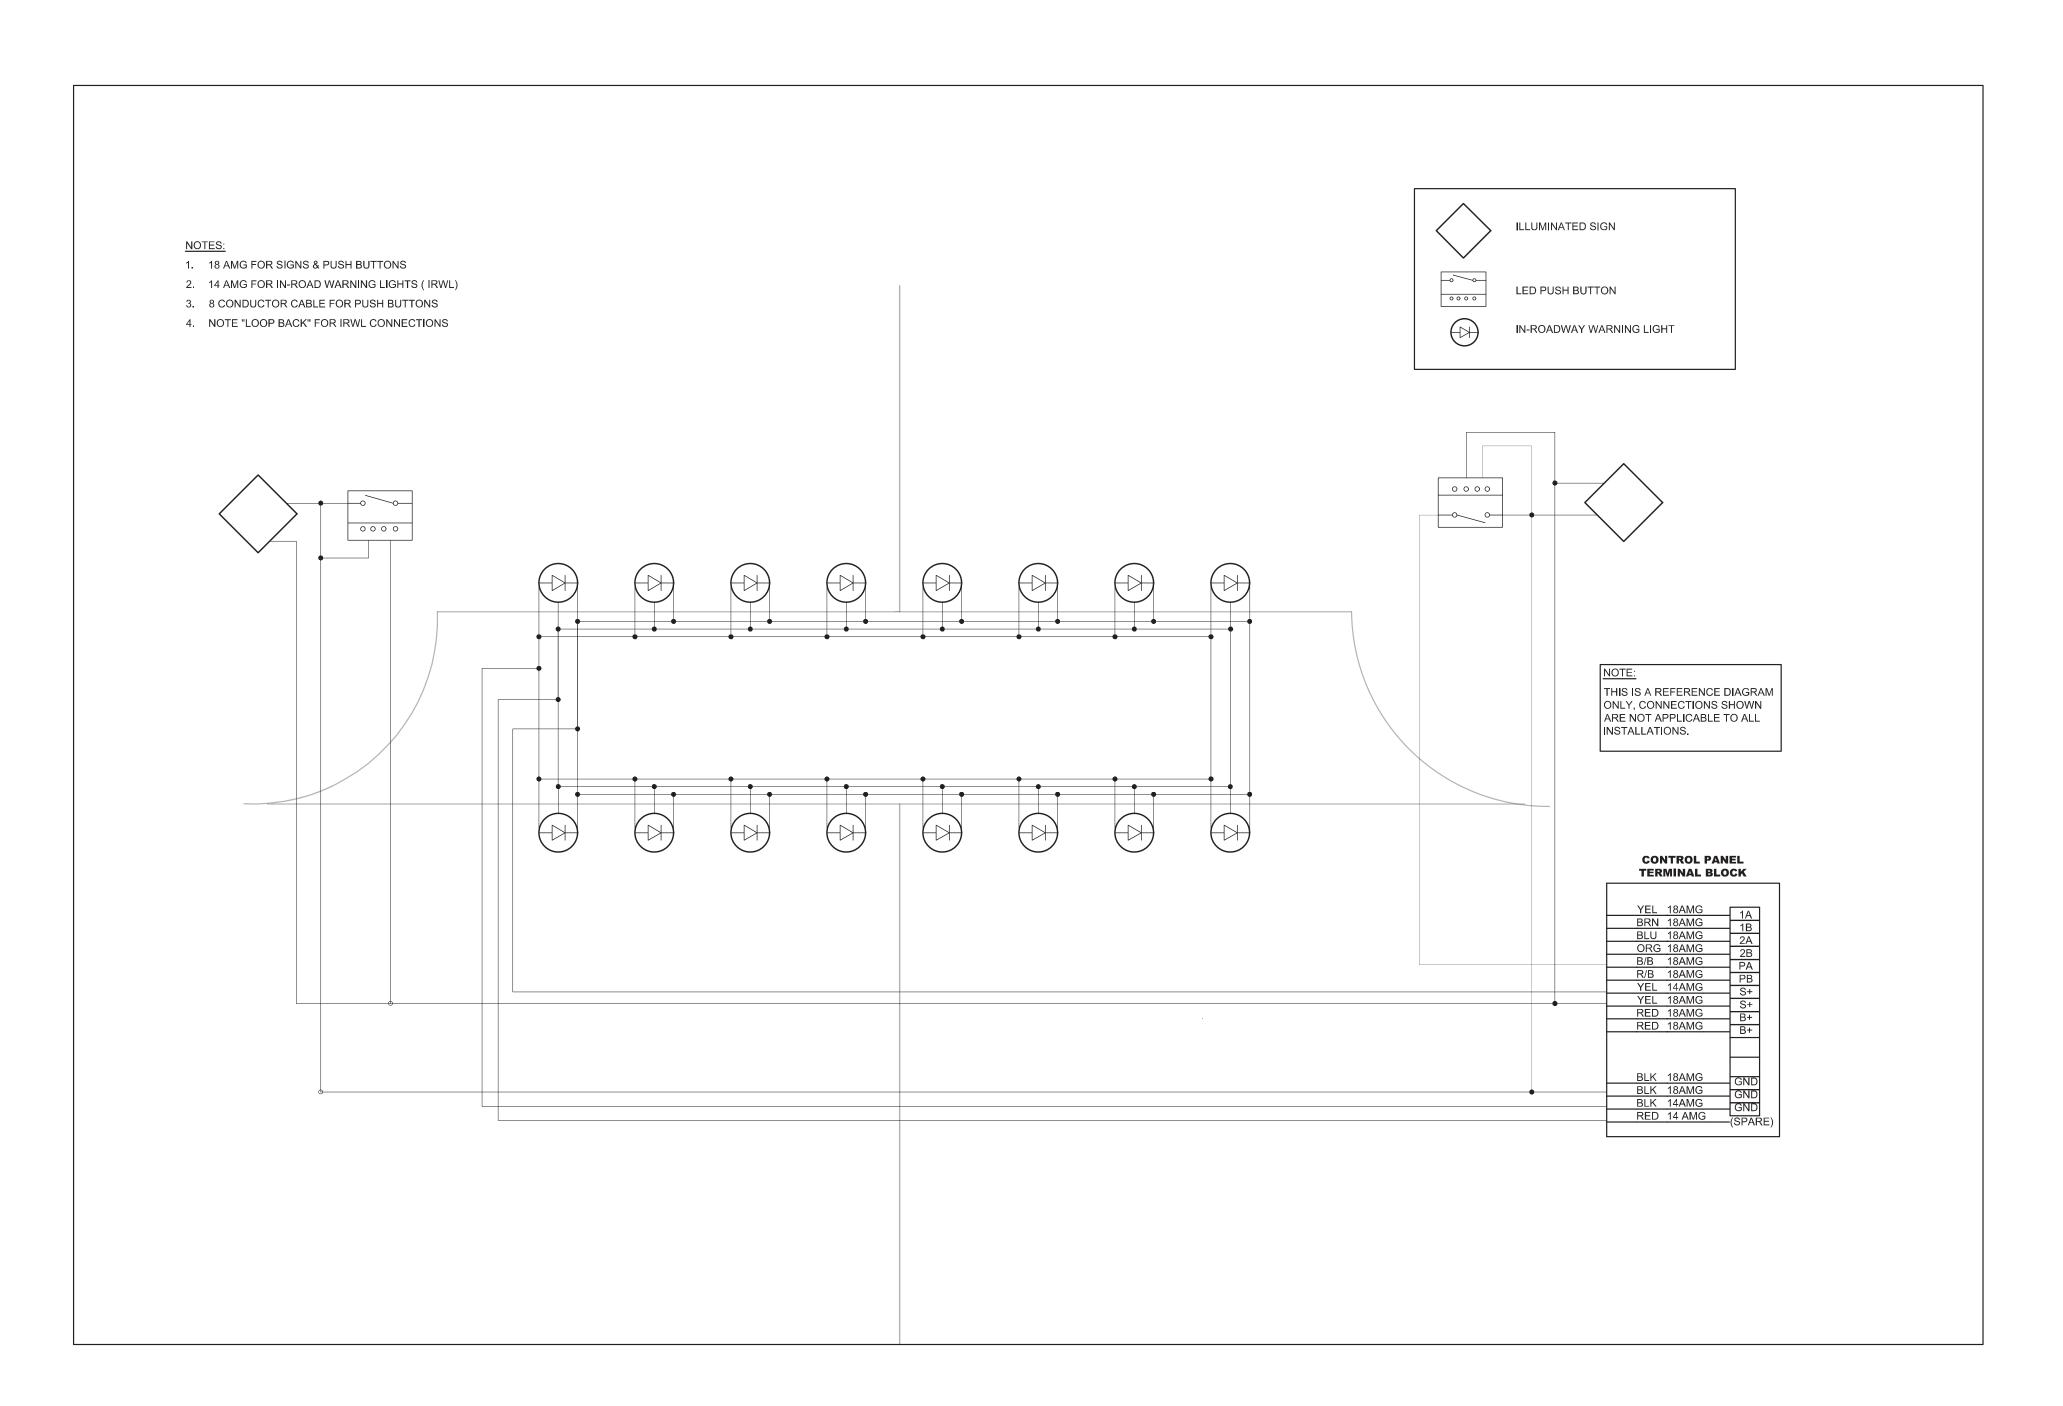


TYPICAL IN-ROADWAY WARNING LIGHT WIRING DIAGRAM N.T.S.

JOB NO: QA/QC: FILE: DATE:




SHEET NO.

38

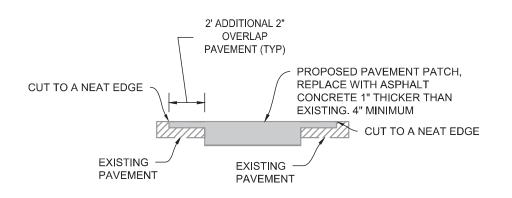

# DETAIL 1 PAVEMENT SECTION PATCH (N.T.S.)


	LIGHTING ASSEMBLY MATERIAL LIST (FOR REFERENCE ONLY)		
CALLOUT	DESCRIPTION	UNIT	ESTIMATED QUANTITY
A	IN-ROADWAY WARNING LIGHT (IRWL), 8 LIGHTS 5FT OF SPACING, UNIDIRECTIONAL AMBER, 50 FEET LEAD, LEFT	EA	1
В	IN-ROADWAY WARNING LIGHT (IRWL), 8 LIGHTS 5 FEET OF SPACING, UNIDIRECTIONAL AMBER, 50 FEET LEAD, RIGHT	EA	1
(c)	EPOXY FOR IN-ROADWAY WARNING LIGHT (IRWL) STUDS	EA	16
(-)	CONTROLLER, IRWL, 12V, PROSTAR (OR EQUIVALENT)	EA	1
Œ	120625, RADIO HOLLOW, RELAY-DRIVEN IRWL CONTROLLOER (OR EQUIVALENT)	EA	1
F	CABINET BRACKET SET, FITS ROUND POLES 2-3/8 & UP, WITH STANDARD HARDWARE & SNAP LOCKS FOR 120625. (OR EQUIVALENT)	EA	1
G	85W/12V SOLAR PANEL PACKAGE, TOP OF POLE MOUNT 4.5" DIAMETER.	EA	1
H	BATTERY 35AH, 12V AGM LEAD ACID. (OR EQUIVALENT)	EA	3
	WIRE 2C 18AWG 16TC 2464 (OR EQUIVALENT)	FT	250
(7)	1000 FEET SPOOL 300V CM BRN/BLU	FT	1000
K	BLINKER ON SITE	EA	1

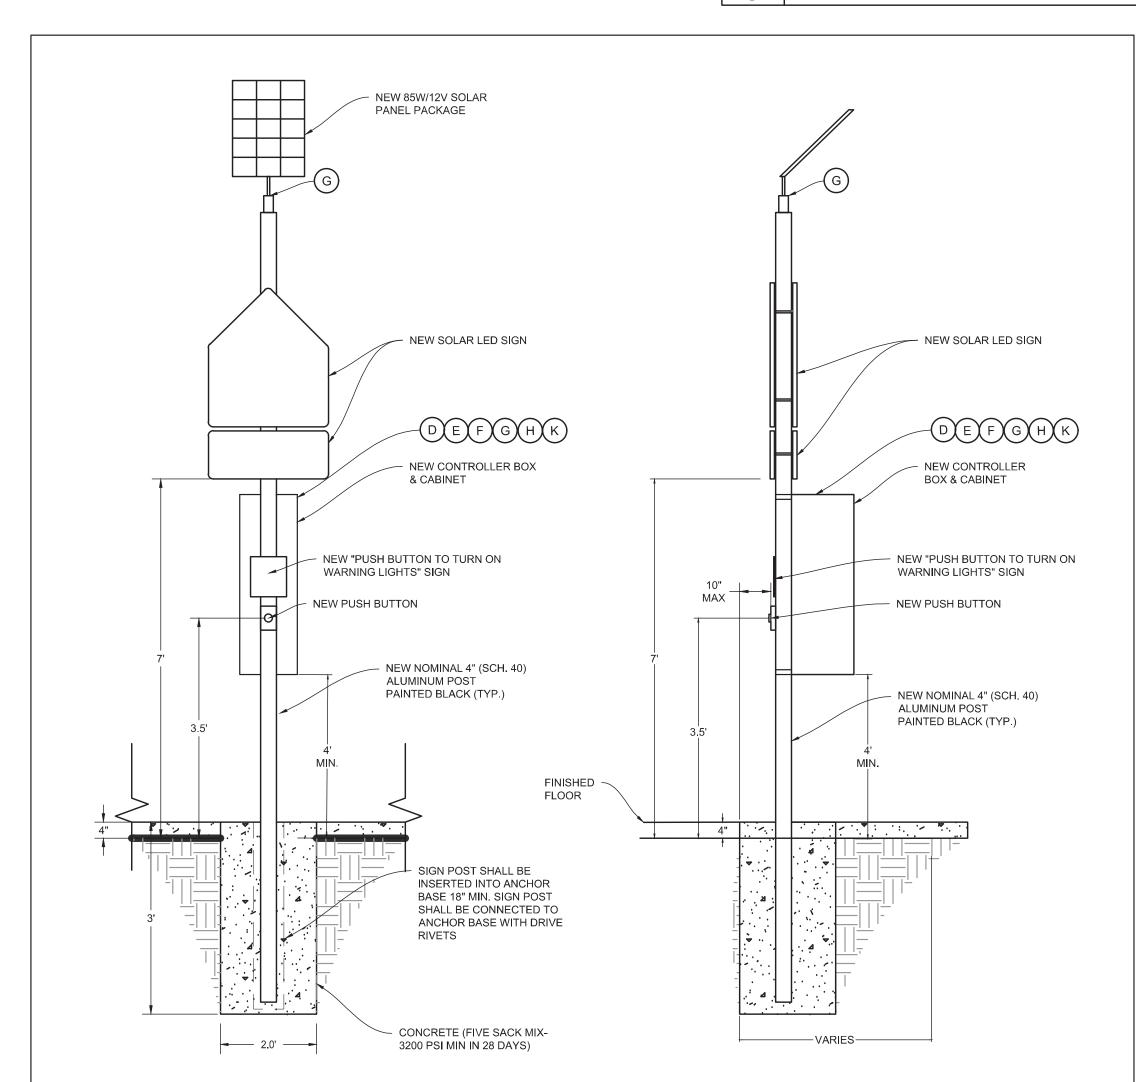


PROPOSED SOLAR FLASHING SIGN W/ CONTROLLER BOX INSTALLATION LAYOUT (PROFILE VIEW)

SCALE: N.T.S.




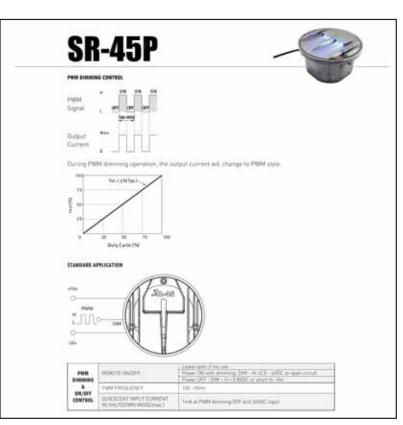


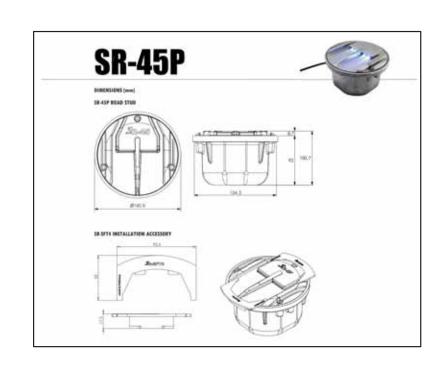




GENERAL HARDWIRED ROAD STUD
WITH POWER LED DETAILS
SCALE: N.T.S.

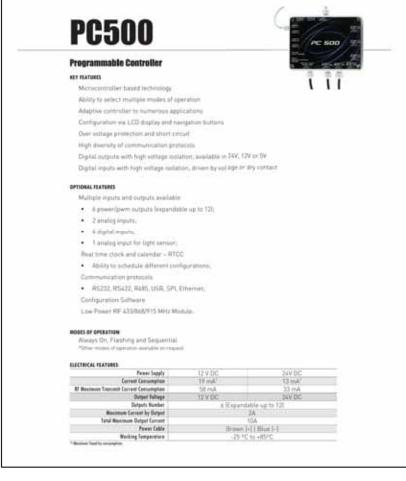


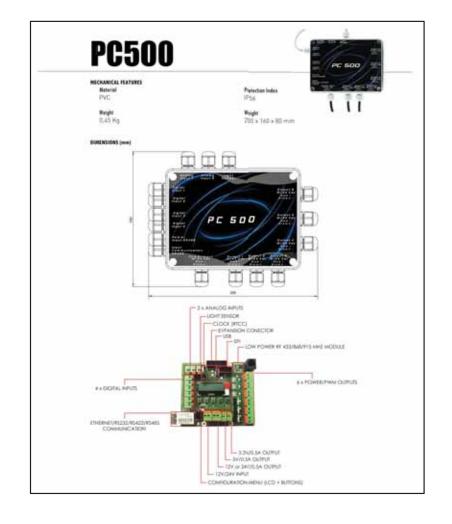

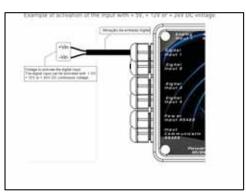

# GENERAL PROGRAMMABLE CONTROLLER DETAILS

SCALE: N.T.S.

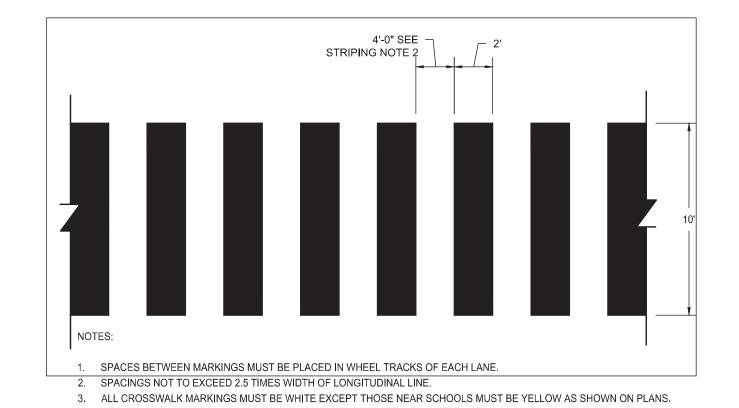


HIGH VISIBILITY CROSSWALK CONTINENTAL

DETAIL
(N.T.S.)





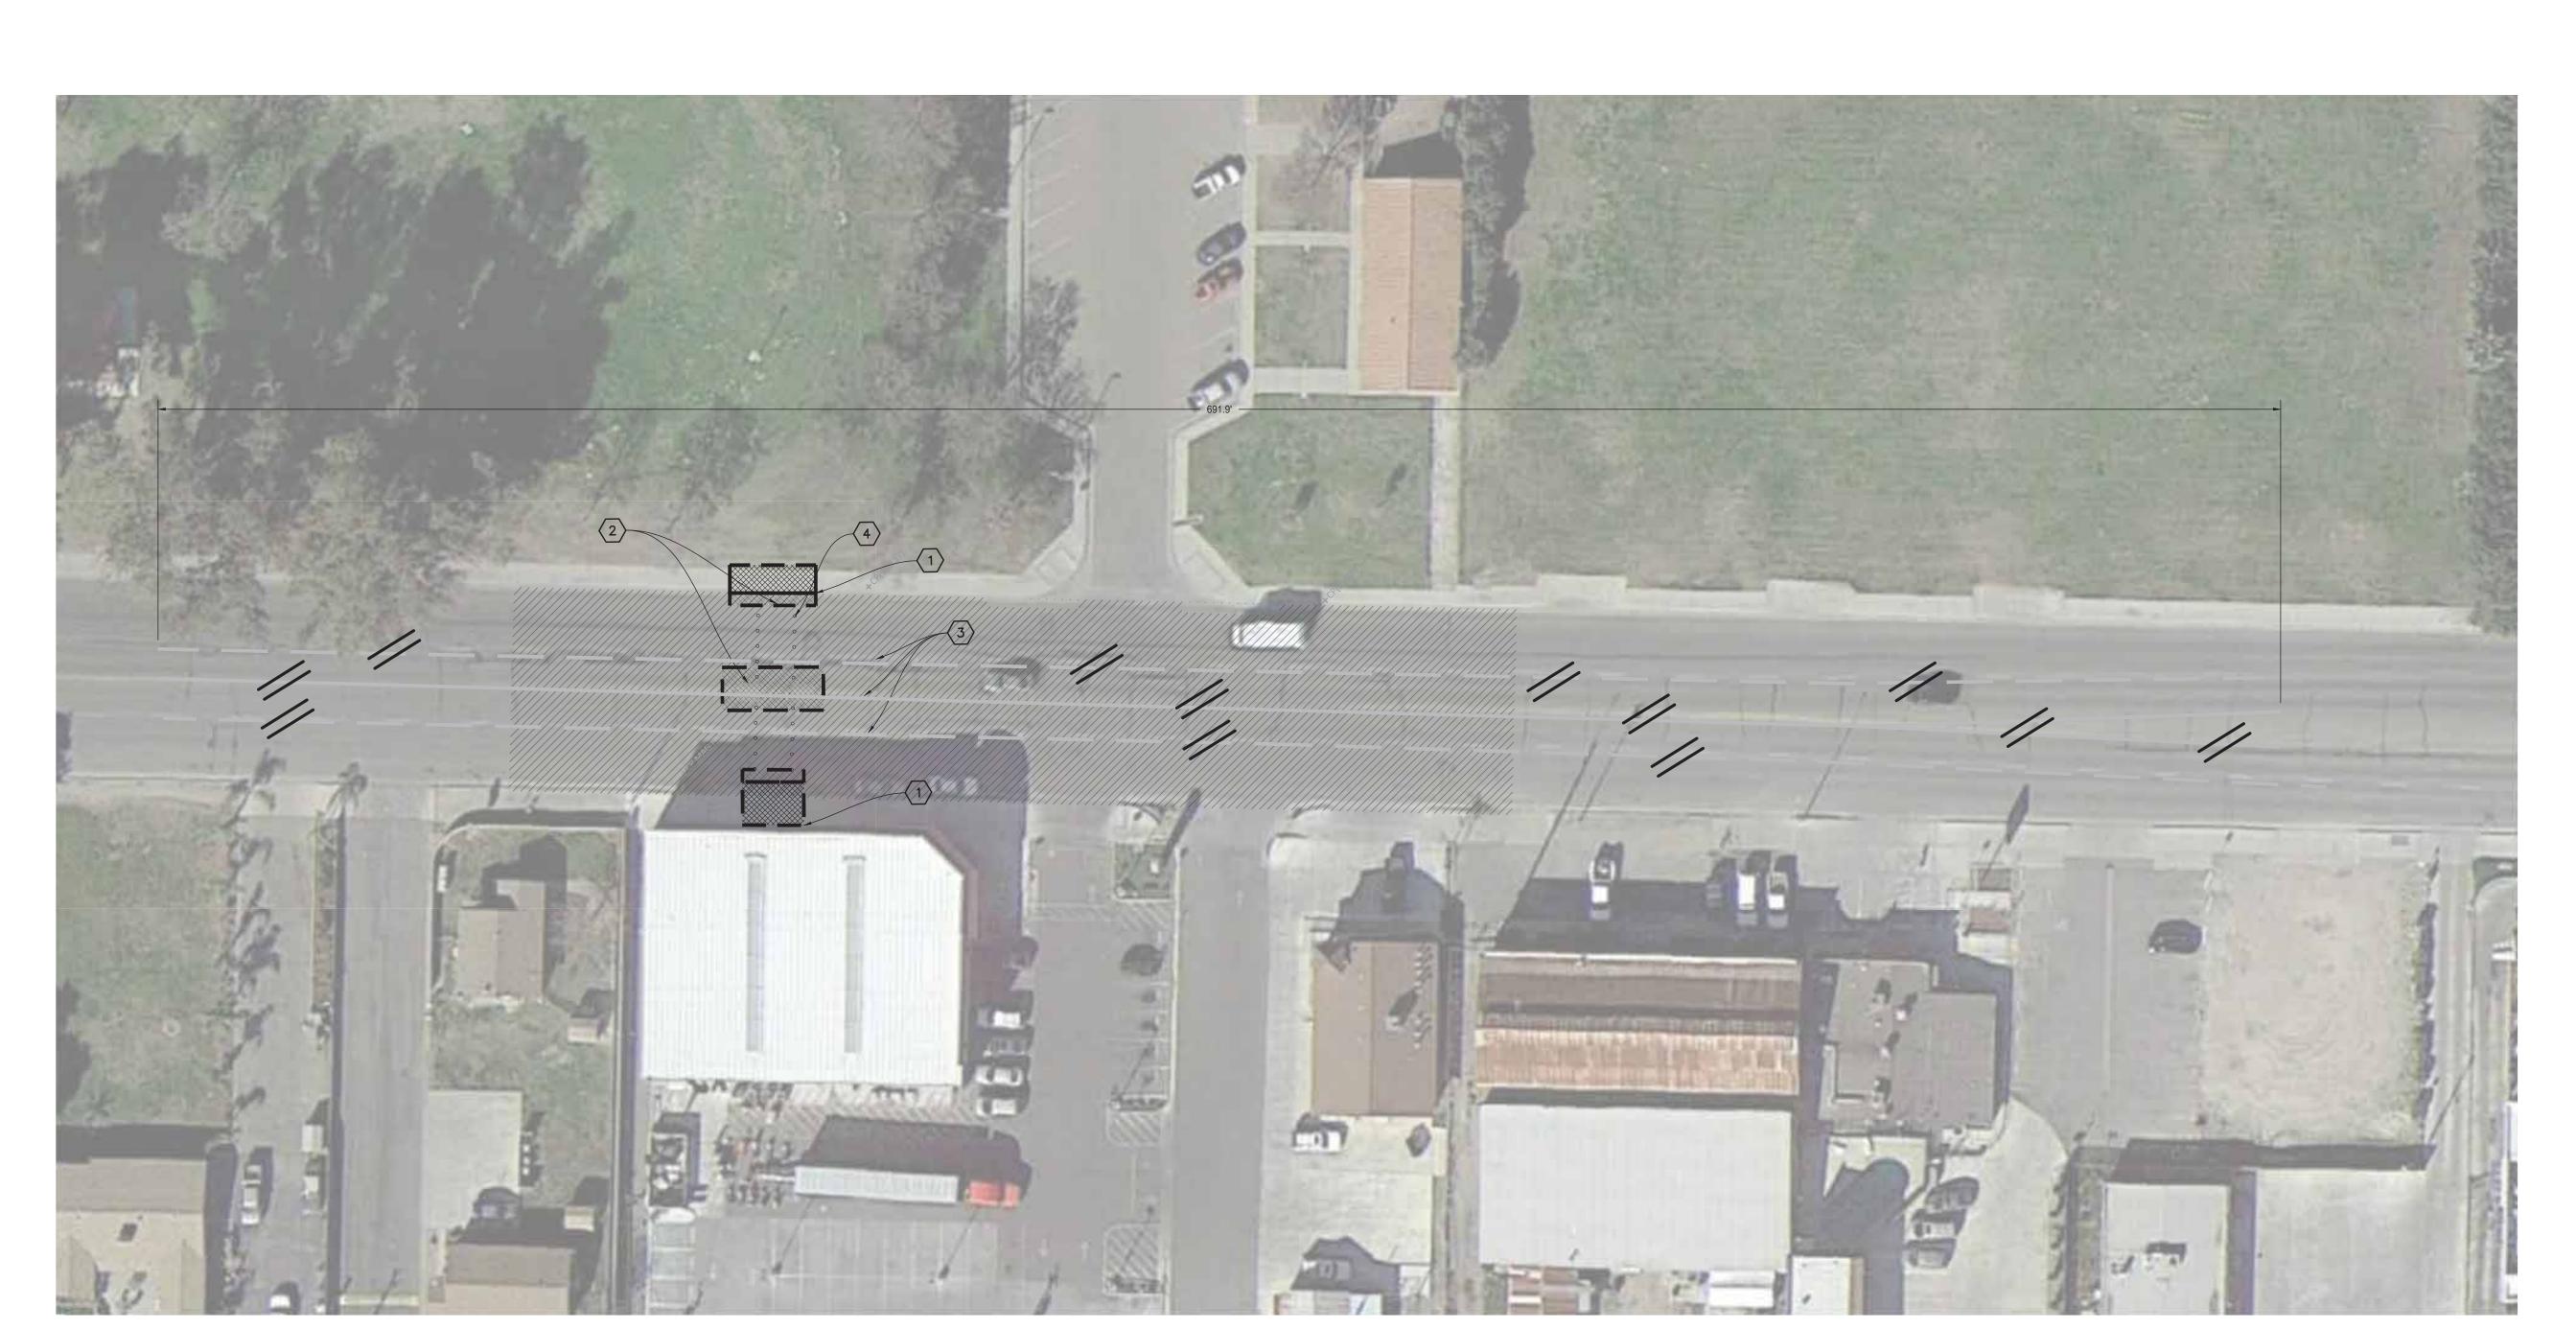

- 1. IT IS THE RESPONSIBILITY OF THE CONTRACTOR TO PRESERVE ALL SURVEY MONUMENTS. ANY MONUMENT DISTURBED DURING CONSTRUCTION SHALL BE PERPETUATED PER THE PROFESSIONAL LAND SURVEYOR'S ACT, BUSINESS AND PROFESSIONS CODE 8771, AT THE CONTRACTORS EXPENSE.
- 2. LOCATIONS OF EXISTING UTILITIES ARE APPROXIMATED. CONTRACTOR TO FIELD VERIFY ALL EXISTING UTILITIES BEFORE COMMENCEMENT OF WORK.

#### **DEMOLITION NOTES**

1. SAWCUT EXISTING CONCRETE TO A NEAT CLEAN EDGE LINE

2. SAWCUT EXISTING PAVEMENT TO A NEAT CLEAN EDGE LINE

3. EXISTING STRIPING OR MARKING TO BE REMOVED BY SANDING OR WATER BLASTING.


4. CORE DRILL HOLE, SEE SHEET 5 FOR IN-ROADWAY WARNING LIGHT (IRWL) INSTALLATION

#### **LEGEND**

//// EXISTING PAVEMENT



DEMO AREA - REMOVE AND DISPOSE OF ALL EXISTING SURFACES AND VEGETATION.

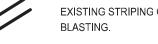

EXISTING STRIPING OR MARKING TO BE REMOVED BY SANDING OR WATER


EXISTING OVERHEAD COMMUNICATIONS UTILITY LINE

EXISTING UNDERGROUND COMMUNICATIONS UTILITY LINE

EXISTING WATER SERVICE LINE


EXISTING SANITARY SEWER LINE

EXISTING 4" SERVICE GAS LINE

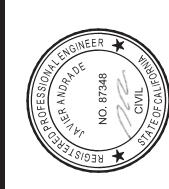


COR



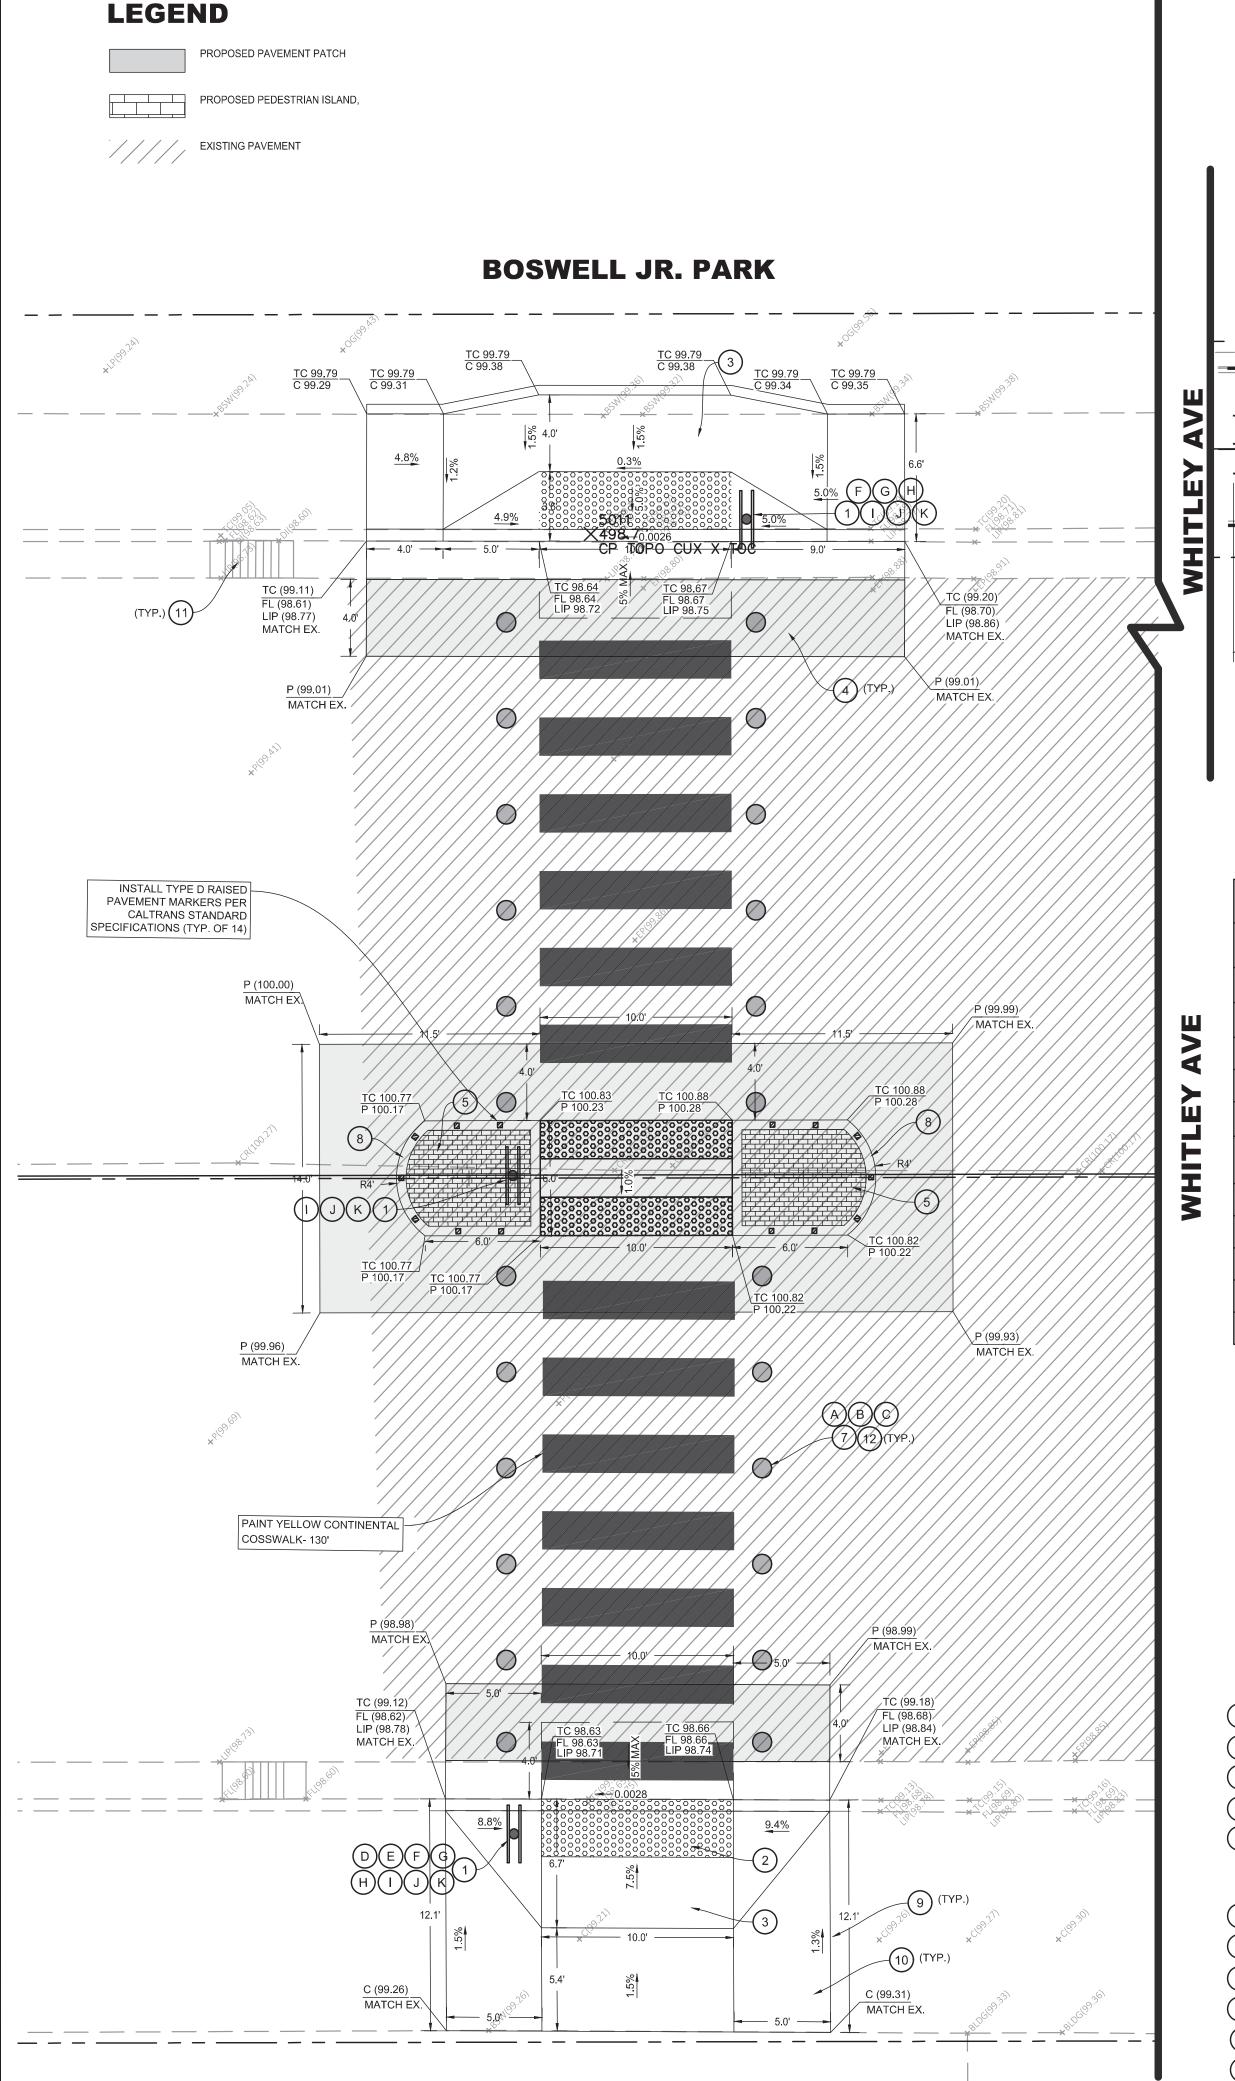





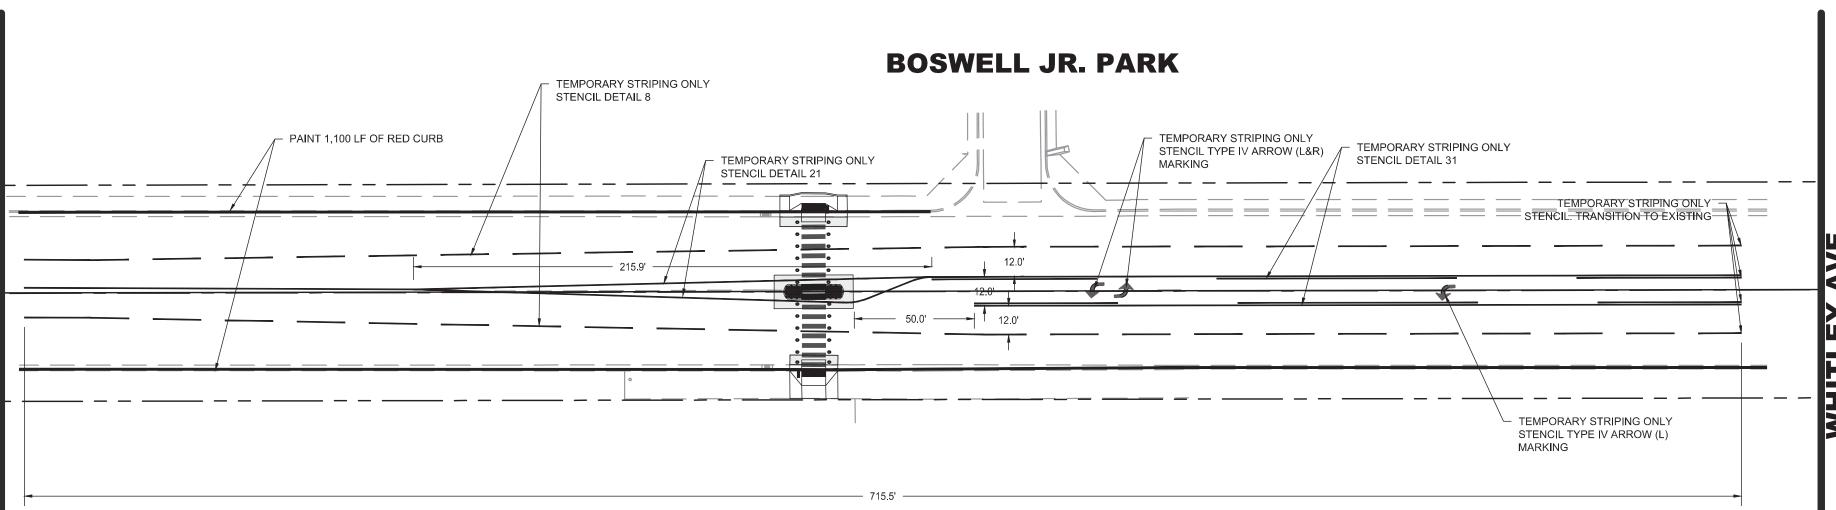

	LIGHTING ASSEMBLY MATERIAL LIST (FOR REFERENCE ONLY)		
CALLOUT	DESCRIPTION	UNIT	ESTIMATEI QUANTITY
A	IN-ROADWAY WARNING LIGHT (IRWL), LIGHTS 5 FEET OF SPACING, UNIDIRECTIONAL AMBER, 50 FEET LEAD, LEFT	EA	12
В	IN-ROADWAY WARNING LIGHT (IRWL), LIGHTS 5 FEET OF SPACING, UNIDIRECTIONAL AMBER, 50 FEET LEAD, RIGHT	EA	12
C	EPOXY FOR IN-ROADWAY WARNING LIGHT (IRWL) STUDS	EA	24
D	CONTROLLER, IRWL, 12V, PROSTAR (OR EQUIVALENT)	EA	1
E	120625, RADIO HOLLOW, RELAY-DRIVEN IRWL CONTROLLOER (OR EQUIVALENT)	EA	1
F	CABINET BRACKET SET, FITS ROUND POLES 2-3/8 & UP, WITH STANDARD HARDWARE & SNAP LOCKS FOR 120625. (OR EQUIVALENT)	EA	2
G	85W/12V SOLAR PANEL PACKAGE, TOP OF POLE MOUNT 4.5" DIAMETER.	EA	2
Н	BATTERY 35AH, 12V AGM LEAD ACID. (OR EQUIVALENT)	EA	3
	WIRE 2C 18AWG 16TC 2464 (OR EQUIVALENT)	FT	250
J	SPOOL 300V CM BRN/BLU	FT	1000
K	BLINKER	EA	3

- 1. IT IS THE RESPONSIBILITY OF THE CONTRACTOR TO PRESERVE ALL SURVEY MONUMENTS. ANY MONUMENT DISTURBED DURING CONSTRUCTION SHALL BE PERPETUATED PER THE PROFESSIONAL LAND SURVEYOR'S ACT, BUSINESS AND PROFESSIONS CODE 8771, AT THE CONTRACTORS EXPENSE.
- 2. LOCATIONS OF EXISTING UTILITIES ARE APPROXIMATED. CONTRACTOR TO FIELD VERIFY ALL EXISTING UTILITIES BEFORE COMMENCEMENT OF WORK

#### **SIDEWALK AND RAMP NOTES**

- 1. MAXIMUM SLOPES OF ADJOINING GUTTERS, THE ROAD SURFACE IMMEDIATELY ADJACENT TO THE CURB RAMP OR ACCESSIBLE ROUTE SHALL NOT EXCEED 5% WITHIN 4' OF THE BOTTOM OF THE CURB RAMP.
- 2. NO CROSS SLOPE IN THE PATH OF TRAVEL TO EXCEED 1.5%
- 3. SIDEWALKS AND RAMPS SHALL BE STEEL TOWELED AND HAVE A LIGHT BROOM FINISH UNLESS OTHERWISE NOTED. RAMPS SHALL HAVE A HEAVY BROOM FINISH ACROSS THE SLOPE OF THE RAMP.
- 4. SIDEWALKS AND RAMPS SHALL HAVE WEAKEN PLANE JOINTS CONSTRUCTED WHERE SHOWN IN THESE IMPROVEMENT PLANS. WEAKENED PLANE JOINTS SHALL BE A MINIMUM OF 1 INCH IN DEPTH AND SHALL BE FINISHED WITH A SCORING TOOL LEAVING THE EDGES ROUNDED.
- 5. SIDEWALKS AND RAMPS SHALL BE PLACED ON 6 INCH MOIST AND COMPACTED BASE MATERIALS. 90% RELATIVE COMPACTION UNDER SIDEWALKS. 95 PERCENT RELATIVE COMPACTION UNDER RAMPS AND SIDEWALKS.

#### **SIGNING, STRIPING & MARKINGS NOTES**


- 1. ALL WORK AND MATERIALS SHALL CONFORM TO CALTRANS STANDARD PLANS (2015 REVISED STANDARD PLAN RSP) AND THE CA 2014 MANUAL ON UNIFORM TRAFFIC CONTROL DEVICES FOR STREETS AND HIGHWAYS MUTCD (REVISION 3)
- ANY CONTRACTOR PERFORMING WORK ON THIS PROJECT SHALL FAMILIARIZE HIMSELF WITH THIS SITE AND SHALL BE SOLELY RESPONSIBLE FOR ANY DAMAGE TO EXISTING FACILITIES RESULTING DIRECTLY OR INDIRECTLY FROM HIS OPERATIONS, WHETHER OR NOT SUCH FACILITIES ARE SHOWN ON THESE PLANS.
- 4. FOR CROSSWALK DETAILS, PLEASE REFER TO THE DETAILS ON THIS SHEET.THE GAP BETWEEN THE LINES ON THE YELLOW SCHOOL CROSSWALK SHOULD BE 10 FEET WITH HIGH VISIBILITY 24" CONTINENTAL PATTERN AS SHOWN ON THE PLANS.
- 5. ALL EXISTING PAVEMENT STRIPING & MARKINGS ( CROSSWALKS, STOP BARS, STOP MARKING LEGENDS, CENTERLINE, ETC.) SHALL BE REPAINTED WHEN DISTURBED BY IMPROVEMENTS, UNLESS

## **GENERAL CONCRETE NOTES**


- 1. ALL CONCRETE SHALL BE CLASS 3 CONCRETE UNLESS OTHERWISE SPECIFIED.
- 2. CLASS 3 CONCRETE SHALL CONTAIN NOT LESS THAN 505 POUNDS OF PORTLAND CEMENT PER CUBIC YARD WITH 1 IN AGGREGATE. 5 INCH MAXIMUM SLUMP. 2500 P.S.I. AT 28 DAYS.
- 3. WHEN MAXIMUM DAYTIME TEMPERATURE EXCEEDS 50° F. ALL NEWLY PLACED CONCRETE SHALL BE SPRAYED UNIFORMLY WITH A CURING COMPOUND. CURING COMPOUND SHALL BE APPLIED AT A NOMINAL RATE OF ONE GALLON PER 150 SQUARE FEET, UNLESS OTHERWISE SPECIFIED.
- 4. ALL WORK CONSTRUCTED BY THESE PLANS SHALL BE IN COMPLIANCE WITH ALL CURRENT ADA REGULATIONS.

#### **CONSTRUCTION NOTES**

- (1.) INSTALL TAPCO FLASHING SOLAR LED SIGN (SN: J-528763-1601), (SKU: C-DBB-1ABFPBWNNAA) WITH POST, SEE SHEET 42 FOR DETAILS
- 2. INSTALL 3' DEEP BY 10 WIDE DETECTABLE WARNING SURFACE (RAISED TRUNCATED DOMES)
- (3.) CONSTRUCT NEW ACCESSIBLE RAMP PER CITY STANDARDS AND AS SHOWN
- (4.) CONSTRUCT PAVEMENT PATCH PER DETAIL 1 ON SHEET 42
- $^{\prime}$  5.  $^{\prime}$  INSTALL 4" THICK STAMPED CONCRETE SURFACE WITH "BRICK" PATTERN. COLOR SHALL BE "BRICK RED". A LIQUID RELEASE AGENT SHALL BE USED. A CURE AND SEAL PRODUCT SHALL BE APPLIED IN ACCORDANCE WITH THE MANUFACTURER'S RECOMMENDATIONS IMMEDIATELY AFTER COMPLETING THE IMPRINTING PROCESS. GRADE TO ACCOMMODATE DRAINAGE (2% MIN.) STAMPED CONCRETE SHALL BE PLACED ON 12" AGGREGATE BASE AT 95% RELATIVE COMPACTION.
- ( 6. ) INSTALL WEAKENED PLANE JOINT.
- 7. ) INSTALL SOLAR LED IN-ROAD WARNING LIGHTS PER MANUFACTURER'S RECOMMENDATIONS.
- 8. THE TOP FACE OF THE CURB SHALL BE PAINTED WITH YELLOW WATERBORNE PAINT AND APPLY GLASS BEADS FOR
- RETROFLECTIVITY IN ACCORDANCE TO CALTRANS STANDARD SPECIFICATIONS (9.) INSTALL WEAKENED PLANE JOINT AROUND RAMP PERIMETER TYPICAL.
- 10.) HEAVY BROOM FINISH ACROSS SLOPE OF RAMPS TYPICAL.
- 11.) PROTECT IN PLACE DRAIN INLET (DI)
- 12.) ALIGN IRWL AT A POINT OF CONVERGENCE OF 200' RELATIVE TO EACH LANE FOR EACH TRAVEL LANE DIRECTION (CONTRACTOR TO VERIFY LOCATION WITH DESIGN ENGINEER BEFORE PROCEEDING)

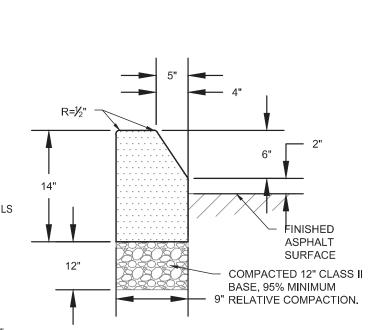

#### **DETAIL 1 - BULB-OUT CURB** N.T.S.

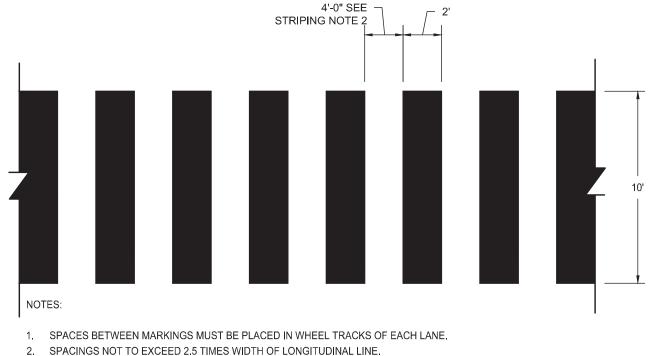


3. ALL CROSSWALK MARKINGS MUST BE WHITE EXCEPT THOSE NEAR SCHOOLS MUST BE YELLOW AS SHOWN ON PLANS.

## HIGH VISIBILITY CROSSWALK CONTINENTAL


**DETAIL** (N.T.S.)

SIDEWALK


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### **TYPICAL 85W SOLAR PANEL** (N.T.S.)

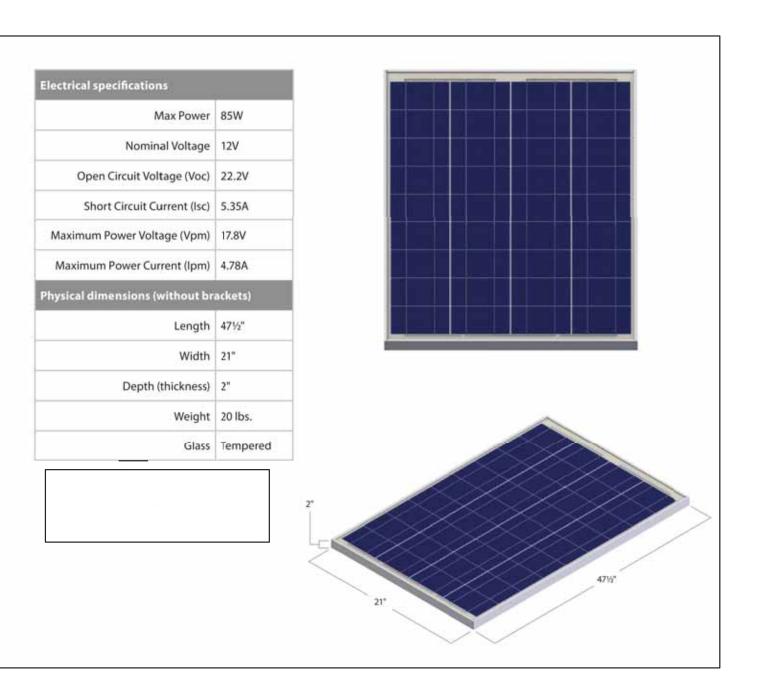


**TYPICAL SOLAR BACK PANEL LAYOUT** (N.T.S.)

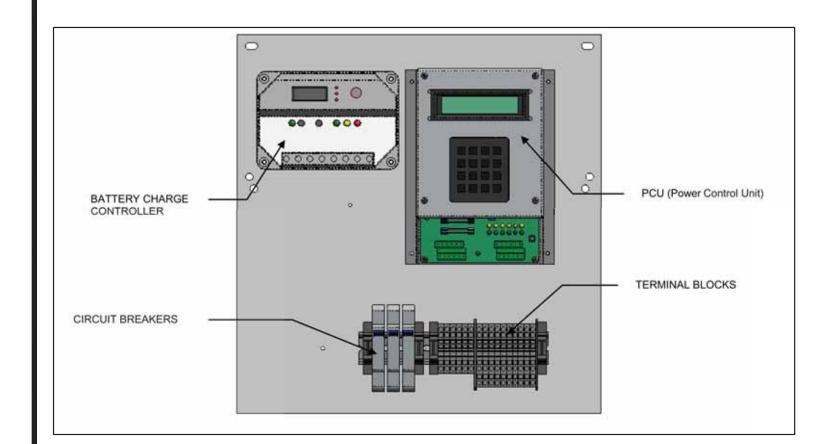


**TYPICAL SOLAR ENCLOSURE** (N.T.S.)

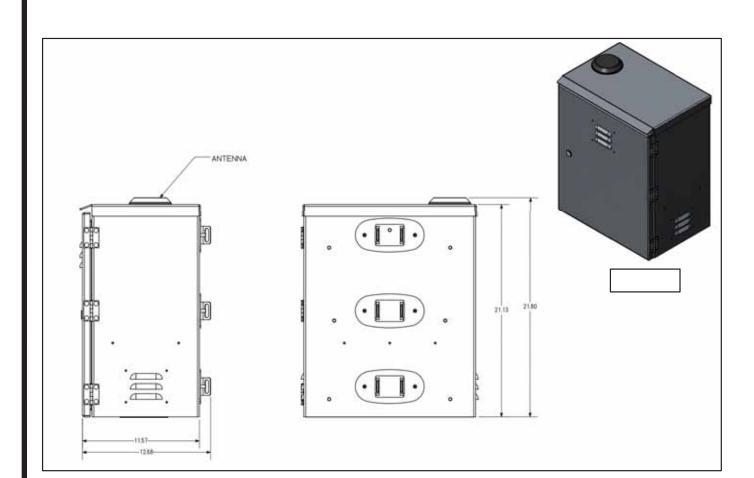

- 1. 18 AMG FOR SIGNS & PUSH BUTTONS
- 2. 14 AMG FOR IN-ROAD WARNING LIGHTS (IRWL)
- 3. 8 CONDUCTOR CABLE FOR PUSH BUTTONS 4. NOTE "LOOP BACK" FOR IRWL CONNECTIONS

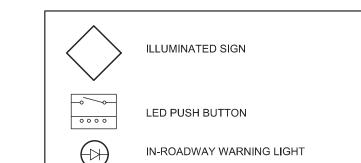

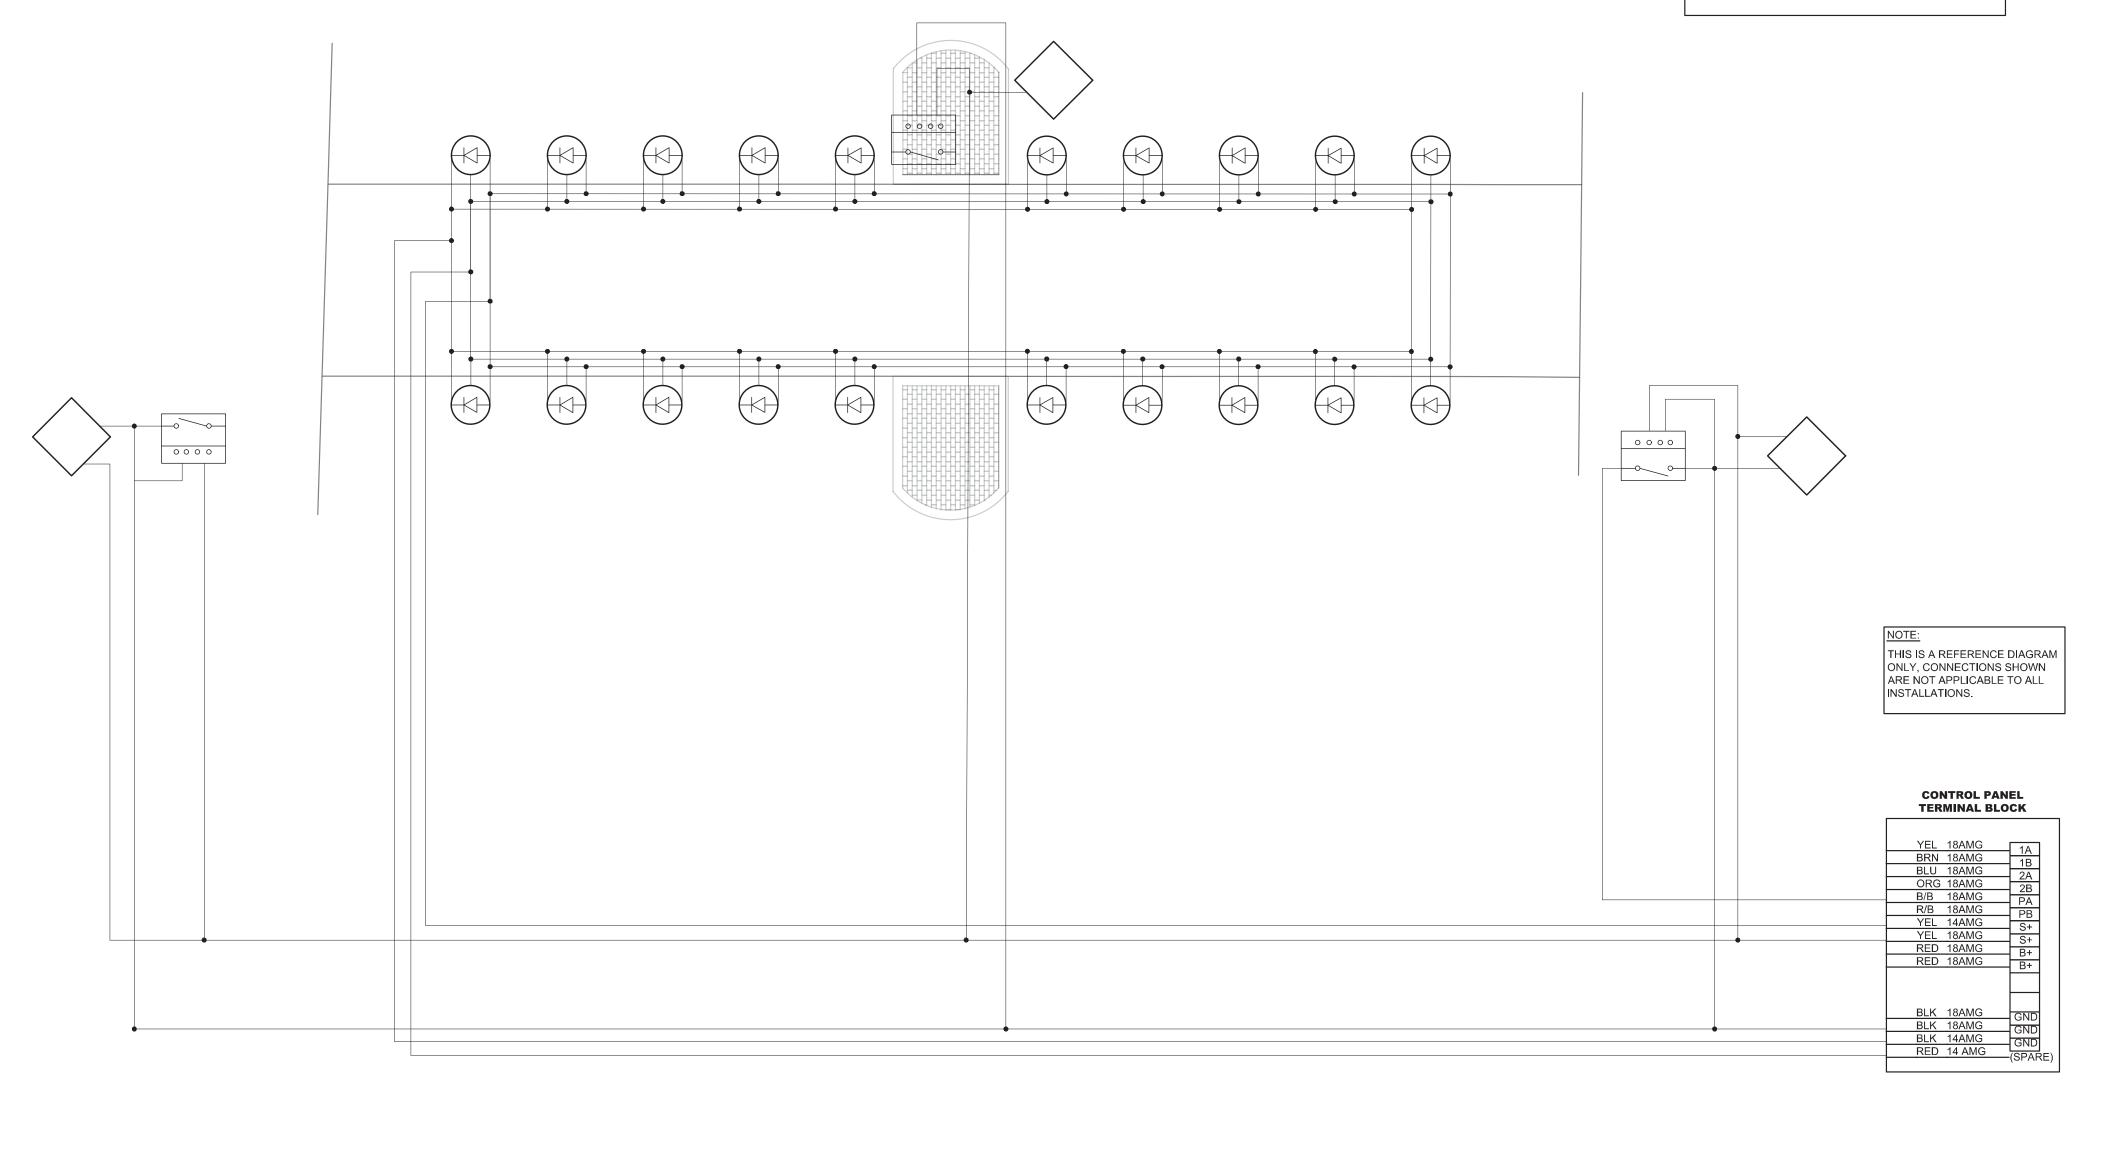


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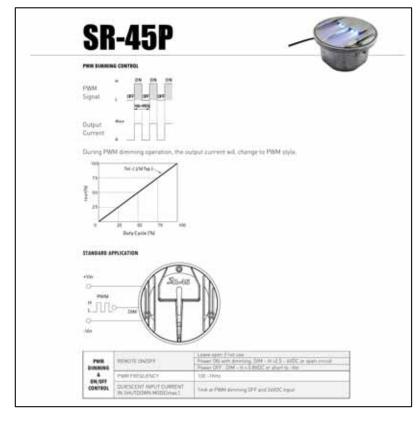
# DETAIL 1 PAVEMENT SECTION PATCH (N.T.S.)


	LIGHTING ASSEMBLY MATERIAL LIST (FOR REFERENCE ONLY)		
CALLOUT	DESCRIPTION	UNIT	ESTIMATED QUANTITY
A	IN-ROADWAY WARNING LIGHT (IRWL), 5FT OF SPACING, UNIDIRECTIONAL AMBER, 50 FEET LEAD, LEFT	EA	12
В	IN-ROADWAY WARNING LIGHT (IRWL), 5 FEET OF SPACING, UNIDIRECTIONAL AMBER, 50 FEET LEAD, RIGHT	EA	12
C	EPOXY FOR IN-ROADWAY WARNING LIGHT (IRWL) STUDS	EA	20
D	CONTROLLER, IRWL, 12V, PROSTAR (OR EQUIVALENT)	EA	1
E	120625, RADIO HOLLOW, RELAY-DRIVEN IRWL CONTROLLOER (OR EQUIVALENT)	EA	1
F	CABINET BRACKET SET, FITS ROUND POLES 2-3/8 & UP, WITH STANDARD HARDWARE & SNAP LOCKS FOR 120625. (OR EQUIVALENT)	EA	2
G	85W/12V SOLAR PANEL PACKAGE, TOP OF POLE MOUNT 4.5" DIAMETER.	EA	2
Н	BATTERY 35AH, 12V AGM LEAD ACID. (OR EQUIVALENT)	EA	3
	WIRE 2C 18AWG 16TC 2464 (OR EQUIVALENT)	FT	250
J	SPOOL 300V CM BRN/BLU	FT	1000
K	BLINKER	EA	3



PROPOSED SOLAR FLASHING SIGN W/ CONTROLLER
BOX INSTALLATION LAYOUT (PROFILE VIEW)
(N.T.S.)

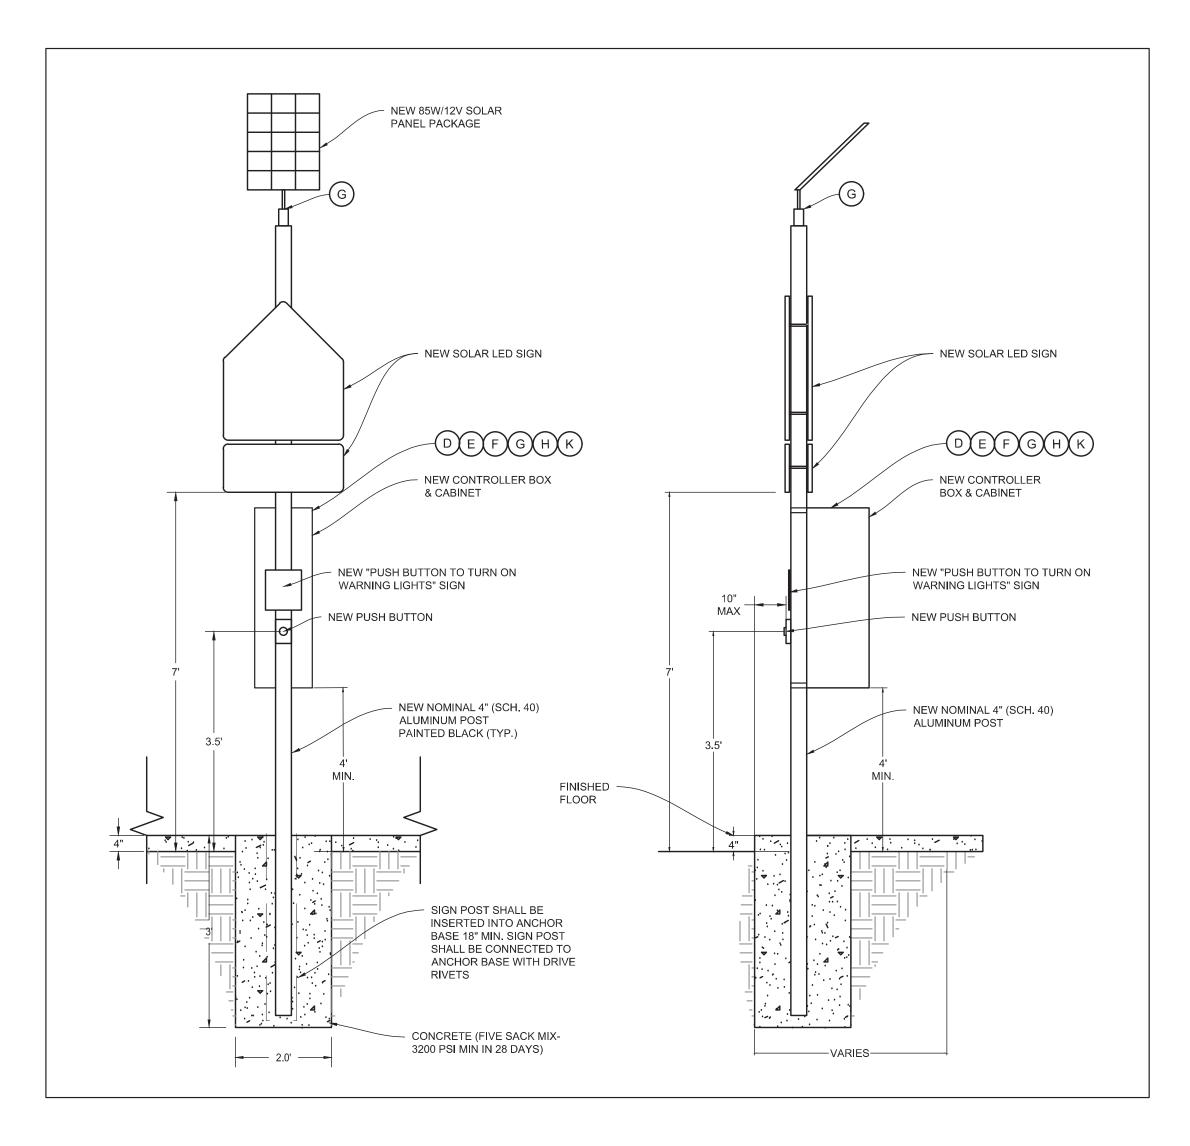



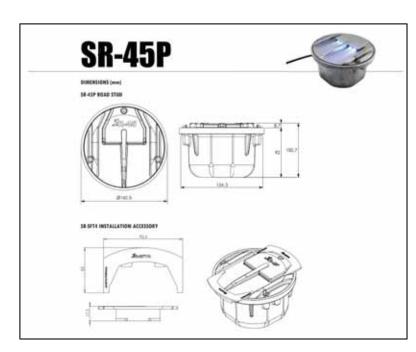









Know what's **below.**Call 811 before you dig.

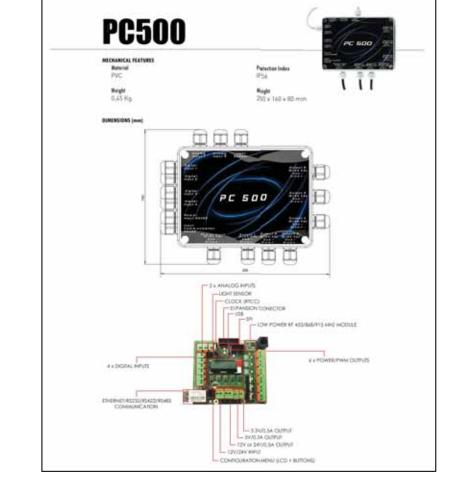

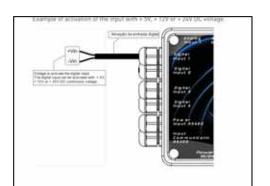

GENERAL PROGRAMMABLE CONTROLLER DETAILS
(N.T.S.)



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OF 61



- 1. IT IS THE RESPONSIBILITY OF THE CONTRACTOR TO PRESERVE ALL SURVEY MONUMENTS. ANY MONUMENT DISTURBED DURING CONSTRUCTION SHALL BE PERPETUATED PER THE PROFESSIONAL LAND SURVEYOR'S ACT, BUSINESS AND PROFESSIONS CODE 8771, AT THE CONTRACTORS EXPENSE.
- 2. LOCATIONS OF EXISTING UTILITIES ARE APPROXIMATED. CONTRACTOR TO FIELD VERIFY ALL EXISTING UTILITIES BEFORE COMMENCEMENT OF WORK.

#### **DEMOLITION NOTES**

- 1. SAWCUT EXISTING CONCRETE TO A NEAT CLEAN EDGE LINE
- $\langle$  2. angle SAWCUT EXISTING PAVEMENT TO A NEAT CLEAN EDGE LINE
- $\langle$  3.  $\rangle$  EXISTING STRIPING OR MARKING TO BE PROTECTED IN PLACE
- $\langle$  4.  $\rangle$  EXISTING STRIPING OR MARKING TO BE REMOVED BY SANDING OR WATER BLASTING
- 5. REMOVE AND PRESERVE EXISTING STREET SIGN






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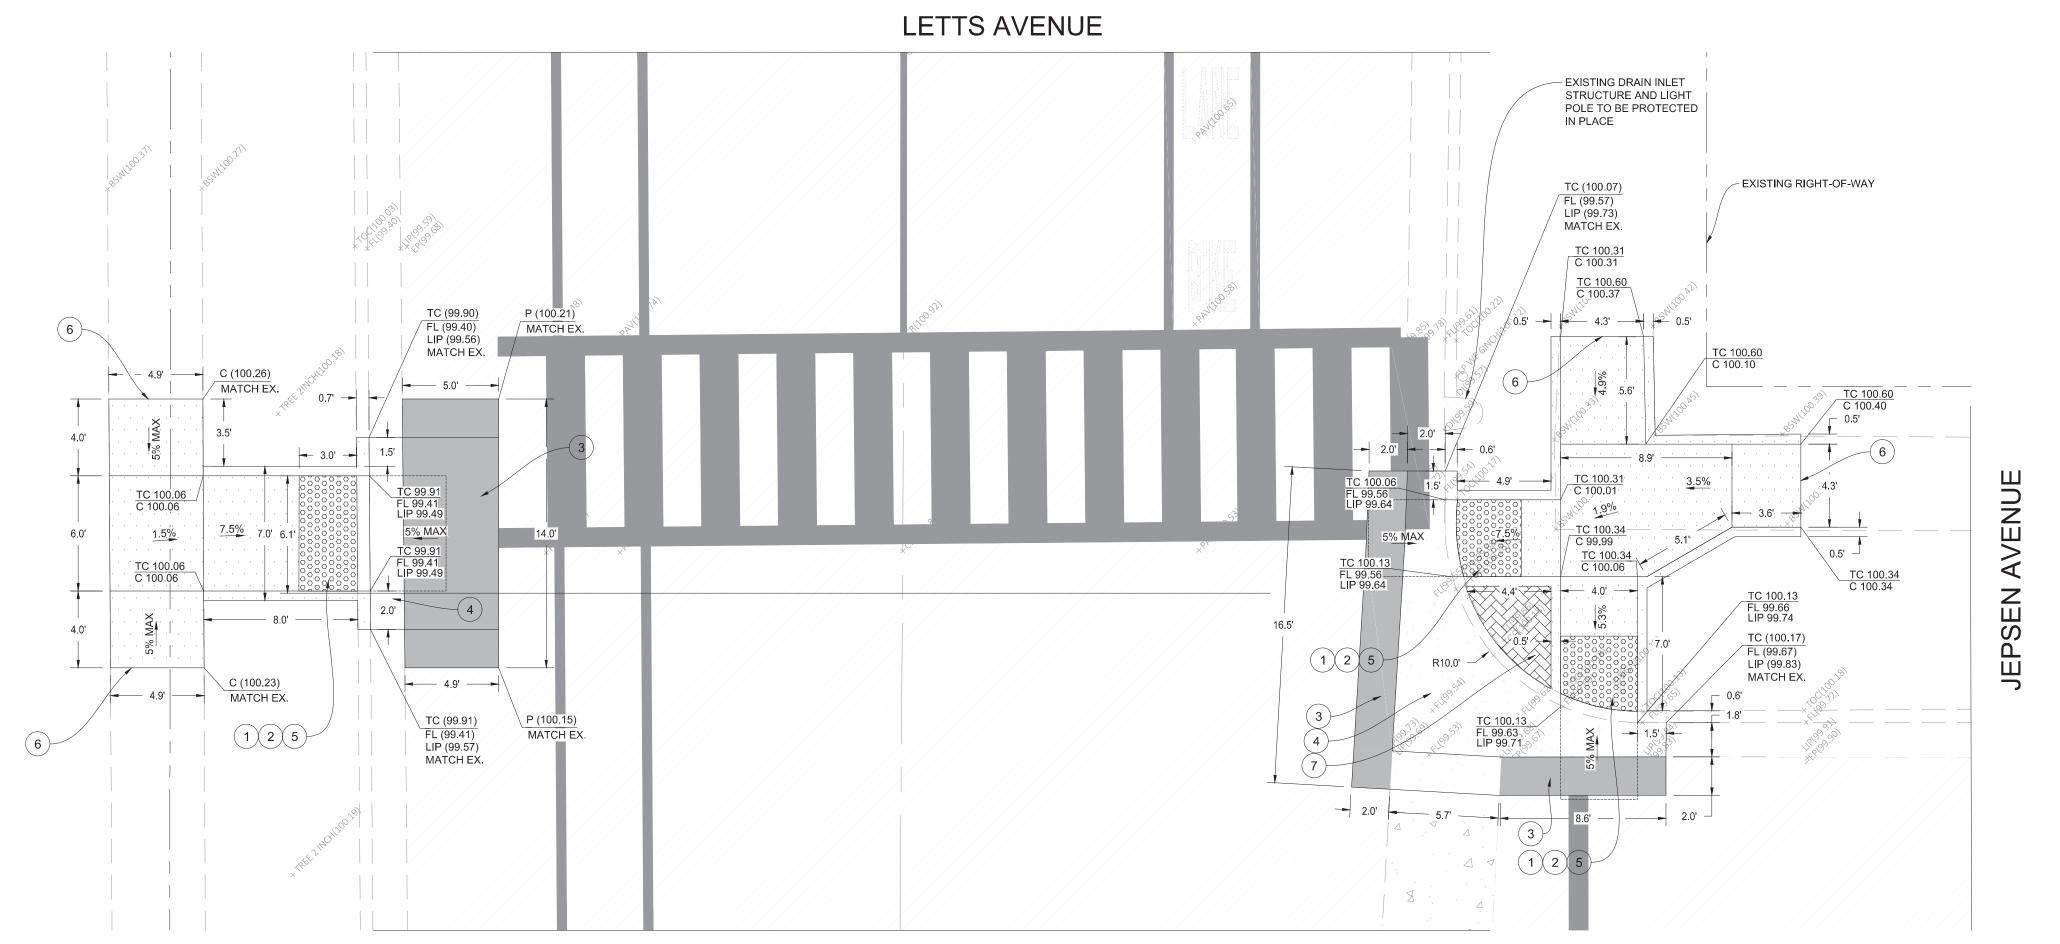
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## **DEMOLITION PLAN**



LETTS AVENUE

**IMPROVEMENT PLAN** 

#### **CONSTRUCTION NOTES**

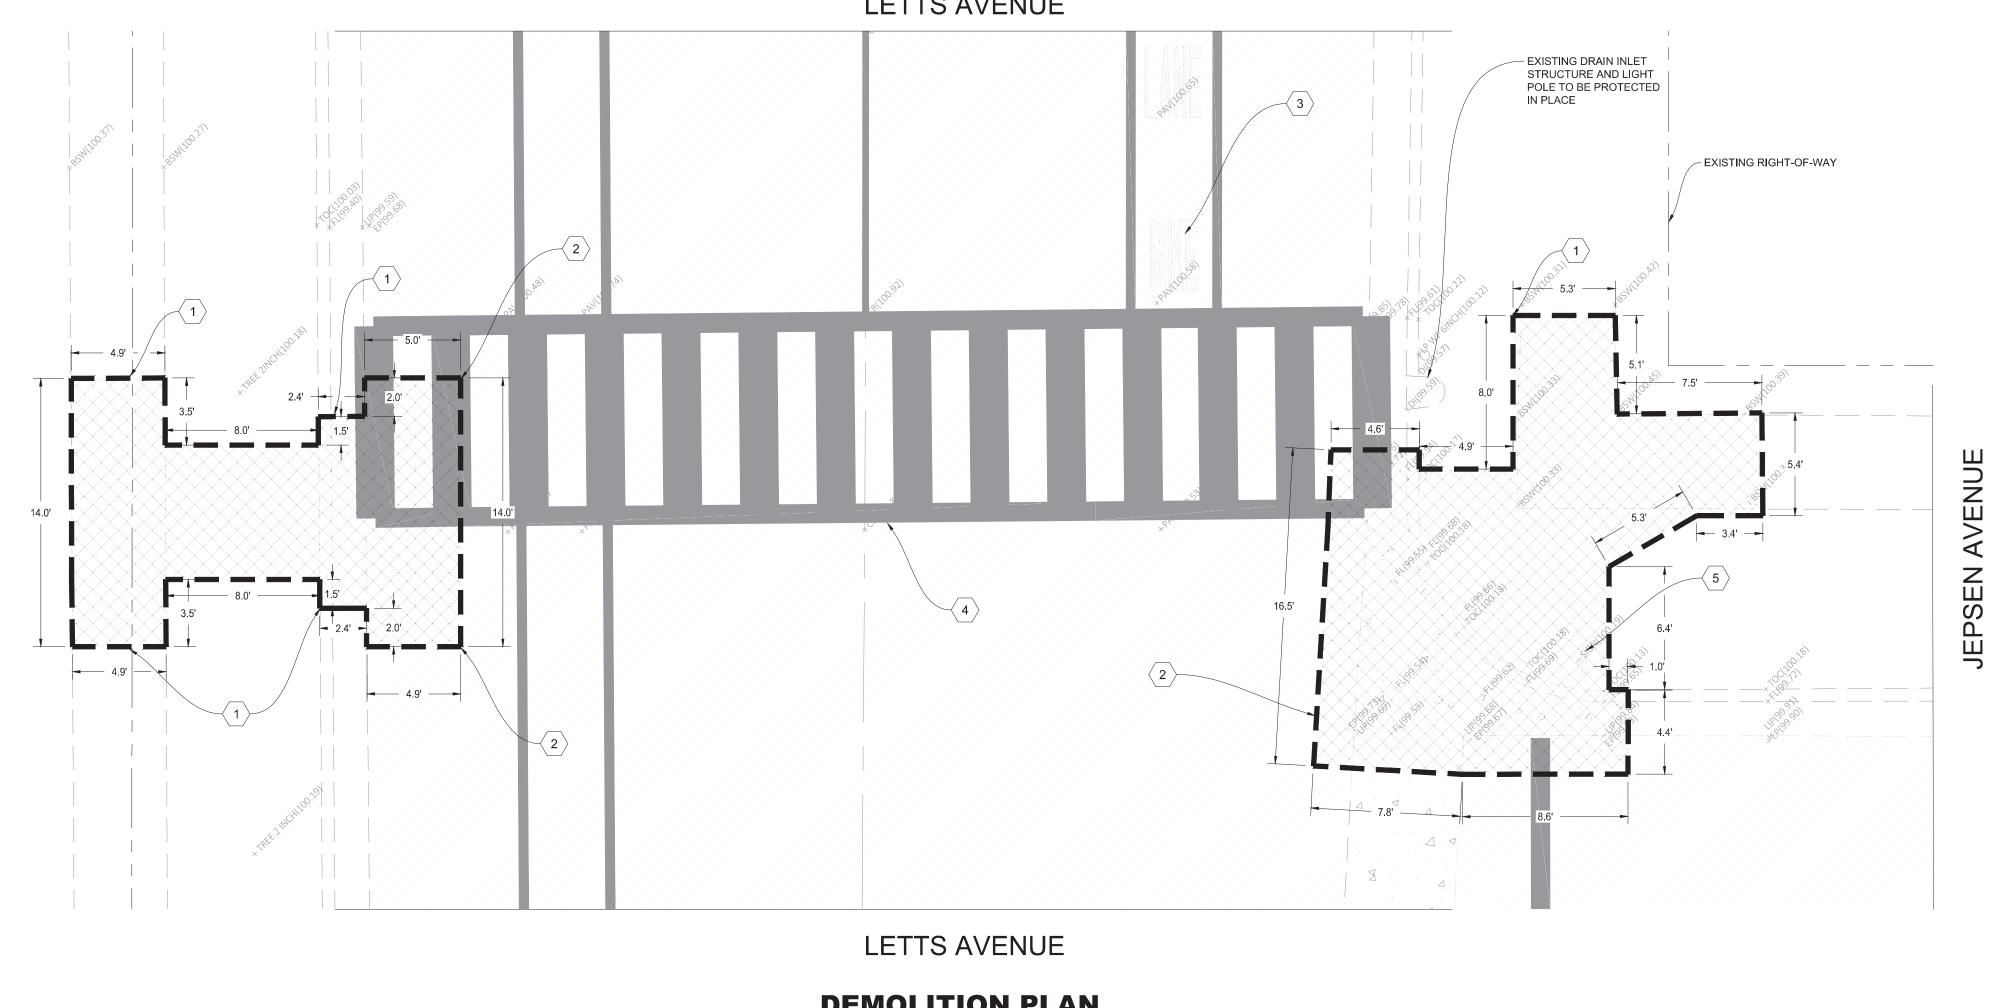- (1.) INSTALL DETECTABLE WARNING SURFACE (RAISED TRUNCATED DOMES) 3' DEEP AND EXTENDING THE FULL WIDTH OF THE RAMP
- 2.) CONSTRUCT NEW ACCESSIBLE RAMP AS SHOWN AND PER CITY STANDARD DETAIL C-6, SEE SHEET 61
- (3.) CONSTRUCT PAVEMENT PATCH PER DETAIL 01, SEE SHEET 59
- (4.) CONSTRUCT CONCRETE CURB AND GUTTER PER DETAIL 10, SEE SHEET 59
- (5.) HEAVY BROOM FINISH ACROSS SLOPE OF RAMPS (TYPICAL)
- (6.) INSTALL WEAKENED PLANE JOINT AROUND RAMP PERIMETER (TYPICAL)
- (7.) INSTALL 4" THICK STAMPED CONCRETE SURFACE WITH "BRICK" PATTERN. COLOR SHALL BE "BRICK RED". A LIQUID RELEASE AGENT SHALL BE USED. A CURE AND SEAL PRODUCT SHALL BE APPLIED IN ACCORDANCE WITH THE MANUFACTURER'S RECOMMENDATIONS IMMEDIATELY AFTER COMPLETING THE IMPRINTING PROCESS. GRADE TO ACCOMMODATE DRAINAGE (2% MIN). STAMPED CONCRETE SHALL BE PLACED ON 6" MOIST AND COMPACTED NATIVE SOIL TO 90% RELATIVE COMPACTION.




#### **CONTRACTOR NOTES**

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- 2. LOCATIONS OF EXISTING UTILITIES ARE APPROXIMATED. CONTRACTOR TO FIELD VERIFY ALL EXISTING UTILITIES BEFORE COMMENCEMENT OF WORK.

#### **SIGNING & STRIPING NOTES**

- 1. PAINT 12" WIDE SOLID YELLOW STANDARD CROSSWALK MARKING, PER PER CITY STANDARD DETAIL ST-10, SEE SHEET 60
- 2. PAINT 12" WIDE SOLID YELLOW LADDER CROSSWALK MARKING, INSIDE LINES TO BE 24" WIDE AND SPACED TO AVOID WHEEL PATH
- 3. PAINT DETAIL 39 (WHITE BIKE LANE), SEE SHEET 58
- 4. PAINT DETAIL 1 (YELLOW CENTERLINE), SEE SHEET 58
- 5. PAINT BIKE LANE LEGEND WITH ARROW

6. REINSTALL EXISTING STREET SIGN AND POLE

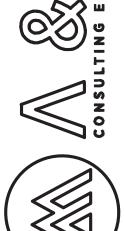

CORAN SIDEWALK IMPROVMENTS

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- (2.) SAWCUT EXISTING PAVEMENT TO A NEAT CLEAN EDGE LINE
- (3.) EXISTING STRIPING OR MARKING TO BE REMOVED BY SANDING OR WATER BLASTING
- 4. REMOVE AND PRESERVE EXISTING STREET SIGN









SIDEWALK IMPROVMENTS COR







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- 1.) INSTALL DETECTABLE WARNING SURFACE (RAISED TRUNCATED DOMES) AS SHOWN AND EXTENDING THE FULL WIDTH OF EACH PASSAGEWAY
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- 6.) INSTALL WEAKENED PLANE JOINT AROUND RAMP PERIMETER (TYPICAL)
- 7. EXISTING STREET SIGN TO BE PROTECTED IN PLACE
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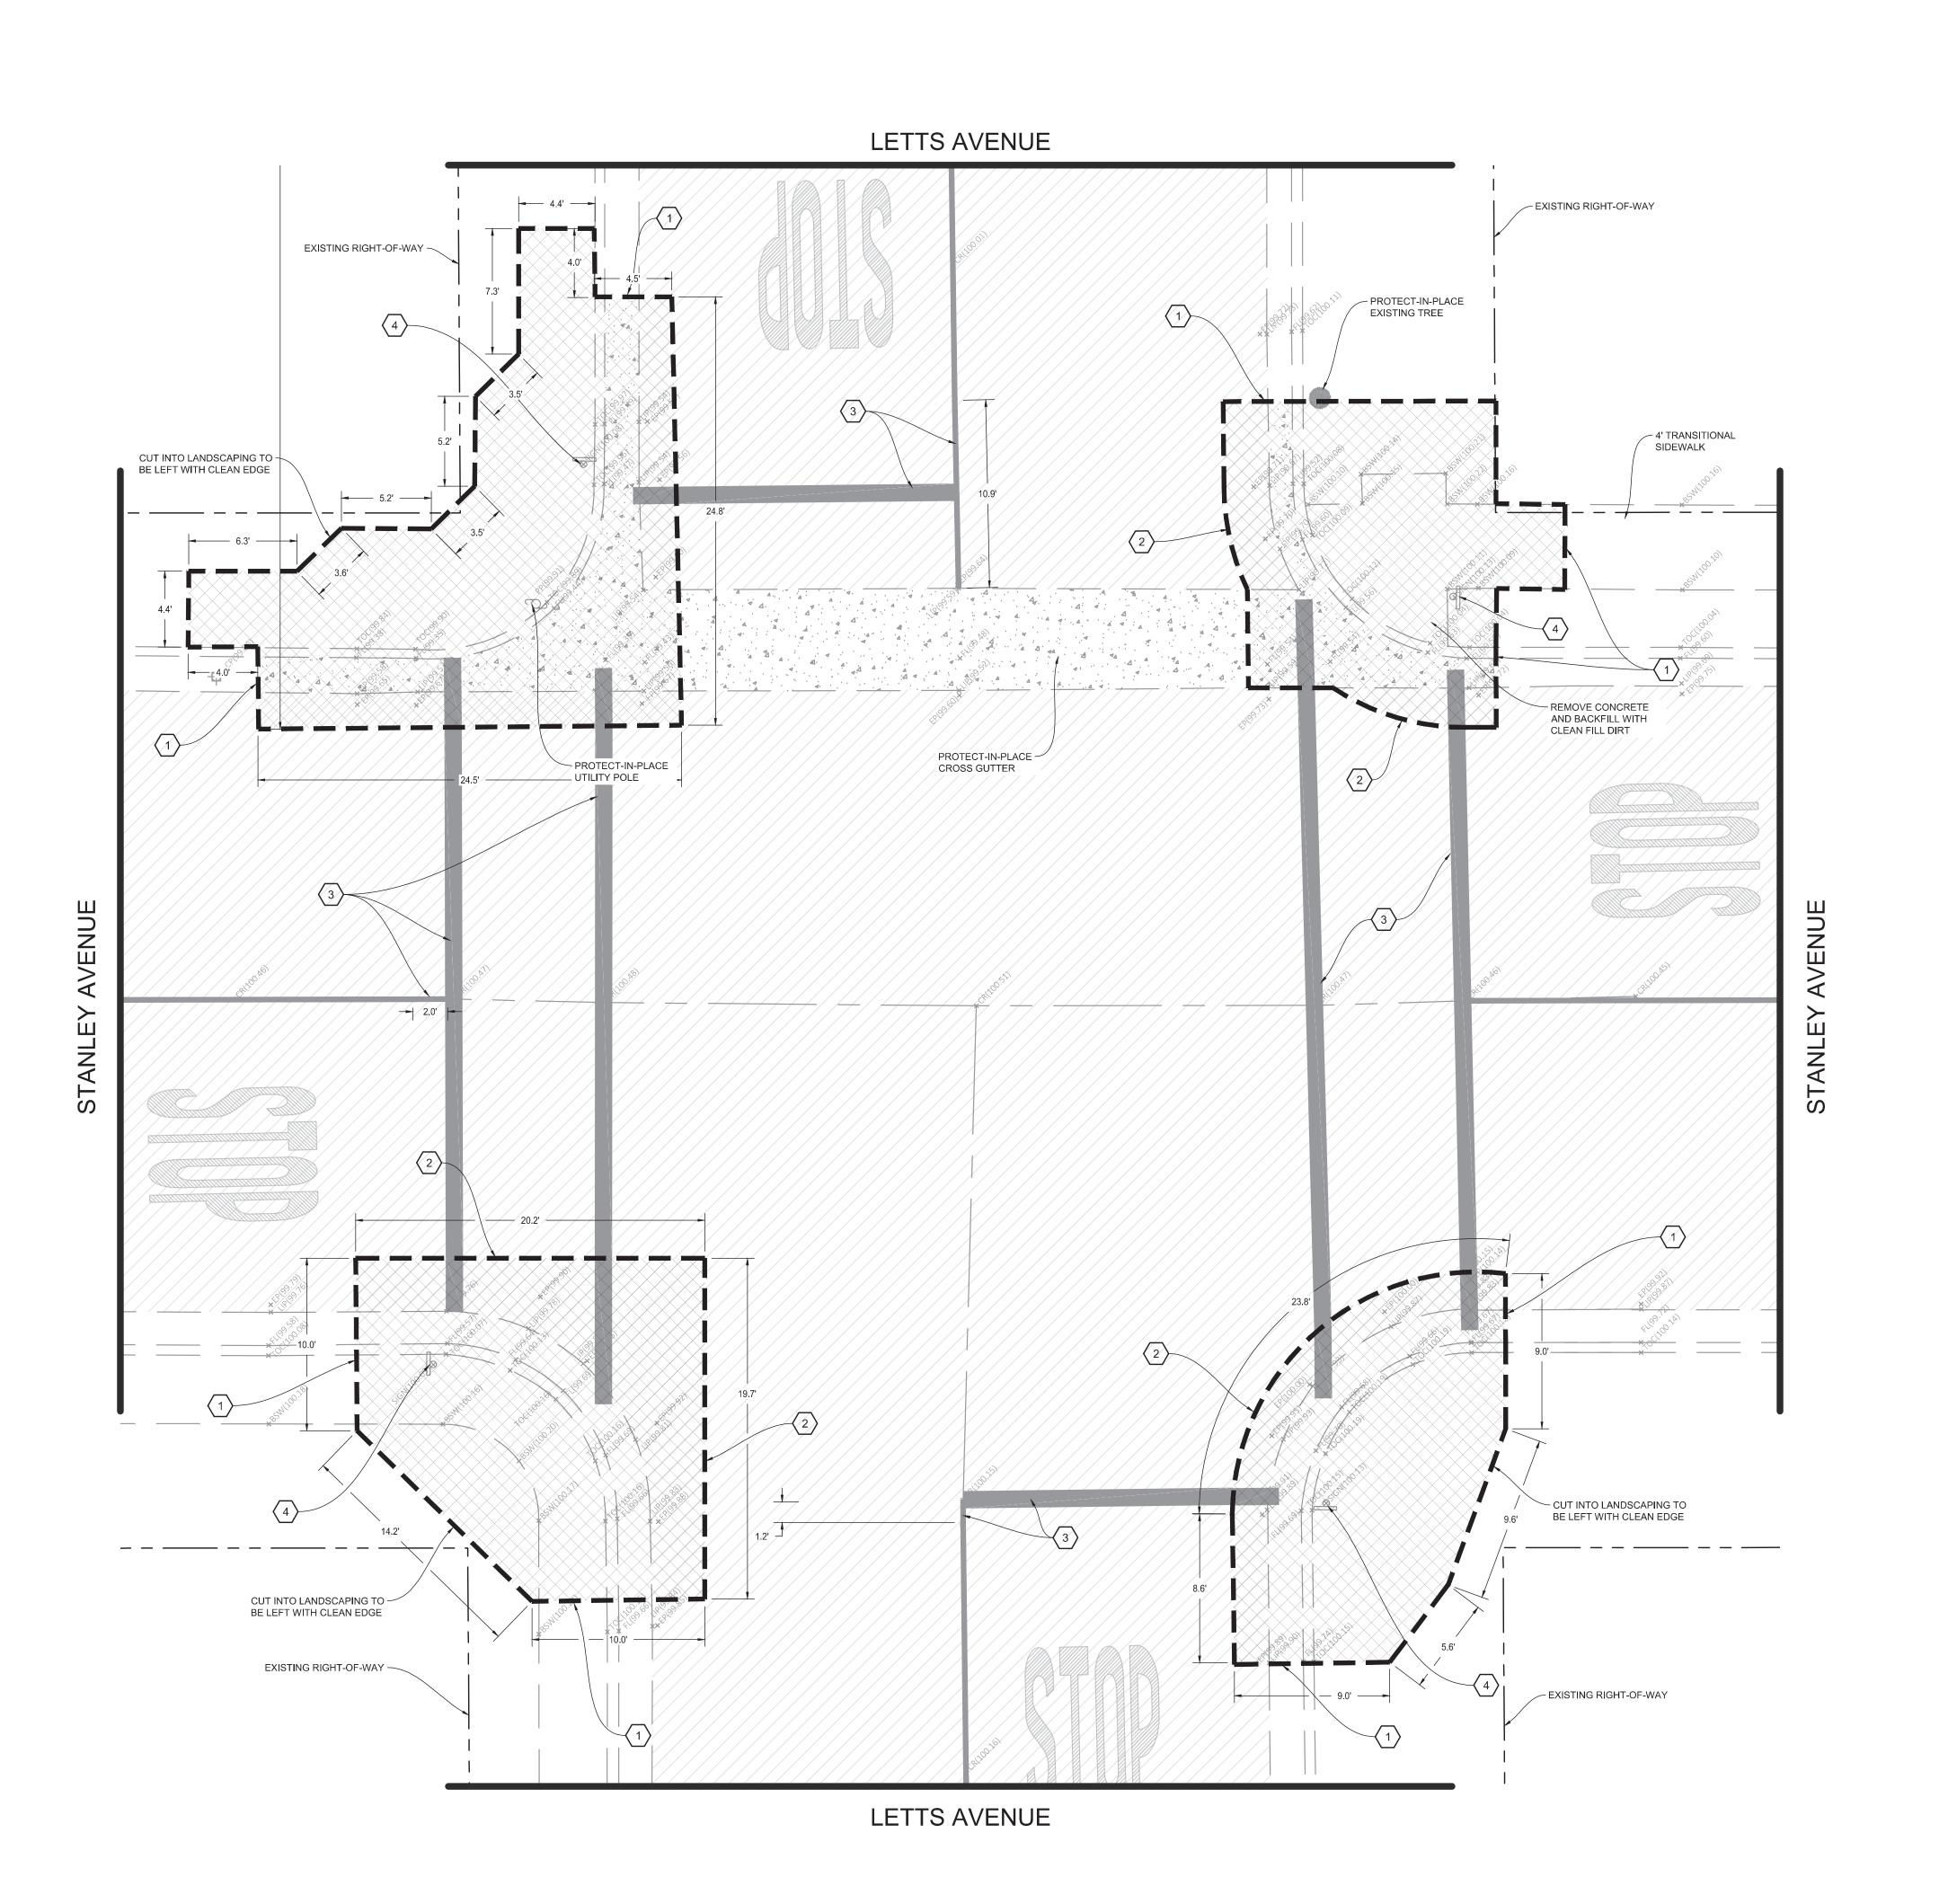
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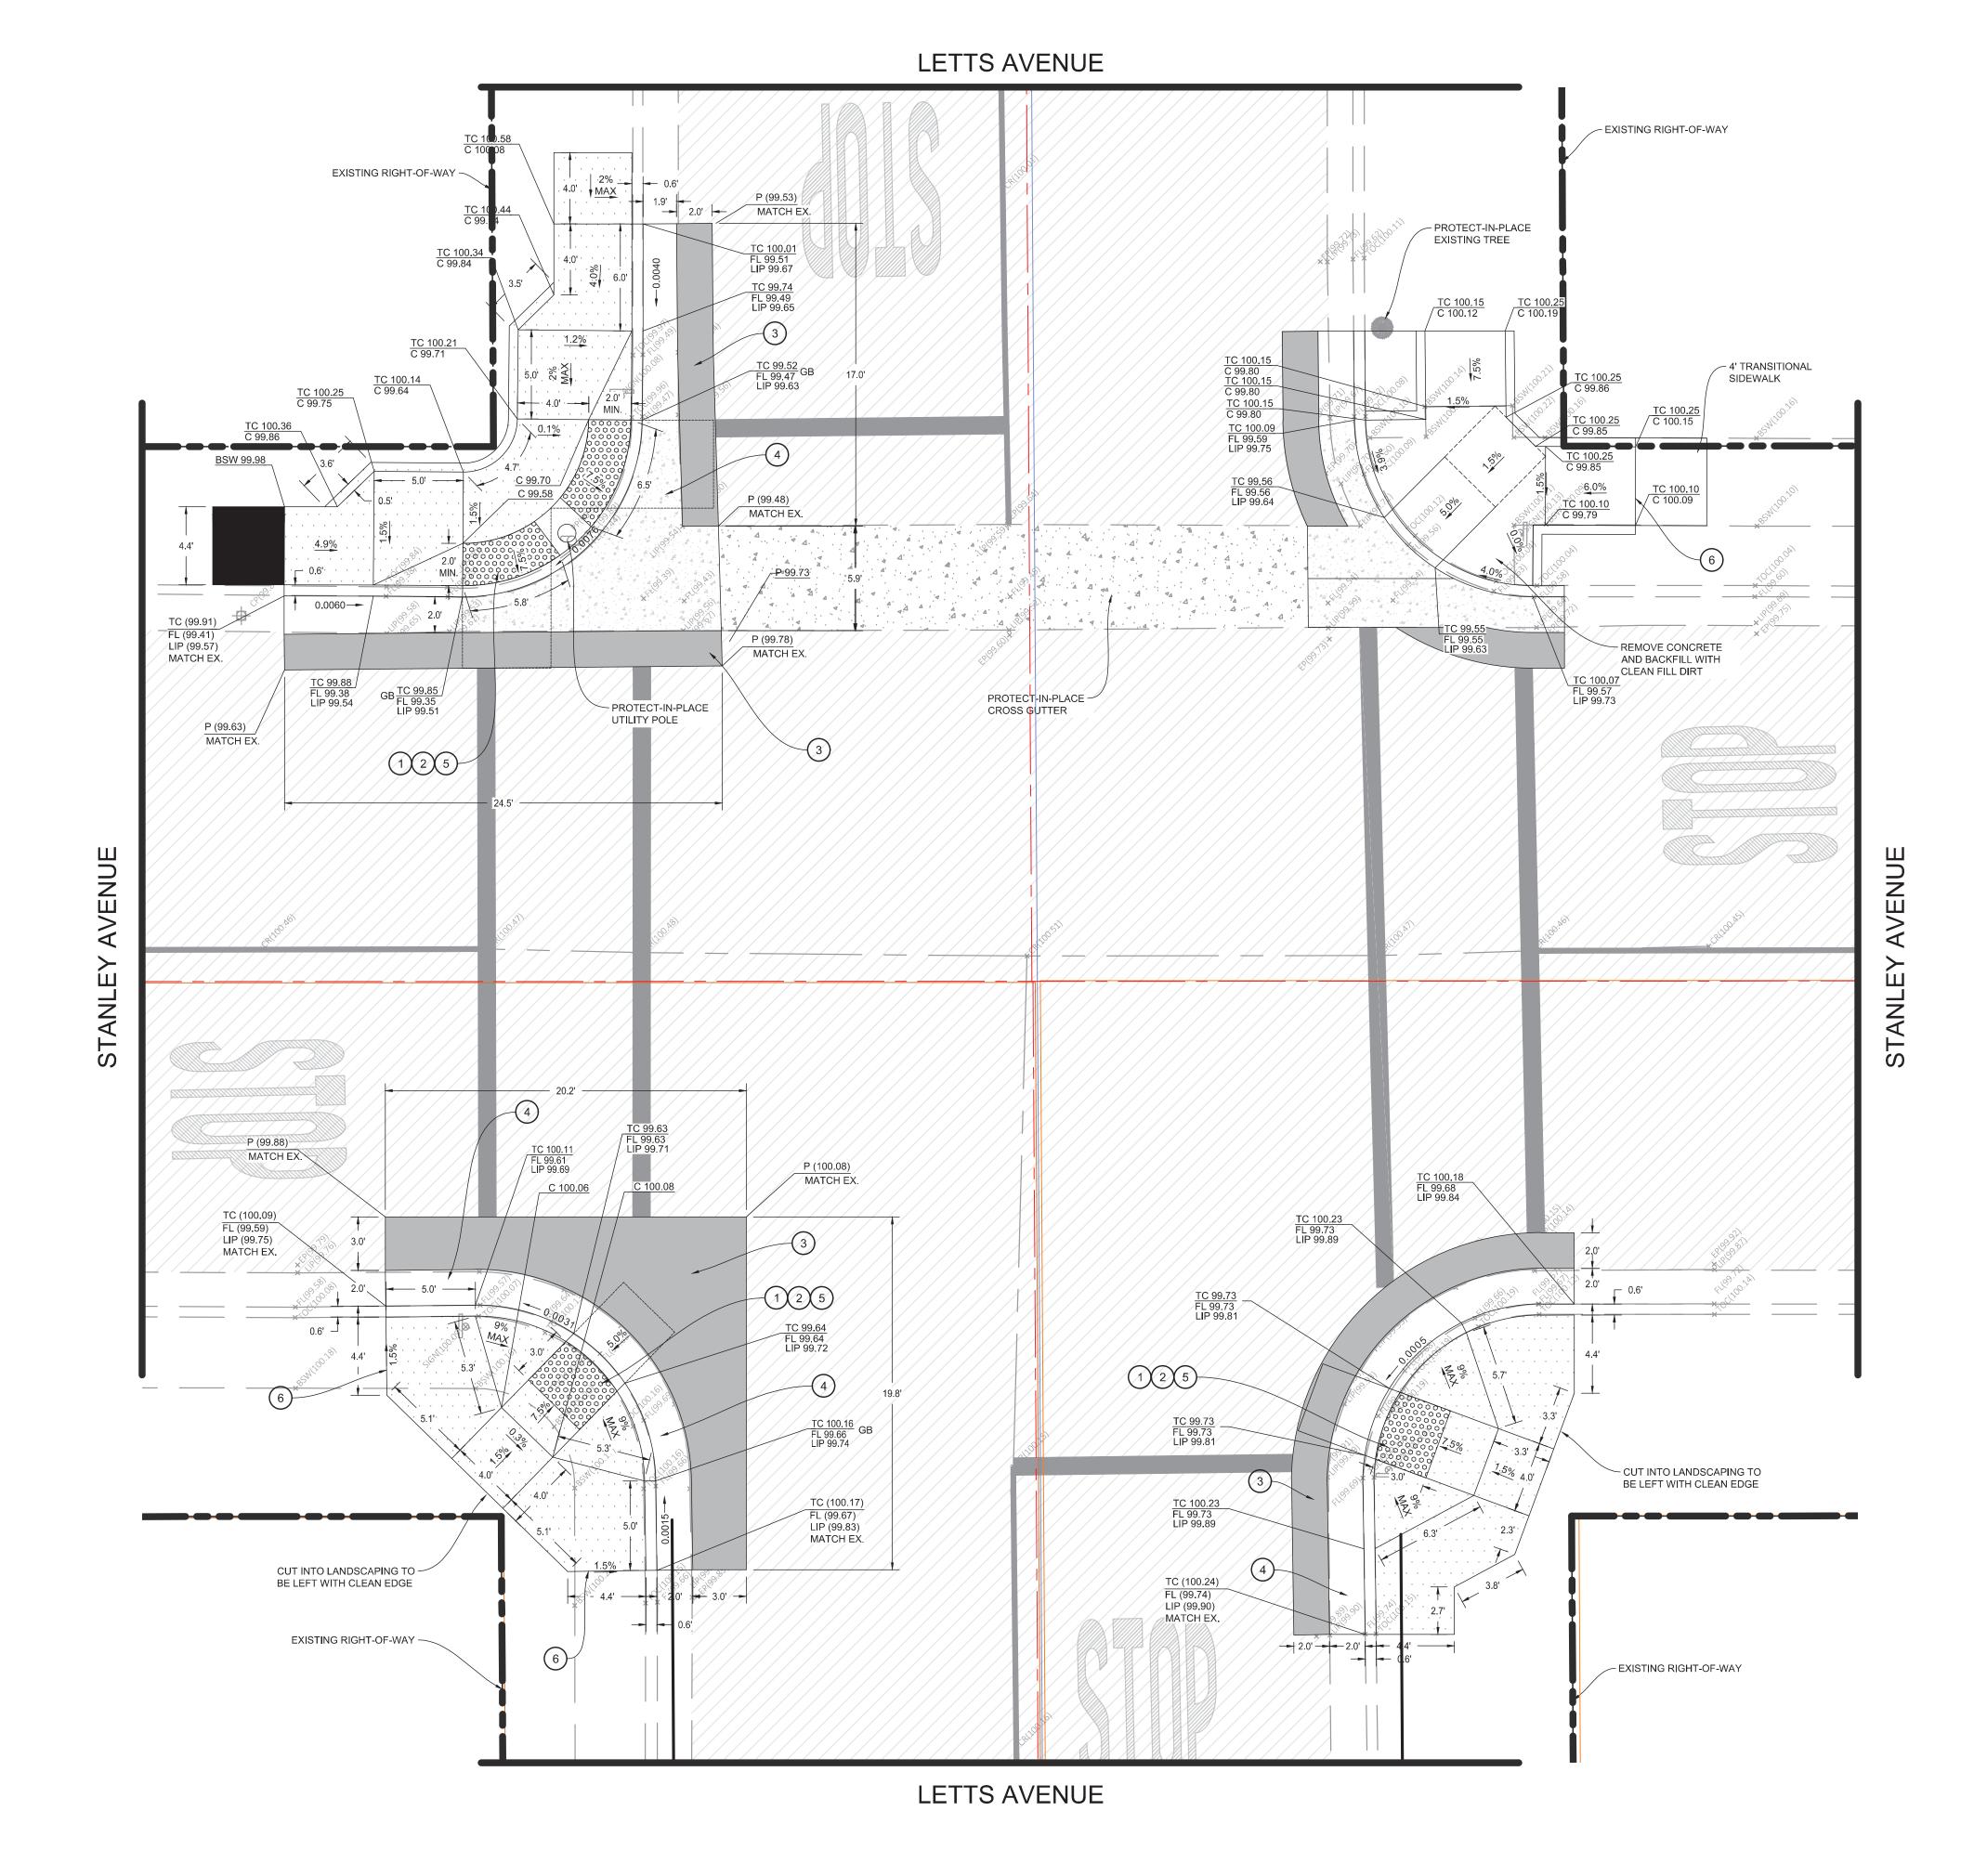
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- 6.) INSTALL WEAKENED PLANE JOINT AROUND RAMP PERIMETER (TYPICAL)



**IMPROVMENTS** SIDEWALK COR OF







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#### **SIGNING & STRIPING NOTES**

- 1. PAINT 12" WIDE SOLID WHITE STANDARD CROSSWALK MARKING, PER PER CITY STANDARD DETAIL ST-10, SEE SHEET 60
- 2. PAINT DETAIL 1 (YELLOW CENTERLINE), SEE SHEET 58
- 3. REINSTALL EXISTING STREET SIGN AND POLE







CORAN SIDEWALK IMPROVMENTS COR OF



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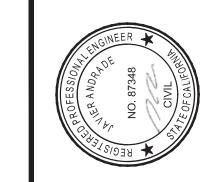
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3. EXISTING STRIPING OR MARKING TO BE REMOVED BY SANDING OR WATER BLASTING

4. REMOVE AND PRESERVE EXISTING STREET SIGN

5. PROTECT EXISTING CURB AND GUTTER





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CORCORAN SIDEWALK IMPROVMENTS

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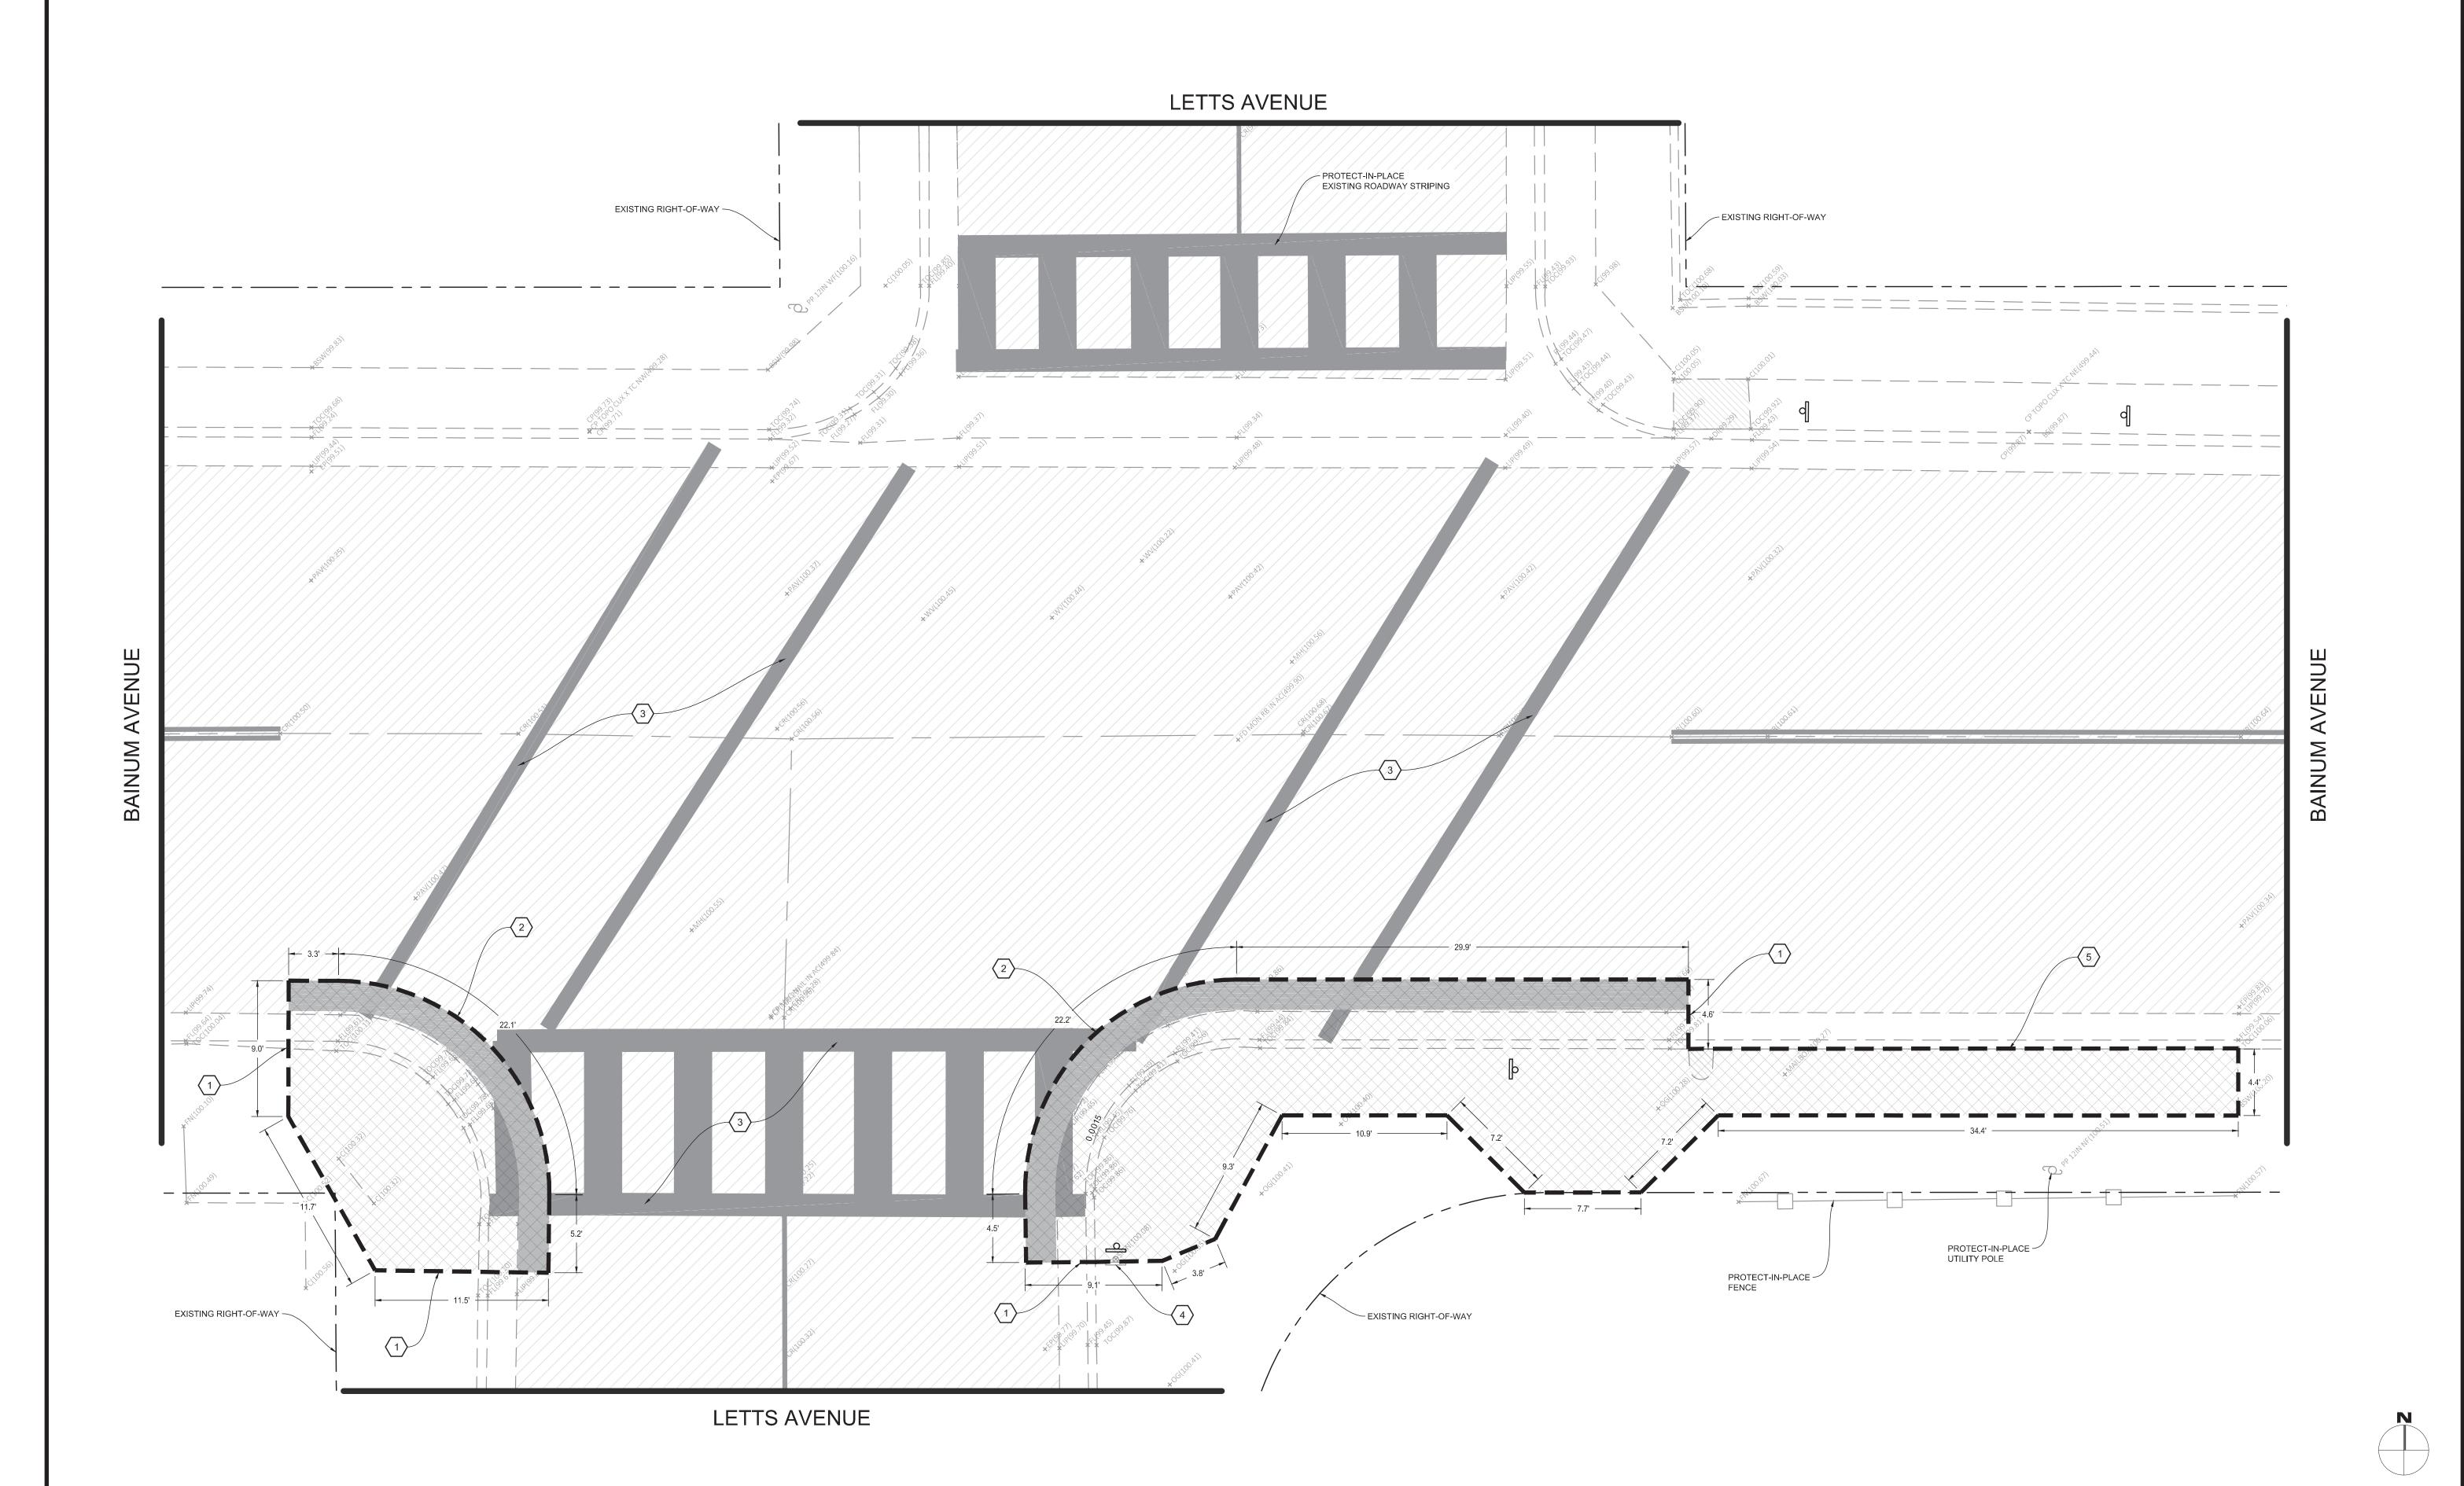
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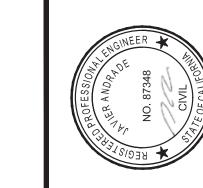


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GINEERING PLANS FOR:

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SHEET TITLE:

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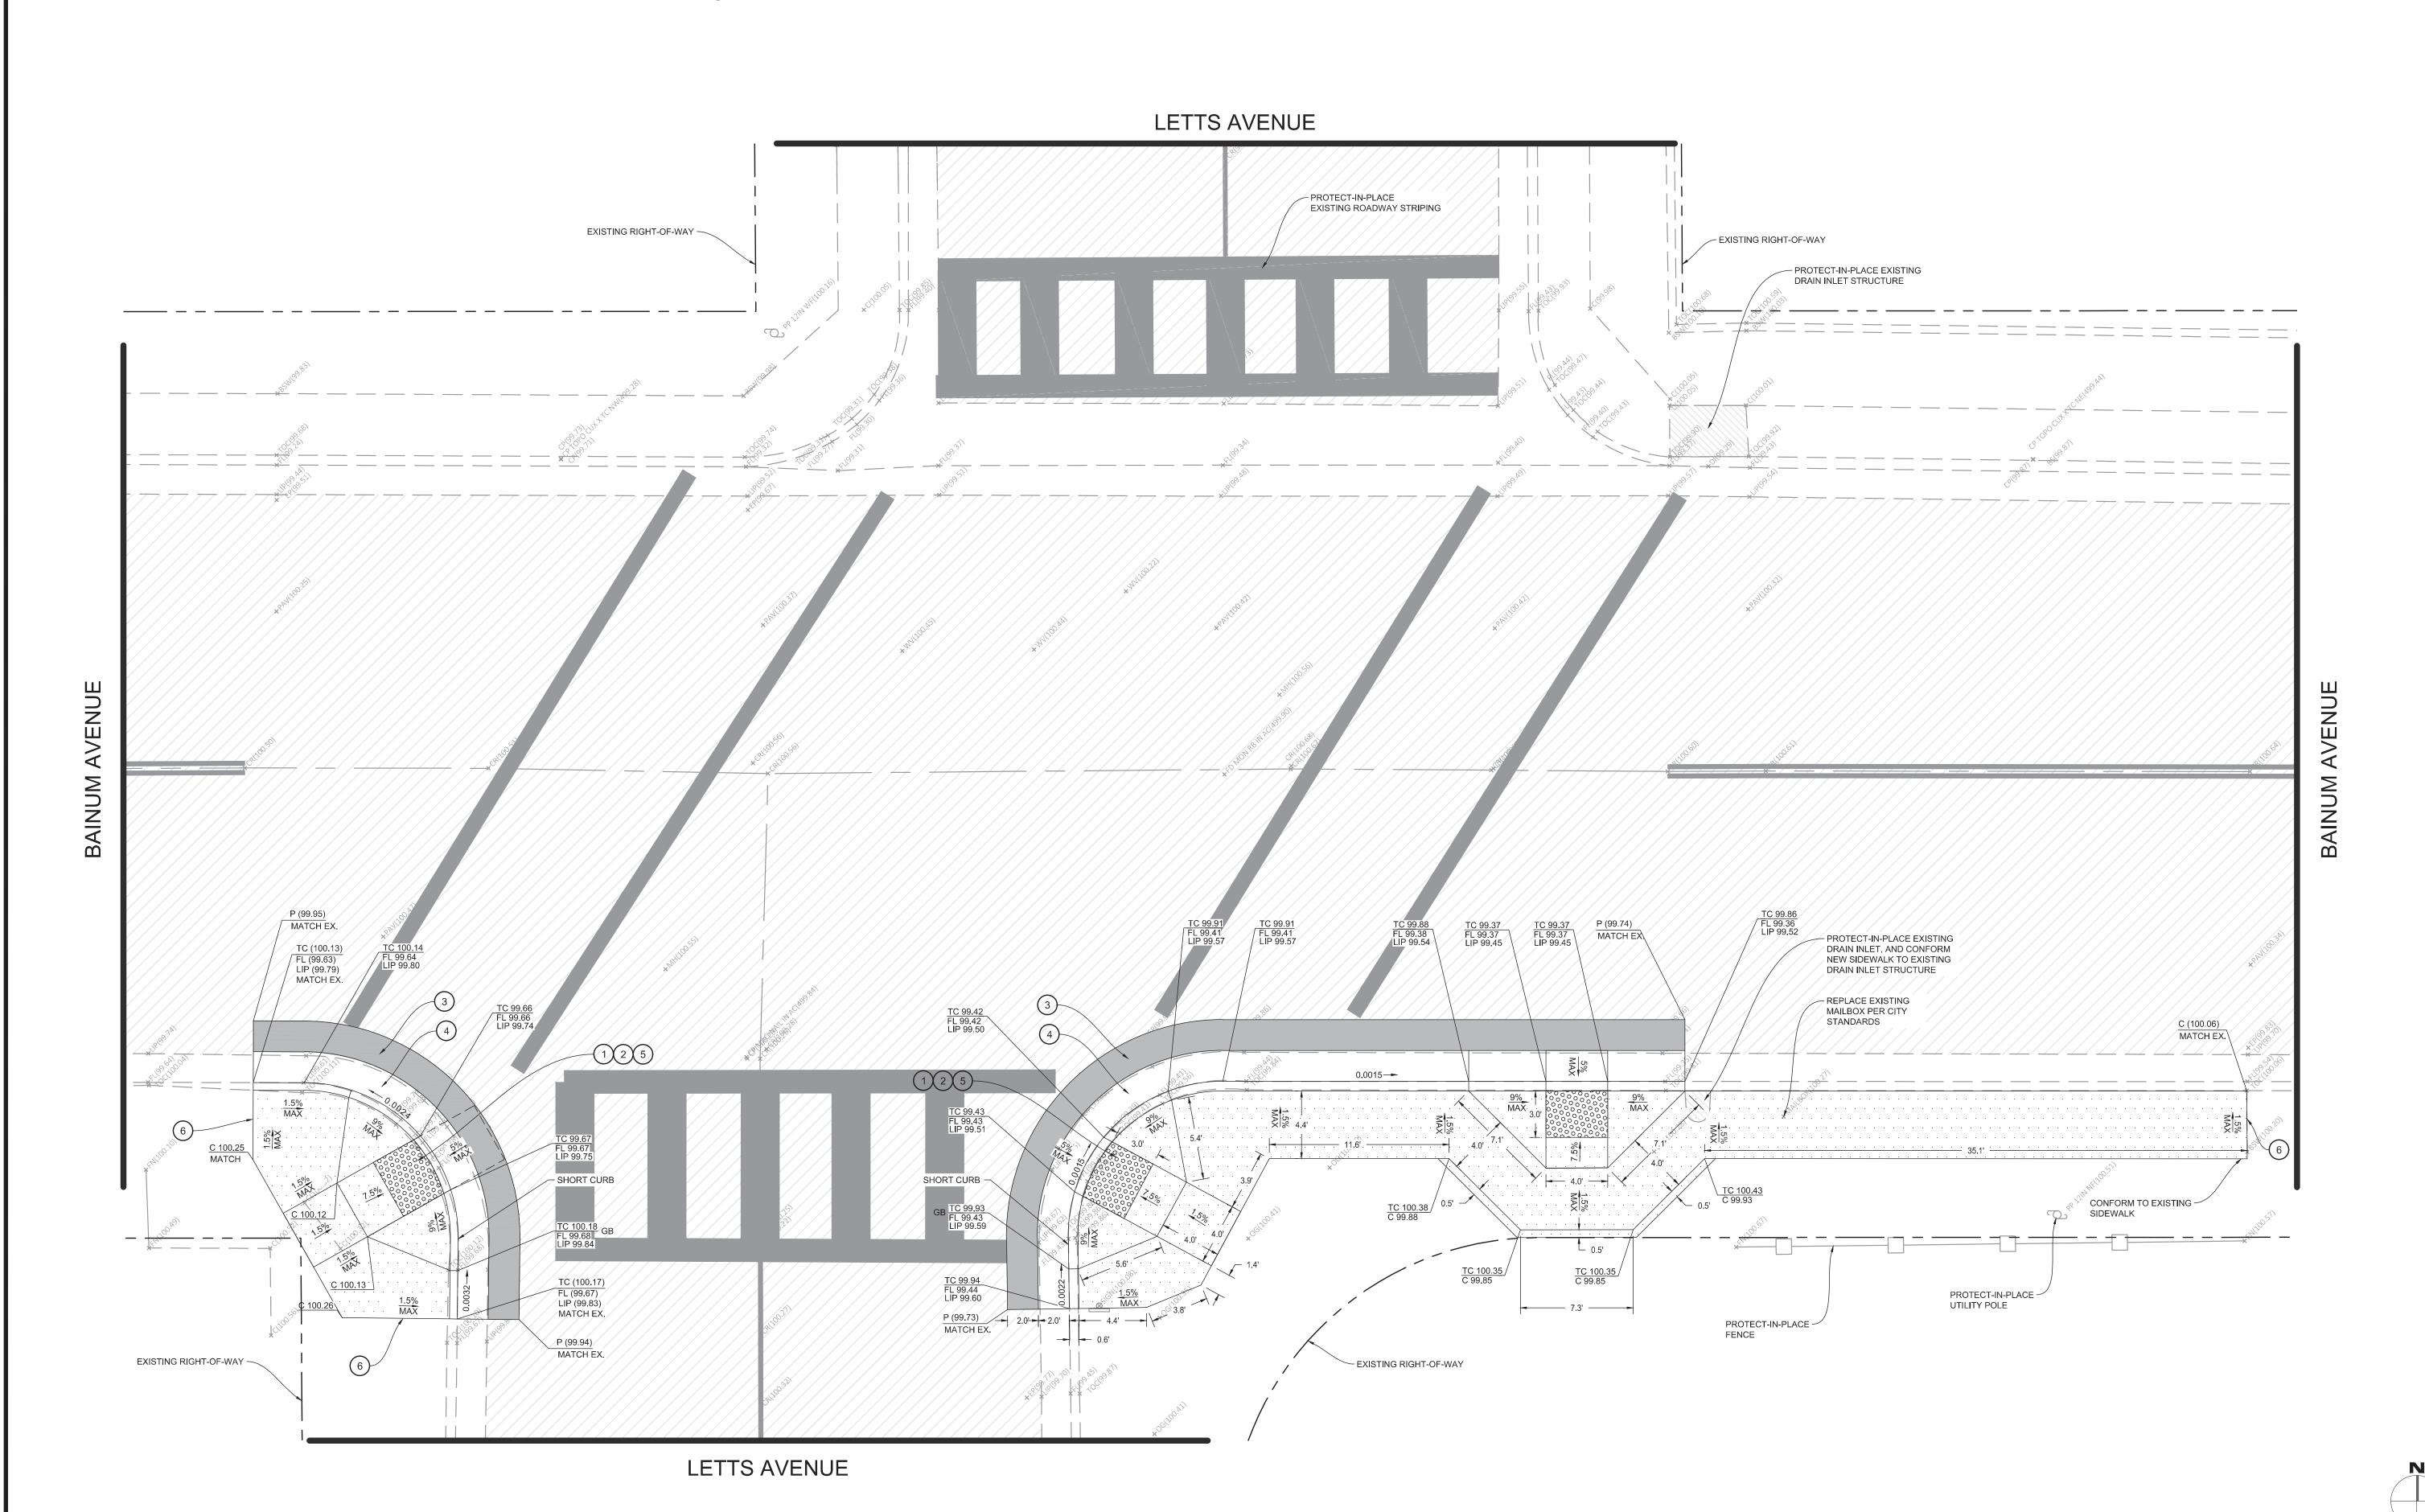
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#### **SIGNING & STRIPING NOTES**

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2. PAINT DETAIL 1 (YELLOW CENTERLINE), SEE SHEET 58

3. REINSTALL EXISTING STREET SIGN AND POLE


4. INSTALL NEW W11-2 & W16-7P SIGN W ITH POST (ARROW MUST POINT TOWARDS ROADWAY)


5. INSTALL NEW R1-5 SIGN WITH POST

6. STRIPE PEDESTRIAN YIELD LINE AS SHOWN AND PER FIGURE 3B-16, SEE SHEET 58






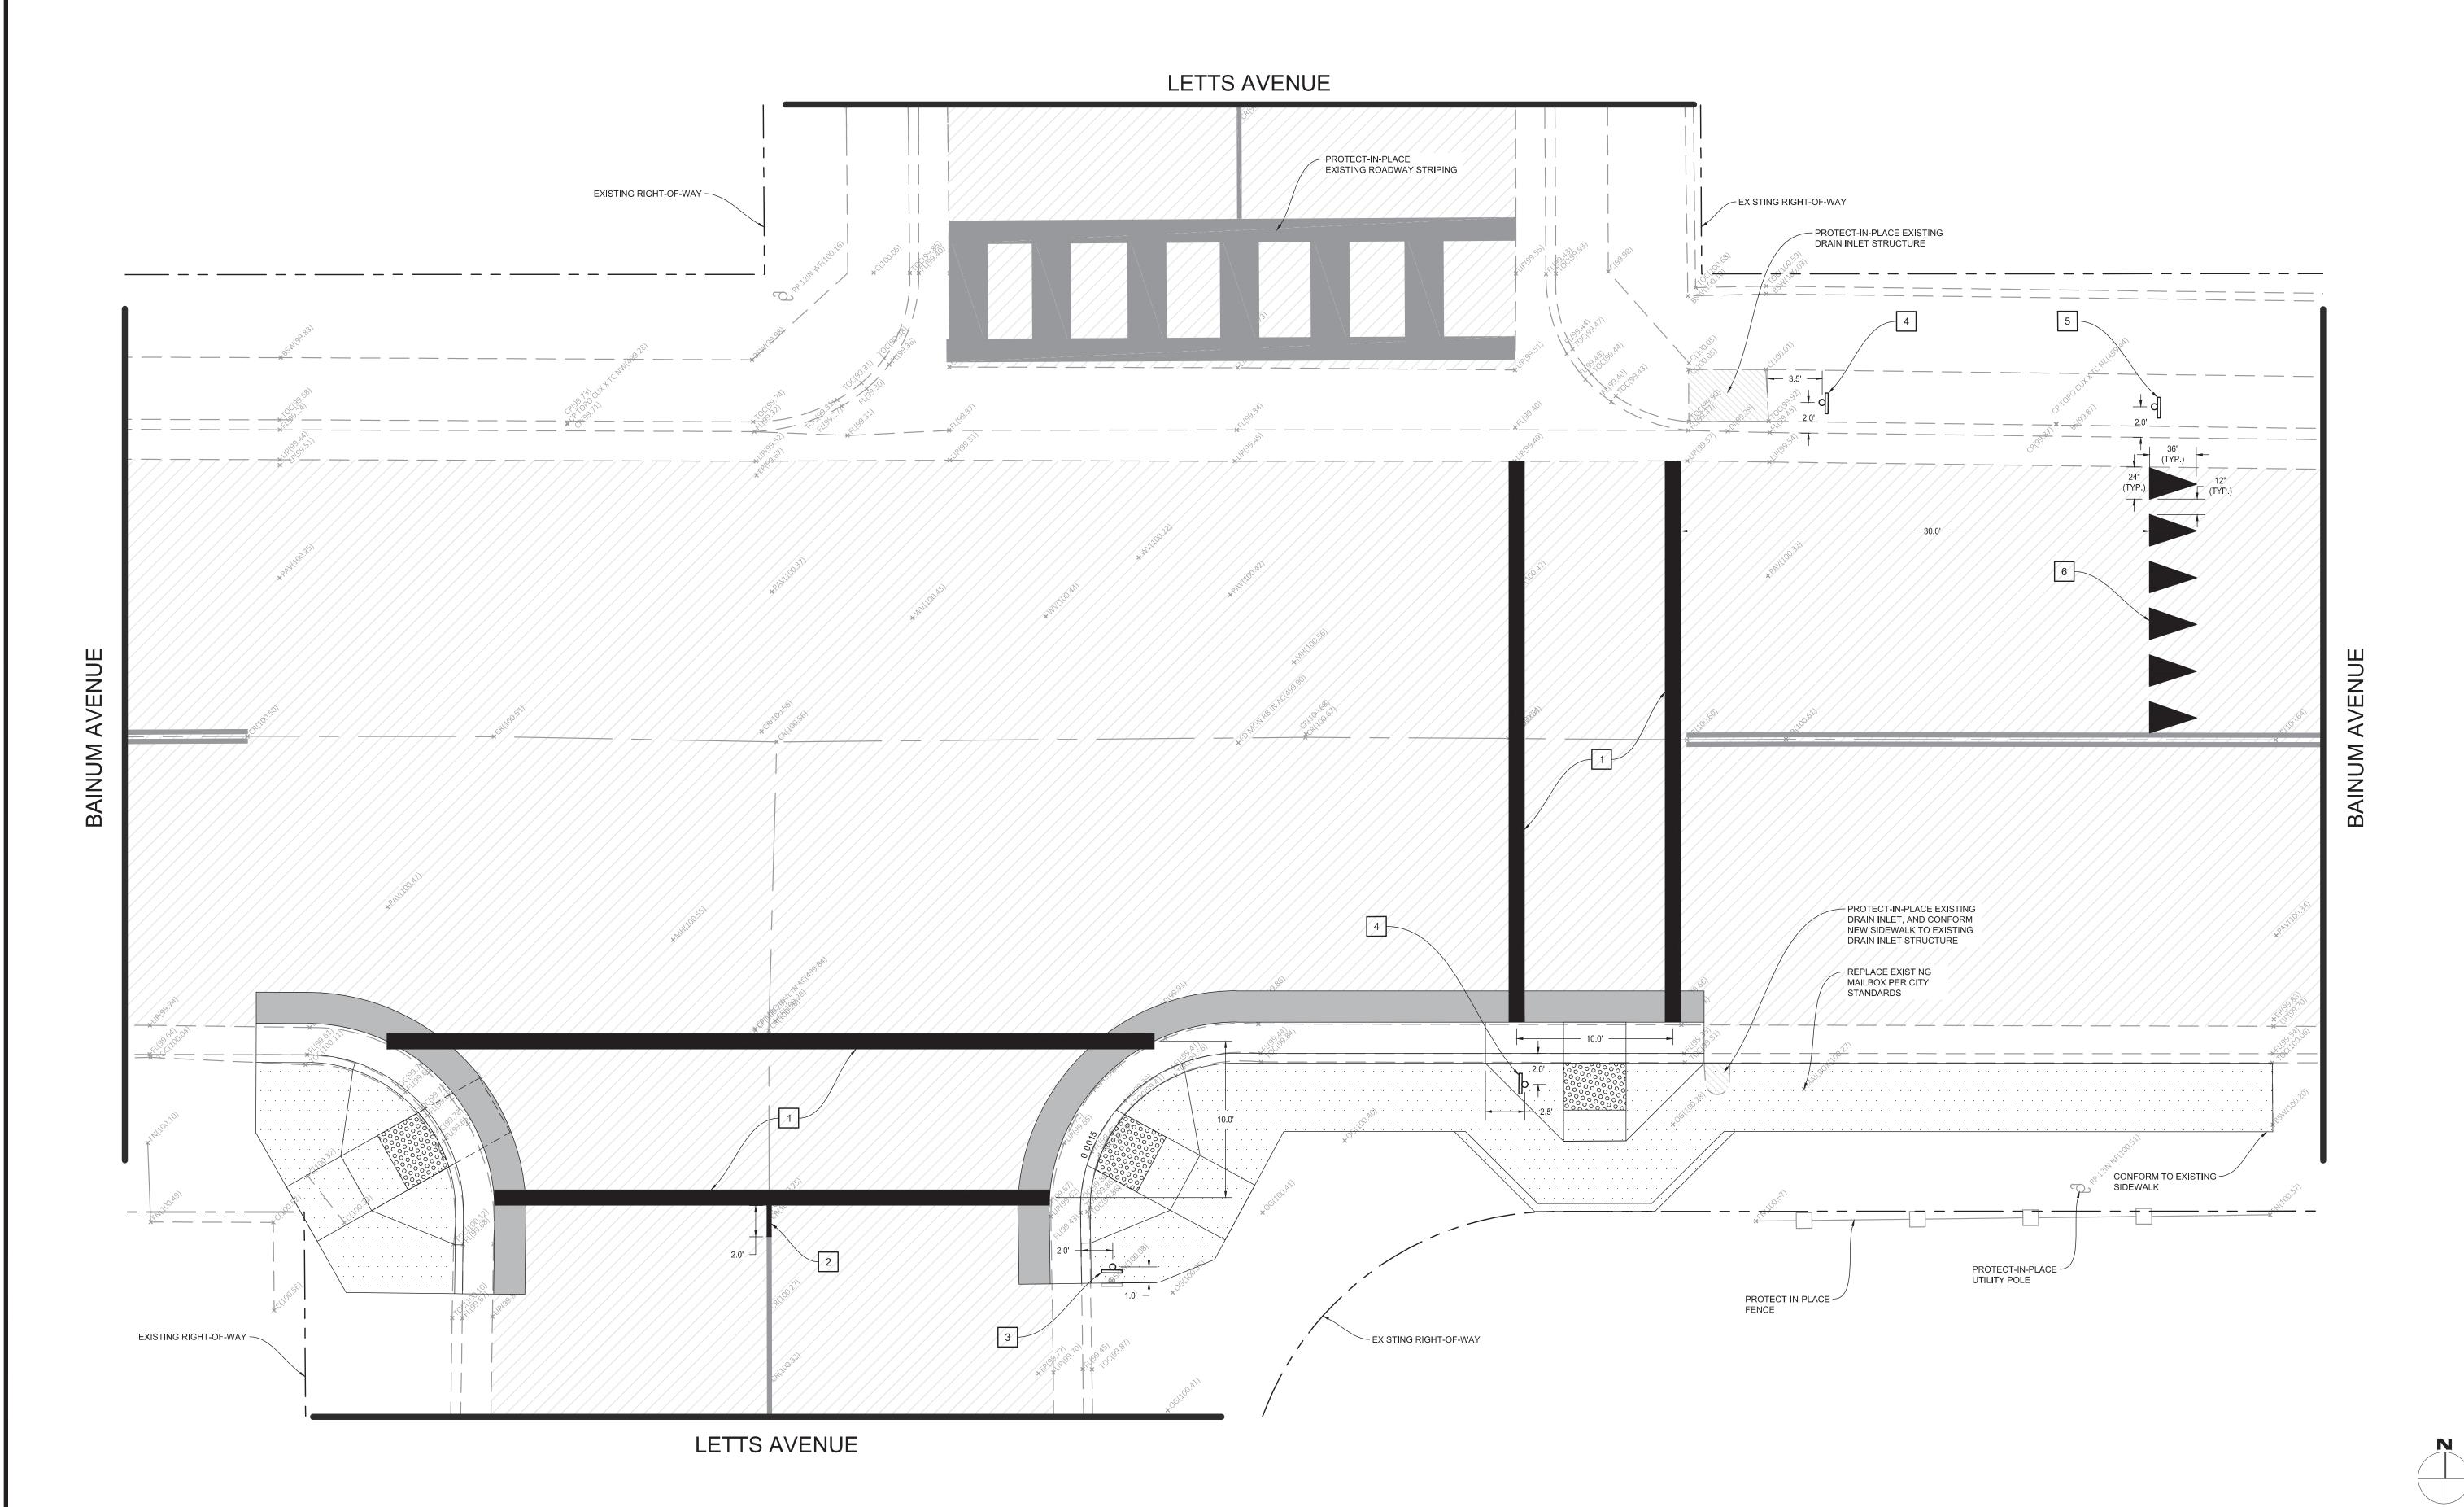

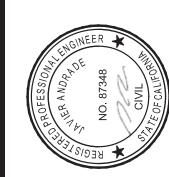



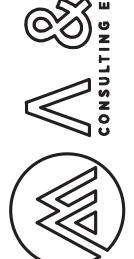

SIDEWALK IMPROVMENTS

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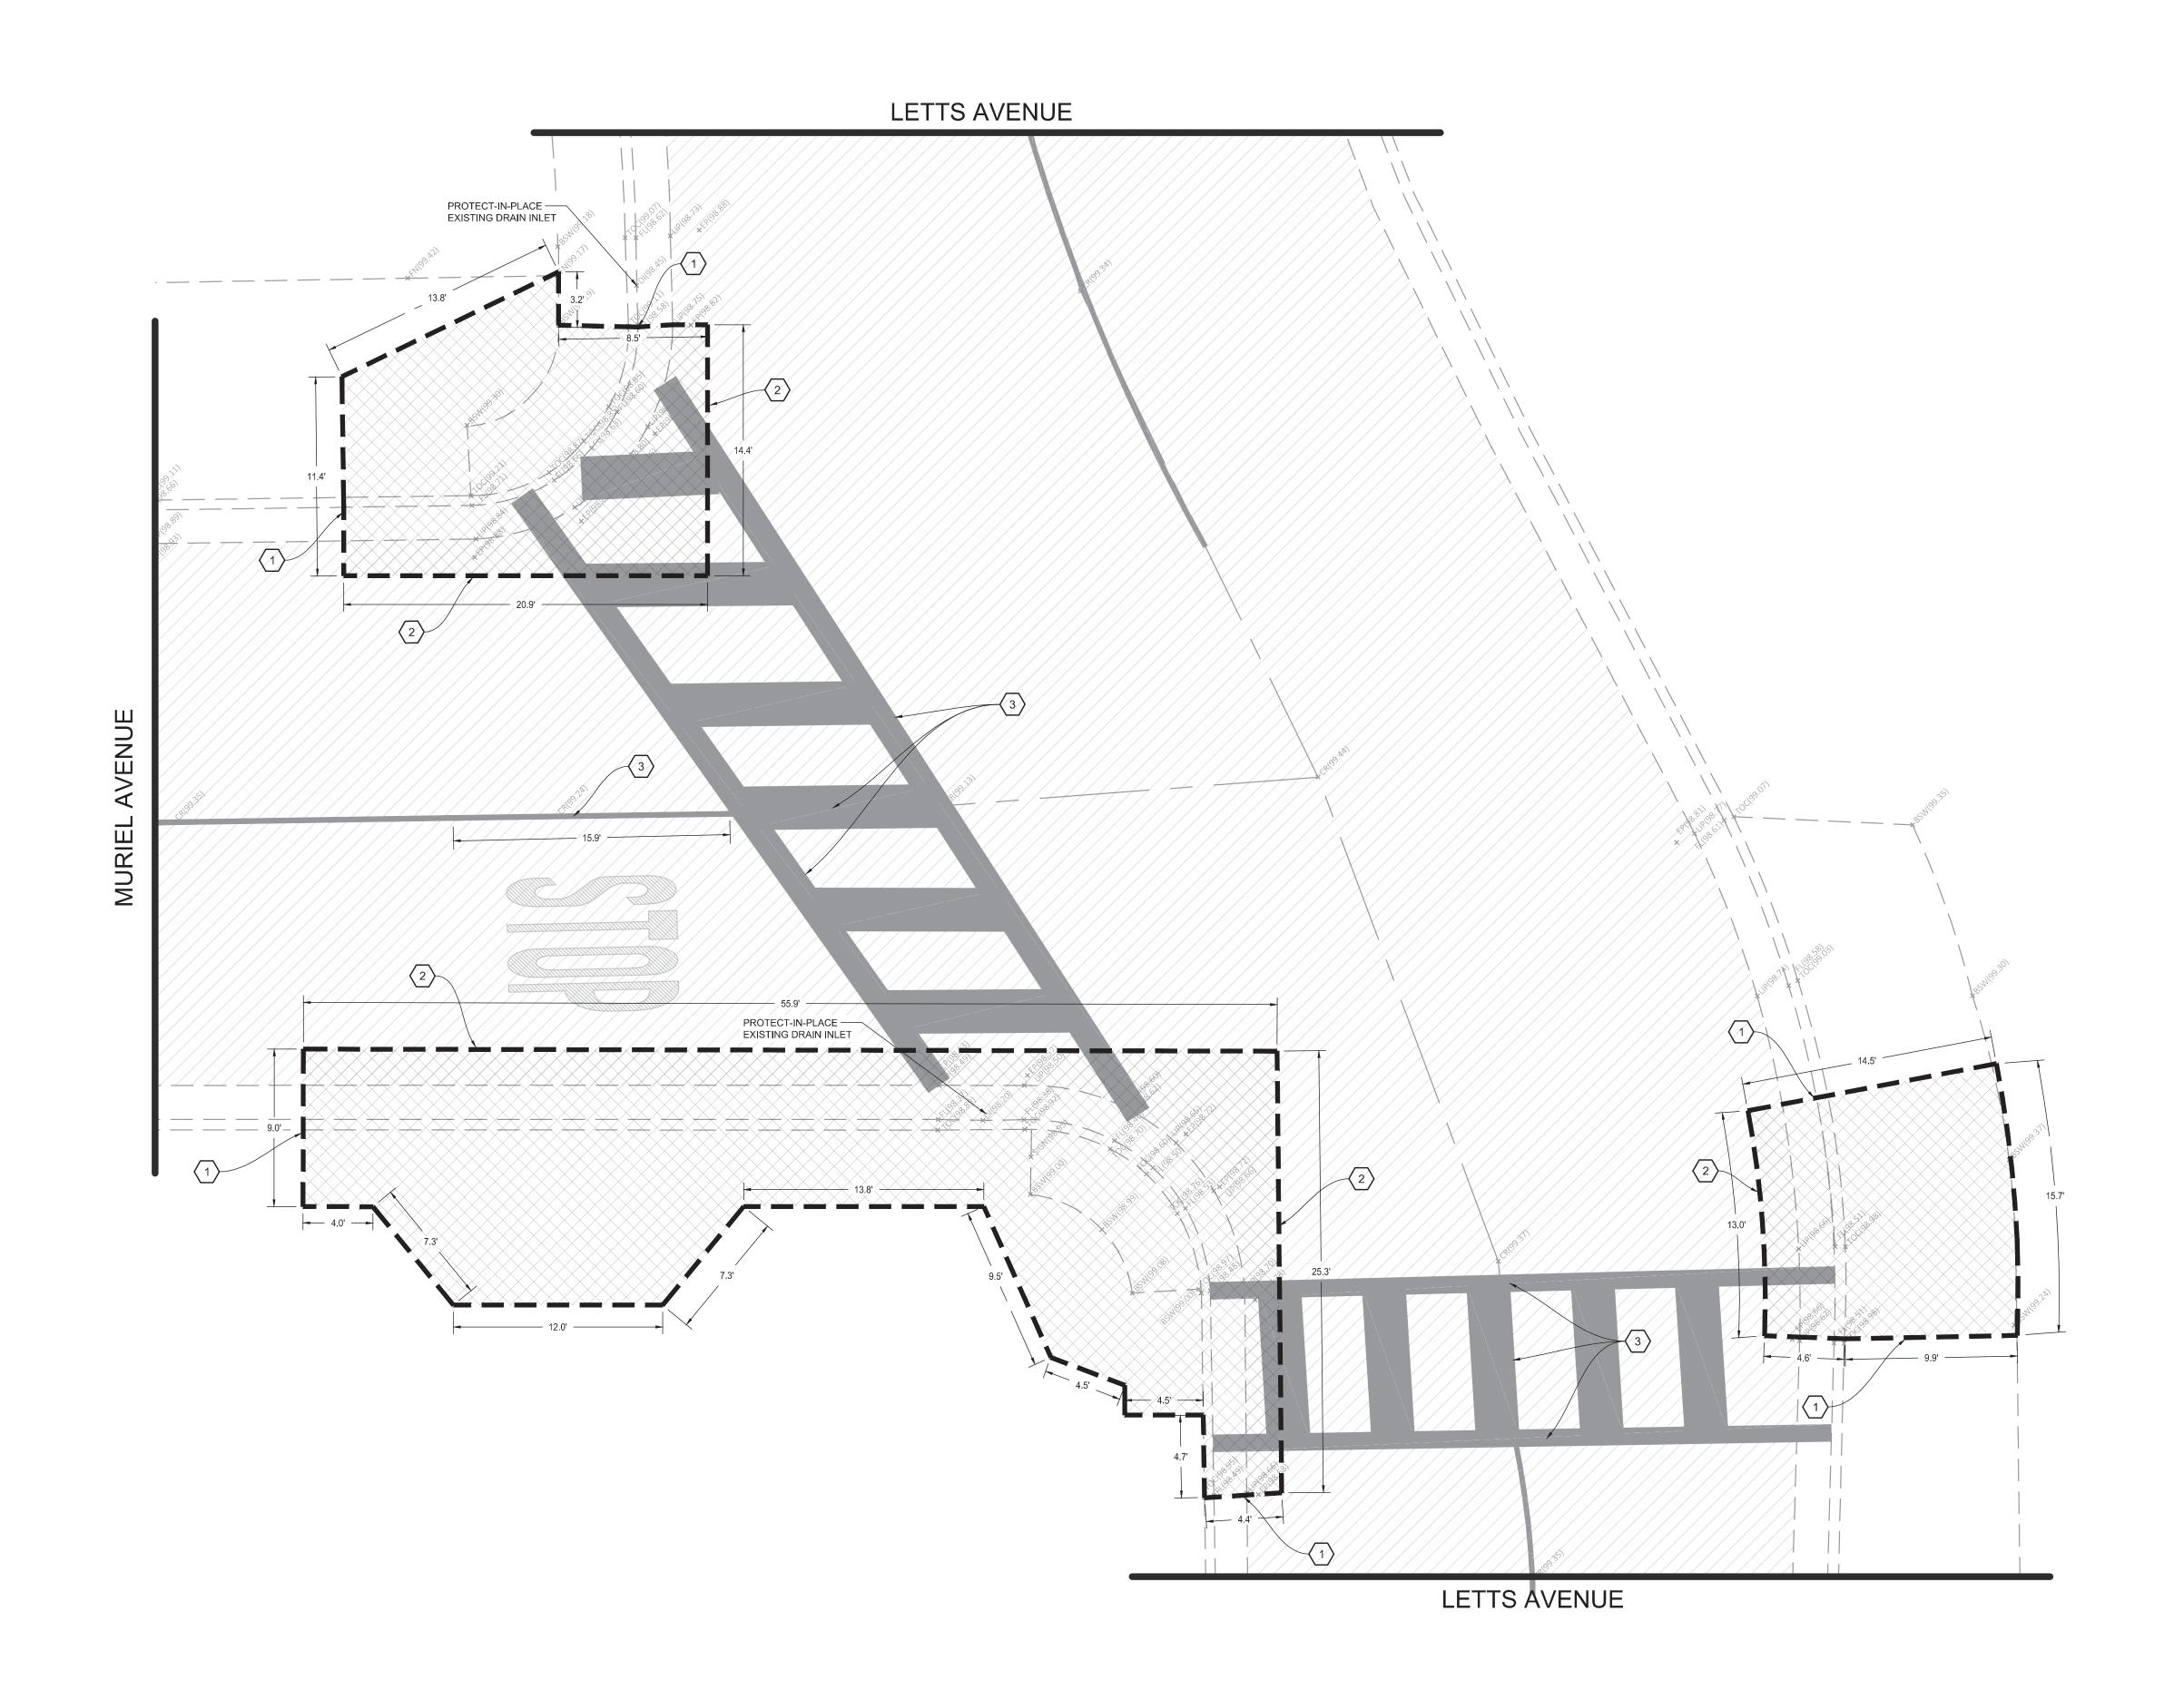


### **DEMOLITION NOTES**

- 1. SAWCUT EXISTING CONCRETE TO A NEAT CLEAN EDGE LINE
- 2. SAWCUT EXISTING PAVEMENT TO A NEAT CLEAN EDGE LINE
- 3. EXISTING STRIPING OR MARKING TO BE REMOVED BY SANDING OR WATER BLASTING









SIDEWALK IMPROVMENTS



SHEET NO.

#### **CONSTRUCTION NOTES**

1.) INSTALL 3' DEEP BY 4' WIDE DETECTABLE WARNING SURFACE (RAISED TRUNCATED DOMES)

2.) CONSTRUCT NEW ACCESSIBLE RAMP SEE SHEET XXX FOR DETAILS

3.) CONSTRUCT PAVEMENT PATCH PER DETAIL XXX ON SHEET XXX

4.) CONSTRUCT CONCRETE GUTTER PATCH PER DETAIL XXX ON SHEET XXX

(5.) HEAVY BROOM FINISH ACROSS SLOPE OF RAMPS TYPICAL.

(6.) INSTALL WEAKENED PLANE JOINT AROUND RAMP PERIMETER TYPICAL.








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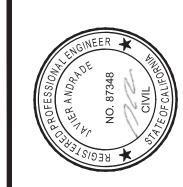


#### **SIGNING & STRIPING NOTES**

- 1. PAINT STANDARD 24" WIDE SOLID YELLOW CROSSWALK MARKING
- 2. PAINT STANDARD 4" SOLID YELLOW CENTER LINE AND MATCH TO EXISTING







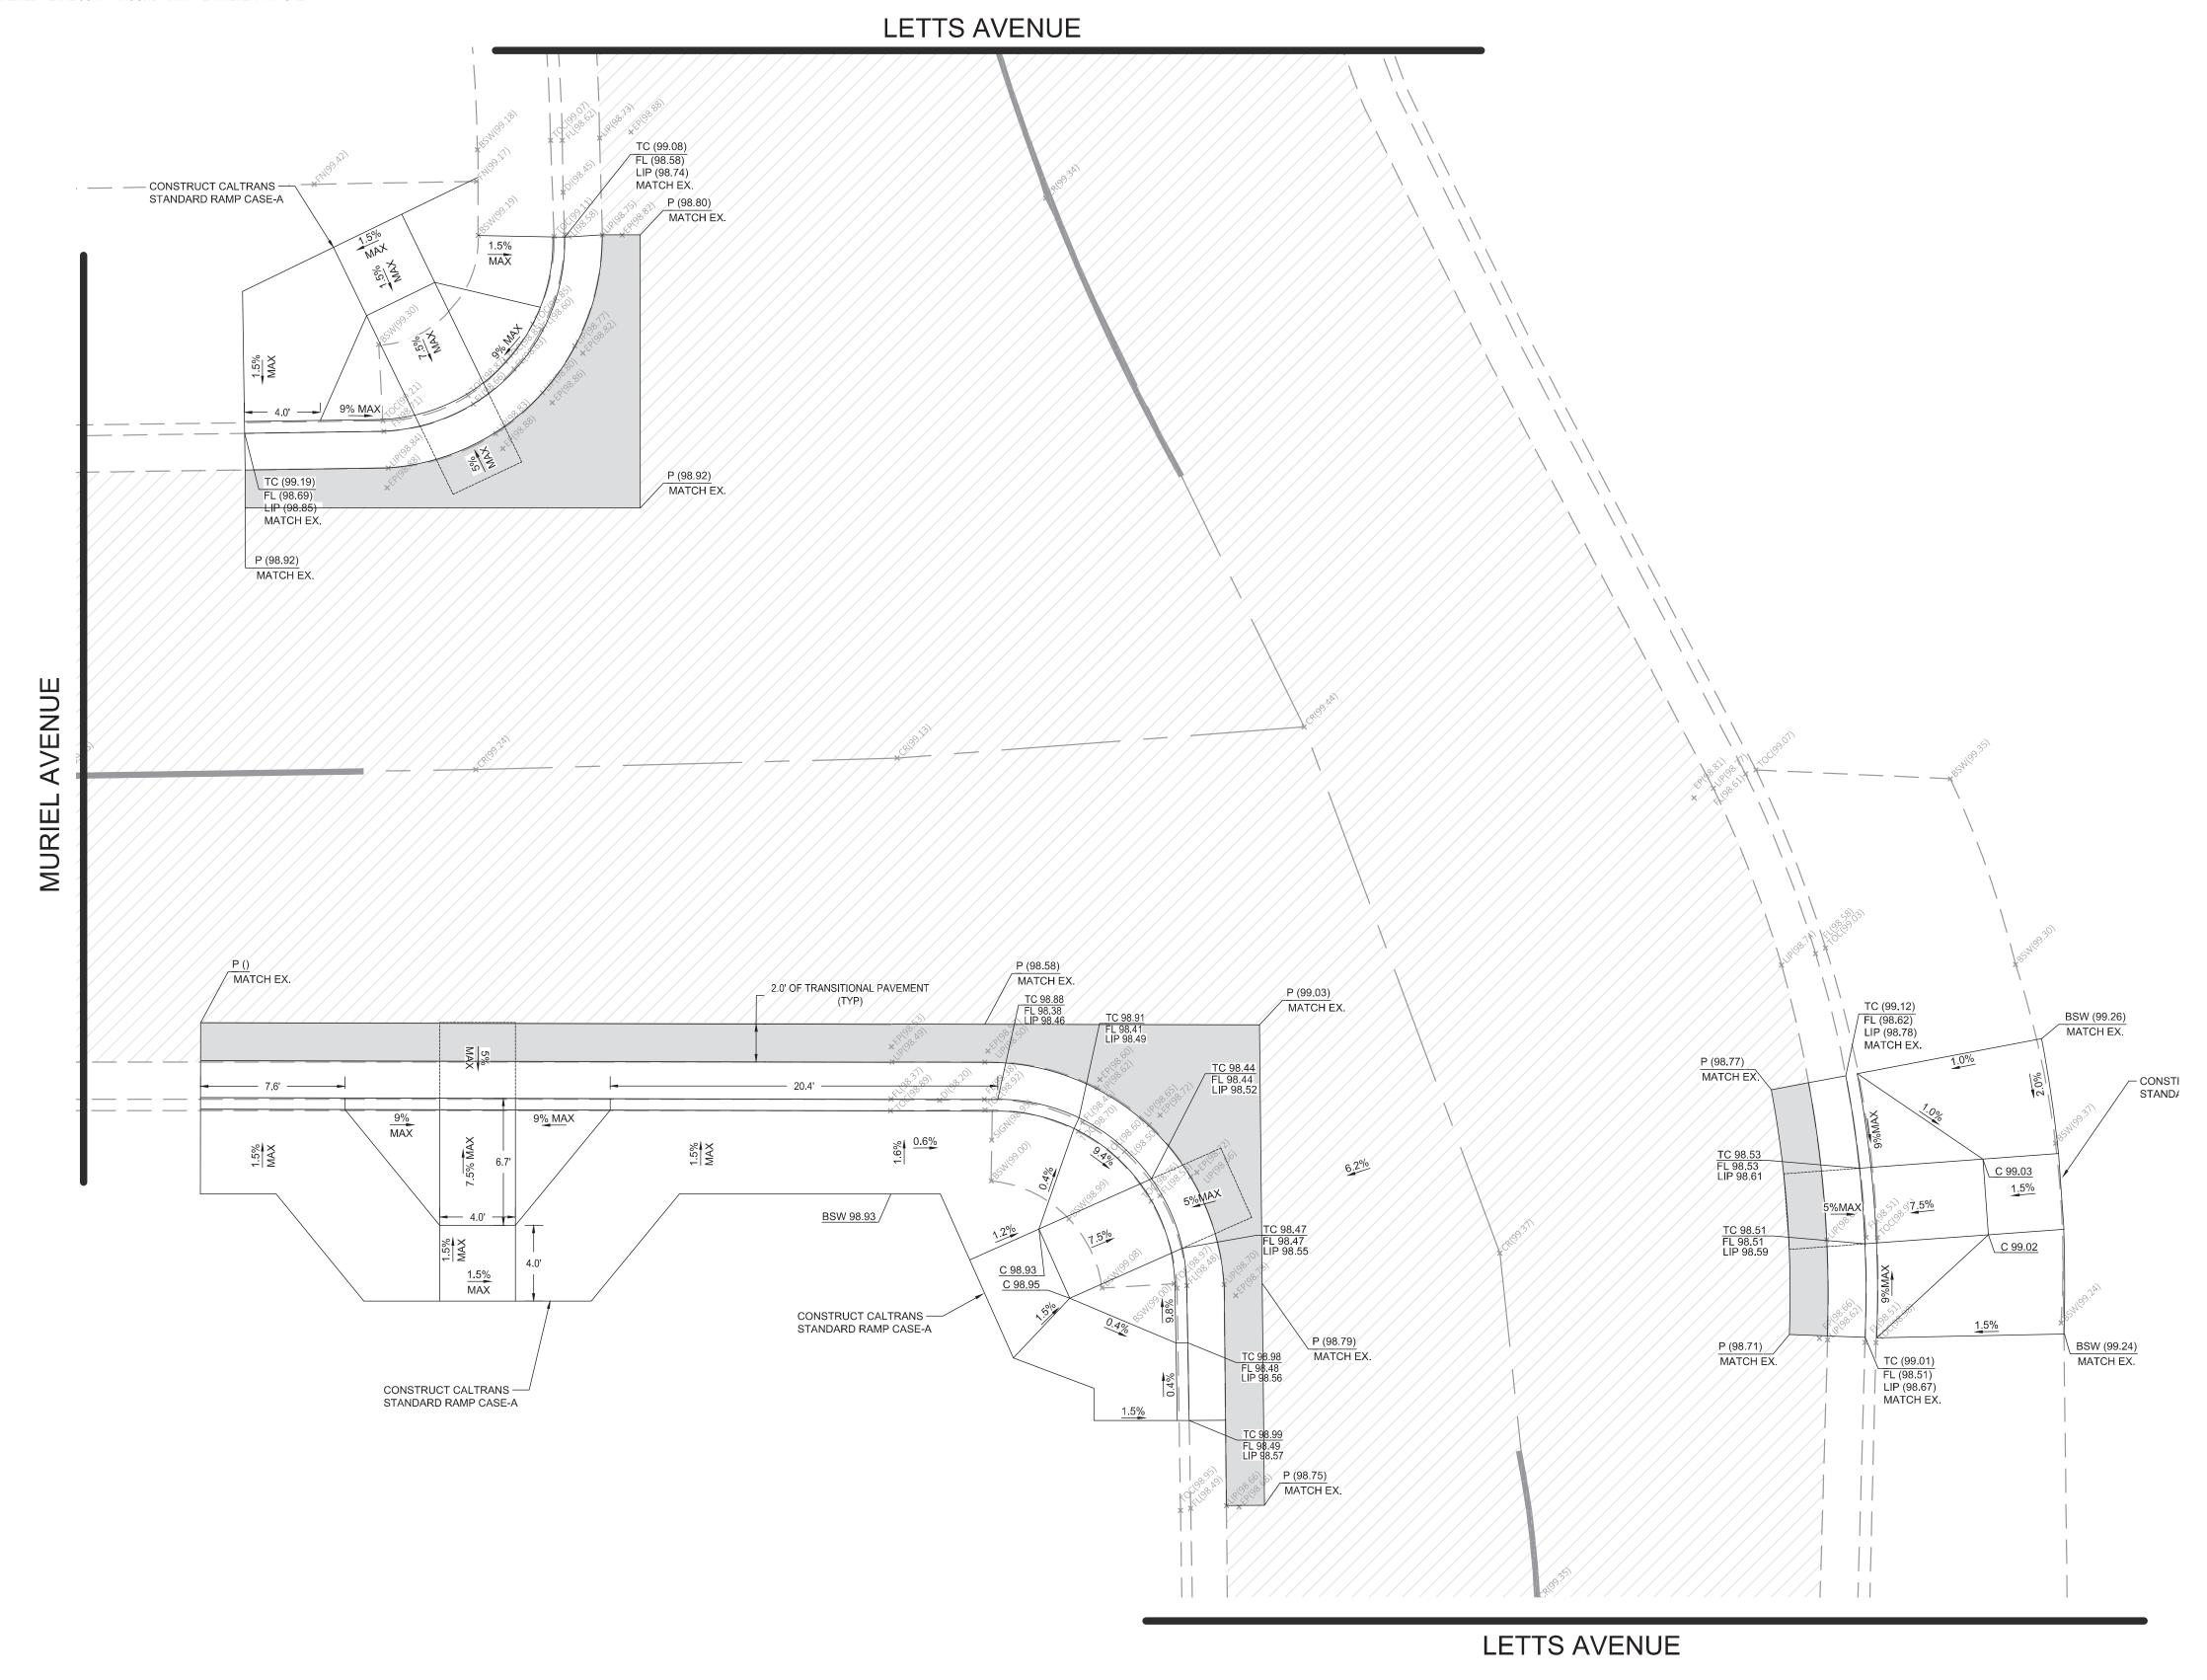

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#### **SIGNING & STRIPING NOTES**

- 1. PAINT 24" WIDE SOLID YELLOW CROSSWALK MARKING
- 2. PAINT 12" WIDE SOLID YELLOW LADDER CROSSWALK MARKING, INSIDE LINES TO BE 24" WI WHEEL PATH

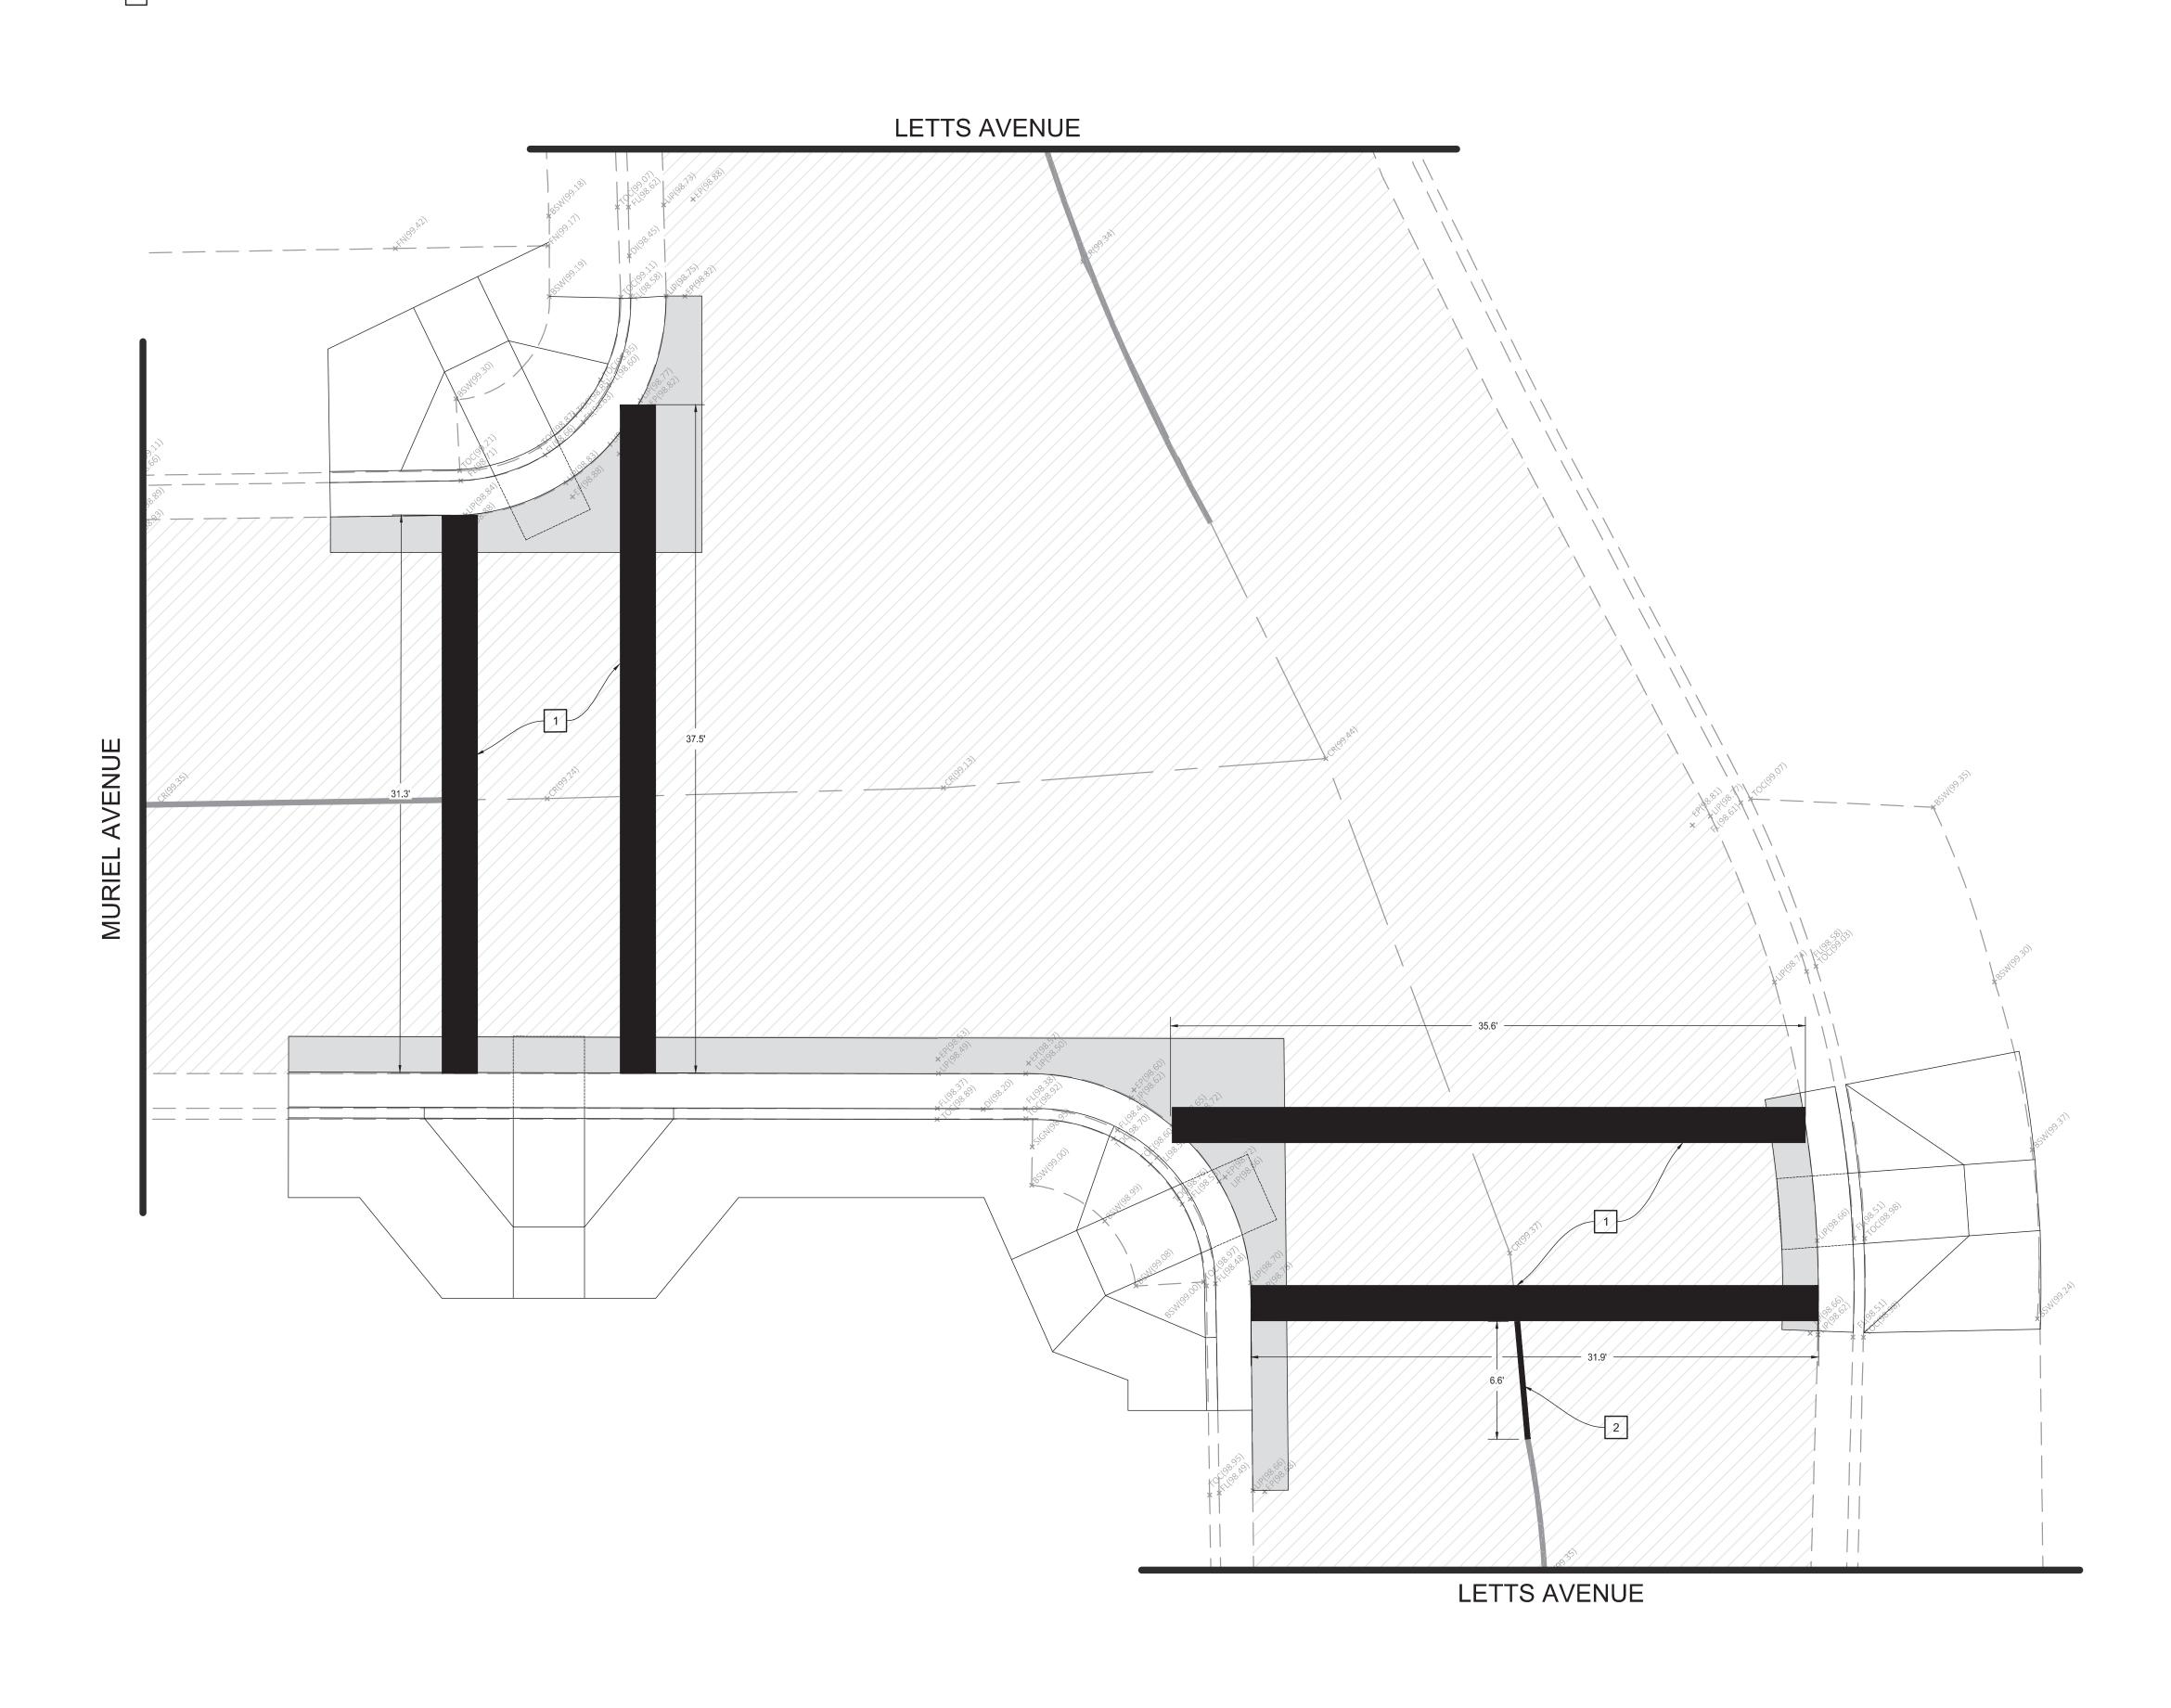

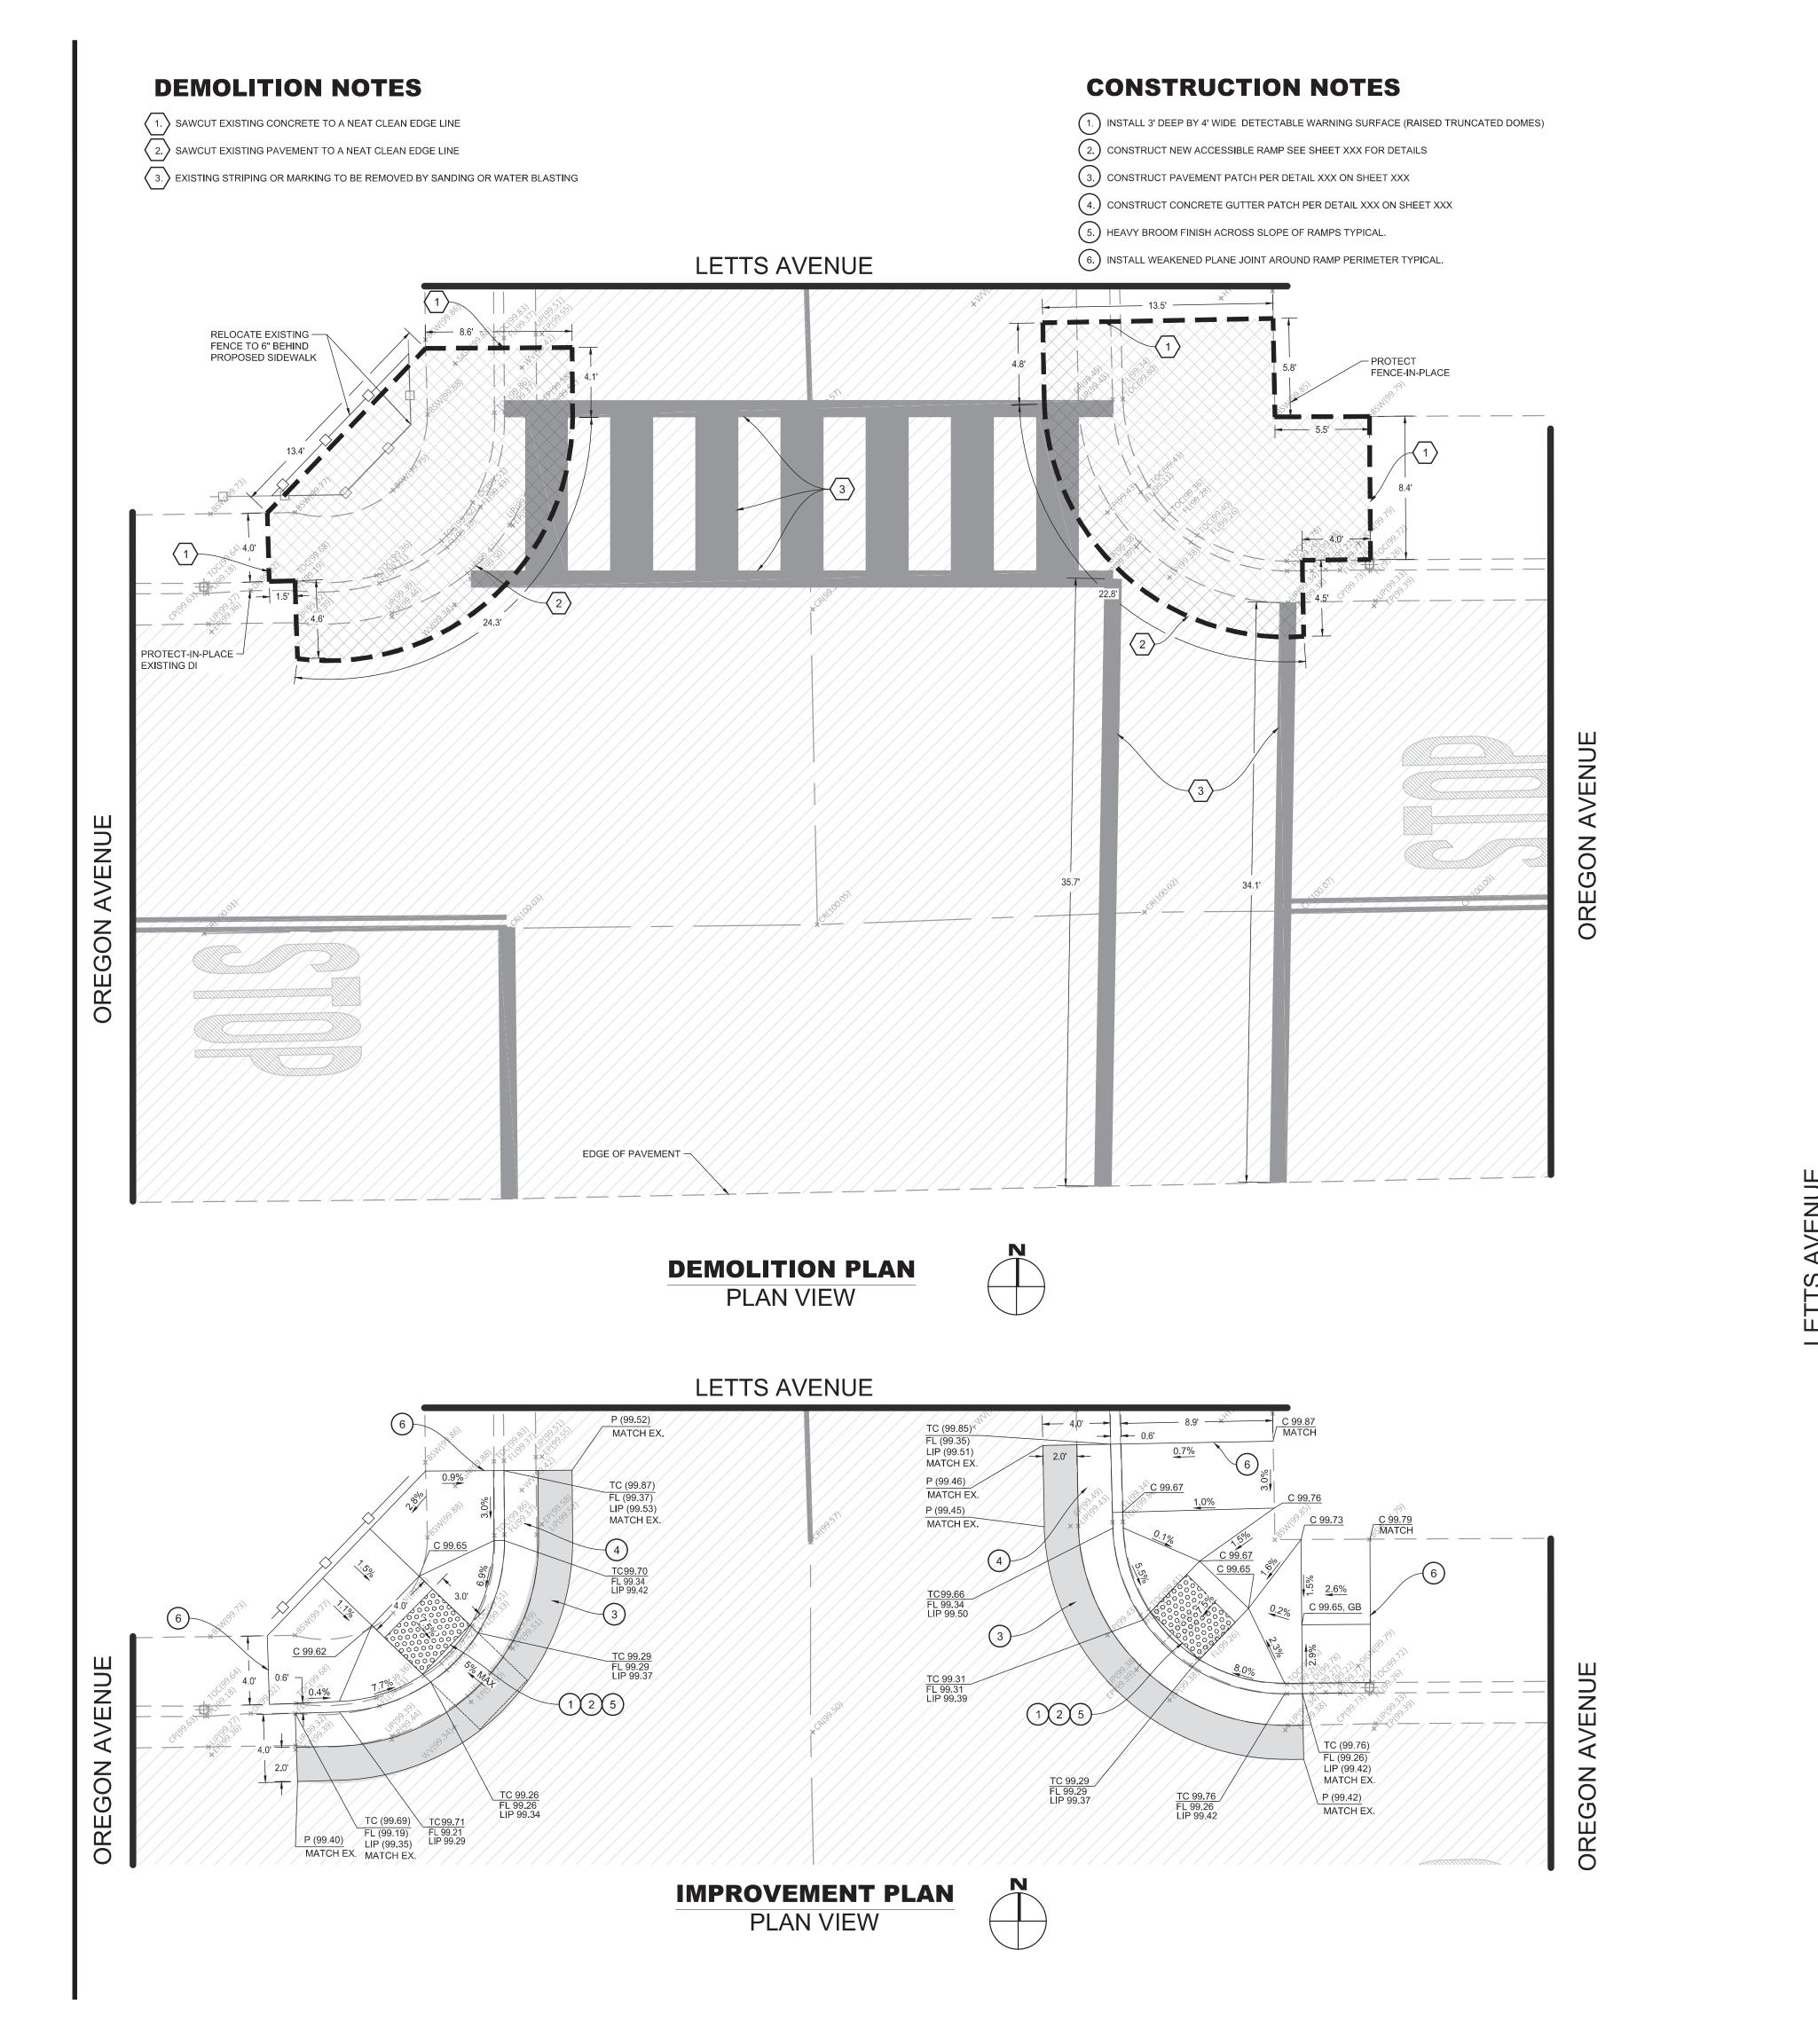OREGON AVENUE



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EDGE OF PAVEMENT -

OREGON AVENUE

SIGNAGE, STRIPING, & MARKING PLAN

PLAN VIEW



SHEET NO.


Sign or Plaque	Sign Designation	Section	Shared-Use Path	Roadway
Stop	R1-1	2B.05, 9B.03	18 x 18	30 x 30
Yield	R1-2	2B.08, 9B.03	18 x 18 x 18	30 x 30 x 30
Dike Lane	R9-17	98.04		24 x 18
Dike Lane (plaques)	R9-17aP, R9-17bP	9B.04		24×0
Movement Restriction	R4-1,2,3,7,16	2B.28,29,30,32; 9B.14	12 x 18	18 x 24
Begin Right Turn Lane Yield to Bikes	R4-4	9B.05	_	36 x 30
Bicycles May Use Full Lane	R4-11	9B.06	_	30 x 30
Bicycle Wrong Way	R5-1b	9B.07	12 x 18	12 x 18
No Motor Vehicles	R5-3	9B.08	24 x 24	24 x 24
No Bicycles	R5-6	9B.09	18 x 18	24 x 24
No Parking Bike Lane	R7-9,9a	9B.10	<u> </u>	12 x 18
No Pedestrians	R9-3	9B.09	18 x 18	18 x 18
Ride With Traffic (plaque)	R9-3cP	9B.07	12 x 12	12 x 12
Bicycle Regulatory	R9-5,6	9B.11	12 x 18	12 x 18
Shared-Use Path Restriction	R9-7	9B.12	12 x 18	_
No Skaters	R9-13	9B.09	18 x 18	18 x 18
No Equestrians	R9-14	9B.09	18 x 18	18 x 18
Push Button for Green Light	R10-4	9B.11	9 x 12	9 x 12
To Request Green Wait on Symbol	R10-22	9B.13	12 x 18	12 x 18
Bike Push Button for Green Light	R10-24	9B.11	9 x 15	9 x 15
Push Button to Turn On Warning Lights	R10-25	9B.11	9 x 12	9 x 12
Bike Push Button for Green Light (arrow)	R10-26	9B.11	9 x 15	9 x 15
Grade Crossing (Crossbuck)	R15-1	8B.03, 9B.14	24 x 4.5	48 x 9
Number of Tracks (plaque)	R15-2P	8B.03, 9B.14	13.5 x 9	27 x 18
Look	R15-8	8B.17, 9B.14	18 x 9	36 x 18
Turn and Curve Warning	W1-1,2,3,4,5	2C.04, 9B.15	18 x 18	24 x 24
Arrow Warning	W1-6,7	2C.12, 2C.47, 9B.15	24 x 12	36 x 18
Intersection Warning	W2-1,2,3,4,5	2C.46, 9B.16	18 x 18	24 x 24
Stop, Yield, Signal Ahead	W3-1,2,3	2C.36, 9B.19	18 x 18	30 x 30
Narrow Bridge	W5-2	2C.20, 9B.19	18 x 18	30 x 30
Path Narrows	W5-4a	9B.19	18 x 18	
Next XX Miles (plaque)	W7-3aP	2C.55, 9B.19	18 x 12	24 x 18
Hill	W7-5	9B.19	18 x 18	30 x 30
Bump or Dip	W8-1,2	2C.28, 9B.17	18 x 18	24 x 24
Pavement Ends	W8-3	2C.30, 9B.17	18 x 18	30 x 30
Bicycle Surface Condition	W8-10	9B.17	18 x 18	30 x 30
Slippery When Wet (plaque)	W8-10P	9B.17	12 x 9	12 x 9
Grade Crossing Advance Warning	W10-1	8B.06, 9B.19	24 Dia.	36 Dia.
No Train Horn (plaque)	W10-9P	8B.21, 9B.19	18 x 12	30 x 24
Skewed Crossing	W10-12	8B.25, 9B.19	18 x 18	36 x 36
Bicycle Warning	W11-1	9B.18	18 x 18	24 x 24
Pedestrian Crossing	W11-2	2C.50, 9B.19	18 x 18	24 × 24
Combination Bike and Ped Crossing	W11-15	9B.18	18 x 18	30 x 30
Trail Crossing (plaque)	W11-15P	9B.18	18 x 12	24 x 18
Low Clearance	W12-2	2C.27, 9B.19	18 x 18	30 x 30
Playground	W15-1	2C.51, 9B.19	18 x 18	24 x 24
Share the Road (plaque)	W16-1P	2C.60, 9B.19	1500(155)	18 x 24


Table 9B-1. Bicycle Facility Sign and Plague Minimum Sizes (Sheet 2 of 2)

Sign or Plaque	Sign Designation	Section	Shared-Use Path	Roadway
XX Feet (plaque)	W16-2P	2C.55, 9B.18	18 x 12	24 x 18
XX Ft (plaque)	W16-2aP	2C.55, 9B.18	18 x 9	24 x 12
Diagonal Arrow (plaque)	W16-7P	9B.18	_	24 x 12
Ahead (plaque)	W16-9P	9B.18	-	24 x 12
Destination (1 line)	D1-1, D1-1a	2D.37, 9B.20	varies x 6	varies x 18
Bicycle Destination (1 line)	D1-1b, D1-1c	9B.20	varies x 6	varies x 6
Destination (2 lines)	D1-2, D1-2a	2D.37, 9B.20	varies x 12	varies x 30
Bicycle Destination (2 lines)	D1-2b, D1-2c	9B.20	varies x 12	varies x 12
Destination (3 lines)	D1-3, D1-3a	2D.37, 9B.20	varies x 18	varies x 42
Bicycle Destination (3 lines)	D1-3b, D1-3c	9B.20	varies x 18	varies x 18
Street Name	D3-1	2D.43, 9B.20	varies x 6	varies x 8
Bicycle Parking Area	D4-3	9B.23	12 x 18	12 x 18
Reference Location (1-digit)	D10-1	2H.02, 9B.24	6 x 12	10 x 18
Intermediate Reference Location (1-digit)	D10-1a	2H.02, 9B.24	6 x 18	10 x 27
Reference Location (2-digit)	D10-2	2H.02, 9B.24	6 x 18	10 x 27
Intermediate Reference Location (2-digit)	D10-2a	2H.02, 9B.24	6 x 24	10 x 36
Reference Location (3-digit)	D10-3	2H.02, 9B.24	6 x 24	10 x 36
Intermediate Reference Location (3-digit)	D10-3a	2H.02, 9B.24	6 x 30	10 x 48
Bike Route	D11-1, D11-1c	9B.20	24 x 18	24 x 18
Bicycles Permitted	D11-1a	9B.25	18 x 18	- 1
Bike Route (plaque)	D11-1bP	9B.25	18 x 6	-
Pedestrians Permitted	D11-2	9B.25	18 x 18	1-
Skaters Permitted	D11-3	9B.25	18 x 18	-
Equestrians Permitted	D11-4	9B.25	18 x 18	1-
Bicycle Route	M1-8, M1-8a	9B.21	12 x 18	18 x 24
U.S. Bicycle Route	M1-9	9B.21	12 x 18	18 x 24
Bicycle Route Auxiliary Signs	M2-1; M3-1,2,3,4; M4-1,1a,2,3,5,6,7,7a,8,14	9B.22	12 x 6	12 x 6
Bicycle Route Arrow Signs	M5-1,2; M6-1,2,3,4,5,6,7	9B.22	12 x 9	12 x 9
Type 3 Object Markers	OM3-L,C,R	2C.63, 9B.26	6 x 18	12 x 36

Notes: 1. Larger signs may be used when appropriate 2. Dimensions are shown in inches and are shown as width x height


Sign or Plaque	Sign Designation	Section	Shared-Use Path	Roadway
Bicycle Parking	G93C(CA)	9B.23	24 x 18	24 x 18
Bike Path Exclusion	R44A(CA)	9B.08	12 x 24	1.000
BICYCLES MOTOR-DRIVEN CYCLES MUST EXIT	R44B(CA)	9B.101(CA)		30 x 36
BICYCLES MUST EXIT	R44C(CA)	9B.101(CA)		30 x 30
Bike Lane	R81(CA)	9B.04	( eee	12 x 8
BEGIN	R81A(CA)	9B.04		12 x 5
END	R81B(CA)	9B.04	1	8 x 5
PASS Bicycle 3 FT MIN	R117(CA)	9B.102(CA)		30 x 30 *
EXCEPT Bicycle	R118(CA)	9C.04		18 x 15 *
Bicycle Route Number Marker	SG45(CA)	9B.21	12 x 18	12 x 18
Bicycle Route Name Marker	S17(CA)	9B.21	24 x 6	24 x 6

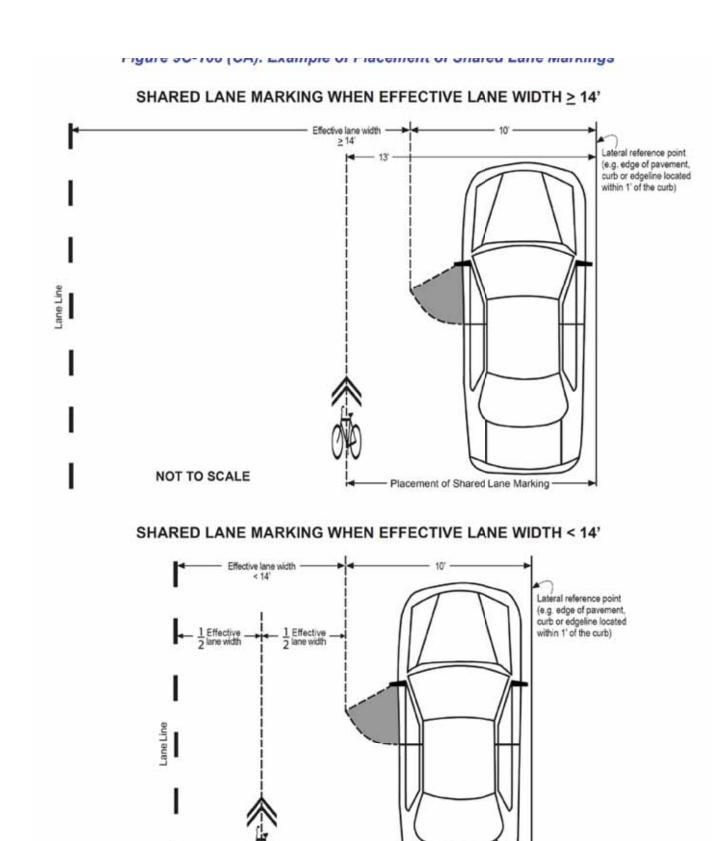


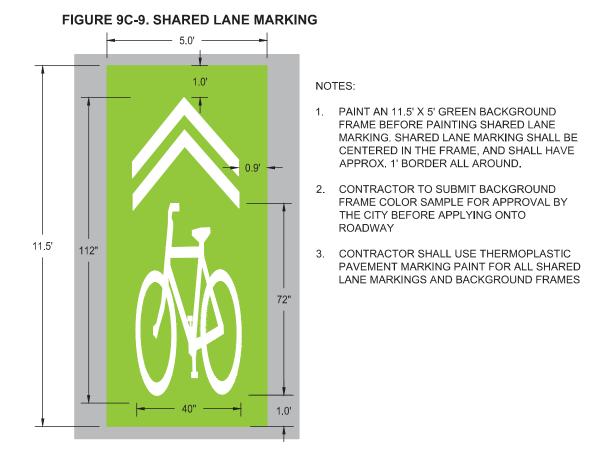


Placement of Shared Lane Marking —

NOT TO SCALE

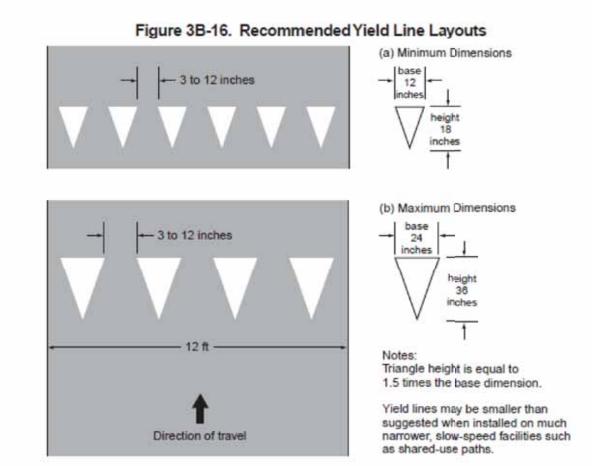

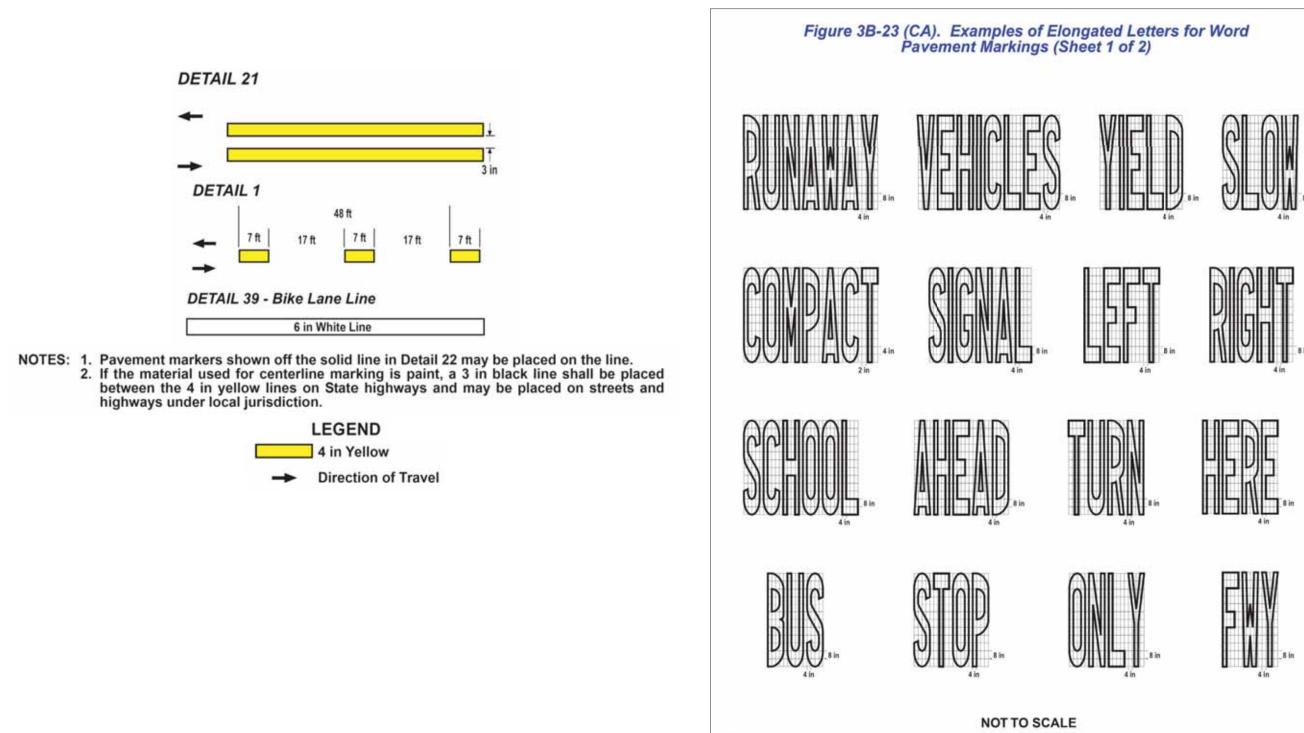

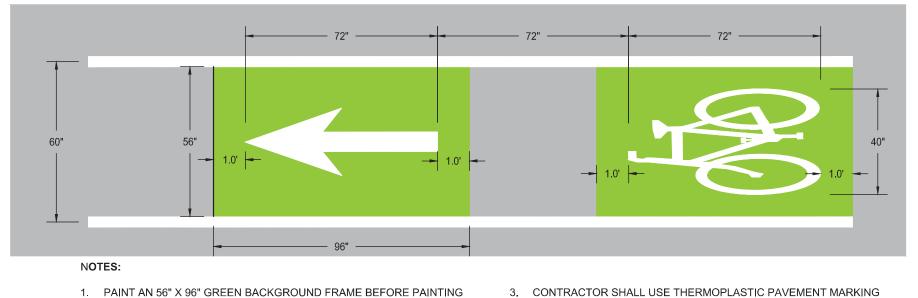

- 1. PAINT AN 56" X 96" GREEN BACKGROUND FRAME BEFORE PAINTING BIKE LANE SYMBOL MARKINGS. BIKE LANE MARKINGS SHALL BE CENTERED IN THE FRAME AND SHALL EXTEND APPROX. 1' BEFORE AND AFTER THE MARKING. SEE FIGURE 9C-3 OF THE CA MUTCD.
- 2. CONTRACTOR TO SUBMIT BACKGROUND FRAME COLOR SAMPLE FOR APPROVAL BY THE CITY BEFORE APPLYING ONTO ROADWAY.

### **BICYCLE LANE MARKING DETAIL**

N.T.S.





G93C (CA)





PAINT FOR BIKE LANE SYMBOL MARKINGS AND GREEN

4. BIKE LANE LINES SHALL BE 6" WHITE LINES. SEE DETAIL 39 AND

BACKGROUND FRAMES.

FIGURE 9C-101 (CA) OF CA MUTCD.


All letters and numerals should be in conformance with the standard alphabets for highway signs and pavement markings approved by Department of Transportation.

2. The design details for various words are also shown in Department of Transportation's



W16-1P

Figure 2A-2. Examples of Heights and Lateral Locations of Sign Installations

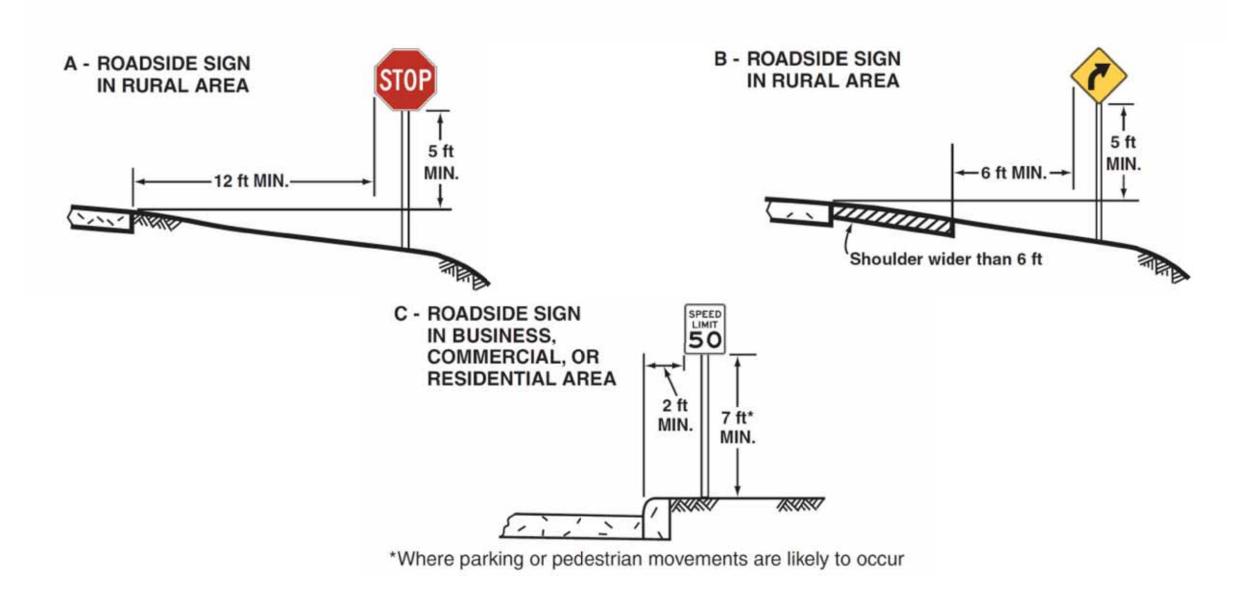



**IMPROVMENT** 

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SIGNA




SHEET NO.


COF

OF



SHEET NO.

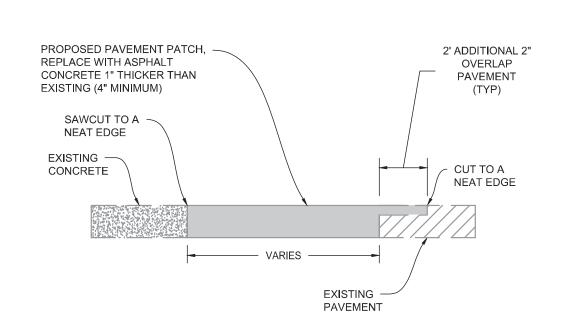

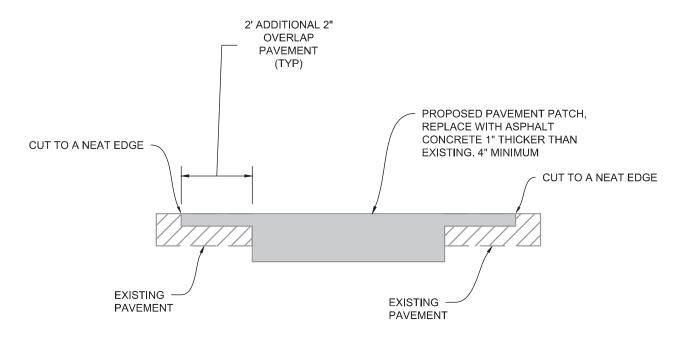

4"

5"

6"

2"

6"

SURFACE

COMPACTED 1' CLASS II


BASE, 95% MINIMUM

RELATIVE COMPACTION.


**DETAIL 1 PAVEMENT SECTION PATCH**N.T.S.


**DETAIL 2 PAVEMENT SECTION PATCH**N.T.S.

DETAIL 3
BULB-OUT CURB
N.T.S.

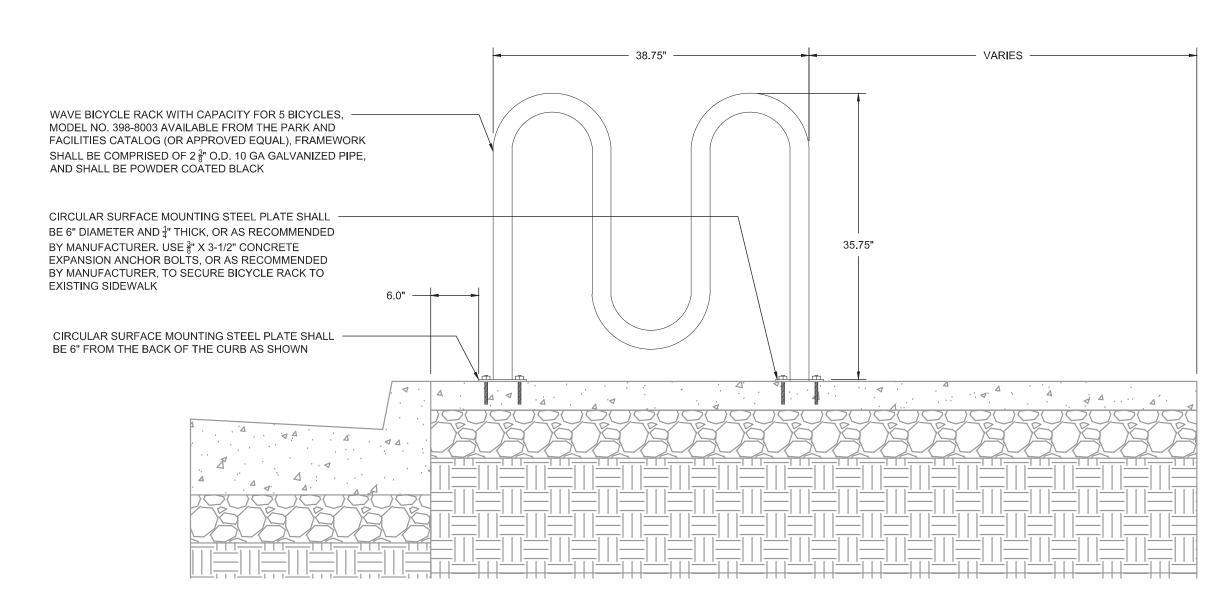


DETAIL 4
BICYCLE RACK (ELEVATION VIEW)
N.T.S.

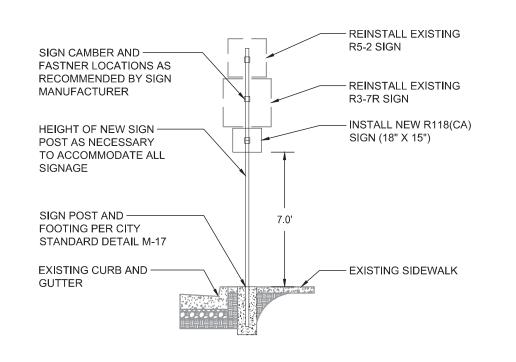

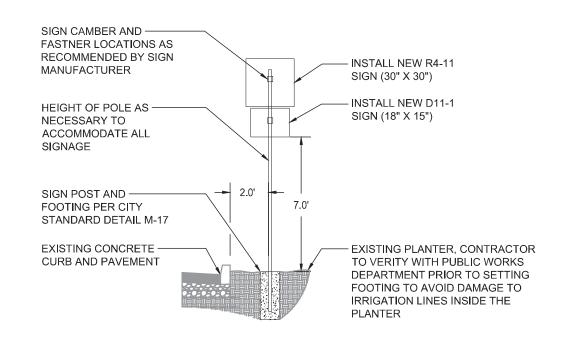


DETAIL 6
BICYCLE ROUTE SIGN ASSEMBLY
N.T.S.


DETAIL 7
BICYCLE ROUTE SIGN ASSEMBLY
N.T.S.

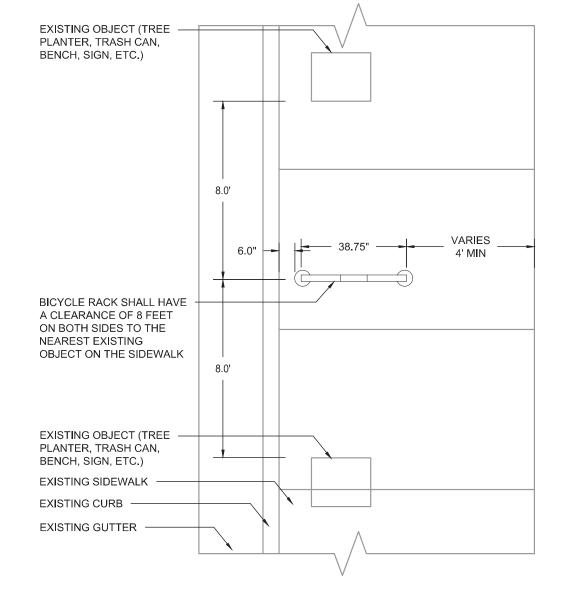

DETAIL 5
BICYCLE RACK (PLAN VIEW)
N.T.S.

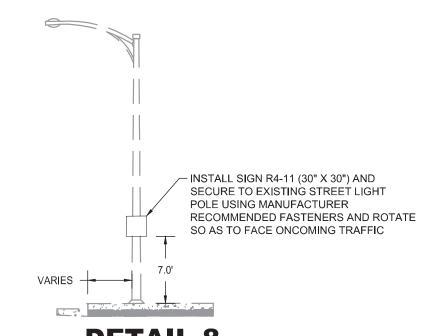

DETAIL 8
BICYCLE ROUTE SIGN INSTALLATION
ON STREET LIGHT POLE
N.T.S.

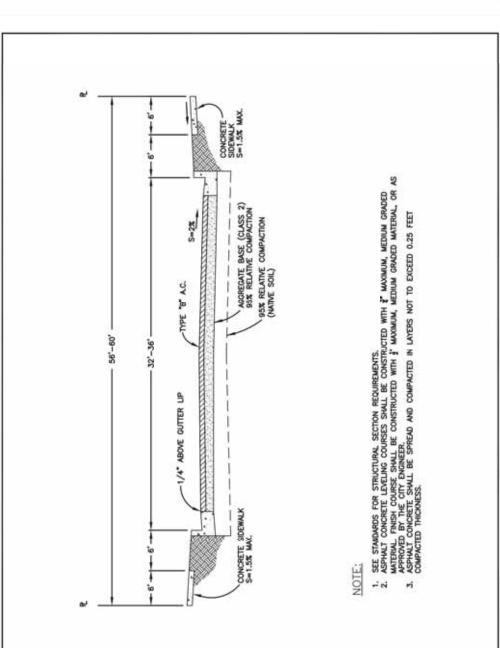

TELESPAR 2"X12"-14
GAUGE SIGN POST

MIN. IN 28 DAYS).


TRAFFIC SIGNS NOT TO SCALE

CITY of CORCORAN · Department of Public Works

STREET AND TRAFFIC

SIGNAL DESIGN

SIGN METAL GAUGE PER MANUFACTURER'S RECOMMENDATIONS AND SUBJECT TO THE APPROVAL OF THE DIRECTOR OF PUBLIC WORKS.

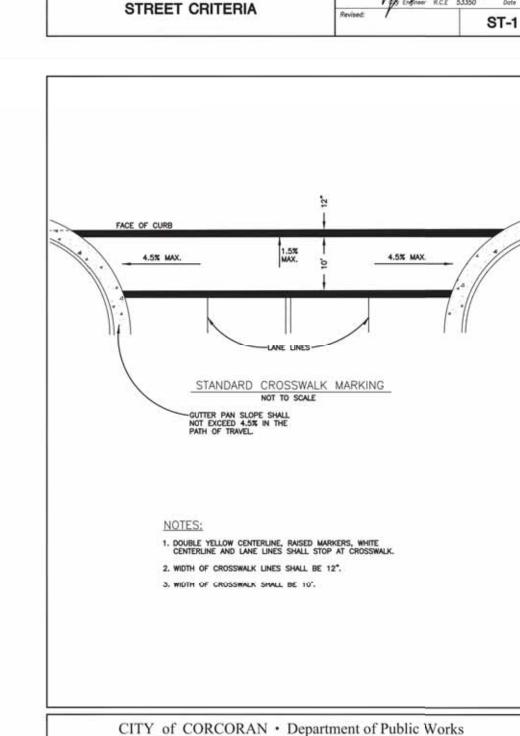

CROSSWALK DETAIL

STREET CRITERIA

IN ORDER TO CLARIFY OUR REQUIREMENTS FOR THE COMPACTION OF STREET SUBGRADE AND BASE MATERIALS, THE FOLLOWING CRITERIA SHALL APPLY:


COMPACTED TO A RELATIVE COMPACTION OF 95 PERCENT FOR GRANULAR MATERIAL, (NON-COHESIVE, FREE DRAINING MATERIAL).


THE REQUIREMENTS FOR MAXIMUM DENSITY-OPTIMUM MOISTURE RELATIONSHIPS FOR ALL OTHER FILLS AS SPECIFIED IN THE GRADING ORDINANCE SHALL APPLY TO THOSE FILLS PLACED ON PRIVATE PROPERTIES OUTSIDE OF STREET RIGHTS-OF-WAY.

CITY of CORCORAN · Department of Public Works

AGGREGATE BASE SHALL BE COMPACTED TO A 95 PERCENT RELATIVE COMPACTION.

MAXIMUM DENSITY — OPTIMUM MOISTURE RELATIONSHIPS, (COMPACTION TESTS), WILL BE DETERMINED IN ACCORDANCE WITH TEST METHOD NO. CALIF. 216 OR 231

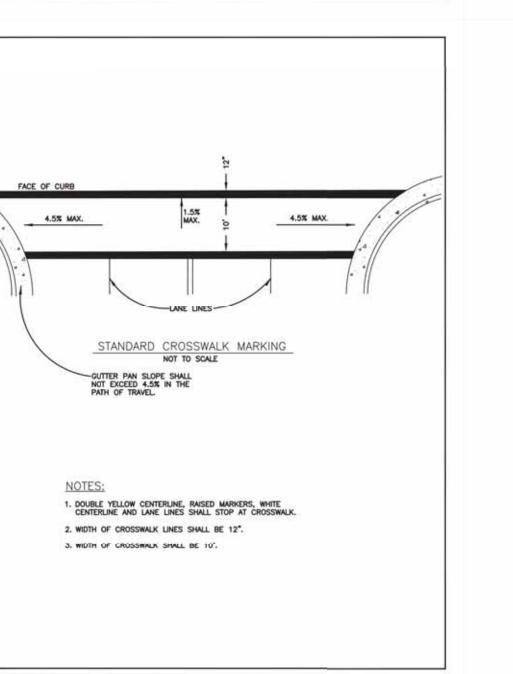

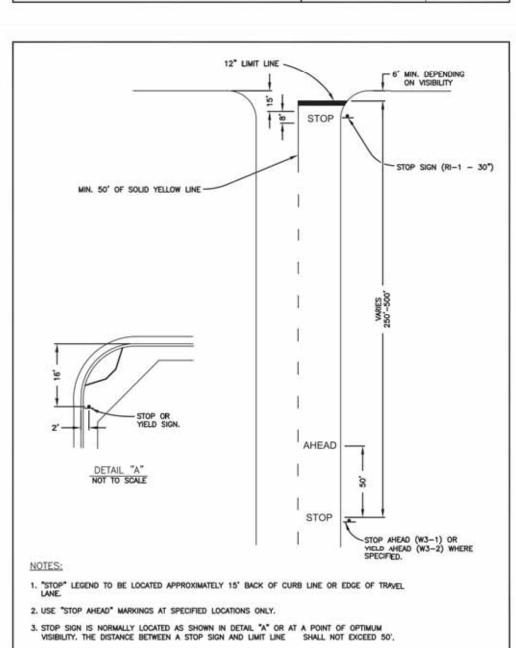

CITY of CORCORAN · Department of Public Works

PROVED BY: 03/01/17

ST-11


tandard Drawing for:


ST-10


STOP & YIELD

PAVEMENT MARKINGS


R/W 116"-124" 96"-106 56"-60" 56"-60"

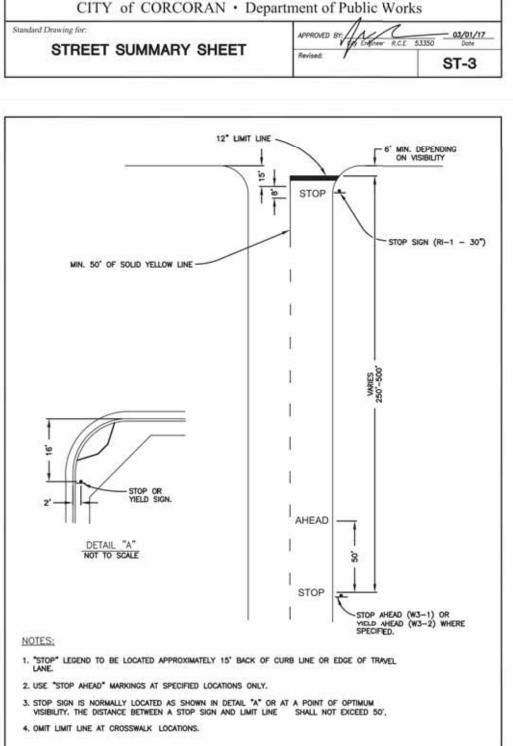


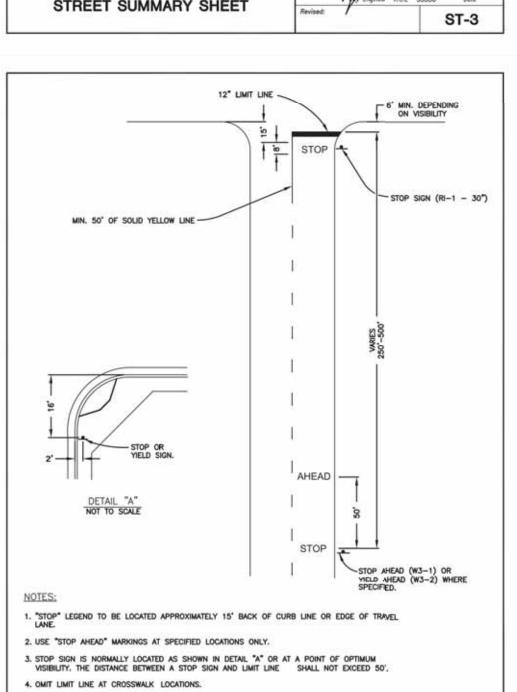

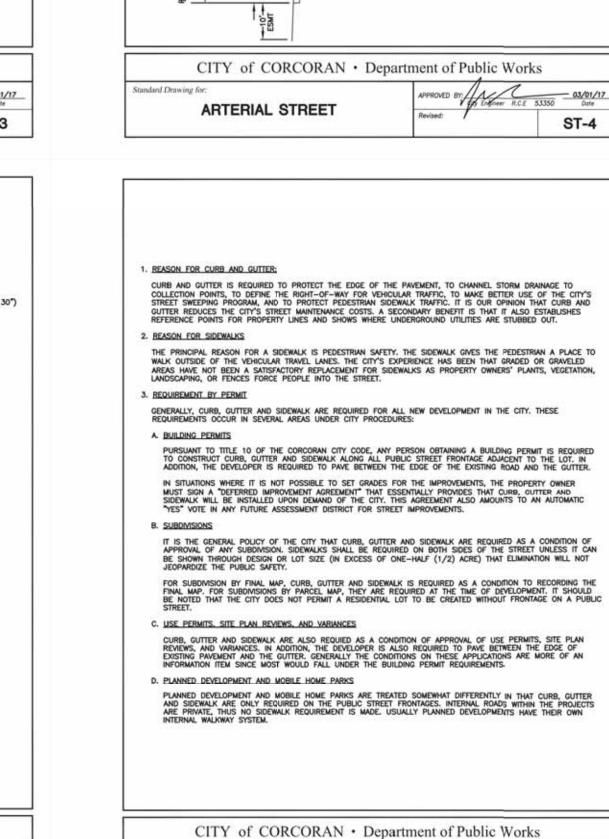

CONCRETE CRITERIA

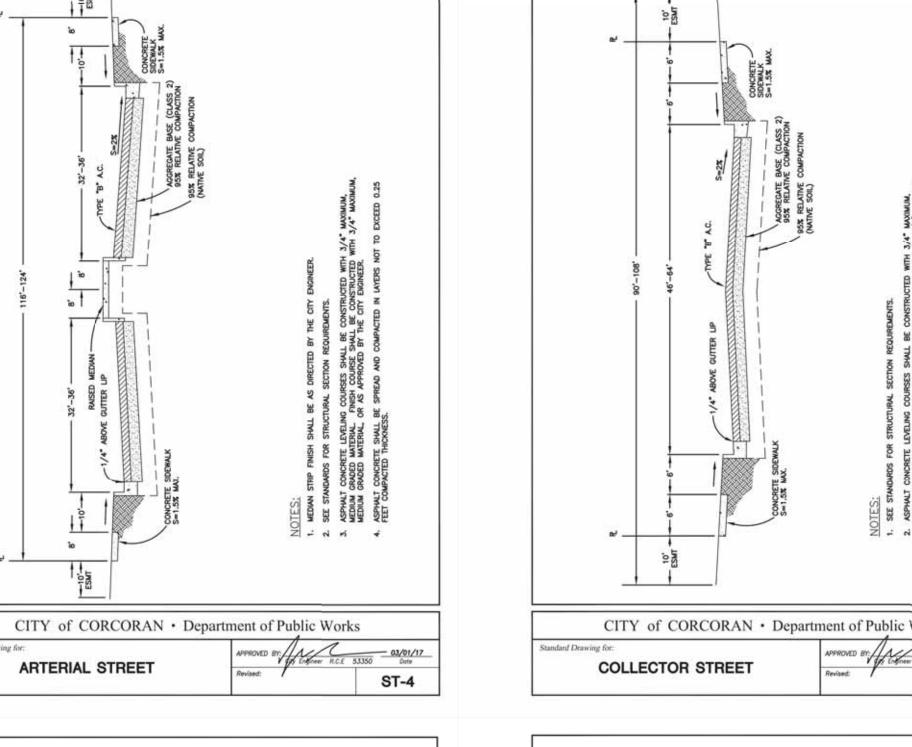

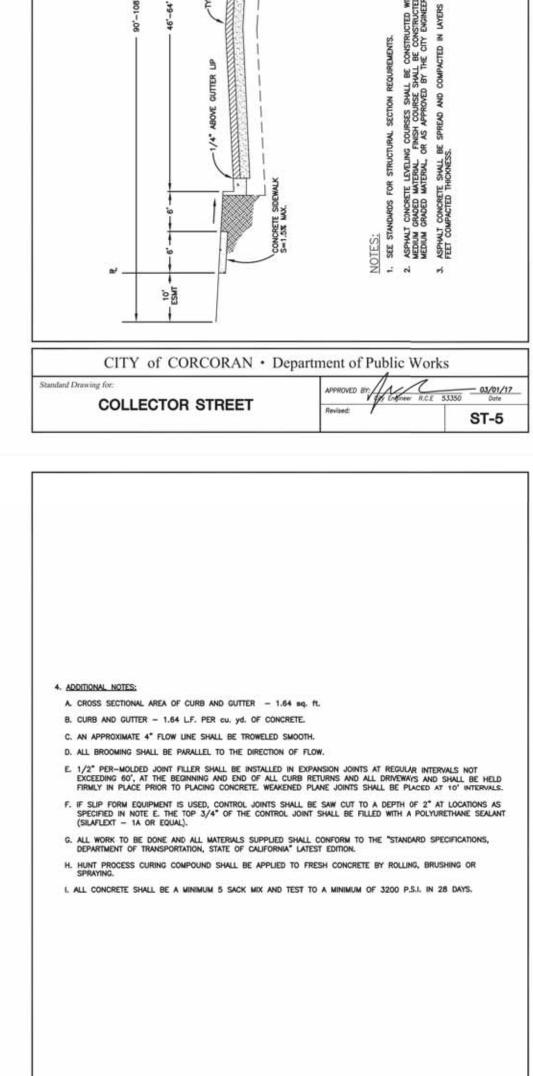

CITY of CORCORAN • Department of Public Works

53350 Dote

C-1A

tandard Drawing for:

C-1

CONCRETE CRITERIA





SIDEWALK IMPROVMENTS

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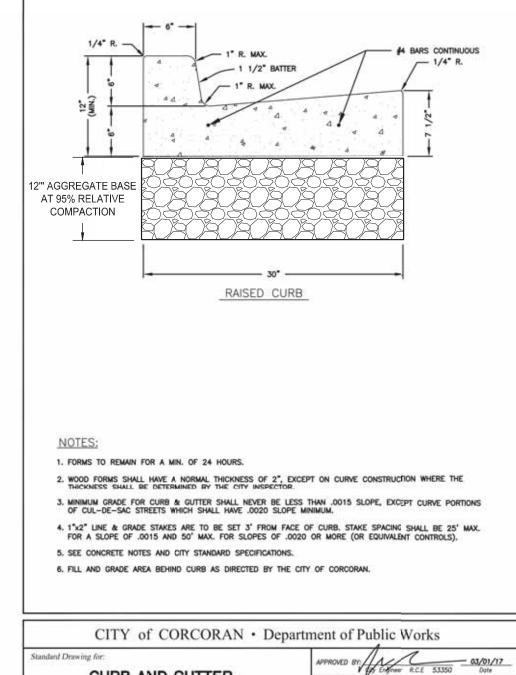
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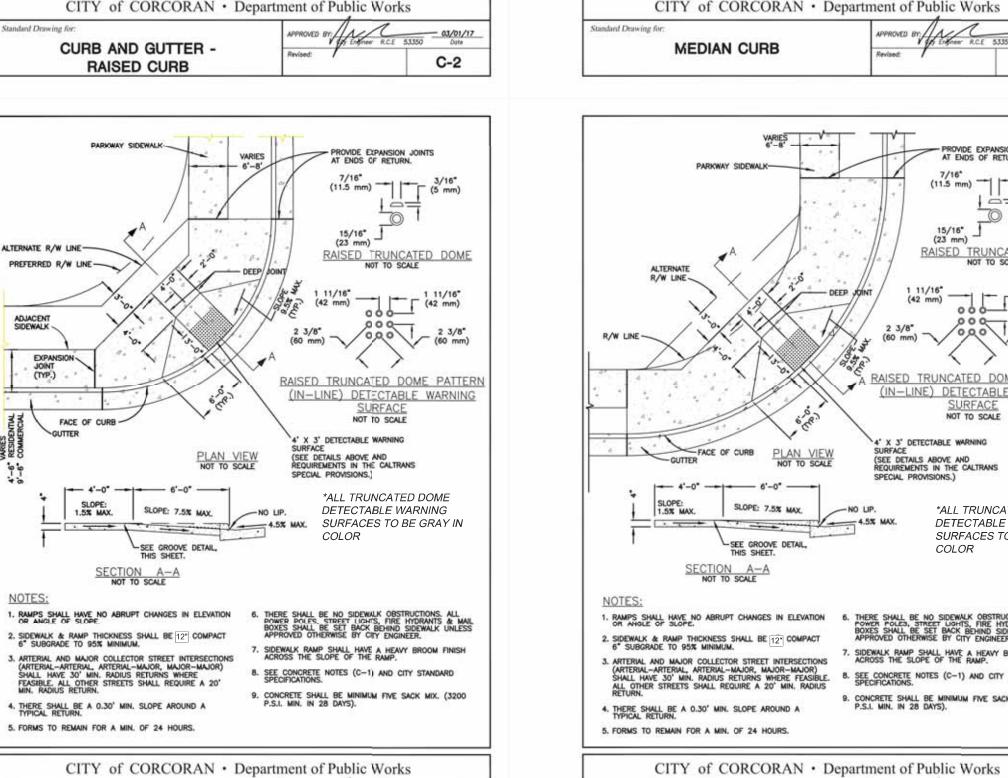


SHEET NO.


61




WHEELCHAIR RAMP DETAIL




C-6

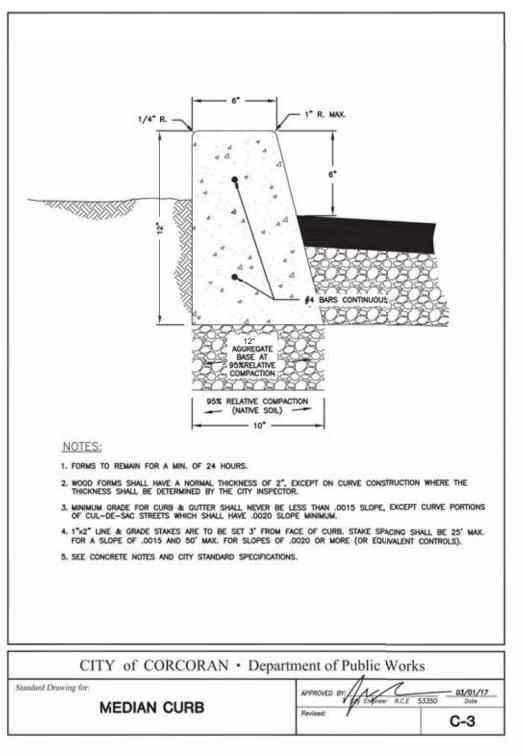


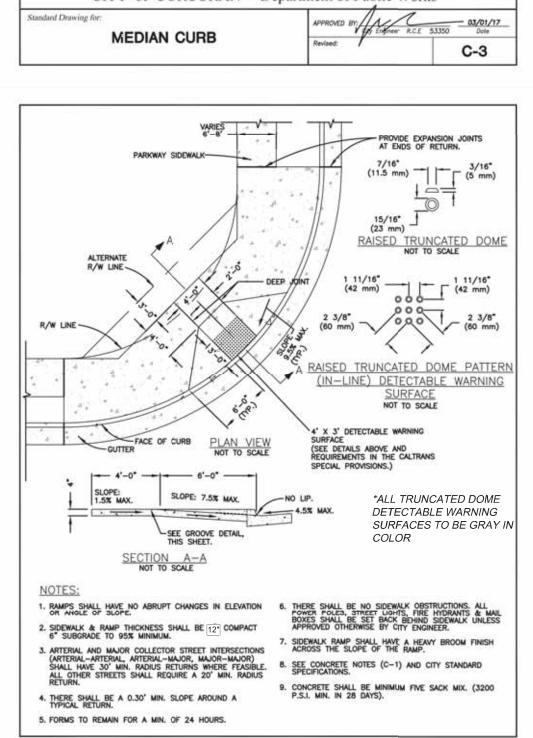



WHEELCHAIR RAMP DETAIL


(30 FOOT RADIUS RETURN)

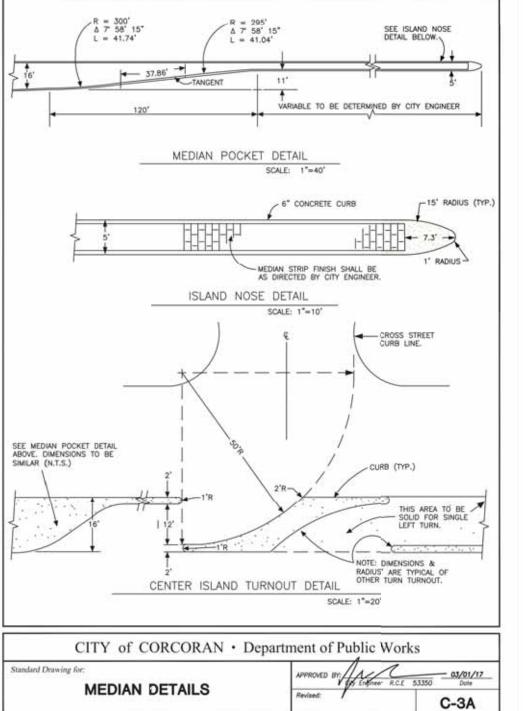


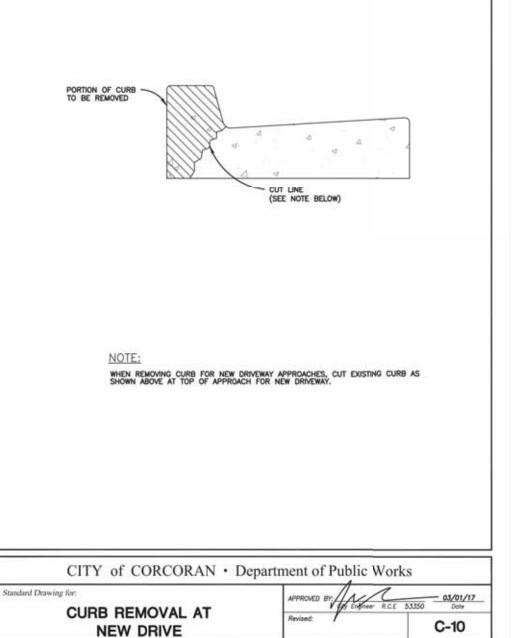

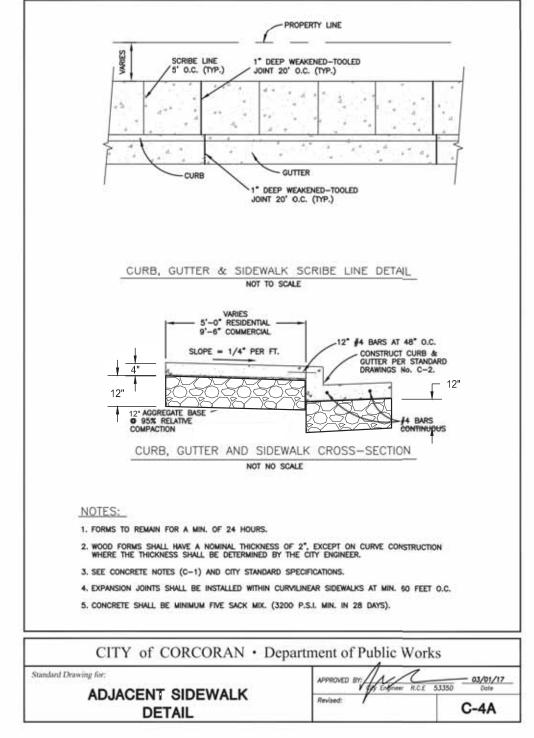

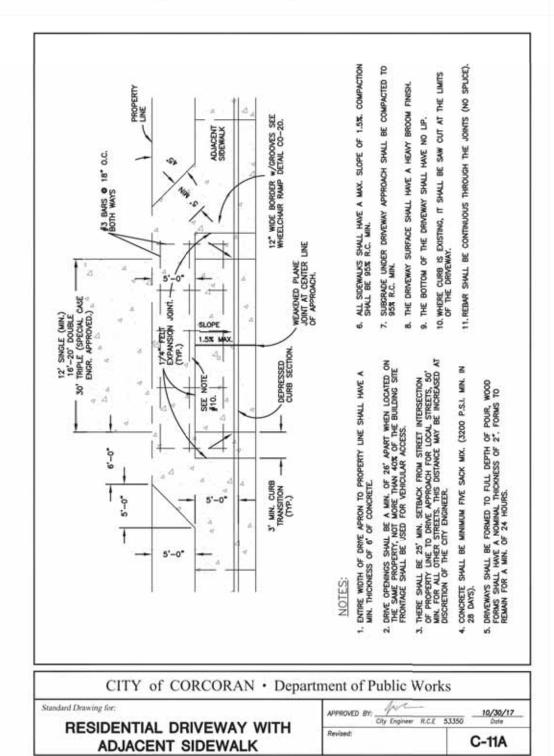

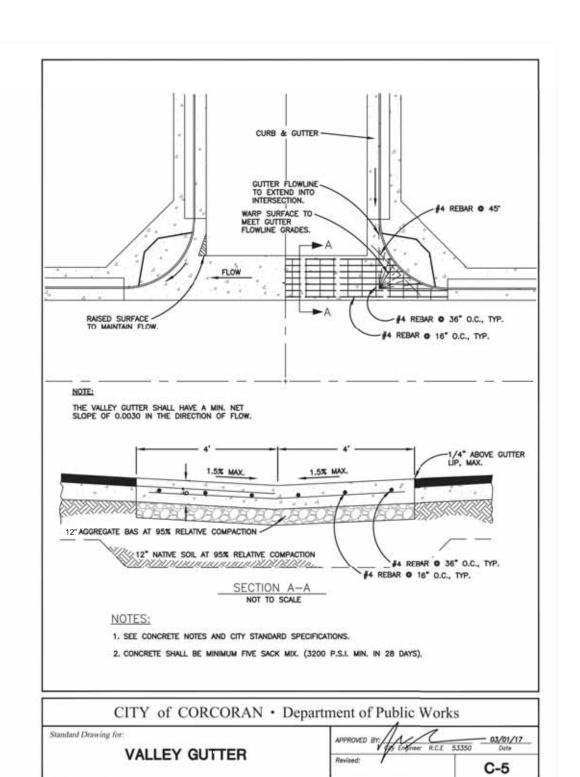

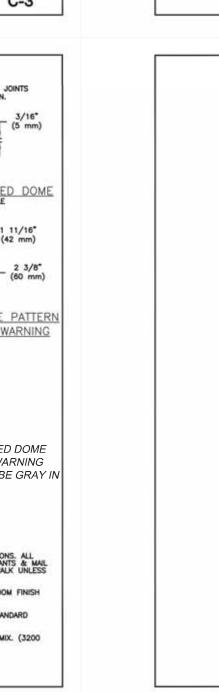

C-6A