Agenda Item 3

983 Maplewood Road Lot-in-Depth Setback Variance

Staff Report Vicinity Map Air Photos

Materials Submitted by Petitioner

Application
Statement of Intent
Plat of Survey – Existing Conditions
Proposed Site Plan
Proposed Elevations
Proposed Floor Plans
Proposed Landscape Plan
Site Plan – Buildable Area

Neighborhood Site Plan Existing and Proposed Streetscape Elevations

Elevation Overlays Renderings

Photographs – Existing Residence Neighborhood Photographs



STAFF REPORT AND RECOMMENDATION

TO:

Chairman Sieman and members of the Zoning Board of Appeals

DATE:

February 28, 2022

FROM:

Michelle E. Friedrich, Planning Technician

SUBJECT:

Lot-in-Depth Setback Variance

PROPERTY OWNER

Lorraine M. DeGrazia Trust Lorraine M. DeGrazia, 100% 2485 Waukegan Avenue Highland Park, IL 60035

PROPERTY LOCATION

983 Maplewood Road

ZONING DISTRICT

R4 – Single Family Residence

CONTRACT PURCHASER AND REPRESENTATIVE

Codfish Partners, LLC Tom Swarthout, 50% Tim Swarthout, 50% 778 N. Western Avenue Lake Forest, IL 60045

SUMMARY OF REQUEST

This is a request for approval of a lot-in-depth setback variance to allow construction of a new single family residence and attached garage. The existing residence is proposed for demolition. The demolition of the existing house and the design elements of the new single family residence and attached garage were reviewed and approved at the February Historic Preservation Commission meeting.

This property is located on the south side of Maplewood Road, accessed by a private lane informally known as "Codfish Alley." The property is on the west side of the private lane. The private lane serves seven homes. This property is part of Lot 258 of the Original Plat of Lake Forest, recorded in 1857. In 1885, emigrants from Newfoundland purchased the east half of Lot 258, 4.58 acres and developed an enclave of houses for fellow emigrants which became known as "Codfish Alley" in deference to the homeland they left behind. The development of Codfish Alley, a cluster of houses served by a narrow, private lane on what today are lots that are unusual in shape and size for this part of Lake Forest, long predated zoning regulations and subdivision approval processes. The properties along Codfish Alley are and have long been recognized by the City as legal non-conforming lots. As a result, any redevelopment of the properties along this lane, and most improvements, require variances because of

the establishment of this unique neighborhood early in the timeline of the development of Lake Forest.

FACTS

Compliance/Non-Compliance with Key Code Requirements

- The property does not comply with the minimum lot width requirements and therefore, is considered a lot in depth. (Lots in depth are parcels that do not have the minimum lot width required in the zoning district along a public or private street.)
- ❖ The property does not comply with the minimum lot size requirements.
- ❖ The proposed project complies fully with the lot coverage limitation.
- ❖ The proposed project complies fully with the building scale limitations.
- The proposed new single family residence and attached garage does not comply with the lot-in-depth setback requirements.

Physical, Natural or Practical Difficulties

- ❖ The "Codfish Alley" area is a unique neighborhood, developed in the late 1800's and early 1900's and located in one of the City's Local Historic Districts. This unique neighborhood with its unusual layout is significant to the community as a piece of Lake Forest's history.
- ❖ The property is 71 feet deep with 110 feet of frontage along the private lane. The size and configuration of the parcel makes it impossible to comply with today's 50 foot setback requirement for lots-in-depth. As noted above, the property is a legal non-conforming buildable lot because of its creation long before a Zoning Code and subdivision requirements were established in the City.
- ❖ This house and other homes in the neighborhood were constructed prior to the adoption of any zoning or subdivision requirements.
- Several of the homes along. "Codfish Alley" have received variances in the past as these older homes were renovated.
- ❖ The variance process is intended to support investment in properties where the application of today's zoning regulations is not reasonable, practical or possible as a result of historic patterns of development.

STAFF EVALUATION

This property is located within the R-4 zoning district. The property is considered a lot-in-depth by today's Zoning Code and the required setback from each property line is 50 feet. Application of the current setbacks would render this lot unbuildable.

The proposed house is sited generally in the location of the existing house and in some areas, is located further from the property lines than the existing residence. The proposed attached garage, at the west side of the property, is closer to the west property line than the existing residence however, the garage is proposed in this area to allow vehicles to back out of the garage without backing into the private lane. The current garage location is immediately adjacent to the private lane, presents the opportunity for conflict with cars traveling on the lane and pedestrians. As proposed, the new garage and driveway are adjacent to the garage and driveway on the property to the north, creating similarly used spaces side by side.

The setbacks of the proposed residence are similar to the pattern of homes along Codfish Alley. The proposed house and attached garage, is at the closest point:

- 6.5 feet from the east property line
- 11 feet from the west property line
- 26 feet from the north property line
- 28 feet from the south property line

No tree removal on the site is proposed and the petitioner submitted a landscape plan that meets the minimum requirements for a new residence. Further enhancement of the landscape plan is anticipated as the new house begins to take shape on the site and viable options for additional plantings are evaluated.

FINDINGS OF FACT

Based on review of the information submitted by the petitioners, site visits and an analysis of this request based on applicable portions of the Zoning Code, staff submits the following findings.


- 1. The variance if granted will not alter, and will help to preserve, the essential character of the subject property, the surrounding area or the larger neighborhood in which the property is located. Many of the homes in the neighborhood are two story structures and sited consistent with the proposed house.
- 2. The conditions upon which the variance is requested, the existing character of the streetscape, are generally unique to this property and this neighborhood and are not applicable to other properties in the same zoning district in other areas of the community.
- 3. The property is legal non-conforming. The property was created prior to the City's adoption of a Zoning Code and prior to the establishment of a process for subdividing property.
- 4. The existing residence is nonconforming as it was constructed prior to current zoning regulations. This hardship was not created by any current or former owner of the property but instead, results from a change to the zoning regulations after the neighborhood was established.
- 5. The variance requested will not impair light or ventilation to adjacent properties, increase congestion, endanger public safety, or substantially diminish property values. The existing residence is generally in the same location as the proposed new residence. The proposed improvements will enhance the value of the property and will be an improvement to the neighborhood. The location of the garage, away from the lane, is a safety improvement eliminating the need for vehicles to back out on to the access road.

PUBLIC COMMENT

Standard public notice of this request was provided by the City to surrounding property owners. Notice was also provided in the Lake Forester, the agenda was posted at five public locations and on the City's website. No correspondence has been received as of the date of this report.

RECOMMENDATION

Based on the findings presented above, recommend approval to the City Council of a lot-in-depth setback variance to allow a new single family residence and attached garage no closer than 6.5 feet to the east property line, 11 feet to the west property line, 26 feet to the north property line and 28 feet to the south property line, as depicted on the site plan presented to the Board.

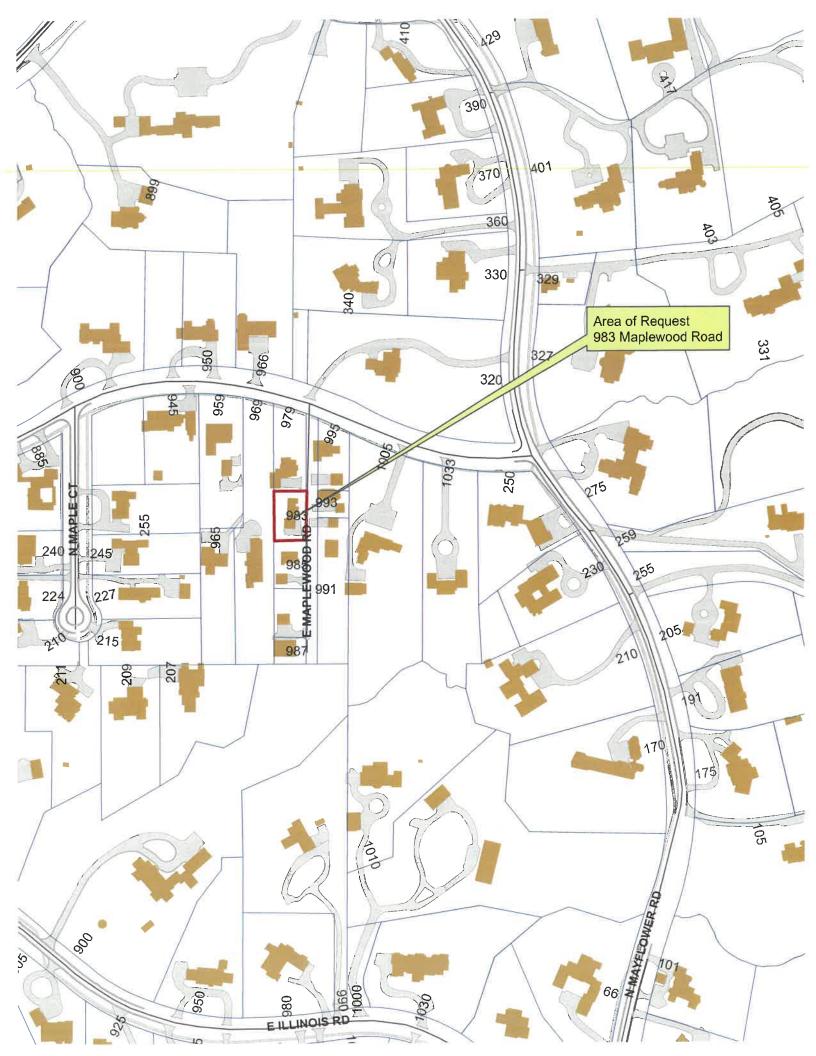







THE CITY OF LAKE FOREST ZONING BOARD OF APPEALS APPLICATION OF ZONING VARIANCE

PROJECT ADDRESS 983	Maplewood Rd.	
	R-4	
ZONING DISTRICT		
Property Owner (s)	Name Lorrai	ine M. DeGrazia Trust
(may be different from project address) Address		5 Waukegan Avenue, Highland Park, IL 60035
(ma) so amorom morriprojest and the	Phone 847.4	33.0370 Fax
		razia@sbcglobal.net
Applicant/Representative	Name Tom S	Swarthout / The Highview Group
Application to proceed the second	Title Presid	dent
(if different from Property Owner)	Address	N. Western Ave., Lake Forest, IL 60045
	Phone 847.98	
	Email tswarth	out@highviewgroupltd.com
Beneficial Interests		Staff Reports are Available the Friday before the Meeting
Corporation	See Exhibit A	Email Report: Owner Representative
Partnership	See Exhibit B	Fax Report: Owner Representative
Trust, land or other	See Exhibit C	Pick Up Report: Owner Representative
Signatures		the state of the s
I have read the complete application be scheduled for a public hearing will	packet and understand ben a determination ha	nd the variance process and criteria. I understand that this matter will as been made that my application is complete.
	20	
Serraes M's	Lorgen	traislee January 18, 202
Owner /	107	Date ()
7	1	
Owner		Date /
	-	
1 the		1/18/2022
Applicant/Representative		/ Date

TRUST OWNERSHIP (EXHIBIT C)

Please list the Trust number and name and address of the Trustee, as well as the names and addresses of all beneficiaries of the Trust, together with their respective interests in the Trust. The application shall be further verified by the applicant in his capacity as Trustee or by the beneficiary as a beneficial owner of an interest in the Trust and the application shall be signed individually by as many beneficiaries as are necessary to constitute greater than 50% ownership of the beneficial interest of the trust.

TRUST NUMBER PEYSONON Social Secur	TRUSTEE INFORMATION
Lorraine M. De Grazia Trust	Name Laraine M. DeGrazia
Revocable Trust	Firm
Lorraine M. De Grazia, Trustes	Address Highland Park, Ill 6003
,	Phone 847-433-0370
Benaficiaries	J8 901 311712
Name Lorraine M. DeGrazia	Name
2485 Waukegan Ave. Address Highland Park Dl 60035	Address
Trust Interest /00 %	Trust Interest%
Name	Name
Address	Address
Trust Interest %	Trust Interest %
Name	Name
Address	Address
Trust Interest . %	Trust Interest%

PARTNERSHIP OWNERSHIP (EXHIBIT B)

Please list all partners, general and/or limited, with an individual or beneficial interest of 5% or greater.

Name	Codfish Partners LLC		Name	
Address	778 N. Western Ave., Lake Forest, Il 60045		Address	
Ownersh	ip Percentage	%	Ownership Percentage	%
Name	Tom Swarthout		Name Tim Swarthout	
Address	778 N. Western Ave., Lake Forest, II 60045		778 N. Western Ave., Address Lake Forest, II 60045	
	ip Percentage	%	Ownership Percentage 50	%
Name			Name	
Address			Address	
Ownersh	ip Percentage	%	Ownership Percentage	%
Name			Name	
Address			Address	
Ownersh	nip Percentage	%	Ownership Percentage	%
Name			Name	
Nante				
Address			Address	%
Ownersh	nip Percentage	%	Ownership Percentage	



983 Maplewood rd

Lake Forest, Illinois

City of Lake Forest - Zoning Board of Appeals Statement of Intent & Zoning Implications & Standards for Variance

January 21, 2022

STATEMENT OF INTENT

The proposed house at 983 Maplewood Road sits close to the lane, along with the others flanking the 30' wide easement road locally known as "Codfish Alley". This enclave's human scale with a narrow roadway flanked by comfortably sized houses is important. It provides an opportunity for residents to engage with their neighbors. This was the story early on when the existing structures were built and retaining that scale and relationship to the lane is important.

Variances being requested:

1. Setbacks:

The proposed house is in the R-4 Zoning District. Conforming to the current zoning setbacks is impossible because the small lots on the lane were established a century prior to the establishment of the current R-4 zoning.

Standards of review for Architectural and Site Design Review:

Standard 1 - The variance, if granted, will not alter the essential character of the subject property, the surrounding area, or the larger neighborhood in which the property is located.

The houses on "Codfish Alley" are all closely sited adjacent to the 30' easement. The conditions under which the proposed house was designed are unique to the existing development on the lane. And respect the existing setbacks on the lane which range from 2'-26', far less than the 50' setback required by the current zoning ordinance.

Standard 2 - The conditions upon which a petition for variance are based are unique to the property for which the variance is sought, and are not applicable, generally, to other property with the same zoning classification.


The existing lot area is 7,824 sf, which provides challenges. The required setbacks for the R-4 zoning classification are based upon sites with a min lot area of 60,000 sf. All the houses on codfish lane were impacted by the changes in the zoning classification.


Standard 3 - The alleged difficulty or hardship in conforming with the requirements of this chapter is caused by this chapter and has not been created by the actions of any persons presently or formally having and interest in the property.

The lot was plotted in the 19th century. The zoning codes and requirements are significantly different in 2021. "Codfish Alley" was developed, over a century ago, into significantly smaller lots than could be created today under the requirements of the R-4 zoning classification. The current zoning classification as R-4 creates the difficulty in conforming with the requirements of the zoning ordinance.

Standard 4 - The proposed variance will not impair an adequate supply of light and air to adjacent property, or substantially increase the congestion of the public streets, or increase the danger of fire, or endanger the public safety, or substantially diminish or impair property values within the neighborhood

The siting of the proposed house was deeply informed by the footprint of the existing house. As such there will be little effect on the supply of light and air to the adjacent property. With respect to the potential increase of congestion on the lane, the proposed structure will do the opposite. It will reduce the current nuisance parking on the lane due to the division of the existing house into 3 apartments. The proposed house will reduce the danger of fire due to the sense of ownership one has for their own home compared to that of a renter in an apartment. The proposed house will add significant value compared to the existing dilapidated apartment house.

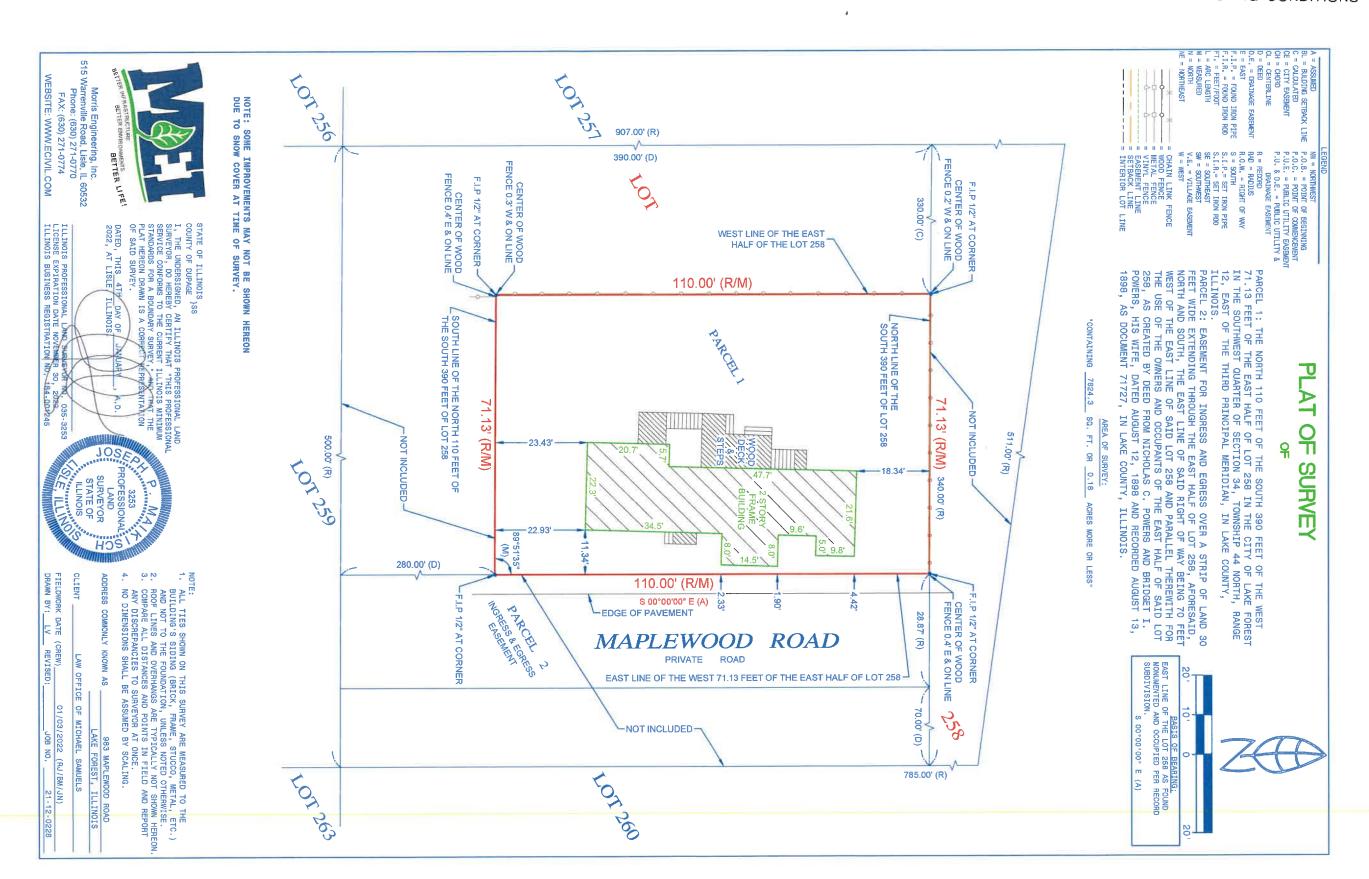

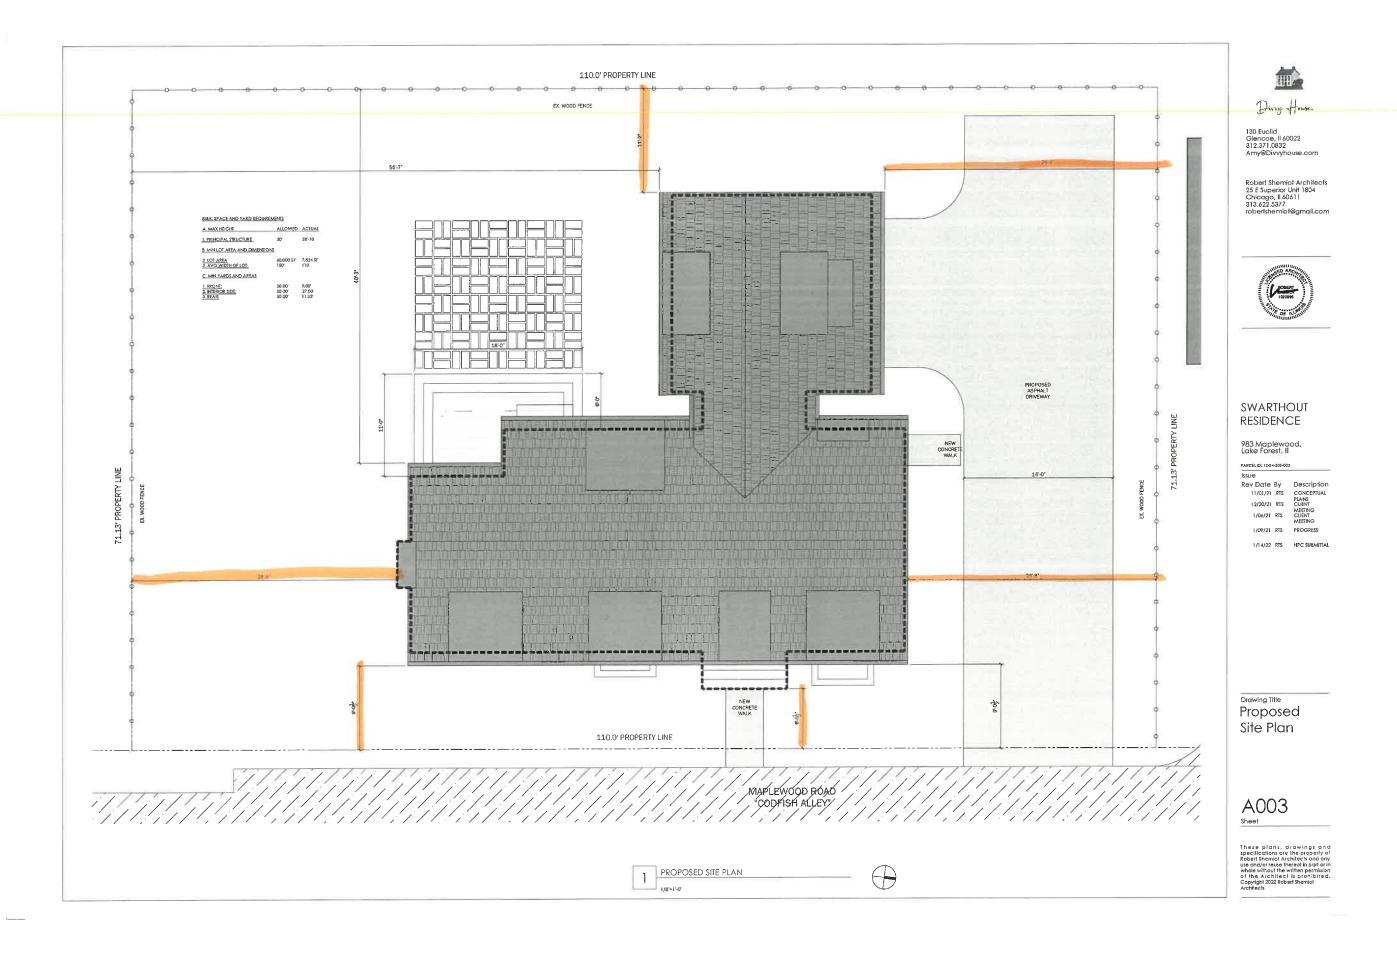



130 Euclid Glencoe, II 60022 312.371.0832 Amy@Divvyhouse.com

Robert Shemiot Architects 25 E Superior Unit 1804 Chicago, II 6061 313.622.5377 robertshemIot@gmail.com



SWARTOUT RESIDENCE

983 Maplewood, Lake Forest, II

PARCEL ID; 12-34-305-033

Rev Date By Description
11/01/21 RTS CONCEPTUAL
PLANS
12/20/21 RTS CUENT
MEETING
LUENT MEETING
LUENT

1/09/21 RTS **PROGRESS**

1/14/21 RTS HPC SUBMITTAL 1/21/21 RTS ZBA SUBMITTAL

Drawing Title Exterior Elevation

A200

Sheet

These plans, drawings and specifications are the property of Robert Shemiol Architects and any use and/or reuse thereof in part or in whole without the written permission of the Architect is prohibited. Copyright 2022 Robert Shemiol Architects



1/4"=1'-0"





130 Euclid Glencoe, II 60022 312.371.0832 Amy@Divvyhouse.com

Robert Shemiot Architects 25 E Superior Unit 1804 Chicago, II 6061 i 313.622.5377 robertshemiot@gmail.com



SWARTOUT RESIDENCE

983 Maplewood, Lake Forest, Il

PARCEL ID: 12-34-305-033 Issue

Rev Date By Description 11/01/21 RTS CONCEPTUAL
PLANS
12/20/21 RTS CUENT
MEETING
1/06/21 RTS CUENT
MEETING

1/09/21 RTS

1/21/21 RTS ZBA SUBMITTAL

Drawing Title Exterior Elevation

A202

Sheet

These plans, drawings and specifications are the property of Robert Shemiol Architects and any use and/or reuse thereof in part or in whole without the written permission of the Architect is prohibited. Copyright 2002 Robert Shemiot Architects





Dury Hour

130 Euclid Glencoe, II 60022 312.371.0832 Amy@Divvyhouse.com

Robert Shemiot Architects 25 E Superior Unit 1804 Chicago, II 6061 I 313.622.5377 robertshemiot@gmail.com



SWARTOUT RESIDENCE

983 Maplewood, Lake Forest, Il

PARCEL ID: 12-34-305-033

Rev Date By Description
11/01/21 RTS CONCEPTUAL
12/20/21 RTS CONCEPTUAL
12/20/21 RTS CONCEPTUAL
1/06/21 RTS CUENT
MEETING
1/09/21 RTS PROGRESS

1/14/21 RTS HPC SUBMITTAL
1/21/21 RTS ZBA SUBMITTAL

Drawing Title
Exterior
Elevation

A201

Sheet

These plans, drawings and specificalians are the property of Robert Shemiol Architects and ony use and/or reuse thereof in part or in whole without the written permission of the Architect is prohibited. Copyright 2022 Robert Shemiot Architects





130 Euclid Glencoe, II 60022 312,371,0832 Amy@Divvyhouse.com

Robert Shemiot Architects 25 E Superior Unit 1804 Chicago, Il 6061 | 313.622.5377 robertshemiot@gmail.com



SWARTOUT RESIDENCE

983 Maplewood, Łake Forest, II

PARCEL ID: 12-34-305-033 Issue

Rev Date By Description

11/01/21 RTS CONCEPTUAL
PLANS
12/20/21 RTS CLIENT
MEETING
1/06/21 RTS CLIENT
MEETING 1/09/21 RTS PROGRESS

1/14/21 RTS HPC SUBMITTAL 1/21/21 RTS ZBA SUBMITTAL

Drawing Title Exterior Elevation

A203

Sheet

These plans, drawings and specifications are the property of Robert Shemiol Architects and any use and/or reuse thereof in part or in whole without the written permission of the Architect is prohibited. Copyright 2022 Robert Shemiol Architects



130 Euclid Glencoe, II 60022 312,371.0832 Amy@Divvyhouse.com

Robert Shemiot Architects 25 E Superior Unit 1804 Chicago, Il 6061 I 313.622.5377 robertshemiot@gmail.com



SWARTOUT RESIDENCE

983 Maplewood, Lake Forest, II

PARCEL ID: 12-34-305-033

Rev Date By Description
11/01/21 RTS CONCEPTUAL
PLANS
12/20/21 RTS CUBNT
MEETING
LUBNT
MEETING
LUBNT
MEETING

1/09/21 RTS PROGRESS 1/14/21 RTS HPC SUBMITTAL


1/21/21 RTS ZBA SUBMITTAL

Drawing Title Basement Floor Plan


A100

Sheet

These plans, drawings and specificalions are the property of Robert Shemid Architects and any use and/or reuse thereof in part or in whole without the written permission of the Architect is prohibited. Copyright 2022 Robert Shemiol Architects

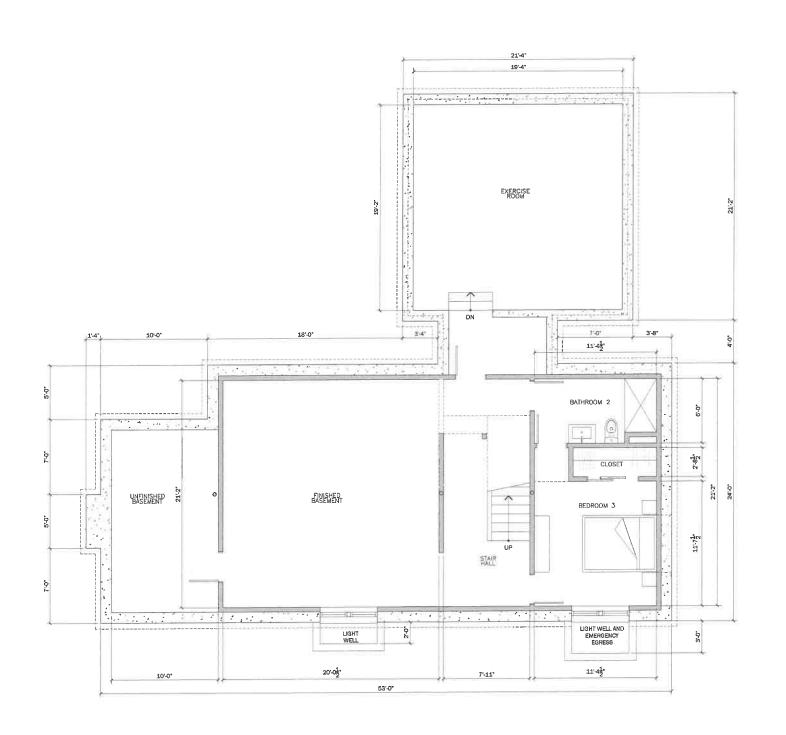

1/4"=1'-0"

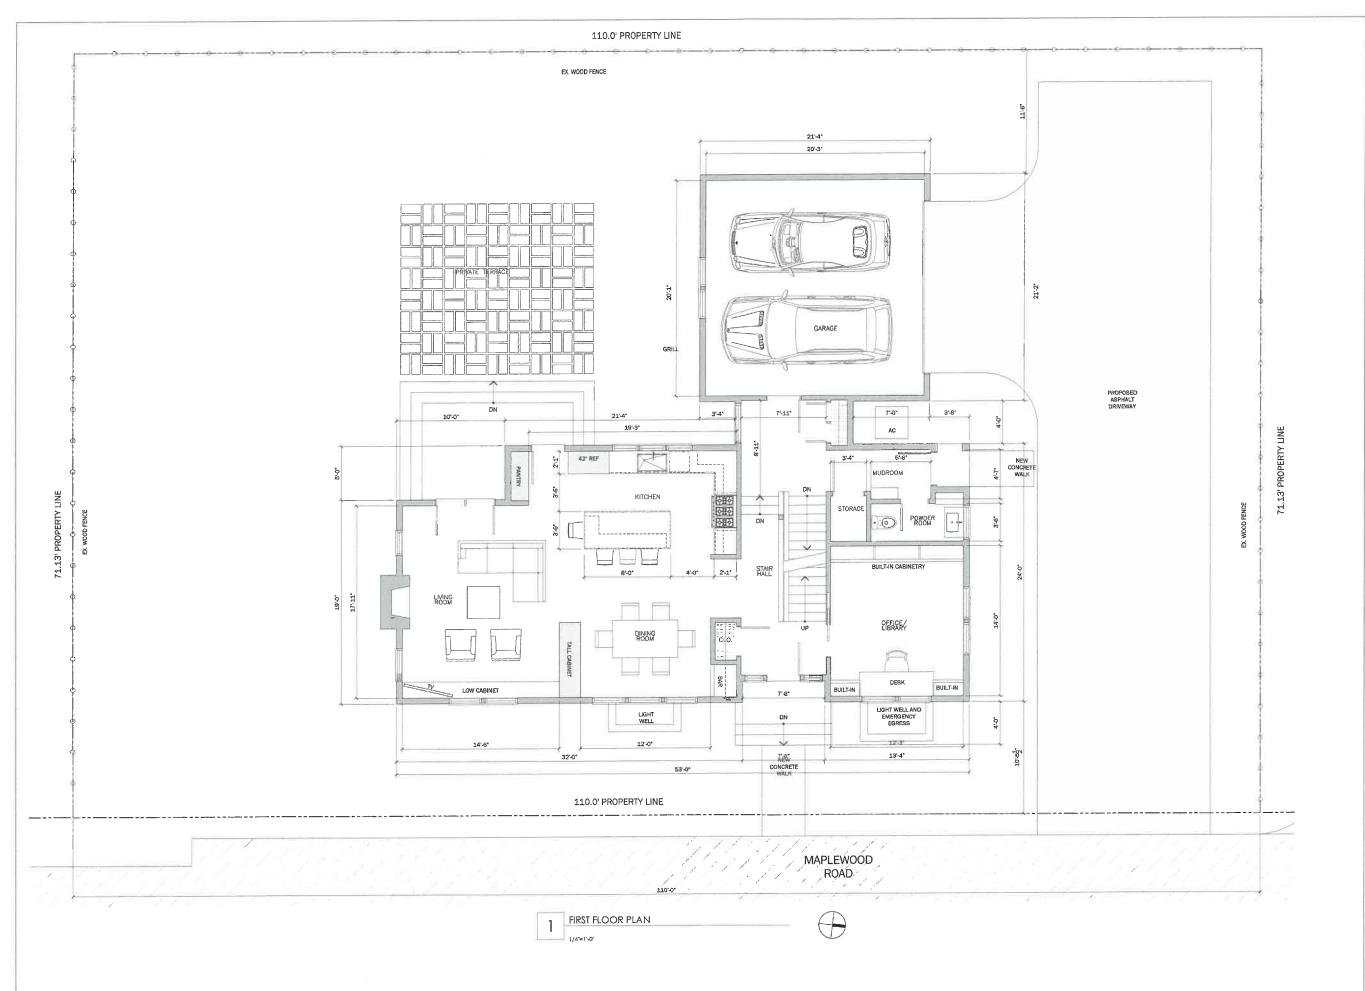



Dirry Hou

130 Euclid Glencoe, II 60022 312.371.0832 Amy@Divvyhouse.com

Robert Shemiot Architects 25 E Superior Unit 1804 Chicago, Il 6061 1 313.622.5377 robertshemiot@gmail.com



SWARTOUT RESIDENCE

983 Maplewood, Łake Forest, II

PARCEL ID: 12-34-305-033

| Issue | Rev Date By | Description | CONCEPTUAL | PLANS | 12/20/21 | RTS | CUENT | MEETING | CUENT | MEETING | CUENT | MEETING | CUENT | MEETING | CUENT | CU

1/09/21 RTS PROGRESS


1/14/21 RTS HPC SUBMITTAL 1/21/21 RTS ZBA SUBMITTAL

Drawing Title
First Floor Plan

A101

Sheet

These plans, drawings and specifications are the property of Robert Shemiol Architects and any use and/or reuse thereof in part or in whole without the witten permission of the Architect is prohibited. Copyright 2022 Robert Shemiol Architects

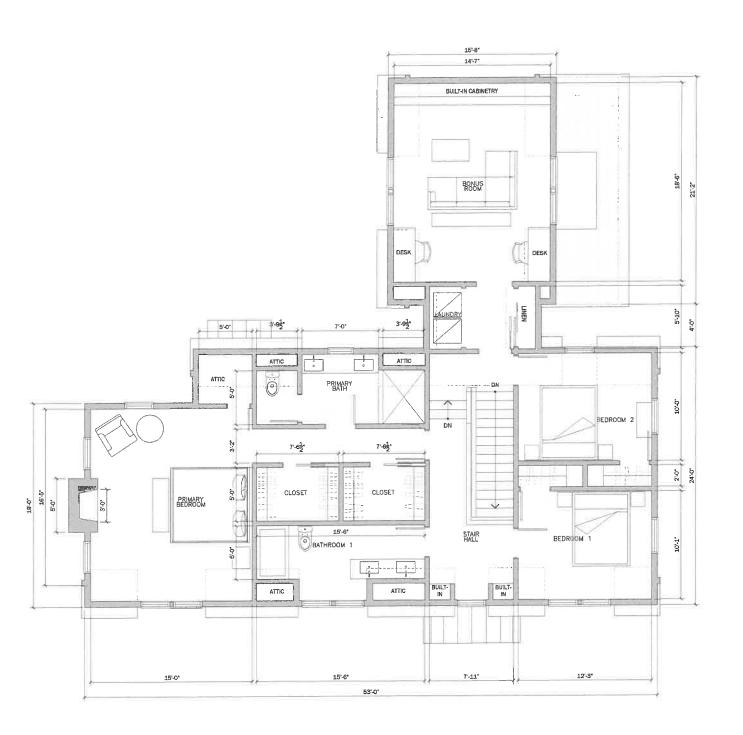



130 Euclid Glencoe, II 60022 312.371.0832 Amy@Divvyhouse.com

Robert Shemiot Architects 25 E Superior Unit 1804 Chicago, Il 60611 313.622.5377 robertshemiot@gmail.com



SWARTOUT RESIDENCE

983 Maplewood, Lake Forest, Il

PARCEL ID: 12-34-305-033

Rev Date By Description 11/01/21 RTS CONCEPTUAL
PLANS
12/20/21 RTS CUENT
MEETING
1/06/21 RTS CUENT
MEETING

PROGRESS

1/14/21 RTS HPC SUBMITTAL 1/21/21 RT\$ ZBA SUBMRITAL

Drawing Title Second Floor Plan


A102 Sheet

These plans, drawings and specifications are the property of Robert Shemich Architects and any use and/or reuse thereof in port or in whale without the written permission of the Architect is prohibited. Copyright 2022 Robert Shemiot Architects


SECOND FLOOR PLAN

1/4"=1'-0"



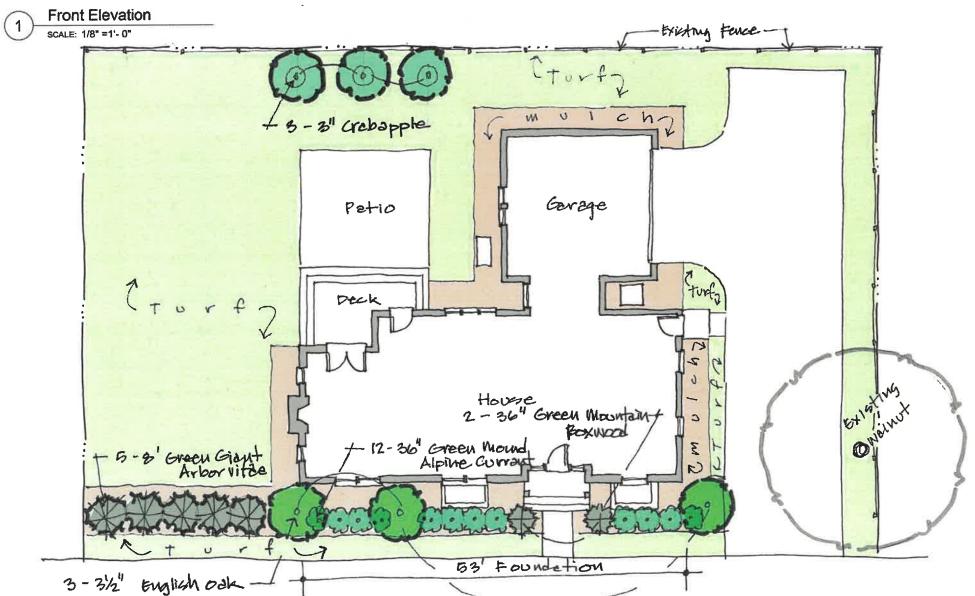

Plant List				
Qty.	Botanical Name	Common Name	Size	Spec.
Shade Trees				
3	Quercus robur Fastiglata	Columnar English Oak	3 1/2"	Caliper
Omamental 1	Frees			
3	Malus 'Schmidtcutleaf' Golden Raindrops	Rain Orop Crabapple	3"	Caliper
Evergreen To	ees			
5	Thujia 'Green Glant'	Green Glant Arborvitae	10'	Height
Evergreen Sh	rubs			
2	Busus x 'Green Mountain'	Green Mountain Baswood	36*	88
Decidious Sh	rubs			
12	Ribes Alpinum 'Green Mound'	Green Mound Alpine Currant	36"	86

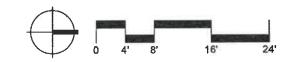


300 Rockland Road | Lake Bluff, Illinois 60045 Phone: 847.234.2172 | Fax: 847.234.2754 w w w . m a r i a n i l a n d s c a p e . c o m

983 Maplewood Rd. - Lake Forest, IL

Project No: SWA22011

01.14.2022 Revised 02.04.2022

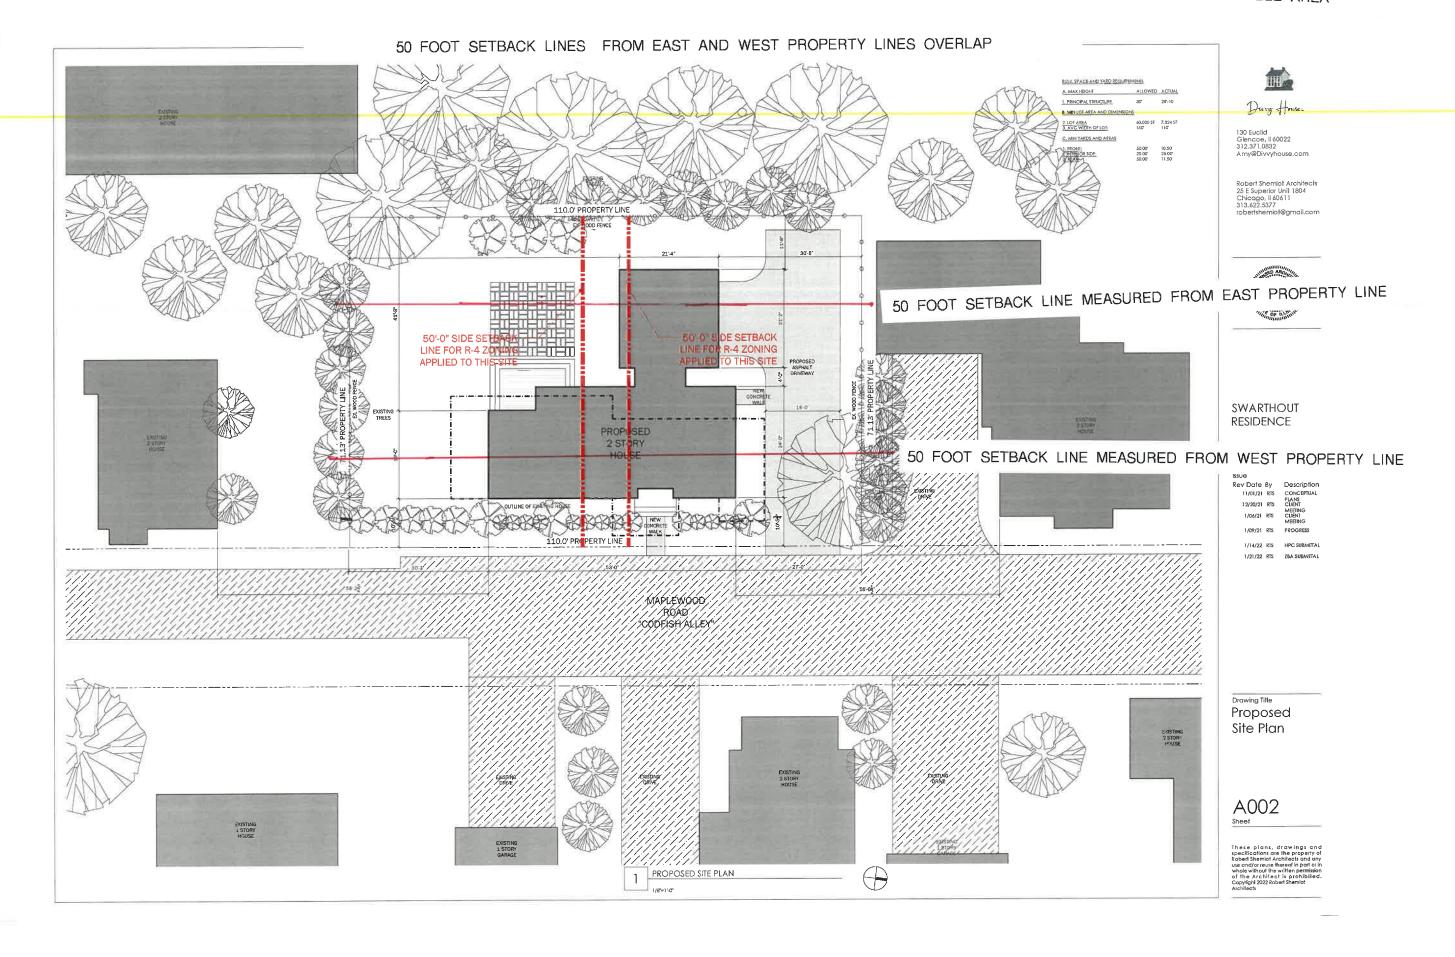

NEIGHBORHOOD SITE PLAN BULK SPACE AND YARD REQUIREMENTS A. MAX HEIGHT ALLOWED ACTUAL I. PRINCIPAL STRUCTURE B. MIN LOT AREA AND DIMENSIONS 2. LOT AREA 3. AVG WIDTH OF LOT: 130 Euclid Glencoe, II 60022 312.371.0832 Amy@Divvyhouse.com C. MIN YARDS AND AREAS 50,00' 10,50' 20,00' 25,00' 50,00' 11,50' Robert Shemiot Architects 25 E Superior Unit 1804 Chicago, Il 60611 313.622.5377 robertshemiot@gmail.com 110.0' PROPERTY LINE EX WOOD FENCE **SWARTOUT** EXISTING 2 STORY HOUSE RESIDENCE PROPOSED 2 STORY 983 Maplewood, Lake Forest, II HOUSE PARCEL ID: 12-34-305-033 Rev Date By Description CONCEPTUAL PLANS CLIENT MEETING CLIENT MEETING 11/01/21 RTS 12/20/21 RTS 110.0' PROPERTY LINE 1/14/21 RTS HPC SUBMITTAL MAPLEWOOD ROAD Drawing Title Proposed Site Plan EXISTING 2 STORY HOUSE EXISTING DRIVE A002 Sheet EXISTING 1 STORY HOUSE

PROPOSED SITE PLAN

1/8"=1'-0"

EXISTING 1 STORY GARAGE

These plans, drawings and specifications are the property of Robert Shemiol Architects and any use and/or reuse thereof in part or in whole without the written permission of the Architect is prohibited. Copyright 2022 Robert Shemiot Architects

EXISTING AND PROPOSED STREETSCAPE ELEVATION



Robert Shemiot Architects 25 E Superior Unit 1804 Chicago, II 60611 313.622.5377 robertshemiot@gmail.com



SWARTOUT RESIDENCE

983 Maplewood, Lake Forest, II

PARCEL ID: 12-34-305-033

Rev Date By Description

11/01/21 RTS CONCEPTUAL
PLANS
12/20/21 RTS CLIENT
MEETING
1/06/21 RTS CLIENT
MEETING

PROGRESS 1/14/21 RTS HPC SUBMITTAL

1/21/21 RTS ZBA SUBMITTAL

Drawing Title Streetscape Elevation

A205

Sheet

These plans, drawings and specifications are the property of Robert Shemiol Architects and any use and/or reuse thereof in part or in whole without the written permission of the Architect Is prohibited. Copyright 2022 Robert Shemiol Architects.



2 EAST ELEVATION - PROPOSED STREETSCAPE 1/8'=1'-0'



EAST ELEVATION - EXISTING STREETS CAPE

1/8"=1'-0"



1 VIEW LOOKING NORTHWEST



130 Euclid Glencoe, II 60022 312.371.0832 Amy@Divvyhouse.com



2 VIEW LOOKING WEST



983 Maplewood, Lake Forest, Il

Issue		
Rev Date	Ву	Description
11/01/21	RTS	CONCEPTUA PLANS
12/20/21	RTS	CLIENT
1/06/21	RIS	CLIENT MEETING
1/09/21	RTS	PROGRESS
1/14/22	RTS	HPC SUBMITT
1/21/22	RTS	ZBA SUBMITT

Drawing Title
Renderings

A600 Sheet

These plans, drawings and specifications are the property of Robert Shemiol Architects and any use and/or reuse thereof in port or in whole without the witten permission of the Architect is prohibited. Copyright 2022 Robert Shemiot Architects



3 VIEW LOOKING SOUTHWEST



Photo 1: from street, looking southwest



Photo 5: rear, west elevation



Photo 9: gable to wing intersection, looking southwest



Photo 13: backyard, looking south



Photo 2 from street, looking northwest



Photo 6: side, south elevation



Photo 10: rear of garage, looking northeast



Photo 14: side yard, looking east



hoto 3: front, east elevation



Photo 7: front of house, looking northwest at garage



Photo 11: backyard, looking north



Photo 15: backyard shed, looking west




Photo 4: north, side elevation



Photo 8: front entry door and stair, looking northwest



Photo 12: rear deck, looking south

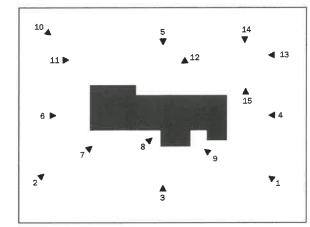

Keyplan



130 Euclid Glencoe, II 60022 312.371.0832 Amy@Divvyhouse.com

Robert Shemiot Architects 25 E Superior Unit 1804 Chicago, Il 60611 313.622.5377 robertshemiot@gmail.com

983 Maplewood, Lake Forest, II

Issue	
Rev Date By 12/20/21 RTS	Description CONCEPTUAL PLANS

Drawing Title
Photo Board



Sheet

These plans, drawings and specifications are the property of Robert Shemiol Architects and any use and/or reuse thereof in part or in whole without the withen permission of the Architect is prohibited. Copyright 2021 Robert Shemiol Architects

NEIGHBORHOOD PHOTOGRAPHS



Photo 1: 995, front, looking north



Photo 5: 979, front, side, and garage, looking southeast



Photo 9: 991, front, looking west

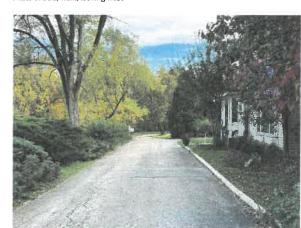


Photo 13: street view, looking north



Photo 2: 995, side, looking west



Photo 6: 993, front and side, looking southwest



Photo 10: 991, front, looking west



Photo 14: street view looking south



Photo 3: 979, front and side, looking northeast



Photo 7: 993, front, looking west



Photo 11: 991, front, looking southwest

Keyplan




Photo 4: 979, front, looking east



Photo 8: 993, garage, looking west



Photo 12: 985, front and garage looking east

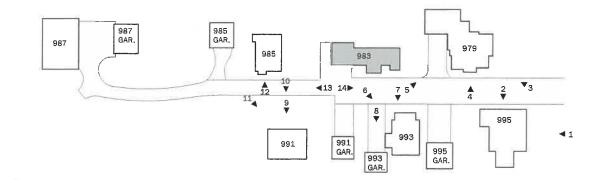

130 Euclid Glencoe, Il 60022 312.371.0832 Amy@Divvyhouse.com

Robert Shemiot Architects 25 E Superior Unit 1804 Chicago, Il 60611 313.622.5377 robertshemiot@gmail.com

983 Maplewood, Lake Forest, II

Rev Date By Description
12/20/21 RTS CONCEPTUAL
PLANS

Drawing Title Photo Board

A800

These plans, drawings and specifications are the property of Robert Shemiol Architects and any use and/or reuse thereof in part or in whole without the written permission of the Architect Is prohibited. Copyright 2021 Robert Shemiot Architects.

Agenda Item 4

471 Illinois Road Lot-in-Depth Setback Variance

Staff Report Vicinity Map Air Photos

Materials Submitted by Petitioner
Application
Statement of Intent
Plat of Survey
Proposed Site Plan
Proposed Elevations
Proposed Floor Plans
Existing Elevations
Existing Floor Plans
Renderings
Photographs

Correspondence



STAFF REPORT AND RECOMMENDATION

TO: Chairman Sieman and members of the Zoning Board of Appeals

DATE: February 28, 2022

FROM: Michelle E. Friedrich, Planning Technician

SUBJECT: Lot-in-Depth Setback Variance

PROPERTY OWNER

Alan and Angella Koncarevic 471 F. Illinois Road

471 E. Illinois Road Lake Forest, IL 60045 PROPERTY LOCATION

471 E. Illinois Road

ZONING DISTRICT

R1 – Single Family Residenc 9,375 SF minimum lot size

SUMMARY OF REQUEST

This request is for a recommendation in support of approval of a lot-in-depth setback variance to allow construction of a single story addition on the south side of the existing residence and a single story addition on the north side of the existing residence and relocation of the existing air conditioning units to accommodate the proposed additions. Portions of the existing house are within the lot-in-depth setback. The petitioner recently purchased the property and desires to make upgrades to accommodate their needs.

This property is located on the west side of Illinois Road, south of Heather Lane. It is accessed by a shared drive off of Illinois Road that serves this property and two other properties to the east.

FACTS

Compliance/Non-Compliance with Key Code Requirements

- ❖ The property meets the minimum lot size requirement for the R-1 zoning district.
- ❖ A previous owner of the property was granted a lot-in-depth setback variance in 2006 for additions and alterations that were never completed.
- ❖ The proposed project complies with the lot coverage limitation.
- ❖ The proposed project fully complies with the Building Scale limitation.
- ❖ The existing residence is nonconforming with respect to the 40-foot lot-in-depth setback requirement from the north and south property lines as the house was constructed prior to the current regulations in the Zoning Code.
- The proposed project requires a variance from the lot-in-depth setback from the north and south property lines.

Physical, Natural or Practical Difficulties

The original house, was built in 1976, prior to the adoption of lot in depth setbacks.

STAFF EVALUATION

The property is 36,856 square feet and is developed with a residence sited in the center of the site. Due to the minimal street frontage of the property that does not meet the minimum width requirement of the R-1 zoning district, the property is considered a lot-indepth by today's Zoning Code and the setback from each property line is 40 feet.

A single story bedroom addition is proposed at the north end of the existing residence, approximately 24 feet from the north property line. The existing air conditioning units, located in the area of the proposed addition, will be shifted north, approximately 20 feet from the north property line. The proposed addition will not encroach to the extent the existing house does toward the north property line. There is one elm tree that is proposed for removal, north of the proposed addition. The tree is in poor condition.

A single story dining room addition is proposed at the southwest corner of the house, in the footprint of the existing deck. At the closest point, the proposed addition is 28 feet from the south property line. The proposed roof of the addition matches the slope of the existing roof and is lowest, closest to the south property line.

There is an existing fence and some screening along both the north and south property lines that shields views of the proposed additions. There is sufficient area along the north and south property lines to provide additional landscaping to further buffer views of the proposed improvements from neighboring properties.

FINDINGS OF FACT

Based on review of the information submitted by the petitioners, an analysis of this request based on applicable portions of the Zoning Code and inspection of the site, staff submits the following findings.

- 1. The requested lot-in-depth setback variance will not alter the essential character of the neighborhood. The proposed additions are single story in design. There is an existing fence along the north and south property lines.
- 2. The conditions upon which the request for a variance is based are generally unique to the property for which the variances are sought and are generally not applicable to other property with the same zoning classification. This property is a lot in depth, the subdivision was approved prior to the current zoning requirements which has created a nonconforming and unique condition.
- 3. The hardship in conforming to the required setback is the fact that the existing house was constructed prior to the adoption of the lot-in-depth setback regulations. The change in the Zoning Code requirements as they pertain to lots in depth were not the result of actions by the current or any former owner of the property and limit the owners' ability to enhance the livability of the property.
- 4. The variances will not impair light or ventilation to adjacent properties, increase congestion, endanger public safety, or significantly diminish property values. The

proposed additions are single story in design and do not encroach any further than the closest points of the existing structure.

PUBLIC COMMENT

Standard public notice of this request was provided by the City to surrounding property owners. Notice was also provided in the <u>Lake Forester</u> and the agenda was posted at five public locations. As of the date of this writing, four letters in support of the petition have been received and are included in the Board's packet. City staff also received two contacts from neighbors who questioned details of the proposed project and the neighbor to the north questioned the possibility of screening along the property line and mitigating any noise impacts of the air conditioning units.

RECOMMENDATION

Based on the findings presented above, recommend approval to the City Council of a lot-in-depth setback variance to include:

- A single story addition no closer than 24 feet to the north property line
- Air conditioning units no closer than 20 feet to the north property line
- A single story addition no closer than 28 feet to the south property line

as depicted in the site plan submitted to the Board. Staff suggests that the recommendation be conditioned upon the petitioner taking steps, subject to City staff approval, to provide screening from neighbors to the north and south and mitigate any off site noise impacts of the air conditioning units.









THE CITY OF LAKE FOREST ZONING BOARD OF APPEALS APPLICATION OF ZONING VARIANCE

PROJECT ADDRESS		471 6	E. ILLINOIS ROAD
ZONING DISTRICT			
Property Owner (s)		Name	ALAN & ANGELLA KONCAREVIC
			471 E ILLINOIS RD LAKE FOREST, IL 6004. 617-480-6183 Fax AKONGARE@HOTMAIL, COM
Applicant/Representative			
(if different from Property Owner) Addr		Address Phone	Fax
Beneficial Interests Corporation Partnership Trust, land or other		See Exhibit A See Exhibit B See Exhibit C	Staff Reports are Available the Friday before the Meeting Email Report: Owner Representative Representative Pick Up Report: Owner Representative Representative Representative Representative Representative
Signatures I have read the complete application packet and understand the variance process and criteria. I understand that this matter will be scheduled for a public hearing when a determination has been made that my application is complete. 16/22 Owner Date			
Applicant/Representative			Date

Statement of Intent

Dear City of Lake Forest Zoning Board of Appeals:

We recently purchased the home at 471 E Illinois Rd for our family of five and look forward to joining the Lake Forest community. We are reaching out to you as we are proposing to expand the existing home and asking for a side yard variation to the north and the south. The current setback requirement of 40 feet for lot-in-depth was changed in 1979, which occurred after the existing house was built in 1976. The home was conforming when built in 1976 and became non conforming when the zoning law was changed in 1979. We have conformed to the previous setback of 15' which is required in the current zoning for not lot-in-depth homes.

In expanding the existing home, we plan to add a single-story primary bedroom and walk-in closet on the north side of the home, and enclose the existing deck on the south side of the home to create additional dining room space. We explored multiple designs and options to create the needed additional space, and the current design and floorplan proved to be the least disruptive and most efficient approach maintaining the existing character of the home while not impairing experiences of the adjacent properties. The only option that would not require a side yard variation, would be to expand west into the back yard; however, we aimed for minimal exterior and overall adverse impact while trying to blend the shapes into the existing form, layout, and volume of the house. The west side of the home also has multiple mature trees in the proximity which would all be negatively impacted by addition in that direction. Finished portion of the basement also has an emergency egress (the only one) facing west, so any addition on the west side of the home would result in a loss of that egress. Finally, the proposed floorplan is the best floorplan requiring least modification of the current home layout and exterior appearance.

Best,

Angella and Alan Koncarevic

Landscape Plan


Dear City of Lake Forest Zoning Board of Appeals:


We plan to maintain the existing landscaping on the property. We also hired an arborist expert from the Davey Tree Expert Company to assess any potential impact that our proposed additions may have on the existing trees on the property. Based on the expert assessment (please see the attached report), there is an American Elm located on the north side of the home that is likely to be impacted by the addition of the primary bedroom. This Elm is not in good health and attempts have been made to previously treat it and parts of the tree (including entire adjoining trunks) have been removed by the previous owners (photographs of the tree and adjacent stumps are attached). Based on the condition of the tree and prior unsuccessful attempts to treat the tree, the arborist recommends removing the tree.

Thank you for your time and consideration.

Best,

Angella and Alan Koncarevic

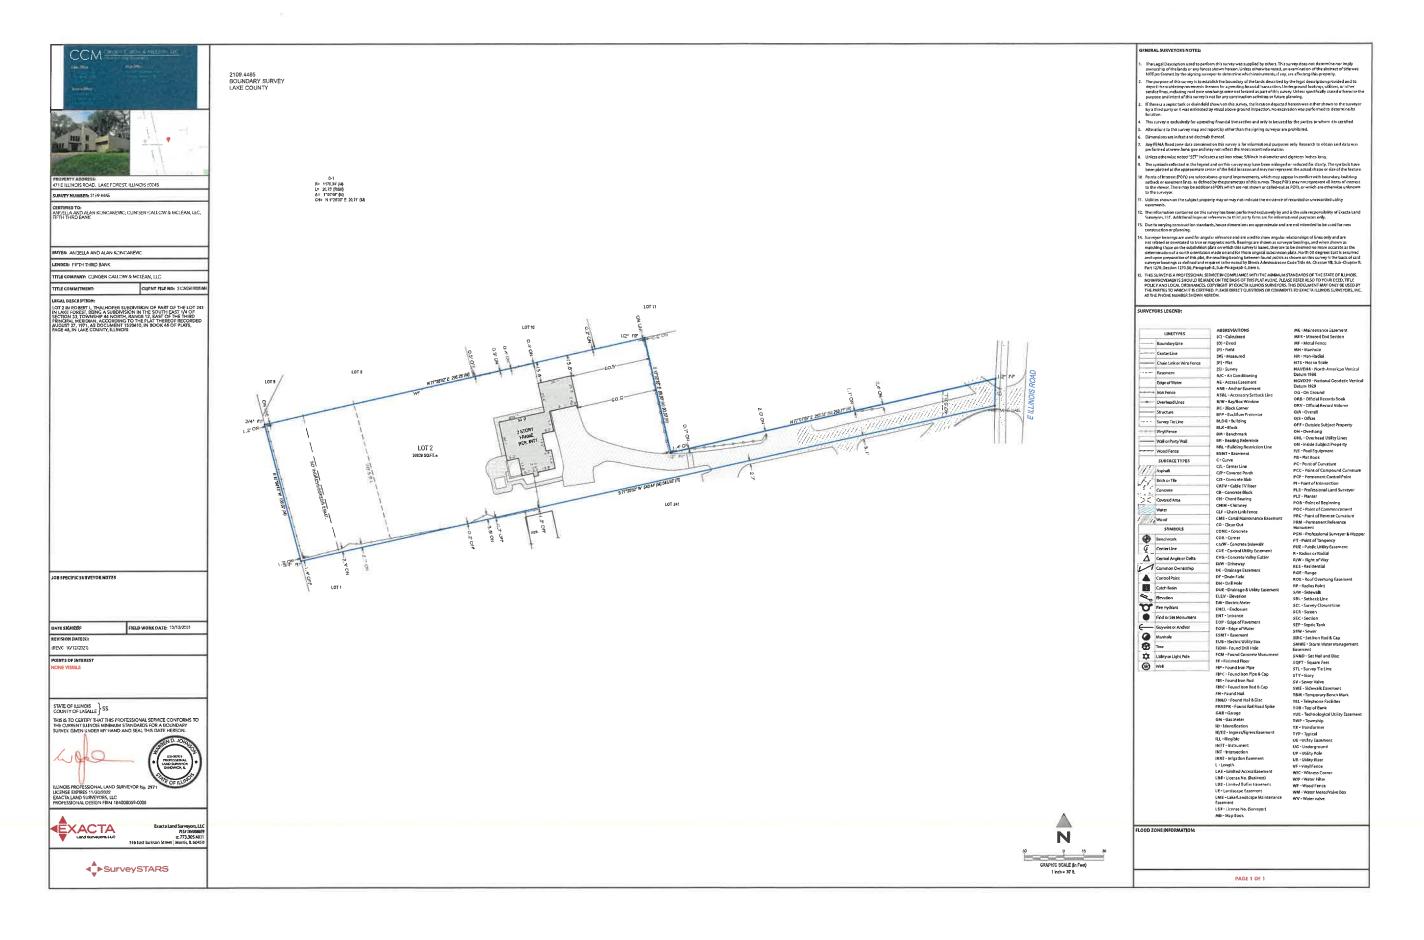

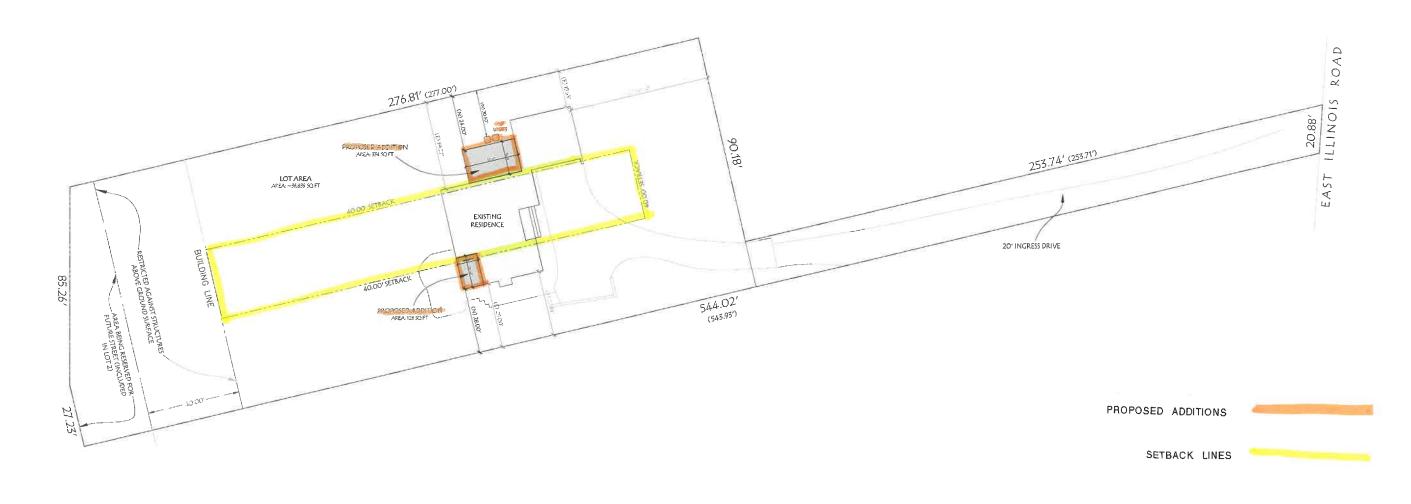

GROSS BUILDING AREA AREAS: Existing Areas:
Garage:
Basement':
First Floor:
Second Floor:
Attic 600.00 Sq. Ft. 1,061.41 Sq. Ft. 1,499.15 Sq. Ft. 978.67 Sq. Ft. 84.50 Sq. Ft. 460.00 Sq. Ft. New Additions: 3,162.32 Sq. Ft. 3,622.32 Sq. Ft. Existing Building Area New Proposed Building Area 'NOTE: Basement area is not counted in the bulk because it is wholly below grade and built before. January 9, 1989

PROPOSED SITE PLAN



January 10, 2022 SP 471 EAST ILLINOIS ROAD LAKE FOREST, ILLINOIS © Copyright Michael J. Leavy, Architects





PROPOSED ELEVATIONS

Scale: 1/4" = 1'-0"

SITE DIMENSIONS AND EXISTING BUILDING SETBACKS ARE REFERENCED FROM THE PLAT SURVEY. SEE SURVEY FOR FULL LOT INFORMATION

January 10, 2022

A5


471

EAST

ILLINOIS

ROAD

LAKE FOREST, ILLINOIS

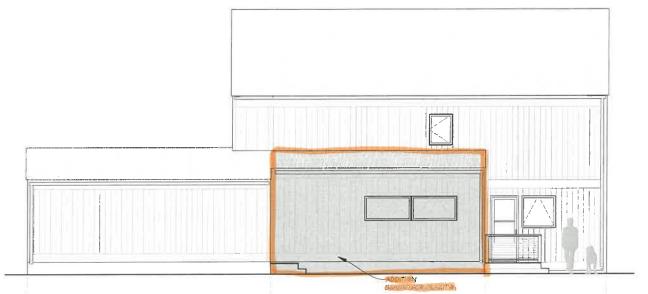

RIGHT SIDE ELEVATION

NORTH FACING

NOTE: SETBACK LINES ARE OUT OF VIEW AT 1/4" SCALE. SEE SITE PLAN FOR COMPLETE SETBACK INFORMATION.



Michael J. Leary Architect 221 North LaSalle Street Chicago, Illinois 60601 312.269.4575

SOUTH FACING NOTE: SETBACK LINES ARE OUT OF VIEW AT 1/4" SCALE, SEE SITE PLAN FOR COMPLETE SETBACK INFORMATION.

PROPOSED ELEVATIONS

SITE DIMENSIONS AND EXISTING BUILDING SETBACKS ARE REFERENCED FROM THE PLAT SURVEY. SEE SURVEY FOR FULL LOT INFORMATION

January 10, 2022 **A6**

471 EAST ILLINOIS ROAD

LAKE FOREST, ILLINOIS

Copyright Michael J. Leary, Architects



BASEMENT

NOTE: NO BULK WORK TO BASEMENT, EXISTING WHOLLY BELOW GRADE BASEMENT.

PROPOSED FLOOR PLAN

Scale: 1/4" = 1'-0"

NORTH


Scale: 1/4" = 1'-0"

SITE DIMENSIONS AND BUILDING SETBACKS ARE REFERENCED FROM THE PLAT SURVEY. SEE SURVEY FOR FULL LOT INFORMATION

January 10, 2022 A1

471 EAST ILLINOIS ROAD LAKE FOREST, ILLINOIS

© Copyright Michael J. Leary, Architects

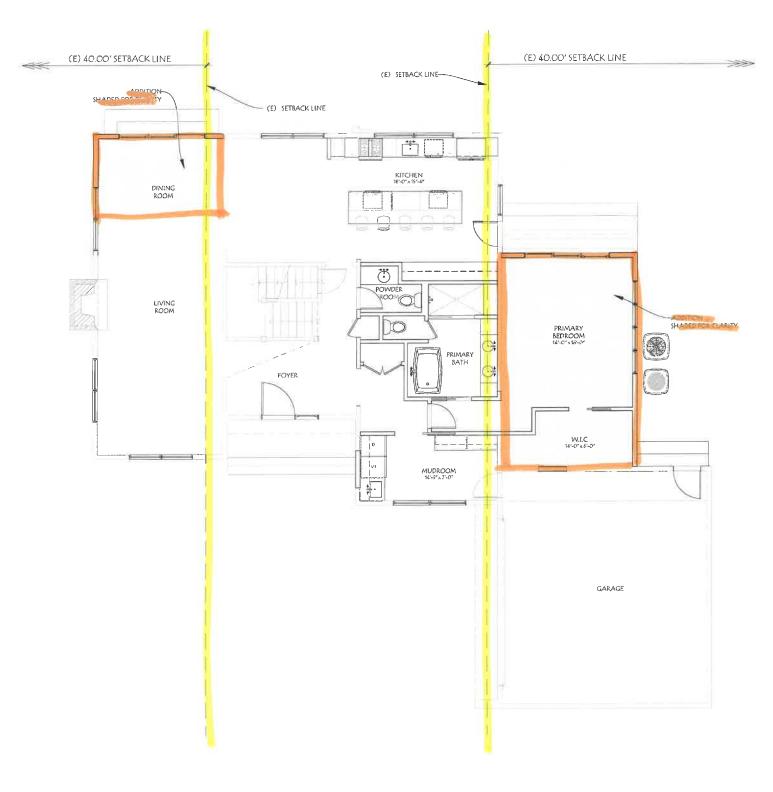

FIRST FLOOR

PROPOSED FLOOR PLAN ON SCALE: 1/4" = 1'-0"




SITE DIMENSIONS AND BUILDING SETBACKS ARE REFERENCED FROM THE PLAT SURVEY. SEE SURVEY FOR FULL LOT INFORMATION

January 10, 2022

471 EAST ILLINOIS ROAD

LAKE FOREST, ILLINOIS

© Copyright Michael J. Leavy, Architects

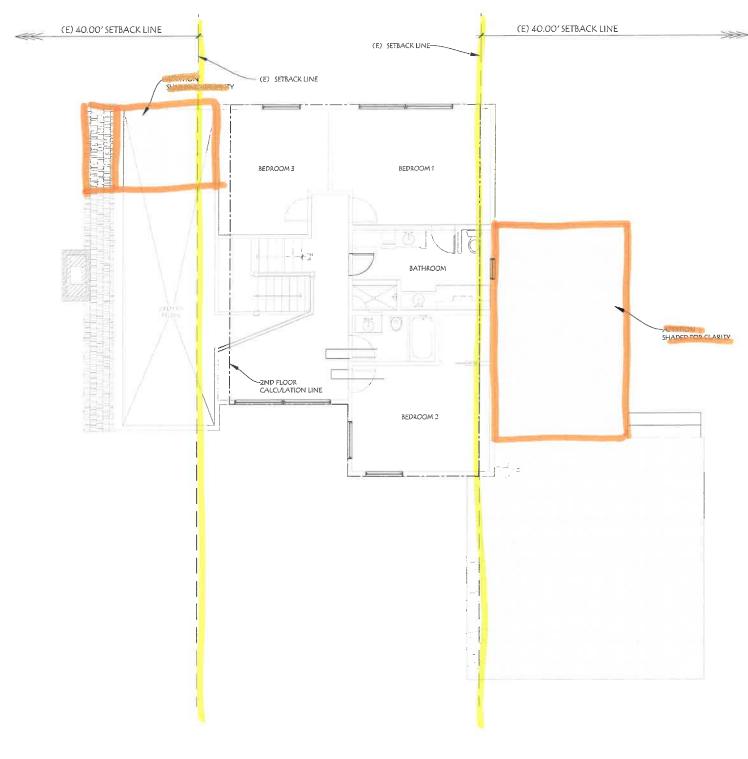

SECOND FLOOR

PROPOSED FLOOR PLAN

SITE DIMENSIONS AND BUILDING SETBACKS ARE REFERENCED FROM THE PLAT SURVEY. SEE SURVEY FOR FULL LOT INFORMATION

January 10, 2022

A3

471 EAST ILLINOIS ROAD

LAKE FOREST, ILLINOIS

© Copyright Michael J. Leavy, Architects



EAST FACING



Michael J. Leary
Architect
221 North LaSalle Street
Chicago, Illinois
60601
312.269.4575

EXISTING ELEVATIONS

WEST FACING

Scale: 1/4" = 1'-0"








EXISTING ELEVATIONS

January 10, 2022 A06 471 EAST ILLINOIS ROAD LAKE FOREST, ILLINOIS © Copyright Michael J. Leary, Architects

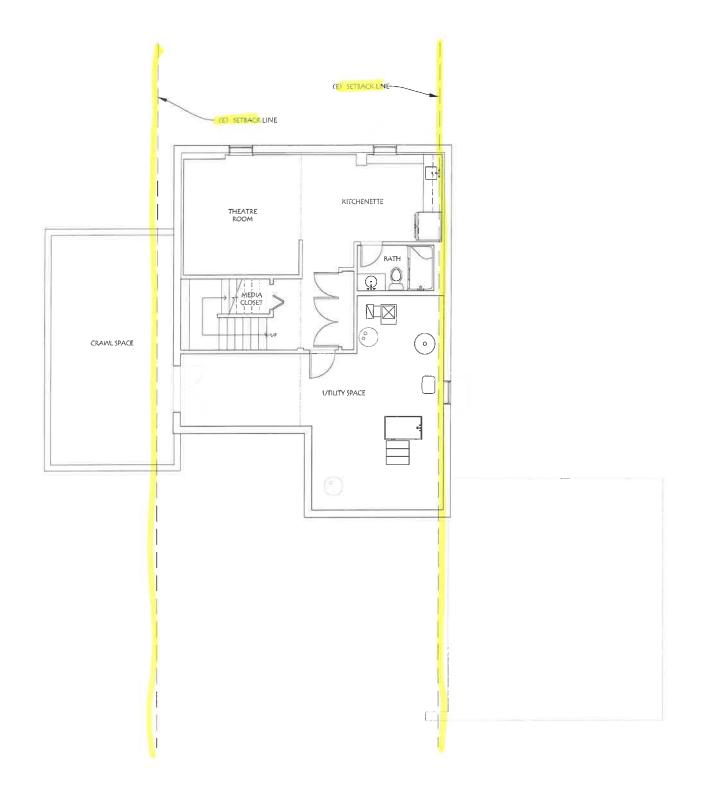

BASEMENT

EXISTING FLOOR PLAN ON ORTH




SITE DIMENSIONS AND BUILDING SETBACKS ARE REFERENCED FROM THE PLAT SURVEY. SEE SURVEY FOR FULL LOT INFORMATION



471 **EAST** ILLINOIS ROAD

LAKE FOREST, ILLINOIS

© Copyright Michael J. Leavy, Architects

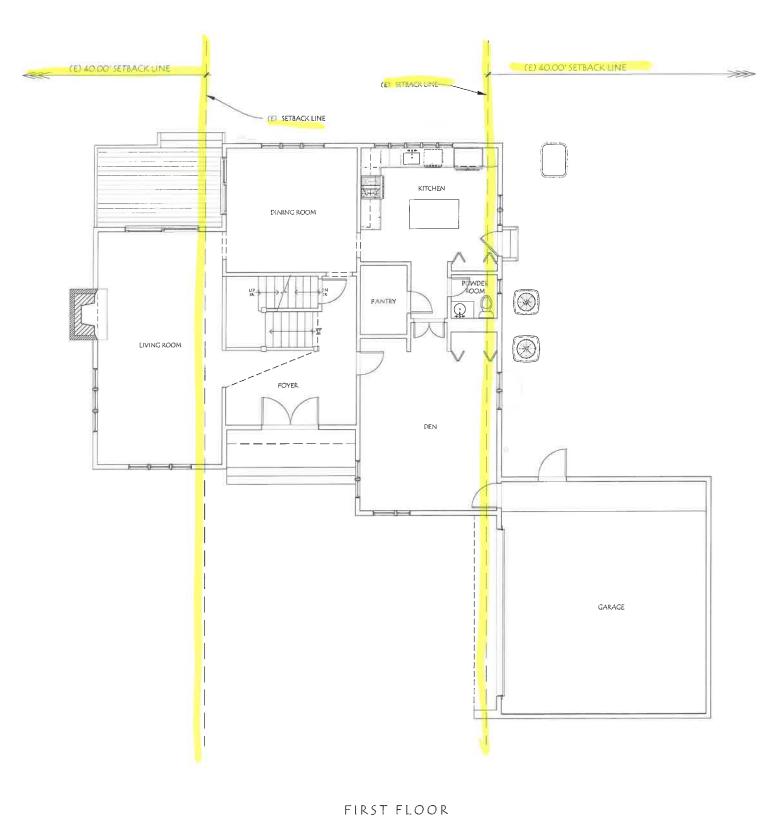

EXISTING FLOOR PLAN ON ORTH




SITE DIMENSIONS AND BUILDING SETBACKS ARE REFERENCED FROM THE PLAT SURVEY. SEE SURVEY FOR FULL LOT INFORMATION

January 10, 2022 A02

471 EAST ILLINOIS ROAD

LAKE FOREST, ILLINOIS

© Copyright Michael J. Leary, Architects

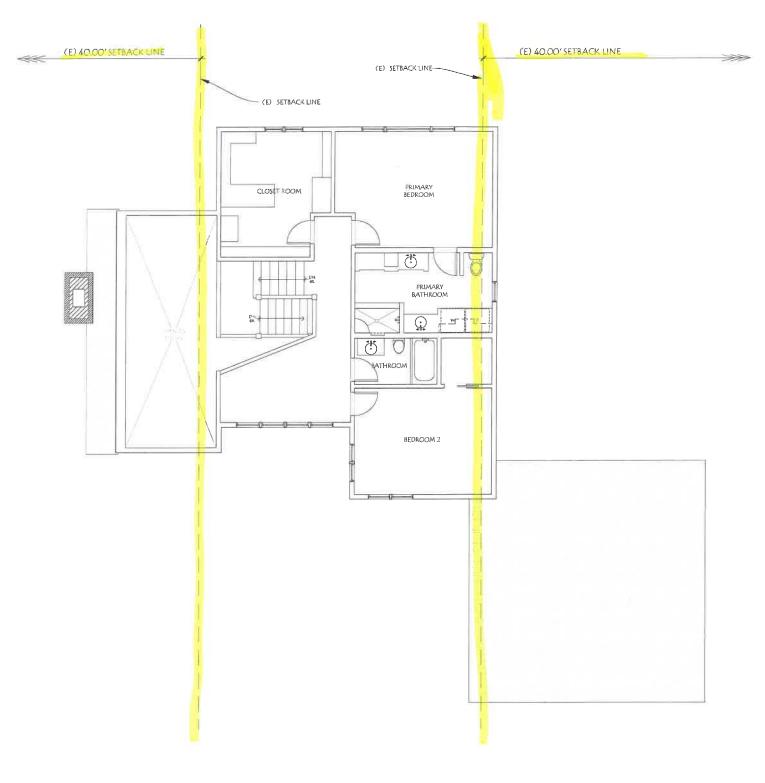

SECOND FLOOR

EXISTING FLOOR PLAN

SITE DIMENSIONS AND BUILDING SETBACKS ARE REFERENCED FROM THE PLAT SURVEY. SEE SURVEY FOR FULL LOT INFORMATION

A03

471 **EAST** ILLINOIS ROAD

LAKE FOREST, ILLINOIS

© Copyright Michael J. Leary, Architects



FRONT ELEVATION



REAR ELEVATION



RIGHT ELEVATION



A7

Michael J. Leary Architect 221 North LaSalle Street Chicago, Illinois 60601 312.269.4575

PROPOSED ELEVATIONS RENDERINGS

471 EAST ILLINOIS ROAD LAKE FOREST, ILLINOIS

© Copyright Michael /. Leavy, Architects

471 E Illinois Rd – Photographs



Front of the house (from the east looking west).




Front of the house (from the east looking west) – additional view from the shared driveway.



North side of the house (close view) - looking east; left/west side of the garage is in the front; north side of the home is to the right; site of the proposed single story primary bedroom addition is market with the wood stakes.



Same as the above (far view) - North side of the house (looking east; left/west side of the garage is in the front; north side of the home is to the right; site of the proposed single story primary bedroom addition is market with the wood stakes).

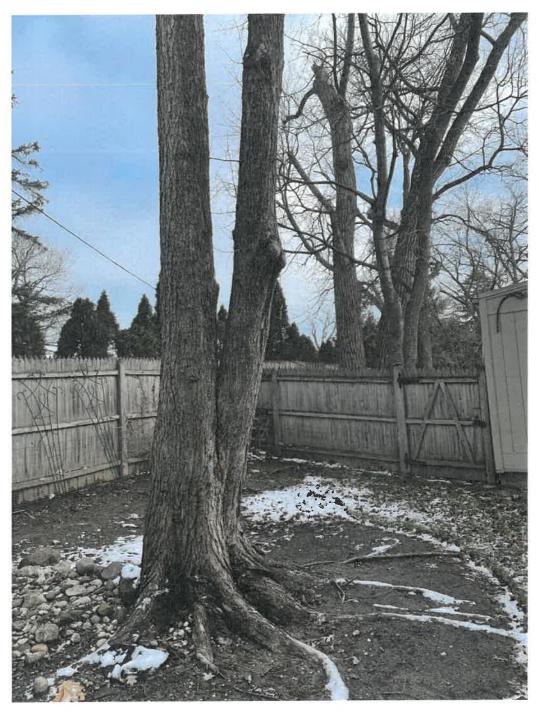

American Elm tree in proximity (to the north) of the proposed primary bedroom addition. Additional information provided in the Landscaping Plan Letter and the attached report from the Davey Tree Expert Company.



American Elm tree (same as the above) - close-up of the adjacent previously removed parts of the tree. Additional information provided in the Landscaping Plan Letter and the attached report from the Davey Tree Expert Company.



Alternate view (looking northeast) of the site of the proposed primary bedroom addition (marked by the wood stakes), the American Elm tree noted in the Landscaping Plan and Davey report, and the neighboring property on the north side.



Back of the house (from the west/back yard looking east).



Back of the house (from the west/back yard looking east) – view of the existing fenced porch, which we propose to enclose, is on the right side of the photograph.



South side of the house (from the south side yard side looking north) – view of the existing fenced porch, which we propose to enclose and incorporate into the floor plan is on the left side of the photograph.



View of the shared driveway from E. Illinois Rd. toward the home (west).



Same as the above (further into the driveway) - View of the shared driveway from E. Illinois Rd. toward the home (west).



Neighbor to the north of the property/driveway.



Neighbor to the south of the property/driveway.

Agenda Item 5

50 S. June Terrace Front and Rear Yard Setback Variances New Duplex Residence


STAKING DIAGRAM

Staff Report Vicinity Map Air Photos

Materials Submitted by Petitioner

Application
Statement of Intent
Plat of Survey – Existing Conditions
Proposed Site Plan
Proposed Elevations
Proposed Floor Plans
Site Plan Overlay
Proposed Grading Plan
Proposed Landscape Plan
Rendering
Concept Studies
Auto Turn Studies
Neighborhood Setback Study
Photographs

Correspondence

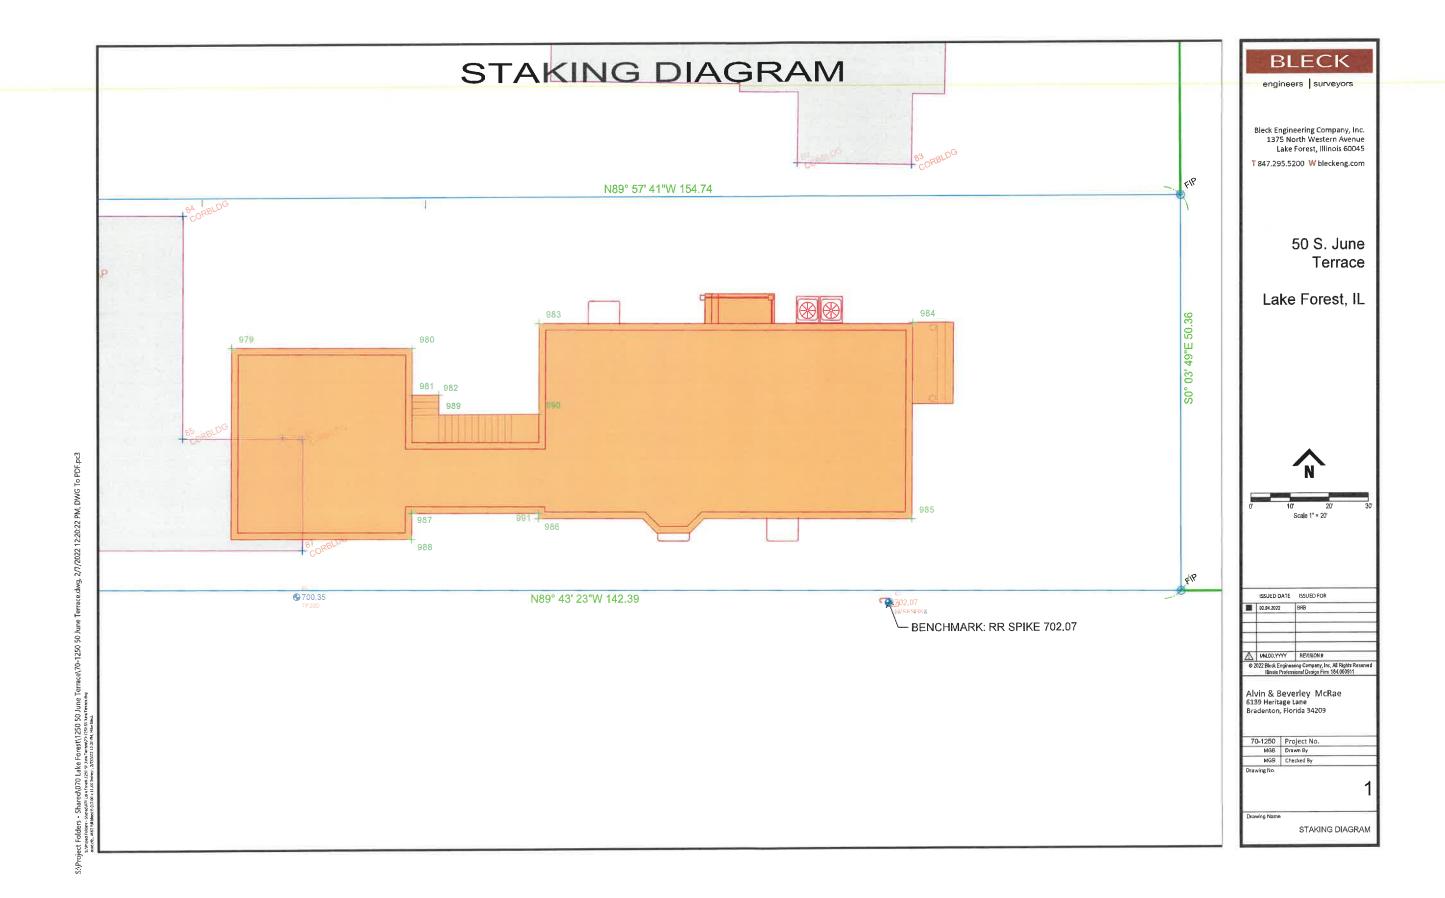



STAFF REPORT AND RECOMMENDATION

TO: Chairman Sieman and members of the Zoning Board of Appeals

DATE: February 28, 2022

FROM: Michelle E. Friedrich, Planning Technician SUBJECT: Front and Rear Yard Setback Variances

PROPERTY OWNER

Alvin and Beverly McRae 6139 Heritage Lane Bradenton, FL 34209 PROPERTY LOCATION

50 S. June Terrace

ZONING DISTRICT GR-3 – General

Residence

REPRESENTATIVE

Diana Melichar, architect

SUMMARY OF REQUEST

This is a request for approval of front and rear yard setback variances to allow construction of a new duplex residence, two separate attached living units, and attached garage. The existing residence is proposed for demolition. The demolition of the existing house and the design elements of the new residence and attached garage will be reviewed at the March Building Review Board meeting.

This parcel is located on the west side of June Terrace, at the south end, the dead end, of the street. The property is bordered by the McClory Bike Path on the west and South Park to the south. This property is part of the Washington Heights Subdivision platted in 1925.

FACTS

Compliance/Non-Compliance with Key Code Requirements

- The property complies with the minimum lot width requirements.
- ❖ The property complies with the minimum lot size requirements.
- ❖ The GR-3 zoning district permits duplex dwelling units.
- The proposed project complies fully with the lot coverage limitation.
- The proposed project complies fully with the building scale limitation.
- The proposed new duplex residence complies fully with the side yard setback requirements.
- ❖ The proposed new duplex residence and attached garage do not comply with the front and rear yard setbacks.
- The existing driveway does not comply with the driveway setback requirements, no changes are proposed to the portion of the driveway located within the setback area.

Physical, Natural or Practical Difficulties

- Homes along June Terrace predate the current zoning requirements and as a result, are nonconforming to the front yard setbacks as show on the graphic provided by the petitioner which is included in the Board's packet. Siting the house forward on the lot to match the prevailing setback pattern of homes on the block will preserve the character of the streetscape.
- ❖ Approximately 17 feet south of the south property line, there is a 20 inch public water transmission line that extends from east to west across South Park. This pipe is critical City infrastructure and serves hundreds of residents in the area. Care will need to be taken during demolition and construction activity on this property to avoid impacting the line.

STAFF EVALUATION

This property is located within the GR-3 zoning district. The Washington Heights subdivision plat established a 30 foot front yard setback. Many of the homes in this subdivision were constructed in accordance with the setback established by the subdivision plat in 1925. Later application of the GR-3 zoning district to the area established a 40 foot front yard setback which is in place today.

As noted above, a City water main is located near this property. During discussions with the property owner and their representatives, staff emphasized that complying with the side yard setback along the south property line was critical to protect the water main. In part, complying with the 6 foot side yard setback from the south property line, drove the siting of the house as presented along with the overall size of the structure desired by the property owners.

The proposed residence is shifted east to be more centered on the property than the existing house which is located to the rear of the property. At the closest point, which is the covered front porch, the proposed duplex is 30 feet from the front property line. Shifting the house to the east, into the 40 foot front yard setback, allows for adequate space at the west side of the property to achieve a functional, attached garage and better aligns the front façade with others on June Terrace.

The proposed attached garage, at the closest point to the rear property line is 22 feet. The rear yard setback for a duplex is 35 feet. Although attached garages are less common in this neighborhood, the property owner's desire is to have it attached to the home. In addition, siting a garage, in compliance with the setback requirements, toward the rear of the property, as is common in this neighborhood, is difficult due to the footprint of the house, configuration and size of the lot. The petitioner studied various locations for the garage and conducted auto turn studies to evaluate the functionality of the various plans. The studies are provided in the Board's packet.

Two trees on the site, a 6" and 27.5" Norway maple in poor condition, will be removed as part of this project and a preliminary landscape plan has been provided.

The existing driveway is sited within the extended side yard setback and is not in conformance with current zoning requirements. This condition is common all along June Terrace. The existing driveway, which, as noted above, is intended to remain in its

present configuration, encroaches across the extended property line, as the driveway flares in the parkway to meet the street. Due to the narrow street, the curb cut and driveway flare as it exists today, is necessary to facilitate access into the site. Shifting the drive to the south, if it were feasible from a functionality standpoint, would move the driveway closer to a parkway tree. To further complicate the access to this property, June Terrace dead ends in front of this property, terminating at South Park. In the past, this area has experienced some congestion as a result of cars parking at the end of the street either by residents using South Park or by visitors to homes on June Terrace. Recently, the City installed a No Parking sign at the end of the street. This has caused some controversy in the neighborhood with some supporting the sign and others preferring that parking be permitted at the end of the street. A cul-de-sac beyond the end of June Terrace, in South Park, was considered in the early discussions about the South Park Master Plan, but dismissed in response to public input in opposition to the proposal. Resolution of this issue is a separate matter from this petition.

FINDINGS OF FACT

Based on review of the information submitted by the petitioners, site visits and an analysis of this request based on applicable portions of the Zoning Code, staff submits the following findings.


- 1. The variances, if granted, will not alter the essential character of the subject property, the surrounding area or the larger neighborhood in which the property is located. Many of the homes in the neighborhood are sited consistent with the proposed duplex, within the front yard setback. No changes are proposed to the existing driveway.
- 2. The conditions upon which the variances are requested, the existing character of the streetscape and the pre-existing pattern of front yard setbacks due to the construction of the houses in this neighborhood prior to current setback regulations, are generally unique to this property and this neighborhood and are not applicable to other properties in the same zoning district in other areas of the community.
- 3. The existing residence is nonconforming as it was constructed prior to current zoning regulations.
- 4. The hardship in conforming to the front yard setback for the proposed new construction is that there is an established pattern of a lesser setback along the streetscape. This pattern was established prior to the current zoning regulations and was not created by any current or former owner of the property. The need for the rear yard variance stems from the size of the footprint of the house and the need to allow adequate space for maneuvering into and out of the garage.
- 5. The variances requested will not impair light or ventilation to adjacent properties, increase congestion, endanger public safety, or substantially diminish property values. The proposed improvements will redevelop the property in a manner that is consistent with the overall neighborhood and support property values along June Terrace. The property is bordered by open space on two sides adjacent to the areas where the garage encroaches into the setback.

PUBLIC COMMENT

Standard public notice of this request was provided by the City to surrounding property owners. Notice was also provided in the Lake Forester, the agenda was posted at various public locations and on the City's website. As of the date of this writing, two emails were received. The correspondence received is included in the Board's packet and indicates general support for the project. The concerns noted about construction traffic and parking will be handled by City staff during the permit review process, a staging and construction vehicle parking plan will be required. If may be necessary for contractors to park off site and shuttle to the job site.

RECOMMENDATION

Based on the findings presented above, recommend approval to the City Council of variances to allow a new duplex and attached garage no closer than 30 feet to the front property line and 22 feet to the rear property line and acknowledge the existing non-conformities of the driveway pertaining to the side yard setback and the location of the flare. The approval is conditioned on approval of the project by the Building Review Board.

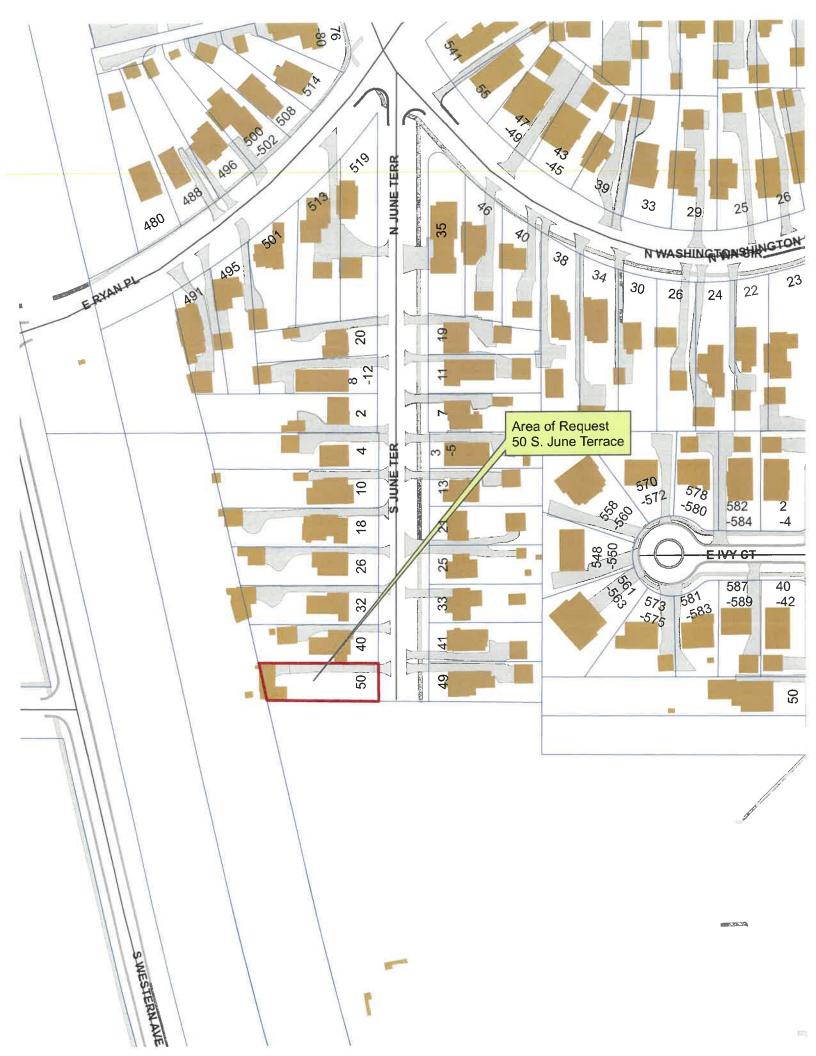







THE CITY OF LAKE FOREST ZONING BOARD OF APPEALS APPLICATION OF ZONING VARIANCE

PROJECT ADDRESS 50 South June Terrace, Lake Forest								
ZONING DISTRICT GR-3								
		0						
Property Owner (s)	Name ALVIN D. MCRAE	BEVERLY J. MCRAE						
(may be different from project address) Add	Idress 6139 HERITAGE	LN, BRADENTON FL 34209						
PI	Phone (941) 761-0080	Fax						
	Email TURNIDZ @ MSN.CO							
,,								
Applicant/Representative N	Name Diana Melichar ·	Melichar Architects						
	Title President							
(if different from Property Owner)	Idrono 207 E INICELLO	- 1 - 1 - 2						
	ldress <u>207 E. Westminster</u> Phone 847·295·2440							
	Email Diana@MelicharArc	Fax 847.295.2451						
_	Diana Girenana	rifeci 5. Con t						
Beneficial Interests	Staff Reports are Av.	allable the Friday before the Meeting						
Corporation	1							
Partnership See Exh	thibit B Fax Report: Own	er 🗌 Representative 🗌						
Trust, land or other See Exh	chibit C Pick Up Report: Own	er Representative						
Signatures								
I have read the complete application packet and understand the variance process and criteria. I understand that this matter will be scheduled for a public hearing when a determination has been made that my application is complete.								
ali Mok	Tae	1/19/22						
Owner		Date						
Bevery Amela	el-	1/19/22						
Owner		Date						
		1/14/21						
Applicant/Representative		Date ⁴						

LAKE FOREST ZONING BOARD OF APPEALS

Mr. and Mrs. Alvin McRae 50 South June Terrace February 28, 2022

Prepared by Melichar Architects

On behalf of Mr. Alvin and Mrs. Beverly McRae, Melichar Architects is requesting zoning variances for a driveway side yard setback at the front yard (the driveway approach), rear yard setback, and front yard setback.

Background

The McRae family has lived in Lake Forest since 1919, when they immigrated from Scotland. Their first family residence was on Scott Street. Later Alvin and Beverly purchased 40 South June Terrace in 1948 (the house just north of the subject property). In March of 1955, the McRaes purchased 50 South June Terrace, raised their girls, Kim and Debbie there, and have owned their home there ever since.

In 2010, Alvin and Beverly became Florida snowbirds, and eventually decided to live year-round in Florida in 2016, renting-out their Lake Forest home. However, with the McRaes' advancing age (Alvin is 97 and Beverly is 84) the heat and humidity in Florida has become a health issue for them, and they would like to return to their beloved Lake Forest. However, their current home at 50 South June Terrace does not meet their aging-in-place needs, and they would like to build a new, duplex home. In this way, the second floor living unit can facilitate Kim and Debbie's potentially long-term and/or care visits when needed.

Driveway Approach Request

We intend on reusing the existing driveway approach footprint, and extend the driveway westward, straightening the path of the new drive to run parallel with the side property line. A turn around is proposed for the west end of the driveway. We believe this achieves three goals:

- 1- A straight-run driveway that allows for forward exiting to the street.
- 2- Better clearances around the house.
- 3- The garage is tucked behind the house.

Proposed Garage Design

It is difficult to locate a garage on this property, due to the narrowness of the site and the angled rear yard configuration. We studied various options for the garage placement (detached, side-loading and rear-loading---see attached sketches) but came to the conclusion that the best configuration was rear-loading. For safety in winter conditions, the McRaes would rather have a covered walking path to enter their home.

The rear-loading garage encroaches into the rear yard building setback line, since it is attached to the screened porch; however, it is set far back from the accessory structure setback line.

Front Yard Setback Request


The new home it set back 30' from the front property line. This setback is consistent with the other homes on the street. We are requesting this variance to accommodate the rear-loading garage turn around.

Standards for Zoning Variance


- 1. The variance, if granted, will not alter the essential character of the subject property, the surrounding area or the larger neighborhood in which the property is located.
- The proposed driveway approach does not change the current driveway approach.
- The home will be located on its lot similarly as the other homes on the street.
- The garage is tucked behind the house, and will not impact neighboring properties.
- 2. The conditions upon which a petition for a variance are based are unique to the property for which the variance is sought, and are not applicable, generally, to other property with the same zoning classification.
- We would prefer to keep the driveway approach in its current configuration to provide a straight run
 out of the property, and to keep the driveway further from the parkway tree and dead-ended portion
 of the street.
- The narrow lot and angled westerly property line condition makes it difficult to site a garage on this
 property, and so it will encroach on the rear yard setback regardless of its configuration (front, side or
 rear-loaded). Shifting the home forward on the site allows for a rear-loading garage; and, it maintains
 a consistent streetscape facing the street.
- 3. The alleged difficulty or hardship in conforming with the requirements of this chapter is caused by this chapter and has not been created by the actions of any persons presently or formerly having an interest in the property.
- If the Driveway Ordinance requirements are applied to the proposed driveway approach, the narrow lot and side yard setback make it tight around the house (refer to sketch). A straight run provides better clearances around the house and it is easier to navigate.
- The area in which to locate a garage is diminished in relation to the home, due to the narrow property dimension and angled geometry at the westerly side.
- 4. The proposed variance will not impair an adequate supply of light and air to adjacent property or substantially increase the congestion of the public streets, or increase the danger of fire, or endanger the public safety, or substantially diminish or impair property values within the neighborhood.
- Keeping the existing driveway approach in-place does not increase congestion nor danger of public safety.
- The front yard setback is consistent with the existing streetscape.
- This property is unique in that it bounds on South Park, and the City of Lake Forest's Robert McClory Bike Path. The setback requests for the garage do not affect neighboring properties in regards to light, air, nor do they endanger the public safety. In comparison to the existing home, that straddles the western property line and is completely set beyond the allowable building envelopes, the new condition is an improvement.

Conclusion

In conclusion, the proposed driveway and building improvements overcome practical difficulties related to the narrow, small lot, and angled property shape. These conditions are unique to the property; and the proposed design addresses those difficulties as best as possible.

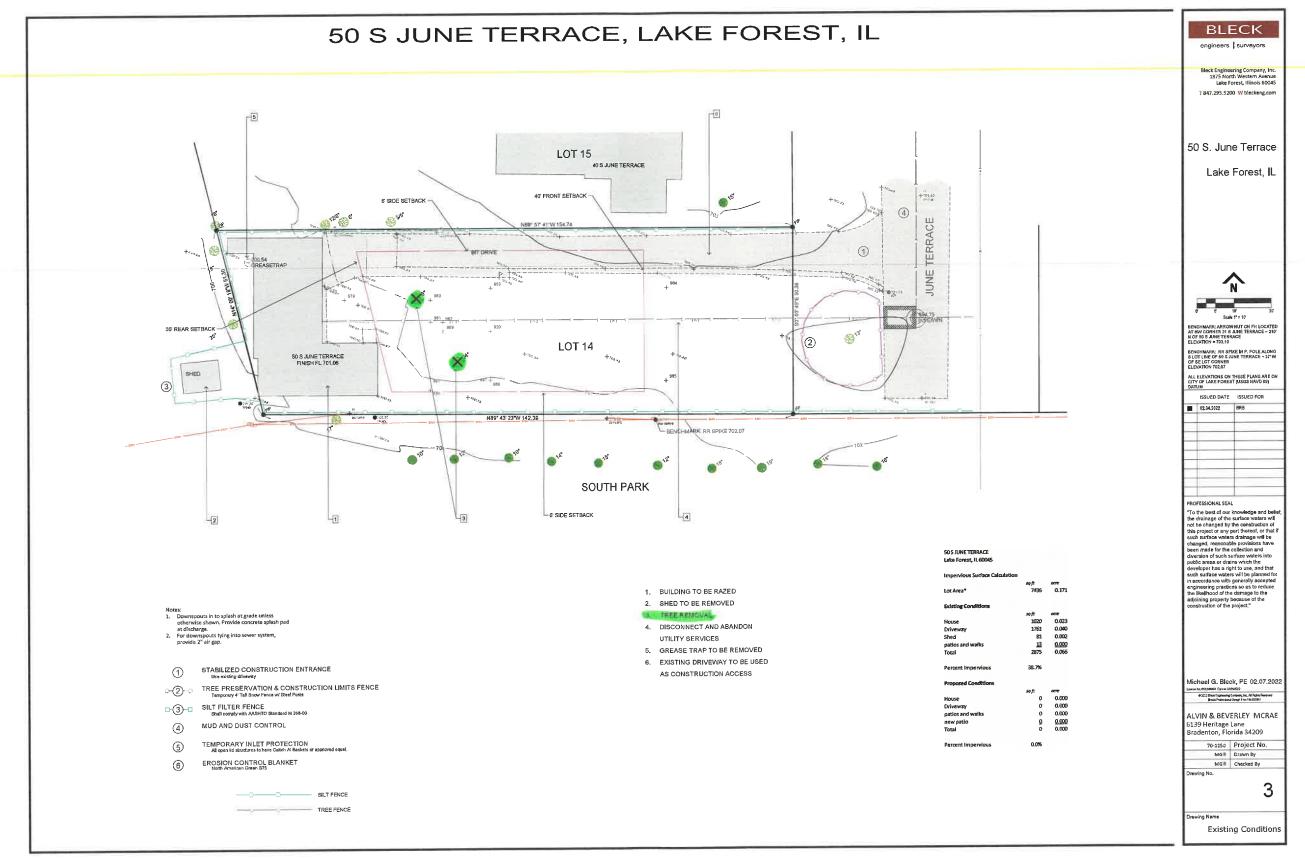

6-Whysic Felders - Sharek Ditt Like Faresh 1259 50 June Terratek 30-1259 50 June Terratek den stitutis, appt half blees to (26, 20 v. 20, 00 milesk), 27/7022 12...) Phi, Mile Bles

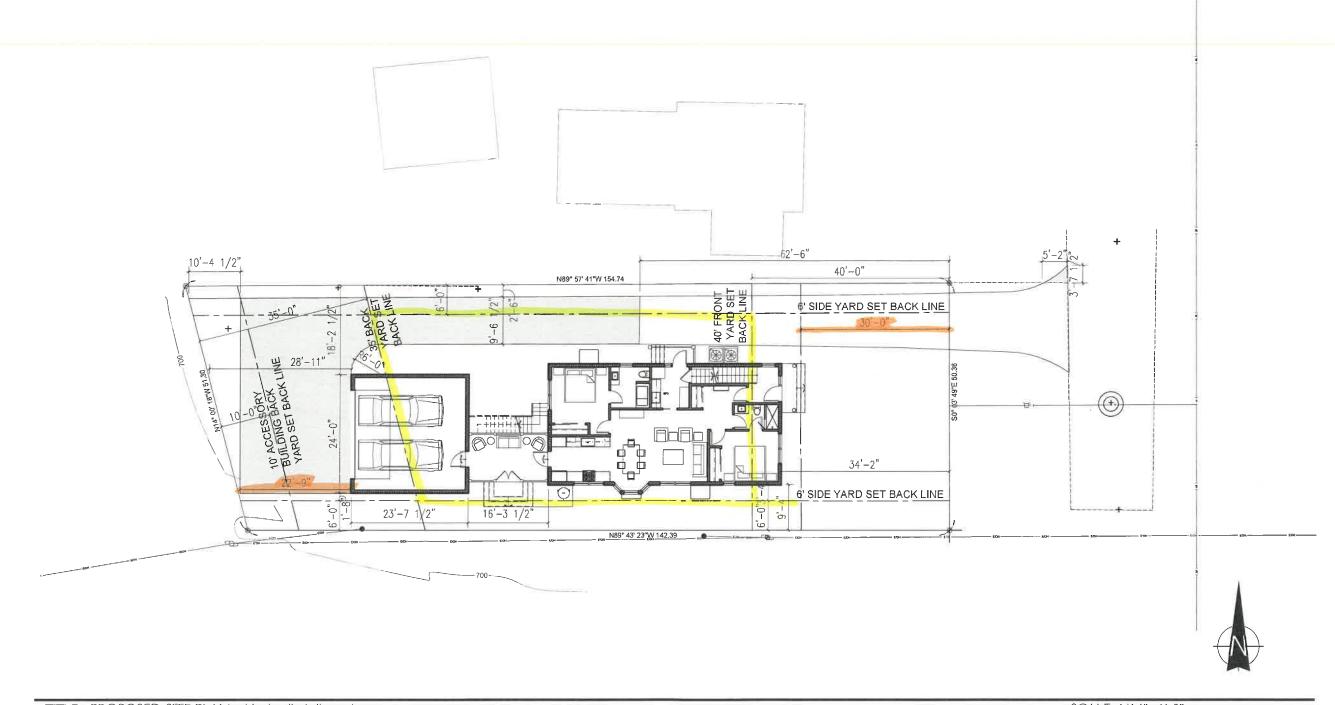

TITLE: PROPOSED SITE PLAN with detailed dimensions



McRAE RESIDENCE NEW CONSTRUCTION 50 SOUTH JUNE TERRACE LAKE FOREST, IL SCALE: 1/16"=1'-0"


JOB NO.: 1968

ISSUE DATE: submitted to Michelle Friedrich 01/21/2022



TITLE: PROPOSED EAST ELEVATION SCALE: 1/8"=1'-0"



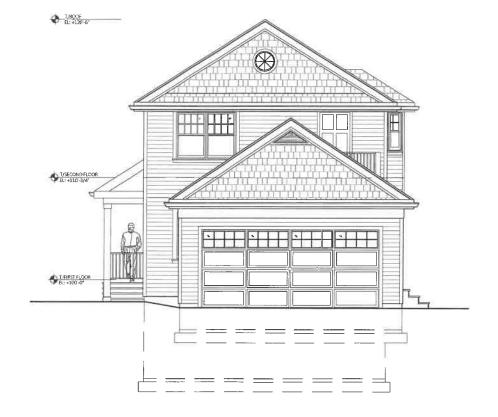

TITLE: PROPOSED WEST ELEVATION SCALE: 1/8"=1'-0"



McRAE RESIDENCE NEW CONSTRUCTION 50 SOUTH JUNE TERRACE LAKE FOREST, IL

JOB NO.: 1968

ISSUE DATE: Zoning Board of Appeals submitted: 01/21/2022



TITLE: PROPOSED NORTH ELEVATION



MELICHAR ARCHITECTS

THE PRACTICE OF FINE ARCHITECTURE

207 EAST WESTMINSTER LAKE FOREST, ILLINOIS 60045 P 847-295-2440 F 847-295-2451 © 2022 MELICHAR ARCHITECTS

McRAE RESIDENCE NEW CONSTRUCTION 50 SOUTH JUNE TERRACE LAKE FOREST, IL SCALE: 1/8"=1'-0"

JOB NO.: 1968

ISSUE DATE: Zoning Board of Appeals submitted: 01/21/2022



TITLE: PROPOSED SOUTH ELEVATION




MELICHAR ARCHITECTS THE PRACTICE OF FINE ARCHITECTURE

207 EAST WESTMINSTER LAKE FOREST, ILLINOIS 60045 P 847-295-2440 F 847-295-2451 © 2022 MELICHAR ARCHITECTS

McRAE RESIDENCE NEW CONSTRUCTION 50 SOUTH JUNE TERRACE LAKE FOREST, IL SCALE: 1/8"=1'-0"

JOB NO.: 1968

ISSUE DATE: Zoning Board of Appeals submitted: 01/21/2022

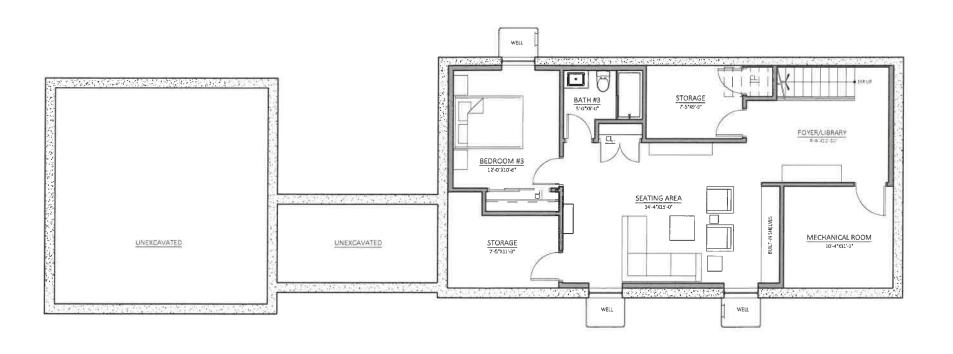



TITLE: PROPOSED BASEMENT PLAN

SCALE: 1/8"=1'-0"




MELICHAR ARCHITECTS THE PRACTICE OF FINE ARCHITECTURE

207 EAST WESTMINSTER LAKE FOREST, ILLINOIS 60045 © 2022 MELICHAR ARCHITECTS

McRAE RESIDENCE NEW CONSTRUCTION 50 SOUTH JUNE TERRACE LAKE FOREST, IL

JOB NO.: 1968

ISSUE DATE: Zoning Board of Appeals submitted: 01/21/2022

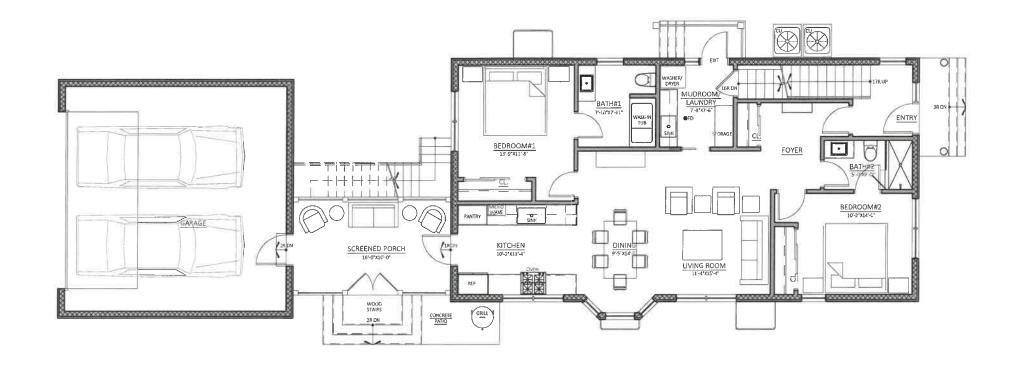



TITLE: PROPOSED FIRST FLOOR PLAN SCALE: 1/8"=1'-0"




MELICHAR ARCHITECTS
THE PRACTICE OF FINE ARCHITECTURE

HE PRACTICE OF FINE ARCHITECTUR

207 EAST WESTMINSTER LAKE FOREST, ILLINOIS 60045 P 847-295-2440 F 847-295-2451 © 2022 MELICHAR ARCHITECTS

McRAE RESIDENCE NEW CONSTRUCTION 50 SOUTH JUNE TERRACE LAKE FOREST, IL JOB NO.: 1968

ISSUE DATE: Zoning Board of Appeals submitted: 01/21/2022

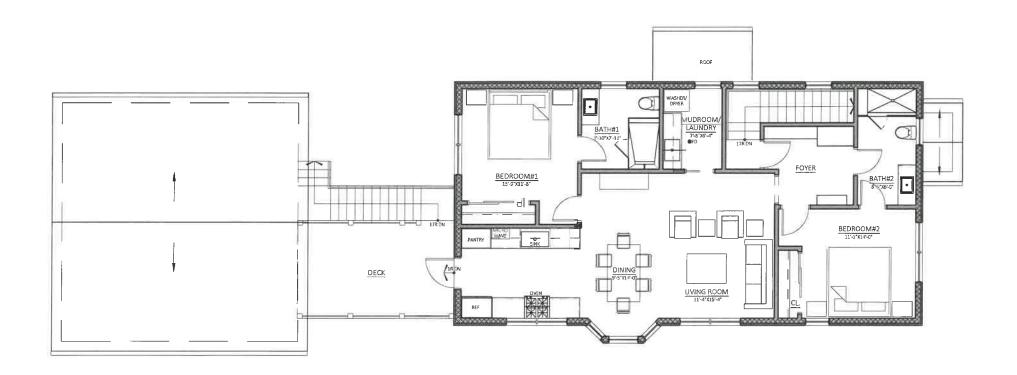




TITLE: PROPOSED SECOND FLOOR PLAN SCALE: 1/8"=1'-0"



JOB NO.: 1968

ISSUE DATE: Zoning Board of Appeals submitted: 01/21/2022

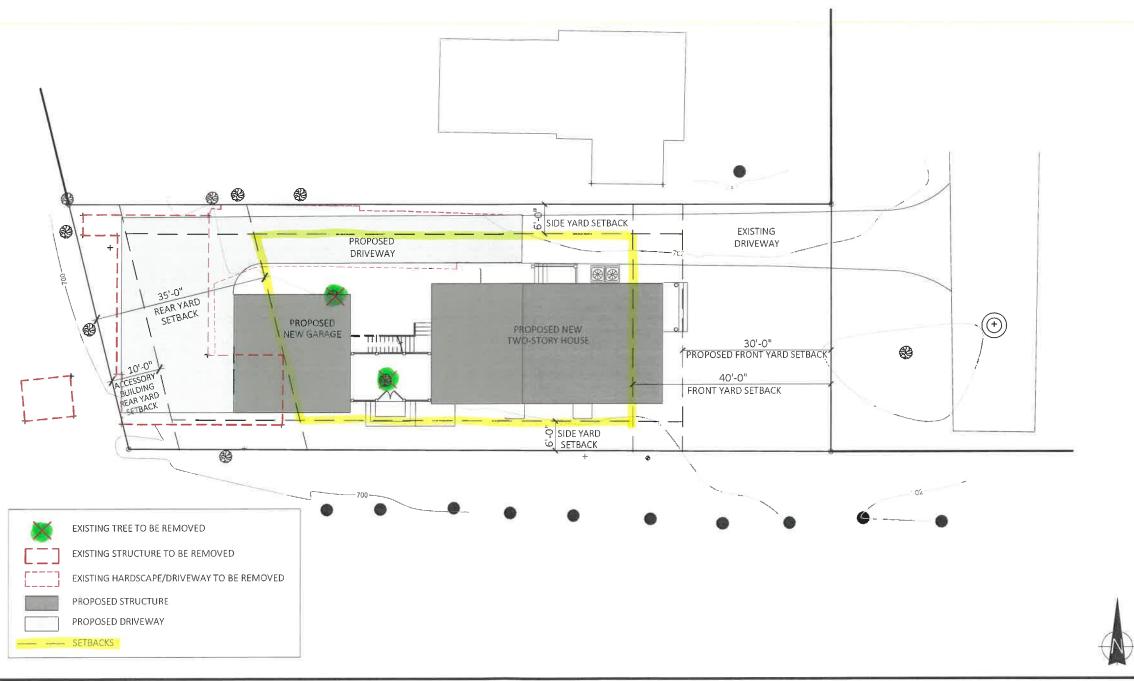

TITLE: SITE PLAN OF PROPOSED IMPROVEMENTS

SCALE: 1/16" = 1'-0"

THE PRACTICE OF FINE ARCHITECTURE


P 847-295-2440 F 847-295-2451

207 EAST WESTMINSTER LAKE FOREST, ILLINOIS 60045 P 847-295-2440 F 847-295-2451 © 2022 MELICHAR ARCHITECTS


McRAE RESIDENCE NEW CONSTRUCTION 50 SOUTH JUNE TERRACE LAKE FOREST, IL

JOB NO.: 1968

ISSUE DATE: Zoning Board of Appeals submitted: 01/21/2022

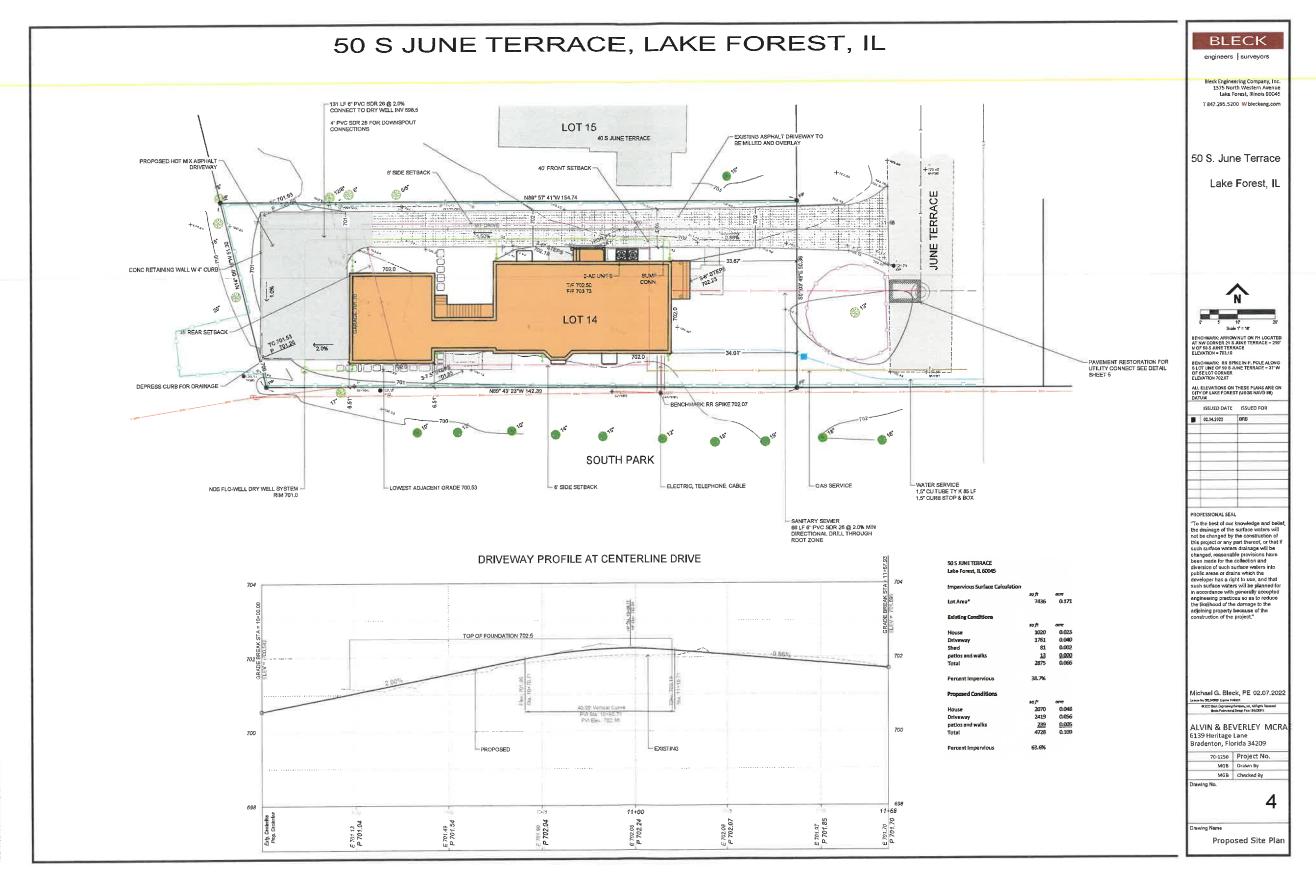

6-5/4-que fieblem e Des rejobble tale forest (1921) to have terrarel 20-13/0 to their terrarelating october. See respect to their control october 20-14/0 to their terrarelating october. I control october 30-14/0 to their terrarelating october 30-14/0 to their terrarelation october 30-14/0 t

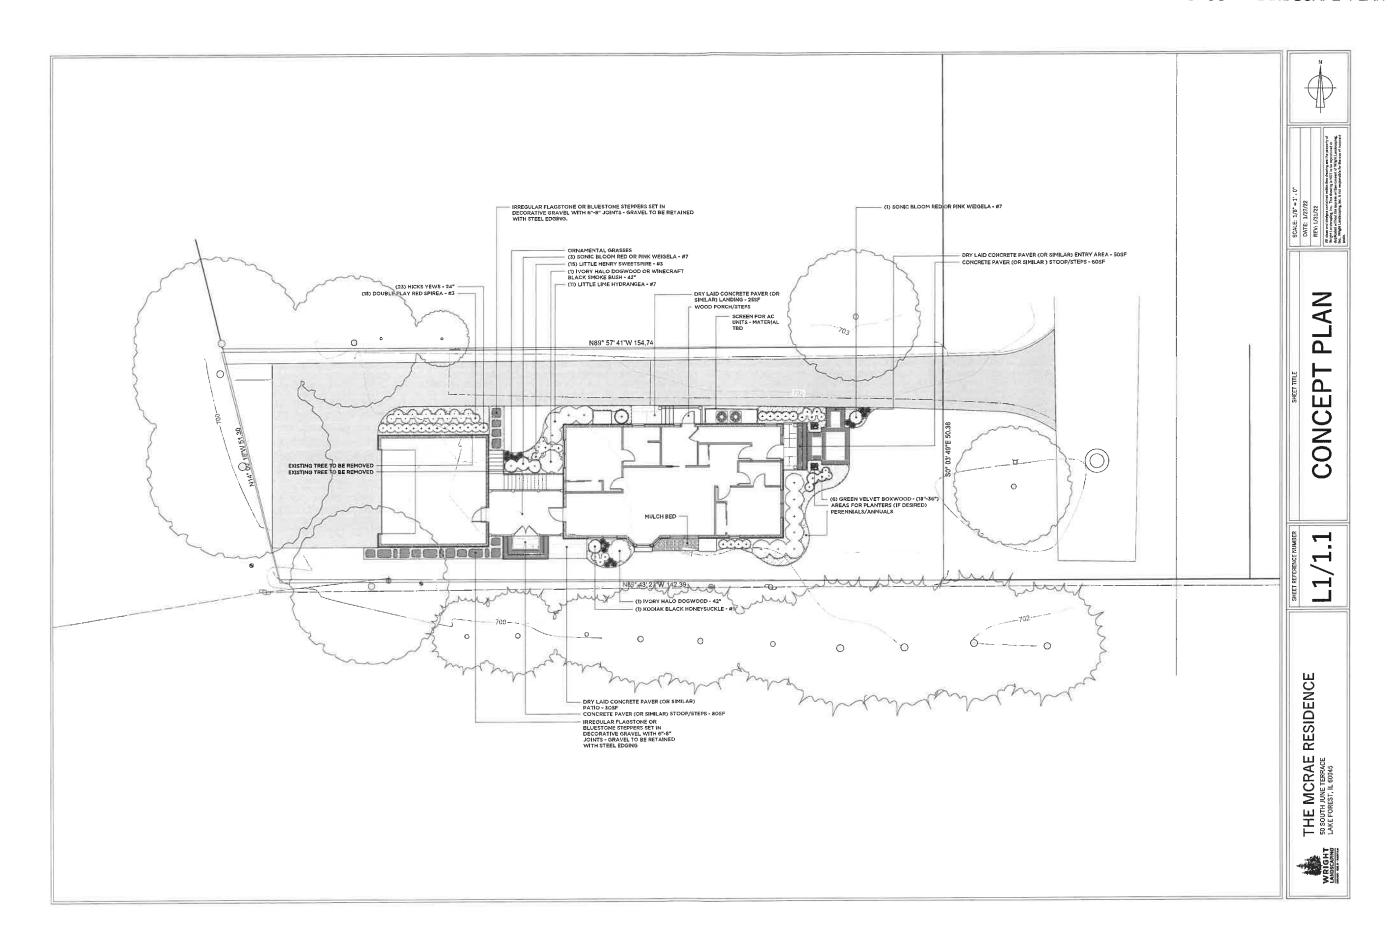



TITLE: PROPOSED COLORS AND MATERIALS

SCALE: 1/4"=1'-0"



MELICHAR ARCHITECTS THE PRACTICE OF FINE ARCHITECTURE

207 EAST WESTMINSTER LAKE FOREST, ILLINOIS 60045 P 847-295-2440 F 847-295-2451 © 2022 MELICHAR ARCHITECTS

McRAE RESIDENCE NEW CONSTRUCTION 50 SOUTH JUNE TERRACE LAKE FOREST, IL




JOB NO.: 1968

ISSUE DATE:


DETACHED GARAGE


- Proximity of garage to house is tight
- Back-out from garage is difficult (could hit house)
- Garage is considered attached, encroaching on 35' rear yard setback

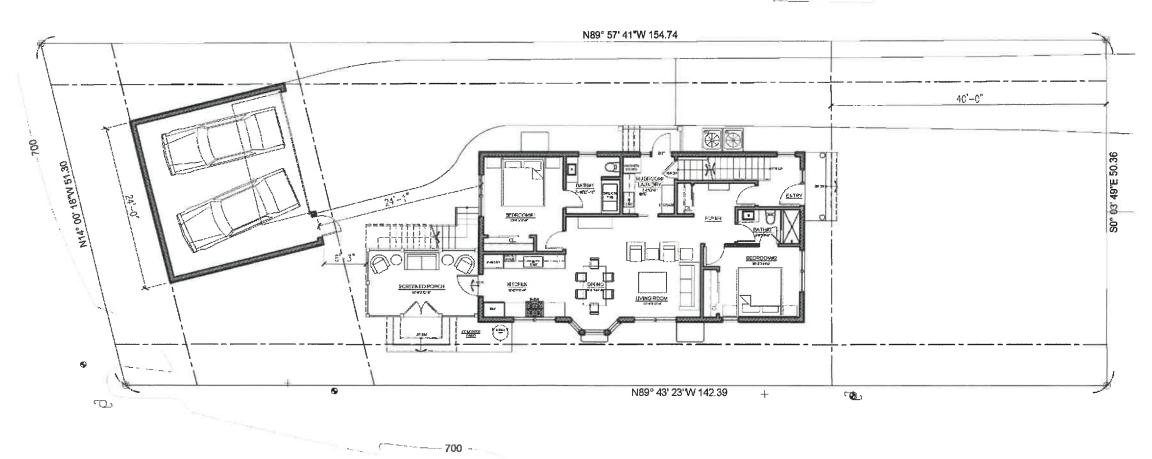

REAR-LOADING GARAGE (HOUSE AT 40' SETBACK)

When house is sited at the 40' front yard setback line,
 there is not enough back-up driveway space at the garage

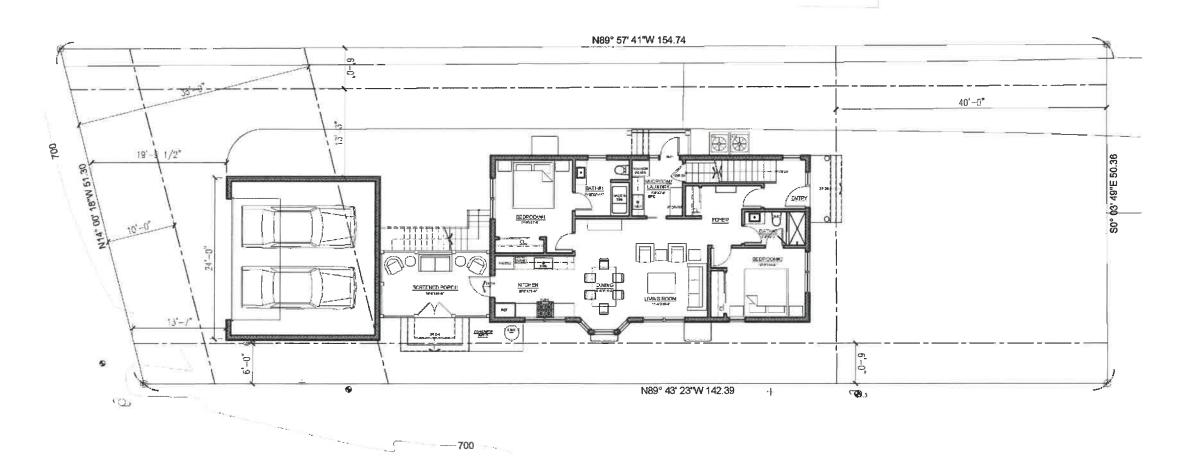

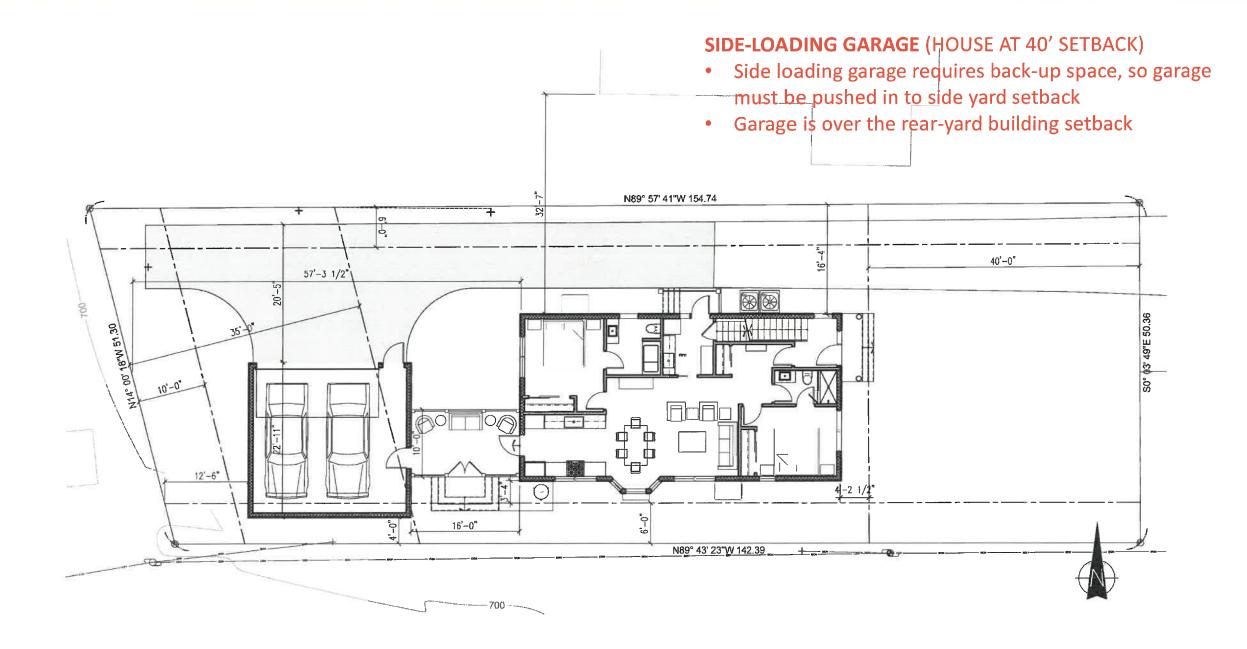


6


TO.

Pinches the northeast (front) corner of the house EXISTING/PRORISED DRIVEWAY DESIGN BYARD SET BACK LINE DRIVEWAY DESIGN PER ORDINANCE

TE.

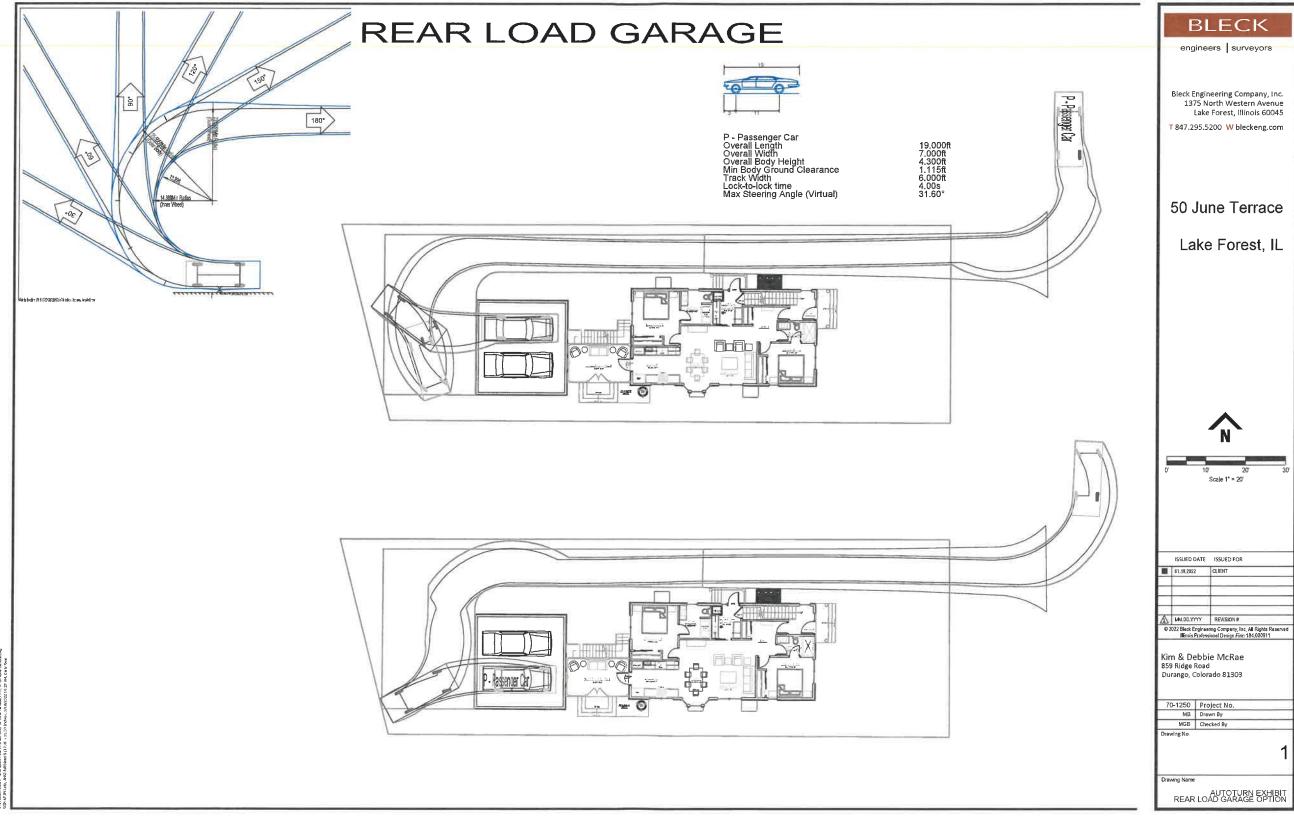

Phoject Folders - SharedUPFLake Forest 1250 St. James

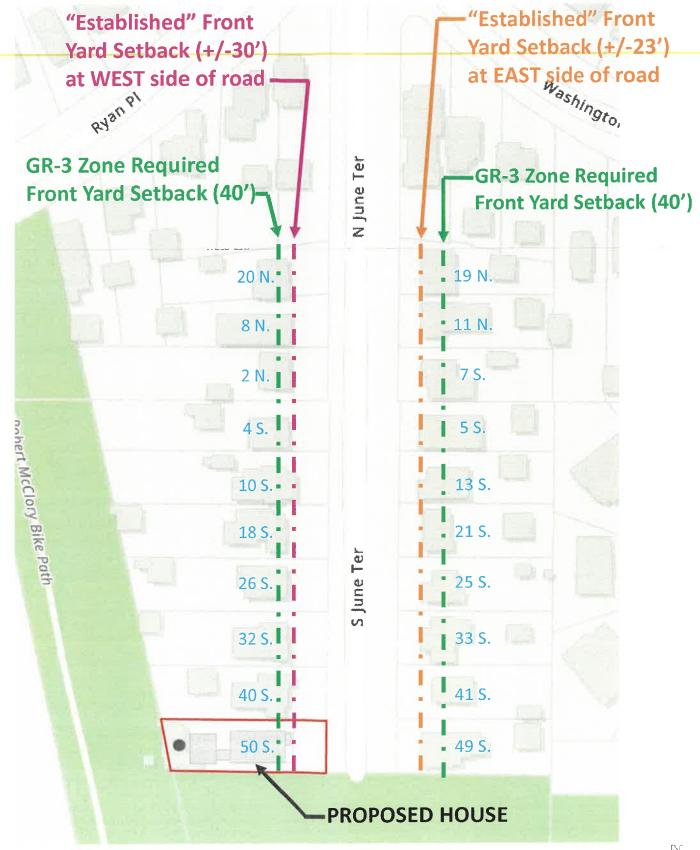











40 South June Terrace



32 South June Terrace



26 South June Terrace



18 South June Terrace



10 South June Terrace



4 South June Terrace



49 South June Terrace



41 South June Terrace



33 South June Terrace



25 South June Terrace



21 South June Terrace




13 South June Terrace

Agenda Item 6

821 Northmoor Road Front Yard Setback Variance

Staff Report Vicinity Map Air Photos

Materials Submitted by Petitioner **Application** Statement of Intent Plat of Survey – Existing Conditions Proposed Site Plan Existing and Proposed Elevations Proposed Floor Plans Existing Floor Plans Proposed Section Renderings Proposed Streetscape Elevation Proposed Grading Plan Tree Removal Plan Tree Inventory Proposed Landscape Plan Photographs

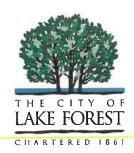

STAFF REPORT AND RECOMMENDATION

Chairman Sieman and members of the Zoning Board of Appeals TO:

DATE: February 28, 2022

Michelle E. Friedrich, Planning Technician FROM:

Front Yard Setback Variance SUBJECT:

PROPERTY OWNER

Black House LLC – Series 821 Northmoor (Patrick Shaver 100%) 1225 Lincoln Avenue S Highland Park, IL 60035

PROPERTY LOCATION

ZONING DISTRICT R-1 - Single Family 821 Northmoor Road Residence

SUMMARY OF REQUEST

This is a request for a recommendation in support of approval of a front yard setback variance to allow for an addition and modifications to the existing driveway. The Building Review Board considered the design aspects of this project and recommended approval subject to conditions relating to refinement of some architectural details and the color scheme and the landscape plan.

The property is located on the south side of Northmoor Road, just east of Wooded Lane. The property is in the Northmoor Terrace Subdivision which was approved in 1922. The parcel today is developed with a residence constructed in 1949.

FACTS

Compliance/Non-Compliance with Key Code Requirements

- ❖ The property meets the minimum lot width requirement in the R-1 zoning district
- ❖ The property meets the minimum lot size requirement of the R-1 zoning district of 9,375 square feet.
- The existing house complies fully with the side and rear yard setbacks.
- ❖ The existing house does not comply with the front yard setback.
- ❖ The proposed addition complies fully with side and rear yard setbacks.
- ❖ The proposed addition requires a variance from the 40-foot front yard setback.
- The proposed driveway modifications include a driveway wider than permitted within the front yard setback.

Physical, Natural or Practical Difficulties

The existing residence was constructed prior to the present day setback requirements.

Northmoor Terrace Subdivision was approved by the City in 1922, prior to the City's adoption of a Zoning Code and setback requirements.

STAFF EVALUATION

The existing residence is just over 39 feet from the front property line. The proposed project expands the single car garage to the east, creating a standard two car garage along the same line of the existing front façade. The overall proposed architectural design of the renovations and addition, creates a cantilevered second story that increases the encroachment into the front yard setback by an additional 3 feet. The cantilevered nature of the proposed modifications provides some depth and interest to the front elevation

The existing driveway awkwardly splits off to the east and three trees are located in the center area. With the proposed garage addition, it is necessary to make modifications to the driveway. The petitioner proposes to remove the trees near the driveway and create a simple, straight 20 foot wide driveway to serve the two car garage. Overall, the driveway will be 1290.5 square feet and the existing driveway is 1595 square feet, reducing the amount of pavement on the property. Although it is difficult to screen the proposed driveway from the street, it does serve the overall design of the project well.

The petitioner has provided an overall landscape plan for the property that replaces inches for the trees removed and upgrades the plant material on the property. The proposed plantings will help to soften the appearance of the front façade.

FINDINGS OF FACT

Based on review of the information submitted by the petitioners, a site visit and an analysis of this request based on applicable portions of the Zoning Code, staff submits the following findings.


- 1. The requested variance from the front yard setback will not alter the essential character of the neighborhood. The addition and alterations to the existing house and site plan are generally compatible with the existing residence and surrounding neighborhood.
- 2. The conditions upon which the variance is requested, including the original siting of the house and the adoption of the zoning regulations after the property was created through a subdivision in 1922, and after the house was constructed, are generally unique to this neighborhood and to this property and are not generally applicable to other properties in the same zoning district throughout the City.
- 3. The existing residence does not conform to the current 40-foot front yard setback requirement. The hardship in conforming to the required setback is a result of the original construction of the residence prior to adoption of the current setback regulations.
- 4. The variance and the resulting modifications will not impair light or ventilation to adjacent properties, increase congestion, endanger public safety, or diminish property values. The proposed modifications are intended to upgrade the home.

PUBLIC COMMENT

Standard public notice of this request was provided by the City to surrounding property owners. Notice was also provided in the <u>Lake Forester</u> and the agenda was posted at various public locations. As of the date of this writing, no letters regarding the setback variances were received. The Building Review Board received letters pertaining to the proposed color palette and addressed the concerns raised through the conditions of the Board's approval.

RECOMMENDATION

Based on the findings presented above, recommend approval to the City Council of a variance to allow an addition no closer than 36 feet to the front property line and a driveway 20 feet in width, consistent with the site plan submitted to the Board.

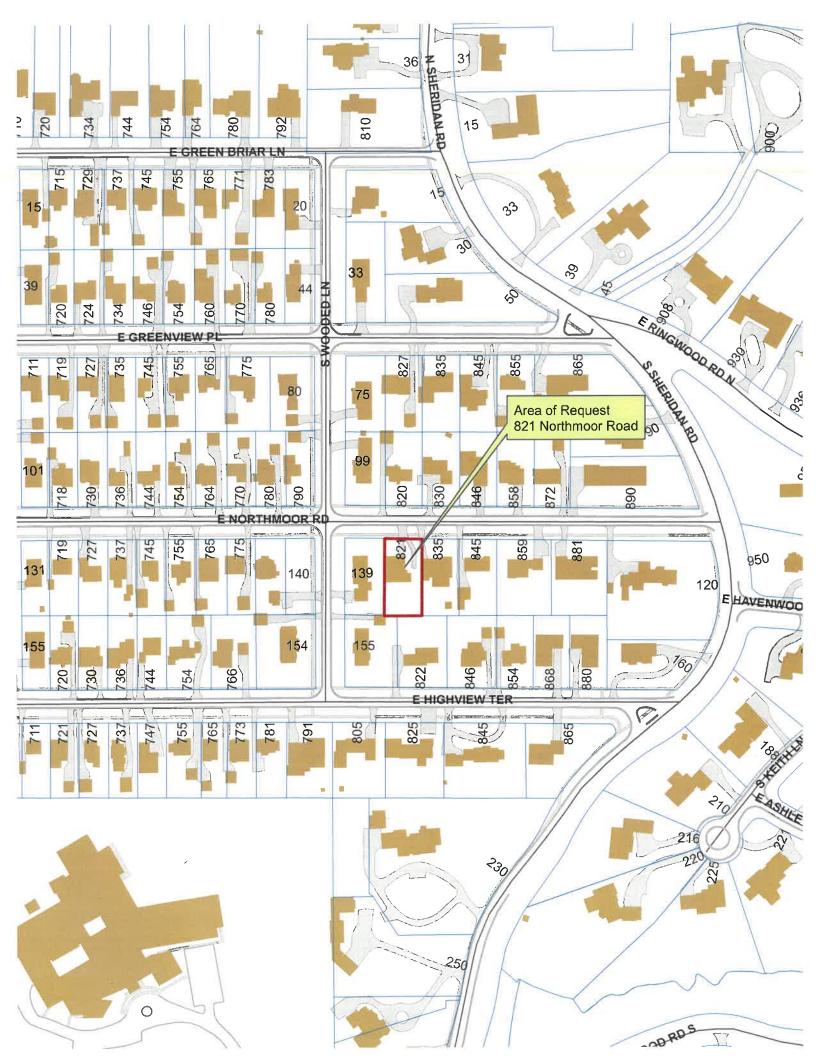







THE CITY OF LAKE FOREST ZONING BOARD OF APPEALS <u>APPLICATION OF ZONING VARIANCE</u>

PROJECT ADDRESS821 Northmoor Rd, Lake Forest, IL 60045								
ZONING DISTRICT R1								
Property Owner (s) Name		Black House LLC - Series 821 Northmoor						
(may be different from project address) Address		1225 Lincoln Ave S, Highland Park, IL 60035						
Phone		847-652-7519 Fax						
	patrick.sh	patrick.shaver@blackhouse.consulting						
Applicant/Representative Name			Patrick Shaver					
Title		Represer	ntative					
(if different from Property Owner) Address 1225 Lincoln Ave S, Highland Park, IL 60035								
	Address Phone	847-652-		,	Fax			
	Email		haver@black	house.c				
	=	-						
Beneficial Interests			Staff Reports a	are Availabi	le the Frid	day before the Meetii	ng	
Corporation	See Exhibit A		Email Report:	Owner		Representative		
	See Exhibit B		Fax Report:	Owner		Representative		
Trust, land or other	See Exhibit C		Pick Up Report:	Owner		Representative		
Signatures								
I have read the complete application packet and understand the variance process and criteria. I understand that this matter will be scheduled for a public hearing when a determination has been made that my application is complete.								
be defined for a pablic floating wi			······································	,	,			
Owner						Date		
Owner						Date		
12-28-2021								
Applicant/Representative					Date			

CORPORATE OWNERSHIP (EXHIBIT A)

Please list the names and addresses of all officers and directors of the Corporation and all shareholders who own individually or beneficially 5% or more of the outstanding stock of the corporation. In addition, this application must be accompanied by a resolution of the Corporation authorizing the execution and submittal of this application.

Name Patrick Shaver		ver	Name
Address	1225 Lincoln Ave	S, Highland Park, IL 60035	Address
Ownership	Percentage	100 %	Ownership Percentage %
Name			Name
Address			Address
Ownership	Percentage	9	Ownership Percentage%
Name			Name
Address			Address
Ownership	Percentage		Ownership Percentage%
Name			Name
Address	-		Address
Ownership	Percentage		Ownership Percentage %
No.			
Name			Name
Address	-		Address
Ownership	o Percentage	9	Ownership Percentage %

Black House, LLC.

1225 Lincoln Ave S Highland Park, IL 60035 847-652-7519

Lake Forest Zoning Board of Appeals 220 East Deerpath Lake Forest, IL 60045

February 17, 2022

To Whom it May Concern,

I am writing to you today regarding the property located at 821 Northmoor Rd, in Lake Forest, Illinois.

It is my intention to renovate and remodel the existing structure into a beautifully finished, modern home in your community to compliment the neighborhood. The current home was built in 1951 and has been neglected and seemingly abandoned which is made clear by the unruly foliage that has nearly engulfed the front of the home in its entirety. The home's design does not lend itself to appropriate modern living. The existing structure has a 1 car garage and 3 small bedrooms on the second floor which share 1 small hall bathroom. The electrical system is dated and insufficient, the windows are failing, and insulation is lacking. Furthermore, the home does not have central AC and utilizes small venting windows in conjunction with a house fan to circulate outside air to "cool" the home.

I am proposing a design to renovate the home to bring it up to current code and design principles including a layout that will suit any family and their needs for modern living while maintaining and enhancing the original 1950's contemporary styling. The small single car garage will be extended to the east into a 2-car garage. The second floor (in the front of the home) will be built over the new garage addition and will include a total of 4 bedrooms, 3 full baths, laundry, and mechanical room for the new HVAC system. Additionally, we will be building a 2nd story addition on the back of the home to house the Primary Suite, which will include a study, bedroom, bathroom, and walk-in closet.

As the Zoning Board of Appeals works to manage and zoning related changes, particularly change that impacts the setbacks and lot coverage, I would like to address the following areas: Front Yard Setback and Driveway.

Regarding the Setbacks and Driveway: The existing home sits approximately 39.23' from the North lot line on the Northeast corner of the garage, 13.1' from the East Lot line and 12.48' from the west lot line. Our proposed 2-car garage addition will be aligned with the existing face of the home and be expanded to the East to align with the existing attached screened porch, and have a 2nd story, 3' front cantilever which will provide both form and function. In addition to provide a beautiful design element it will also serve as weather protection for the residents and guests using the garage and front door. The driveway currently splits and runs along the east side of the house. We will be eliminating the east most drive


and have one single drive which will be approximately 20' wide to match the new 19' garage door and allow for simple access to the home. Although new driveway is slightly wider that 'normal' is covers less of the property than the current drive allowing for more greenspace and landscaping to minimize water run-off from the property.


It is my hope that the information I have provided will be sufficient for you to recognize the need for this home to be renovated and brought up to the current standards, utilizing modern design, technology, and equipment, while beautifying the neighborhood and the City of Lake Forest.


Warm Regards,

Patrick H. Shaver President

Patrick.shaver@blackhouse.consulting

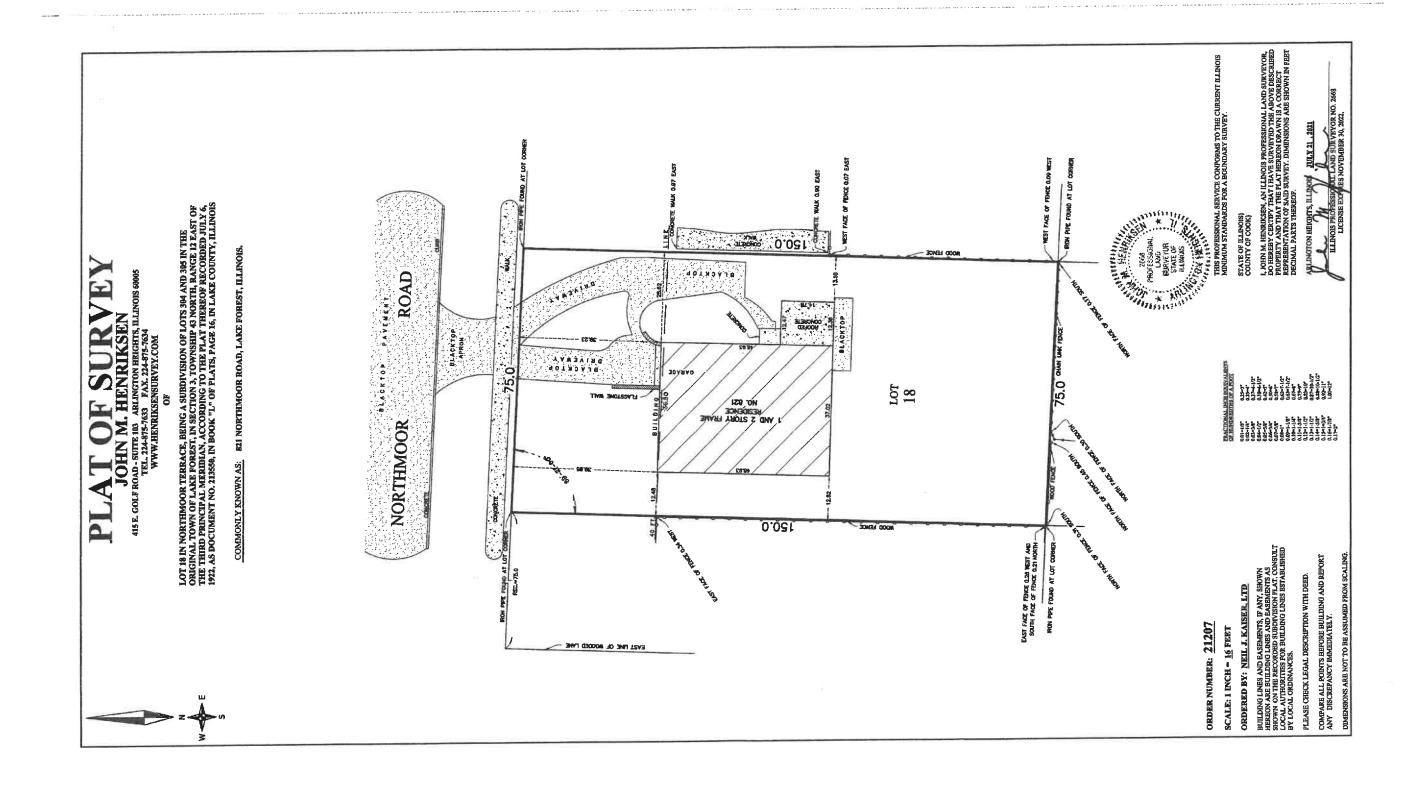


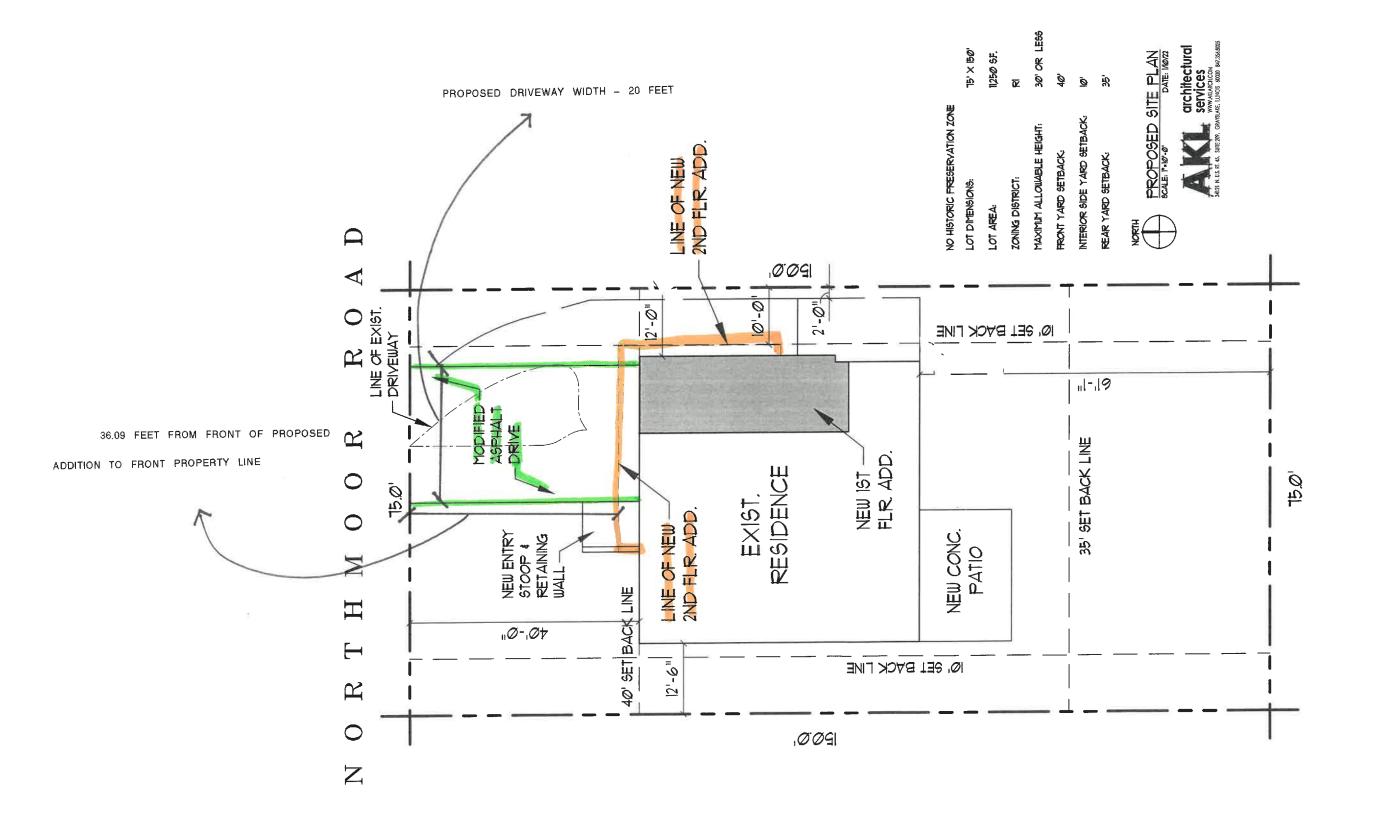

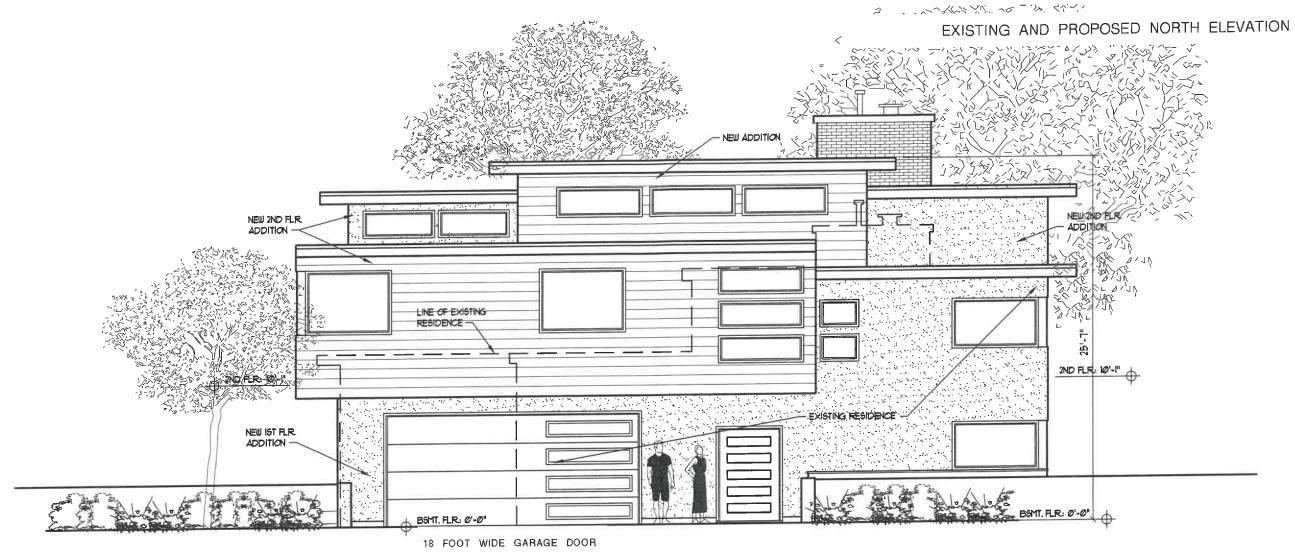


PROPOSED FRONT ELEVATION
SCALE: 1/4"=1'-0" DATE: 1/24/22



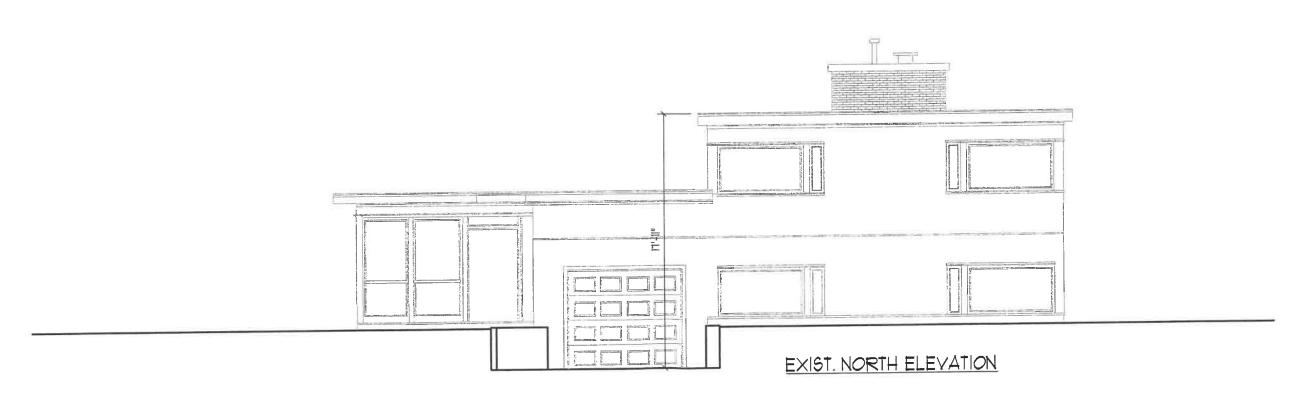




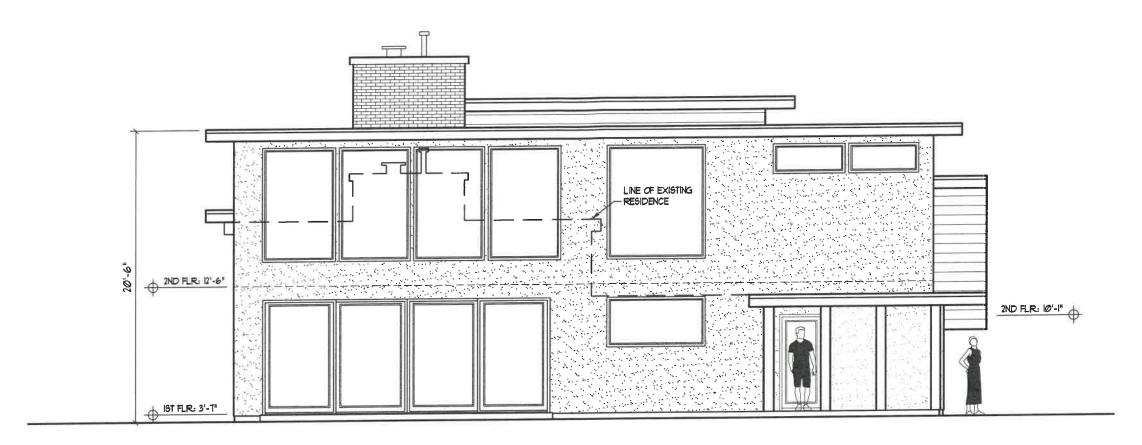







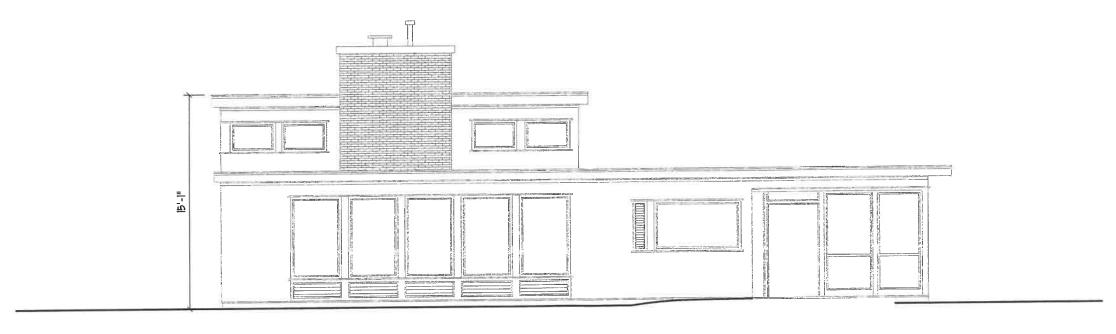

EXIST. SOUTH ELEVATION

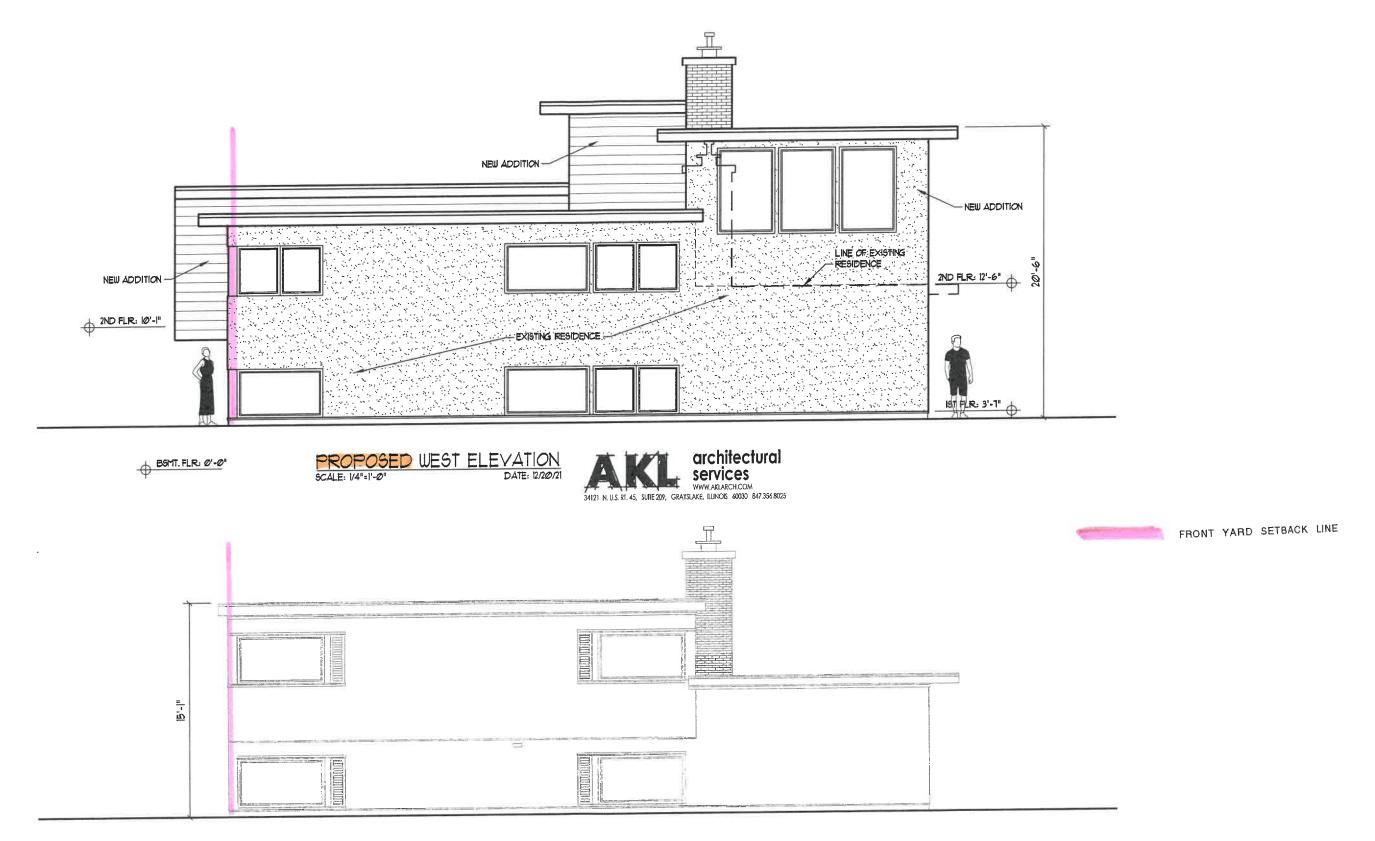


EXIST. WEST ELEVATION

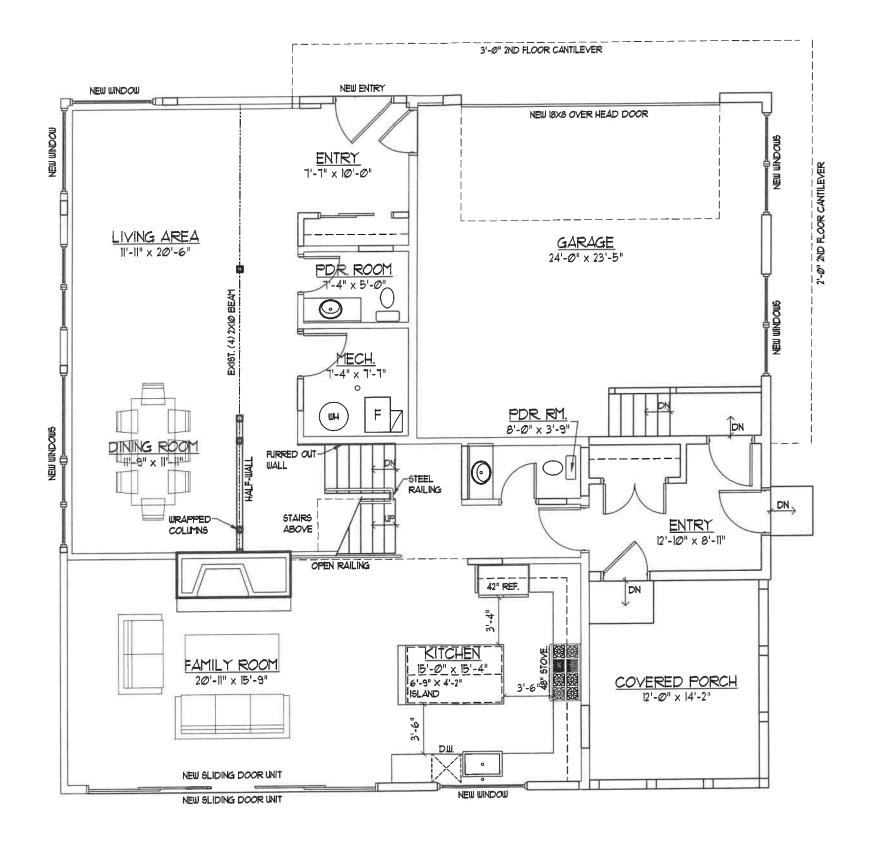






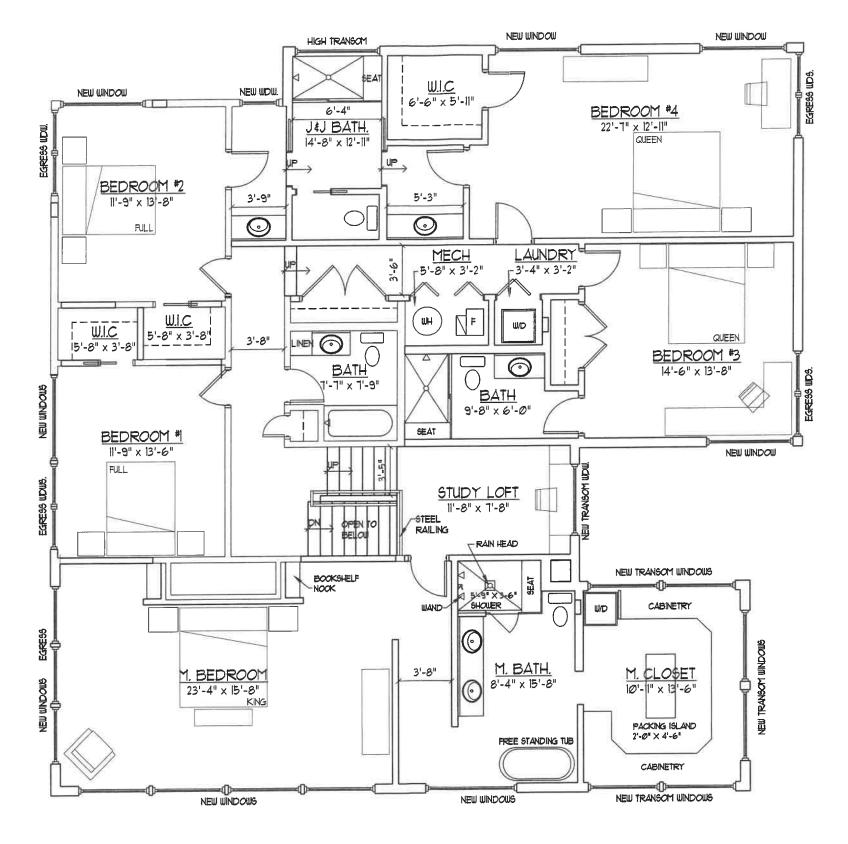

PROPOSED SECOND FLOOR SCALE: 1/4"=1"-0" DATE: 1/24/22




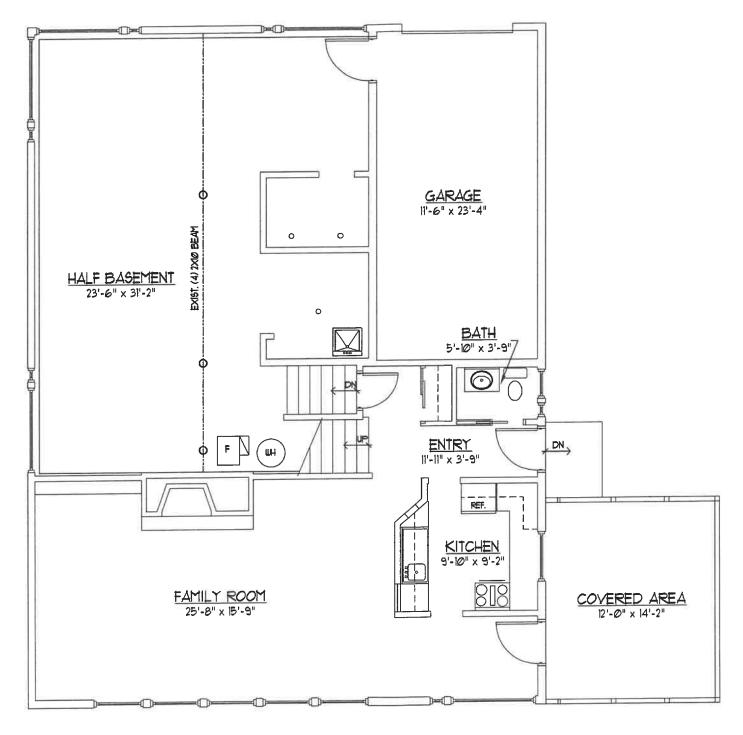

EXIST. FIRST FLOOR
SCALE: 1/4"=1"-0"


DATE: 8/28/21

34121 N. U.S. RT. 45, SUITE 209, GRAYSLAKE, ILLIMOIS 60030 847.355.8025

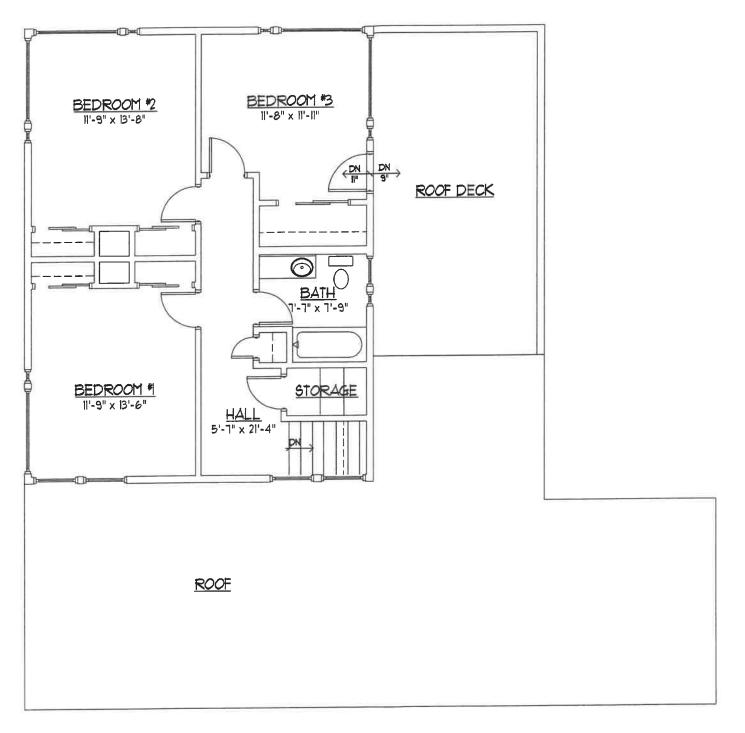





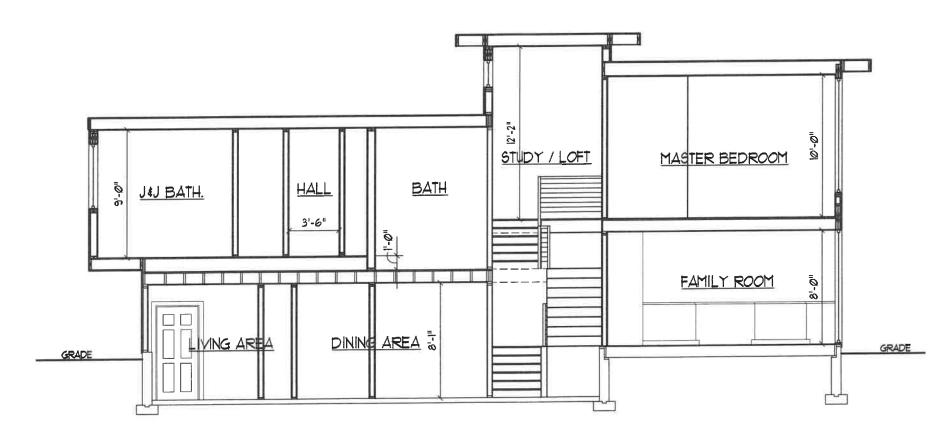


PROPOSED STAIRS SECTION SCALE: 1/4"=1"-0" DATE: 12/20/21











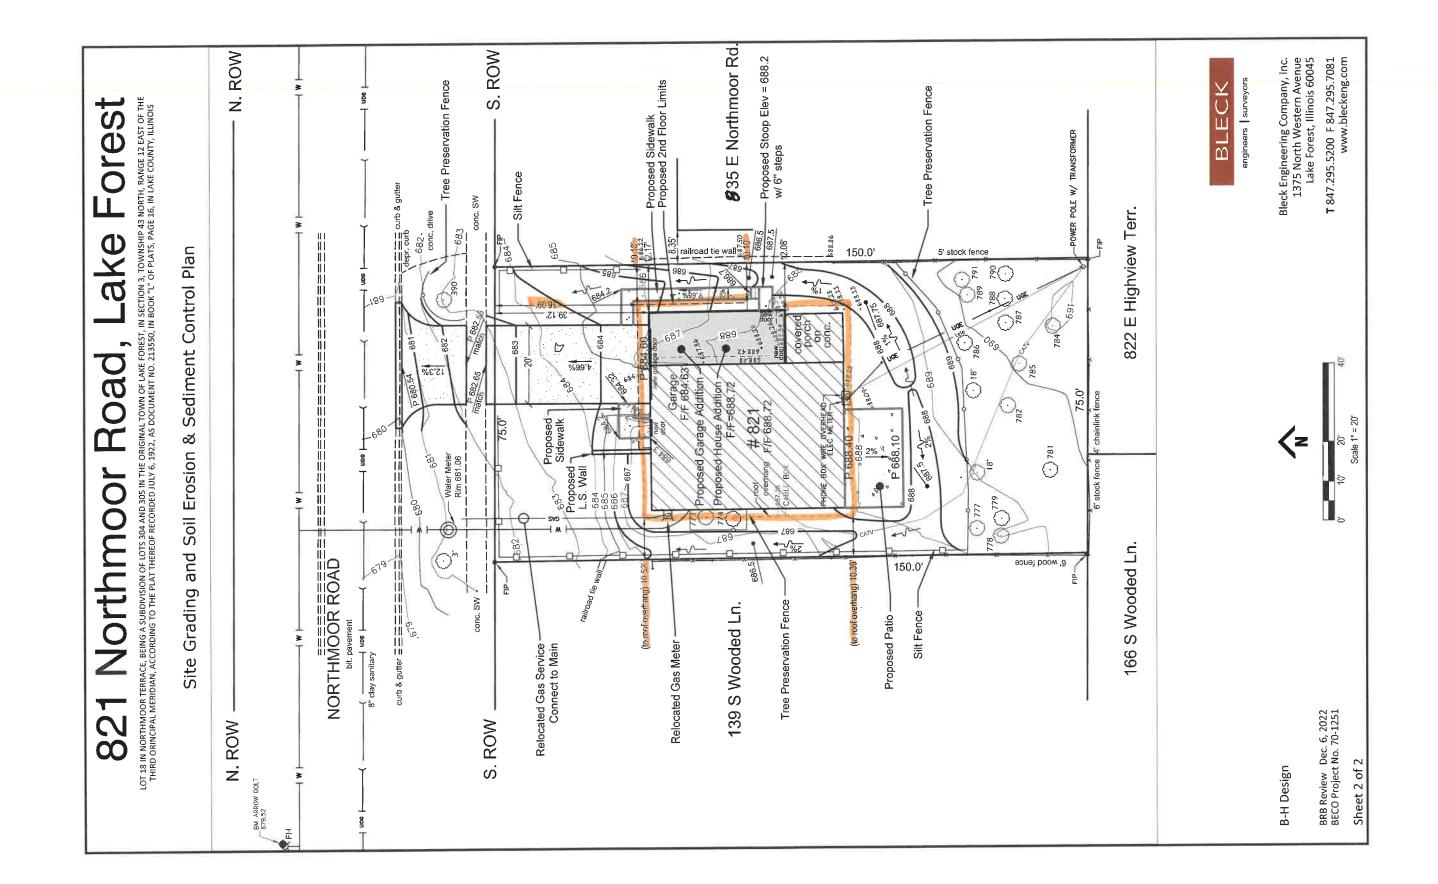

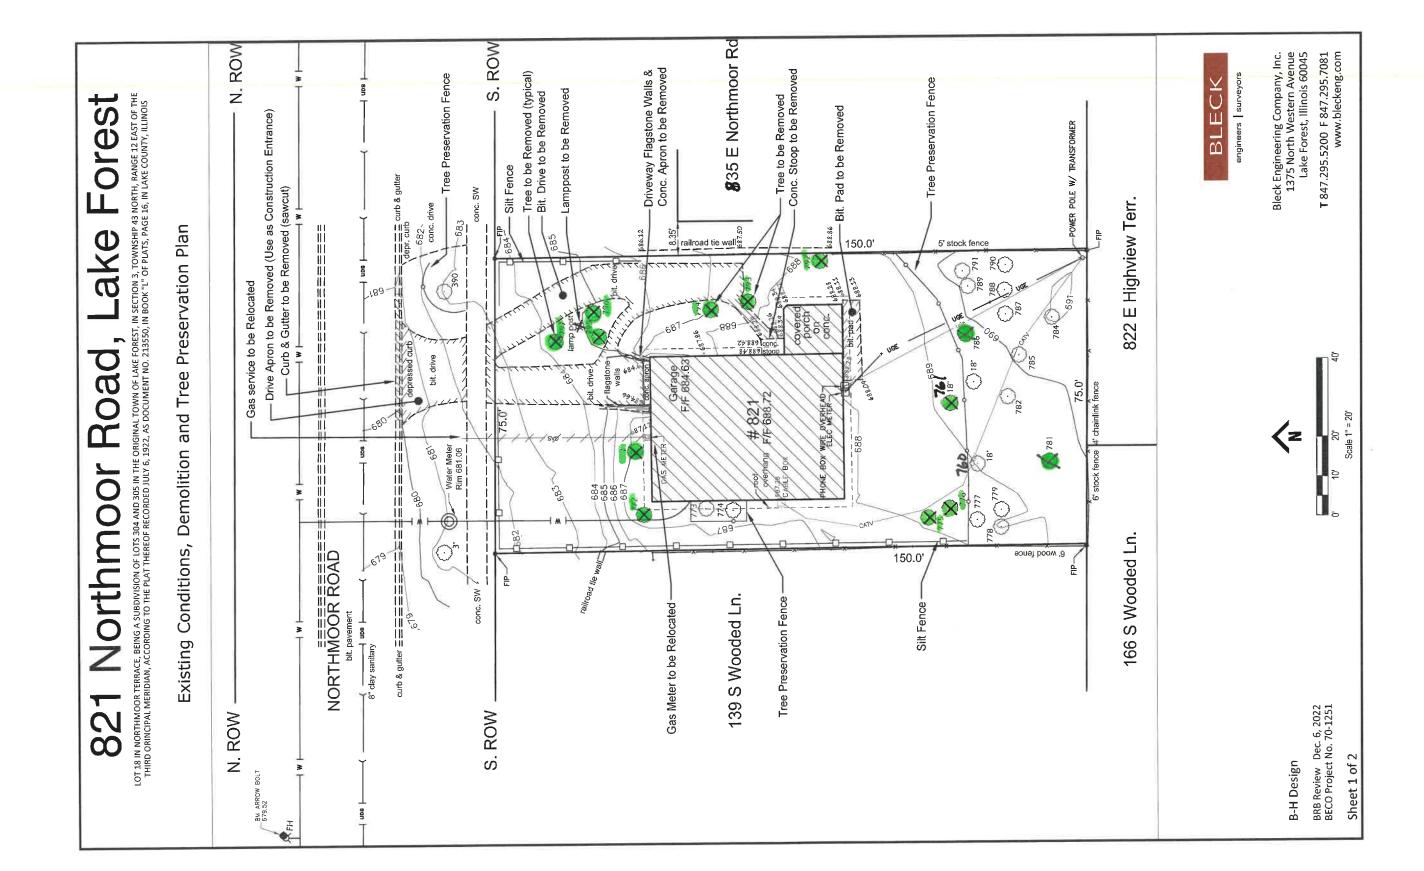


Tree Inventory	11/15/2021		
321 Northmoor			
Lake Forest IL 6	0045		
Гад #	DBH	Species	Condition
798	17	White Oak	Fair
797	15	White Oak	Good
796	14	White Oak	Fair
795		White Oak	Fair
794		White Oak	Fair
793		White Oak	Fair
792		White Oak	Fair
791		Red Oak	Fair
790		White Oak	Fair
789		Hemlock	Good
788		Hemlock	Fair
787		Hemlock	Fair
786		White Oak	Dead
785		White Oak	Fair
784		White Oak	Fair
783		Buckthorn	Good
782		Spruce	Poor
781		Pine Pine	Dead
780	21	Hemlock	Dead
779	13	Hemlock	Poor
778	25	Red Oak	Fair
777	18	Hemlock	Fair
776	19	Red Oak	Poor
775	THE RESIDENCE OF THE PARTY OF T	Spruce	Fair
774		Red Cedar	Fair
773		Red Cedar	Fair
772		Red Cedar	Fair
771	16	Red Cedar	Fair
770		Red Cedar	Fair
769		Arborvitae	Fair
768		Red Cedar	Fair
767	6	Arborvitae	Fair
760		Linden	Fair
761		White Oak White Oak	Fair
762	19	vvinte Oak	
Completed by:			
Miriam Kaufman	TRAQ, IL-9245A		



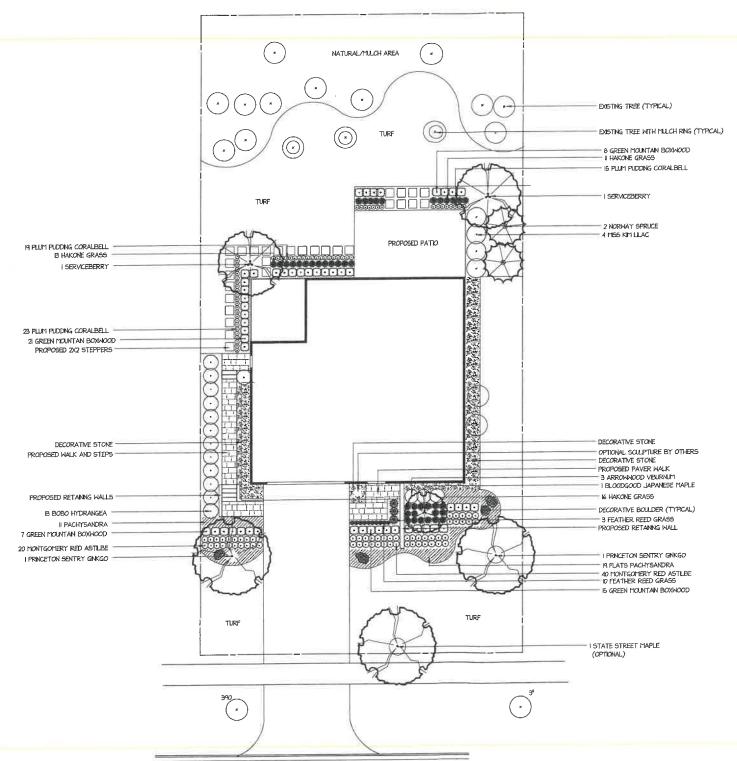

Qty	Botanical Name	Common Name	Size/Condition
Tree	×		
1	Acer miyabei Monton	STATE STREET MAPLE	41
Ι	Acer primatum Bloodgood	BLOODGOOD JAPANESE MAPLE	
2	Amelanchier grandflora	SERVICEBERRY	8'
2	Ginkgo bilaba Princeton Sentry	PRINCETON SENTRY GINKGO	40
Conif	ers		
2	Picea abies	NORWAY SPRUCE	81
Shru	bs		
51	Buxus 'Green Mountain'	GREEN MOUNTAIN BOXWOOD	18°
13	Hydrangeo pania/lata 'Boba'	BOBO HYDRANGEA	#3
4	Syringa patula Miss Kimi	MISS KIM LILAC	36"
3	Viburnum dentatum Rabin Senior	ARROWWOOD VIBURNUM	36"
Onno	mental Grasses		
В	Calamagnestis Karl Forester	FEATHER REED GRASS	I Gallon
40	Hakonechloa 'Aureola'	HAKONE GRASS	I Gallan
Pere	mials and Annuals		
60	Astiloe Montgomery Red	MONTGOMERY RED ASTILBE	I Gallan
57	Heuchera Plum Pudding	PLUM PUDDING CORALBELL	l Gallan
Grou	ndcovers		
30	Padrysandra Green Carpet	PACHYSANDRA	Flat

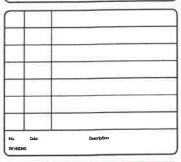



OVERALL LANDSCAPE PLAN

821 NORTHMOOR ROAD LAKE FOREST, ILLNOIS

SOME F = I(I' - 0')

DRAWN BY KEB

GEDED BY

ONTE JANUARY II, 2022

DATE OF PRINT

SHEET NO.











Agenda Item 7

612 E. Woodland Road Steep Slope Setback Variance

STAKING DIAGRAM

Staff Report Vicinity Map Air Photos

Materials Submitted by Petitioner

Application
Statement of Intent
Proposed Site Plan
Enlarged Site Plan
Proposed Elevations

Proposed Floor Plans

Images of Existing Home and Proposed Renderings Proposed Landscape Plan Plat of Survey with Steep Slope Setback Line Shown

Tot of copy of with crosp crops consider Enterent

612 E. WOODLAND ROAD, LAKE FOREST, IL

Point #	Northing	Easting	Elevation	Description
2001	2037932.0438	1120075.6098	0.00	COR GARAGE
2002	2037934.0561	1120049.6878	0.00	COR GARAGE
2003	2037957.9872	1120051.5455	0.00	COR GARAGE
2004	2037957.7550	1120054.5365	0.00	COR GARAGE
2005	2037966.5806	1120055.2216	0.00	COR GARAGE
2006	2037965,0327	1120075.1616	0.00	COR GARAGE
2007	2037956.2071	1120074.4765	0.00	COR GARAGE
2008	2037955.9749	1120077.4675	0.00	COR GARAGE
2009	2037973.1309	1120030.5317	0.00	COR PORCH
2010	2037992.5724	1120032,0409	0.00	COR PORCH
2011	2037973.5434	1120025.2176	0.00	COR ADDITION
2012	2037992.9849	1120026.7268	0.00	COR ADDITION
2013	2037993.1264	1120024.9042	0.00	COR ADDITION
2014	2038007.7524	1120026.0396	0.00	COR ADDITION
2015	2038008.8298	1120012.1595	0.00	COR ADDITION
2016	2037994 2059	1120010.9981	0.00	COR ADDITION




engineers surveyors

Bleck Engineering Company, Inc. 1375 North Western Avenue Lake Forest, Illinois 60045

T 847.295.5200 F 847.295.7081 www.bleckeng.com



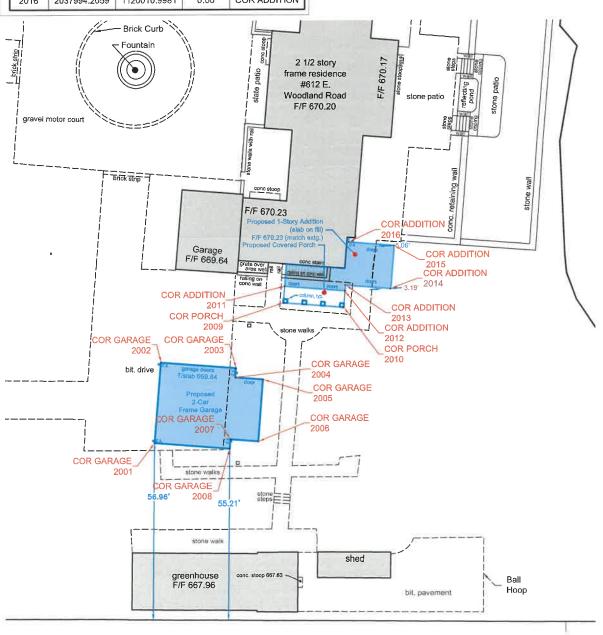



STAFF REPORT AND RECOMMENDATION

TO: Chairman Sieman and members of the Zoning Board of Appeals

DATE: February 28, 2022

FROM: Michelle E. Friedrich, Planning Technician

SUBJECT: Steep Slope Setback Variance

OWNER PROPERTY LOCATION ZONING DISTRICT

612 E. Woodland Road Trust #1 (Greg Sleight) and 612 E. Woodland Road Trust #2 (Megan Sleight) 67 E. Bellevue Place Chicago, IL 60611 612 Woodland Road R4 – Single Family Residence

REPRESENTATIVE

Gary Beyerl, architect

SUMMARY OF REQUEST

This request is for approval of a steep slope setback variance for a portion of a single story addition on the northeast corner side of the residence and two dormers sited on the north facing roof of the residence. The property owners recently acquired the property and desire to make some modest upgrades to the home.

The property is part of the Edison Dick Subdivision recorded in 1998 and is located on the north side of Woodland Road, just west of Meadow Lane. The property is in the East Lake Forest Historic District and the Historic Preservation Commission recently approved the design aspects of the project. The residence was constructed in 1932 and is known as the Edison Dick House. A ravine extends through the northern portion of the property.

FACTS

Compliance/Non-Compliance with Key Code Requirements

- * The existing house complies with the front and side yard setback requirements.
- The existing house encroaches into the steep slope setback.
- ❖ The proposed project complies fully with the lot coverage limitation.
- ❖ The proposed project complies with the Building Scale limitation.
- ❖ The proposed project requires a steep slope setback variance.

Physical, Natural or Practical Difficulties

A significant portion of the northern portion of the property is a ravine.

STAFF EVALUATION

The proposed single story addition at the northeast corner of the house is intended to expand the family and breakfast rooms, located off of the existing kitchen. This area of the home was originally part of the service portion of the house and the property owners' intent is to create a space for modern day families. The northern most portion of this addition encroaches into the steep slope setback a very small distance, about 4 feet.

Two dormers are proposed on the main mass of the residence, on the north facing roof. This area of the existing house falls within the steep slope setback and although no expansion of the building footprint is proposed, a steep slope setback variance is required because the dormers add mass to the portion of the house within the steep slope setback. The proposed dormers egress from the bedroom space on the third floor as required by Code.

A detached garage and various landscape and hardscape improvements are also proposed but do not require a variance or any action by the Zoning Board of Appeals.

FINDINGS OF FACT

Based on review of the information submitted by the petitioner and an analysis of this request based on applicable portions of the Zoning Code, staff submits the following findings.


- The requested steep slope setback variance will not alter the essential character of the neighborhood since the additions are modest and the portion of the additions located within the steep slope setback is extremely small. The proposed alterations are for the purpose of making the house more livable for the current and future owners.
- 2. The conditions upon which the variance is requested, the location of a portion of the residence in the steep slope setback due to construction prior to the regulation, the minimal extent of the improvements located within the setback area and verification by the City Engineer that the proposed improvements are consistent with the intent of the steep slope provisions in the Code are not generally applicable to other properties in the same zoning district.
- 3. The hardship in conforming to the steep slope setback results from the application of the steep slope setback requirement after the house was constructed.
- 4. The variance and the resulting additions will not impair light or ventilation to adjacent properties, increase congestion, endanger public safety, or substantially diminish property values in the area. The additions face the ravine and do not directly impact surrounding neighbors.
- 5. The City Engineer determined that the limited construction proposed within the steep slope setback in consistent with the purpose of the Steep Slope provisions of the Code.


PUBLIC COMMENT

Standard public notice of this request was provided by the City to surrounding property owners. Notice was also provided in the <u>Lake Forester</u> and the agenda was posted at five public locations and on the City's website. As of the date of this writing, no correspondence has been received for this project.

RECOMMENDATION

Based on the findings presented in the staff report, recommend approval to the City Council of a variance from the steep slope setback requirement as depicted on the plan submitted to the Board.

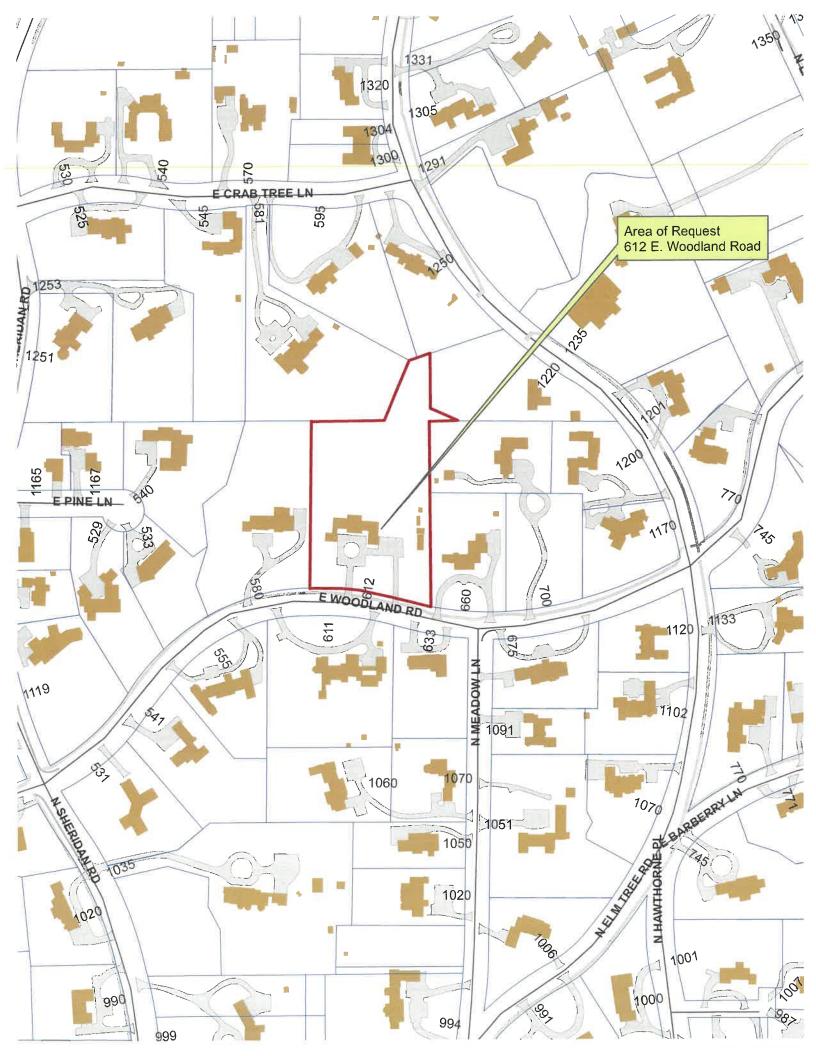

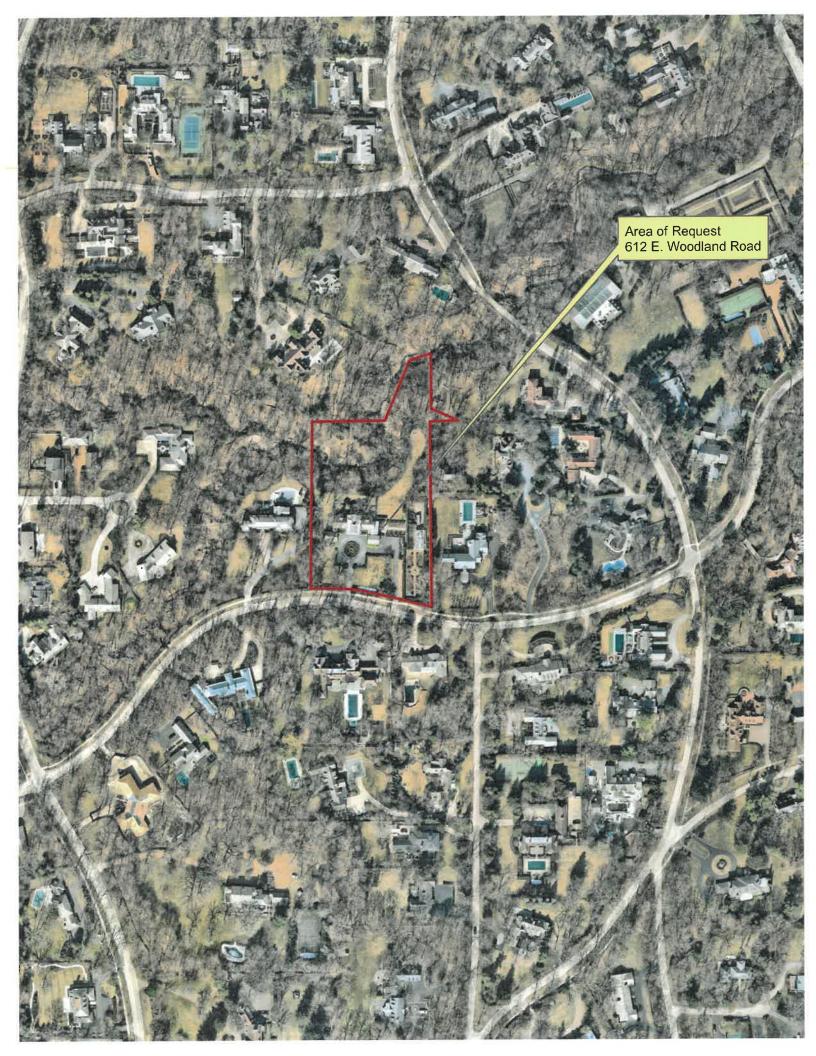





THE CITY OF LAKE FOREST ZONING BOARD OF APPEALS APPLICATION OF ZONING VARIANCE

PROJECT ADDRESS 612 E. WOODLAND RD					
ZONING DISTRICT					
		612 E. Woodland Road Tr	ust #		
Property Owner (s)	ame MEGAN M. AND CREC SL	GS Tenants in Common	1 #2		
(may be different from project address) Add	ress 67 E. BELLEVUE PL., CHI	67 E. BELLEVUE PL., CHICAGO, IL 60611-1114			
	none 312-944-0624	Fax			
E	mail meganmsleight@gmail.com,	sleight.greg@gmail.com			
Applicant/Representative N	ame GARY BEYERL / BBA ARC	CHITECTS			
	Title PROJECT ARCHITECT				
(if different from Property Owner) Add	ress 1010 S. WABASH AVE., CI	CHICAGO, IL 60605			
	none 312-663-0222	Fax			
E	mail beyerl@bbaworld.com				
Beneficial Interests		s are Available the Friday before the Meeting			
Corporation		Owner Representative			
Partnership		Owner Representative			
Trust, land or other See Exh	ibit C Pick Up Report:	Owner Representative			
			=		
Signatures					
I have read the complete application packet of the scheduled for a public hearing when a de-	and understand the variance process termination has been made that my a	s and criteria. I understand that this matter will application is complete.			
be scheduled for a public hearing when a determination has been made that my application is complete.					
12/10/1021					
Owner		Date			
Wegand Sleigh	t	12/10/2021			
Owner ()	^	Date			
Bane	2	2/17/2022			
Applicant/Representative		Date			

TRUST OWNERSHIP (EXHIBIT C)

Please list the Trust number and name and address of the Trustee, as well as the names and addresses of all beneficiaries of the Trust, together with their respective interests in the Trust. The application shall be further verified by the applicant in his capacity as Trustee or by the beneficiary as a beneficial owner of an interest in the Trust and the application shall be signed individually by as many beneficiaries as are necessary to constitute greater than 50% ownership of the beneficial interest of the trust.

TRUST NUMBER MA	TRUSTEE INFORMATION
ľ	Name Brad Gerber
	Firm Harrison Held LLP
	333 W. Whoker DD Swite 170
	Address Chicago IL Goleolo
	Phone 312 - 540 - 49 65
Beneficiaries 612 E Woodland Ross	l Residence Trust #1
Name Grey Sleight as Trustee of the Grey Sleight Livin	
of the Greg Skight Liviv	7 Trust
Address Dated October 14, 2020	Address
Trust Interest /00 %	Trust Interest%
612 E. Wordland Road Ke.	sidence Trust #2
Name Megan Sleight as Trustee of the Megan Sleight Living Address clated October 14, 2020	Name
of the Megan Skeight Living	Trust
Address clated october 14, 2020	Address
Trust Interest 100 %	Trust Interest%
Name	Name
Address	Address
Trust Interest %	Trust Interest%



ZBA - STATEMENT OF INTENT

DATE: JANUARY 21, 2022

PROJECT: Edison Dick House

612 E. Woodland Rd.

Lake Forest, IL

PETITION REQUEST: Approval for proposed Family Room/Breakfast room addition and 3rd floor egress dormers, proposed location within the ravine setback. The proposed design meets the bulk calculation requirements for this property, and relief is not required for square footage.

STATEMENT: The primary intent of this petition is to request approval for New Additions and Renovations to the primary residence located at 612 E. Woodland Rd. These improvements include:

- 1st floor Addition for a Family Room with Porch and Breakfast Room
- 3rd floor Additions for egress dormers
- New detached garage
- Renovation of existing home and landscaping

A portion of the proposed addition to the 1st floor NE corner and 3rd floor egress dormers are within the rayine setback

OVERALL DESIGN INTENT: To maintain the existing character of the structure and property, and transform the existing east 1st floor rooms from service spaces into living spaces integral to the home and upgraded with the level detail found in the original public spaces, using the original drawings, details and with proposed alterations that were prepared by David Adler.

BACKGROUND/HISTORICAL DATA/OBJECTIVE: The existing 2-½ story wood residence is a significant and well-known residence, originally designed by David Adler. Our clients are the 3rd owners of the property, and the residence and landscape has been well-preserved and maintained, even with the modifications throughout the years.

The subject property was originally part of a larger parcel, and was subdivided in 1998 into the 2 current properties. The property abuts a wooded ravine in the back, with original terraces leading from the residence to the ravine edge. There is a significant amount of drawings and photographs available of the original design (published in various books, Art Institute archives, blueprints provided during the property transfer).

The owners are a young family who are sensitive to the property and the historic context. The owners would like to modify and renovate the main home to meet their programmatic family needs, and modern realities (i.e., size of modern family vehicles), basing the design on the original Adler design

(built and not realized).

The proposed design for the Kitchen, Family Room, and Breakfast Room elevates these areas to the level of importance and detail as the historic public areas (Living Room and Dining Room). Originally, this portion of the building was a servant's wing and the rooms were much more utilitarian and without much detail. The proposed 3rd floor egress dormers provide natural light and ventilation, as well as a secondary egress for the bedroom (as required by current building codes). The proposed detached garage provides necessary vehicle and storage space.

STANDARDS FOR VARIATIONS: As set forth by the City of Lake Forest:

The variation, if granted, will not alter the essential character of the locality:

- The existing home is currently set within the ravine setback line. The top of the ravine edge has varied throughout the years, as a natural evolution of the topography.
- The proposed 1st floor and 3rd floor additions are minimally visible from the street in the hedge opening at the main and east drives, as depicted in the submitted photos and model.
 The proposed detached garage is primarily visible along the axis of the east drive, and matches the existing front elevation of the historic attached garage pavilion.
- We have endeavored to design the modifications so that the appearance of bulk is mitigated.

The conditions upon which a petition for a variation are based are unique to the property for which the variation is sought, and are not applicable, generally, to other property with the same zoning classification:

- The original home, including the north terraces, were constructed in 1933. The City of Lake Forest established a Steep Slope Ordinance in January, 2011, to address ongoing issues of ravine erosion and maintenance, as affected by adjacent property improvements (buildings and landscaping)
- The proposed 1st floor additions at the NE corner of the home are minimal enlargements to the existing footprint, to accommodate the family's programmatic requirements while elevating these spaces to the more formal and detailed design of other public spaces in this home.
- The proposed 3rd floor egress dormers are placed on the existing building footprint; are modeled on the typical dormer shape, scale and profile for this property; are located to maintain existing main roof eave and fascia; and are set lower than the prominent main ridge.
- The proposed detached garage (located within the required zoning setbacks), is located in relation to the existing attached garage; no zoning relief is required for this addition.

The alleged difficulty or hardship in conforming with the requirements of this Chapter is caused by this Chapter and has not been created by any persons presently or formerly having an interest in the property:

• This request will not offer the owners a special privilege that other property owners do not enjoy.

The proposed variation will not impair an adequate supply of light and air to adjacent property:


• This request will not impair the public health, safety and welfare of the surrounding neighborhood.


PROPOSED DESIGN: The proposed modifications will not adversely impact the neighborhood or property character. The proposed modifications are classically designed, based on the existing David Adler drawings and sketches (realized and unrealized designs and details), and use high quality traditional materials that will withstand the test of time, and match adjacent surfaces. The proposed exterior is simple, understated and composed of natural materials such as wood siding and wood shakes.

ALTERNATIVE STUDIES: We have explored several alternatives to the design, especially the proposed 1st floor addition footprint, to minimize the impact within the ravine setback while elevating the design of these areas to correspond with the formal design and layout typical throughout the historic residence. We feel that the petition before you has been carefully considered, and will have little impact on the appearance of the home and property.

Due to the relatively minimal visibility of the proposed additions, the owners have not reviewed the petition with the surrounding neighbors, but are in communication with the Lake Forest Historic Preservation department: the proposed additions will be presented to the Historic Preservation Committee prior to the Zoning Board.



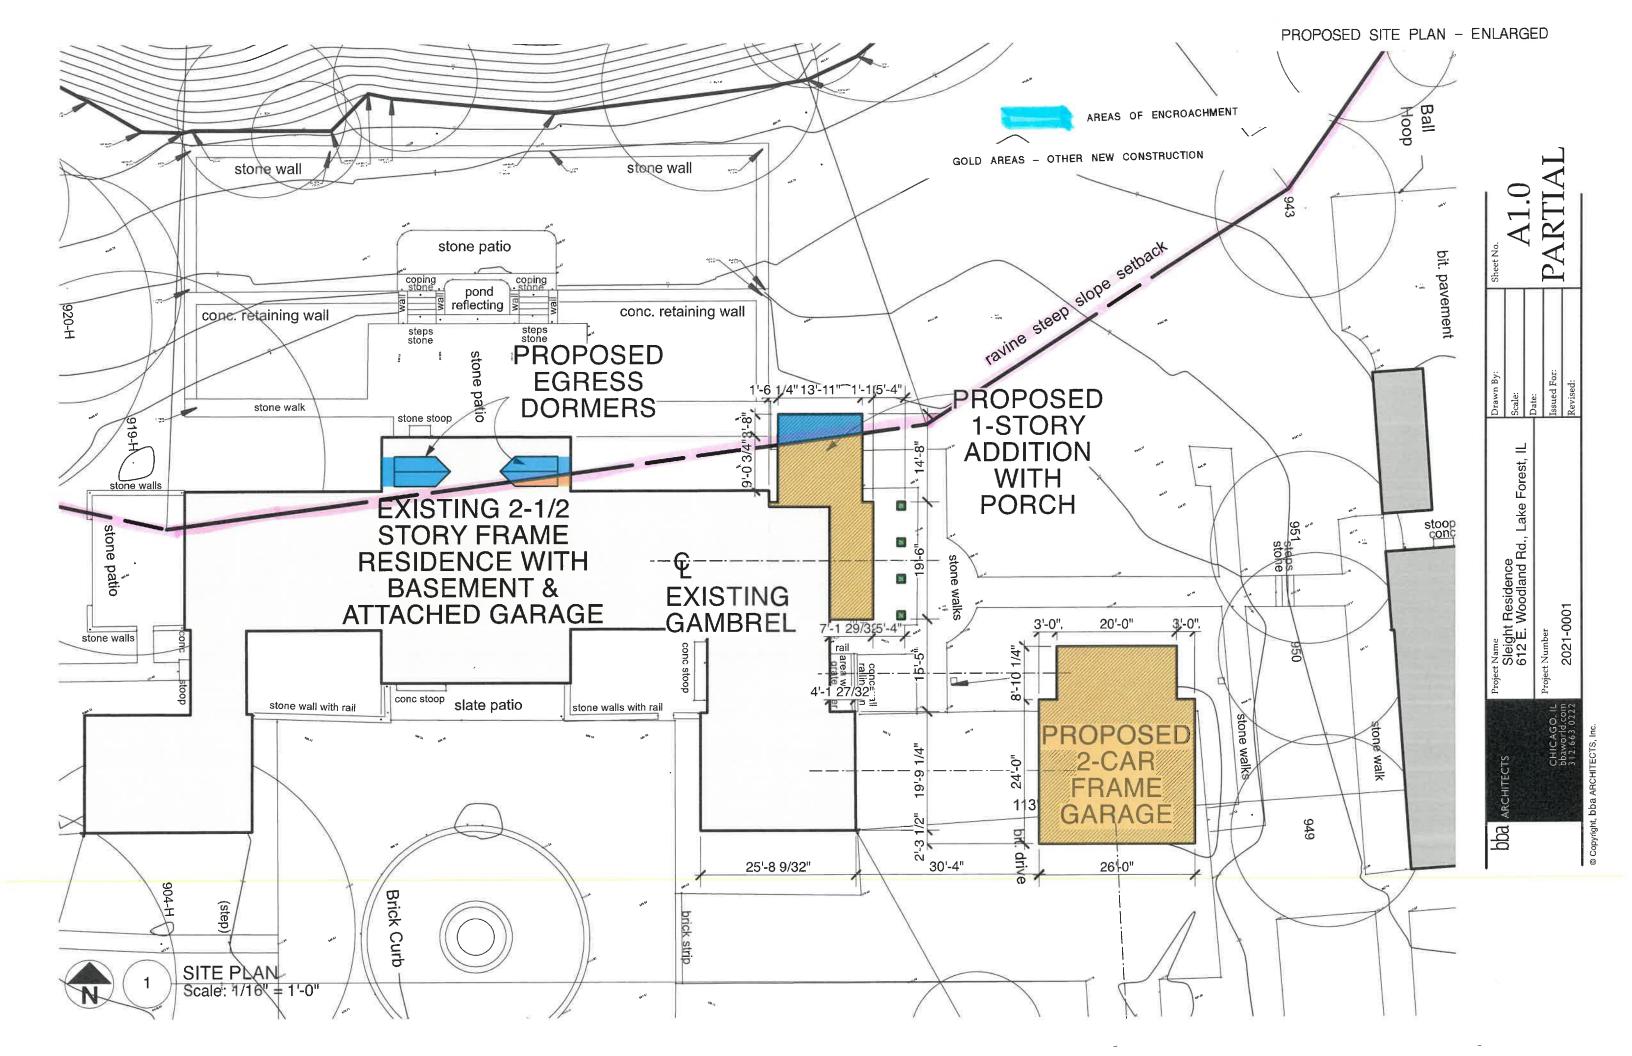

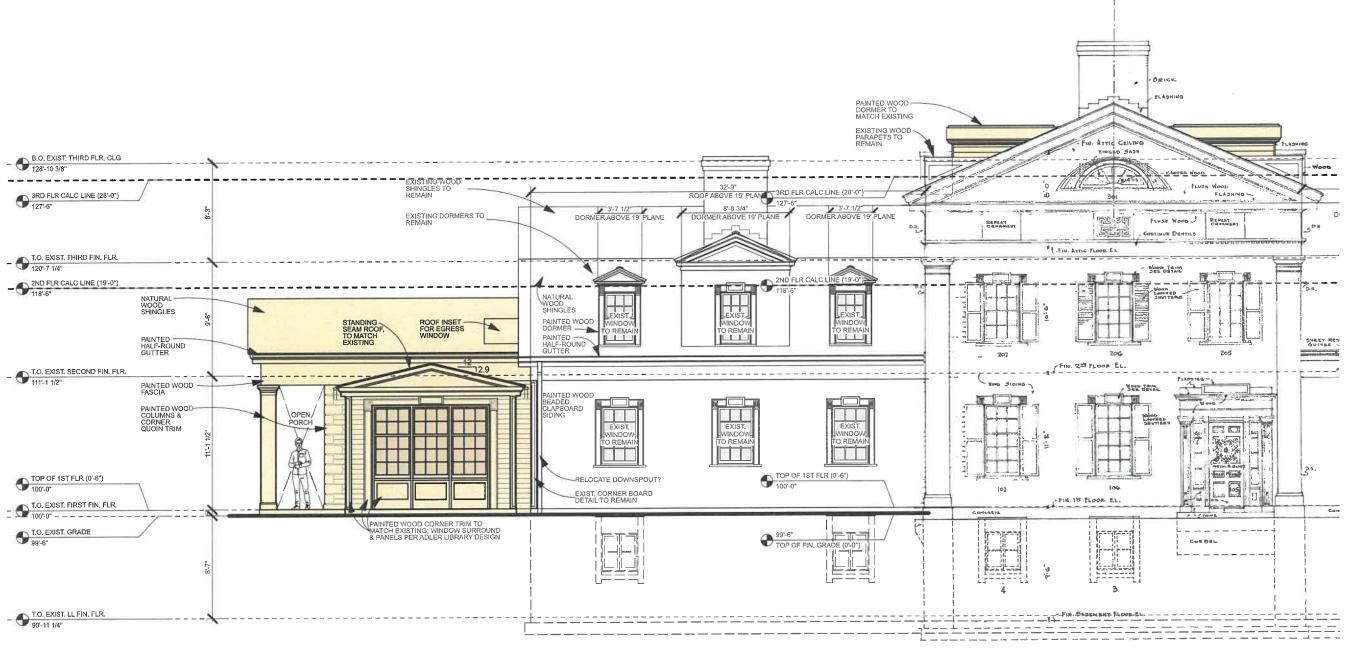




1


NORTH (REAR) - PROPOSED DETAIL ELEVATION

Scale: 1/8" = 1'-0"

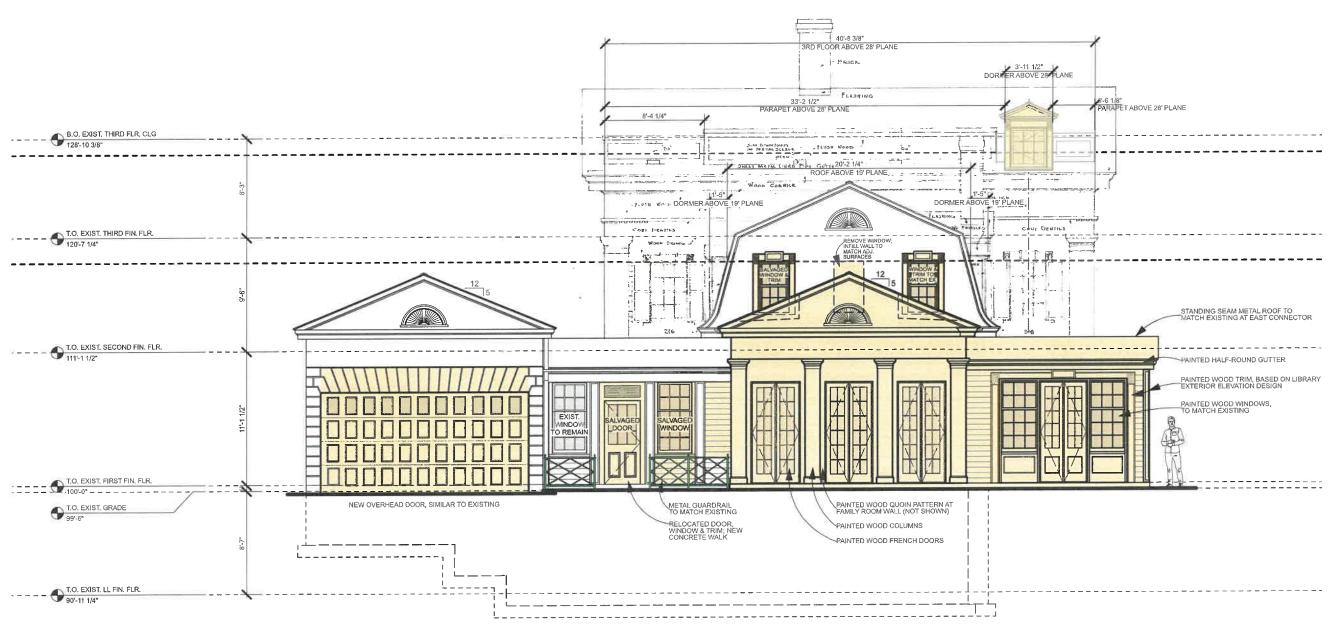

EAST (SIDE) - PROPOSED ELEVATION Scale: 1/8" = 1'-0"


Project Name
Sleight Residence
612 E. Woodland Rd., Lake Forest, IL
Project Number
2021-0001 ppa

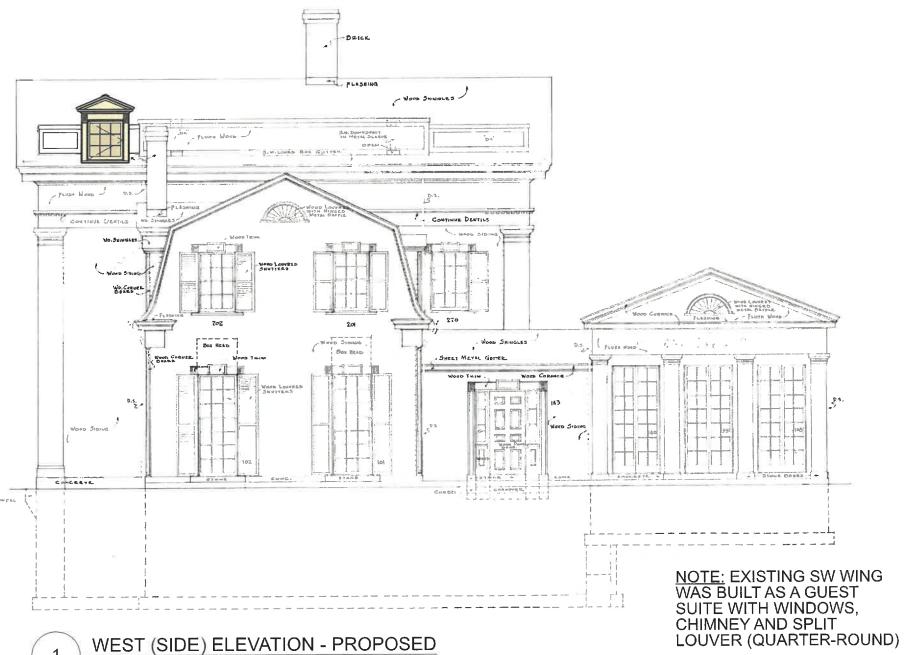

NEW-WEST Project Name Sleight Residence 612 E. Woodland Rd., Lake Forest, IL ARCHITECTS ppa

WEST (SIDE) ELEVATION - PROPOSED


Scale: 1/8" = 1'-0"

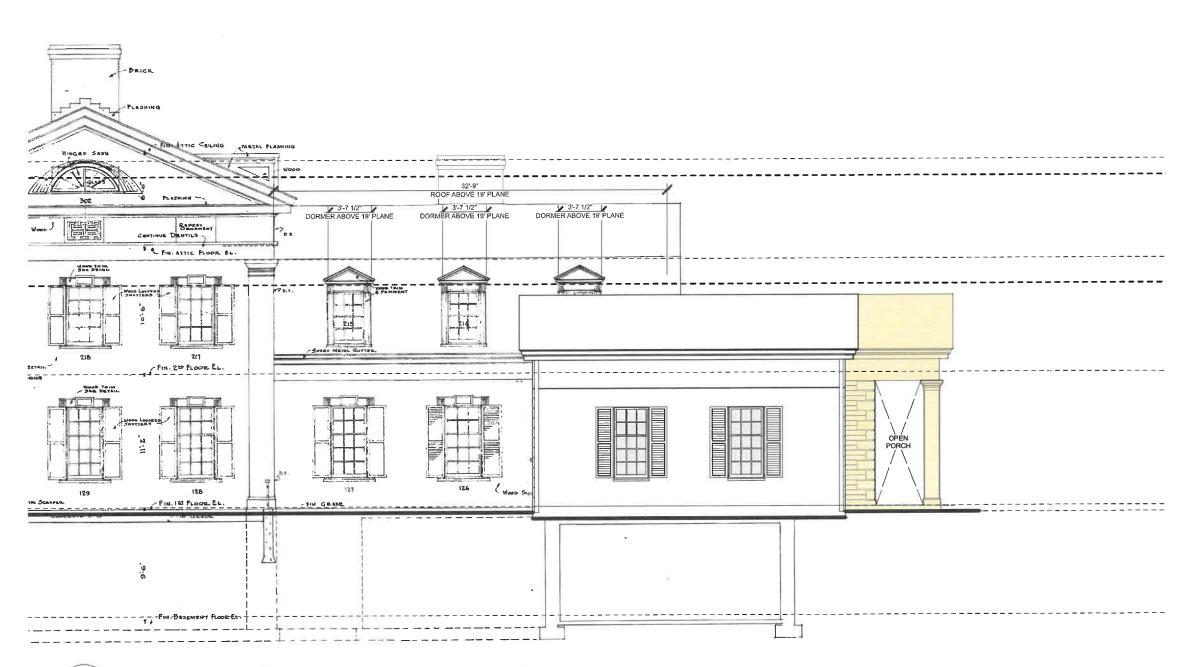

Project Name Sleight Residence 612 E. Woodland Rd., Lake Forest, IL

ppa

SOUTH (FRONT) - PROPOSED DETAIL ELEVATION
Scale: 1/8" = 1'-0"

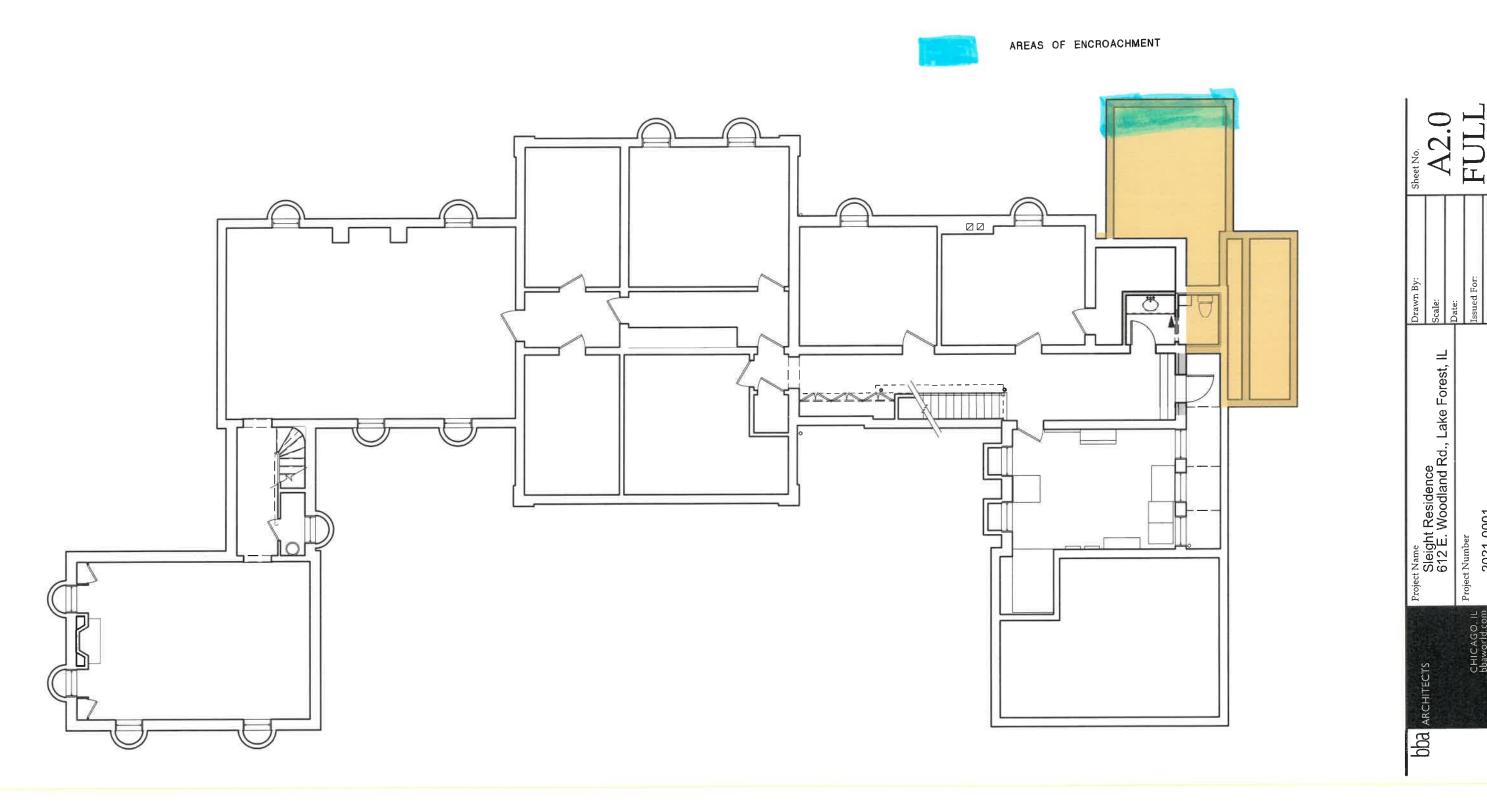




(1

LOWER LEVEL FLOOR PLAN (FULL)


Scale: 3/32" = 1'-0"


ct Number 2021-0001

ARCHITECTS

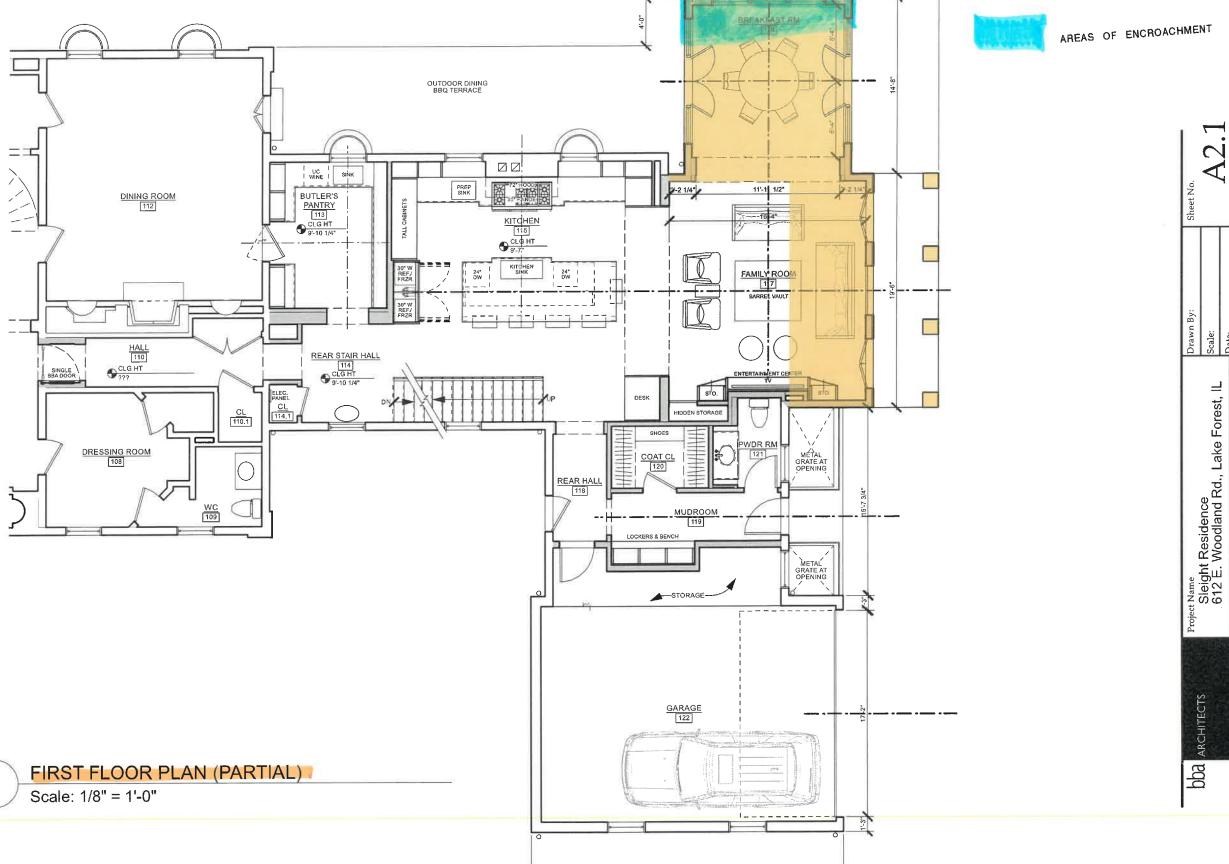

N

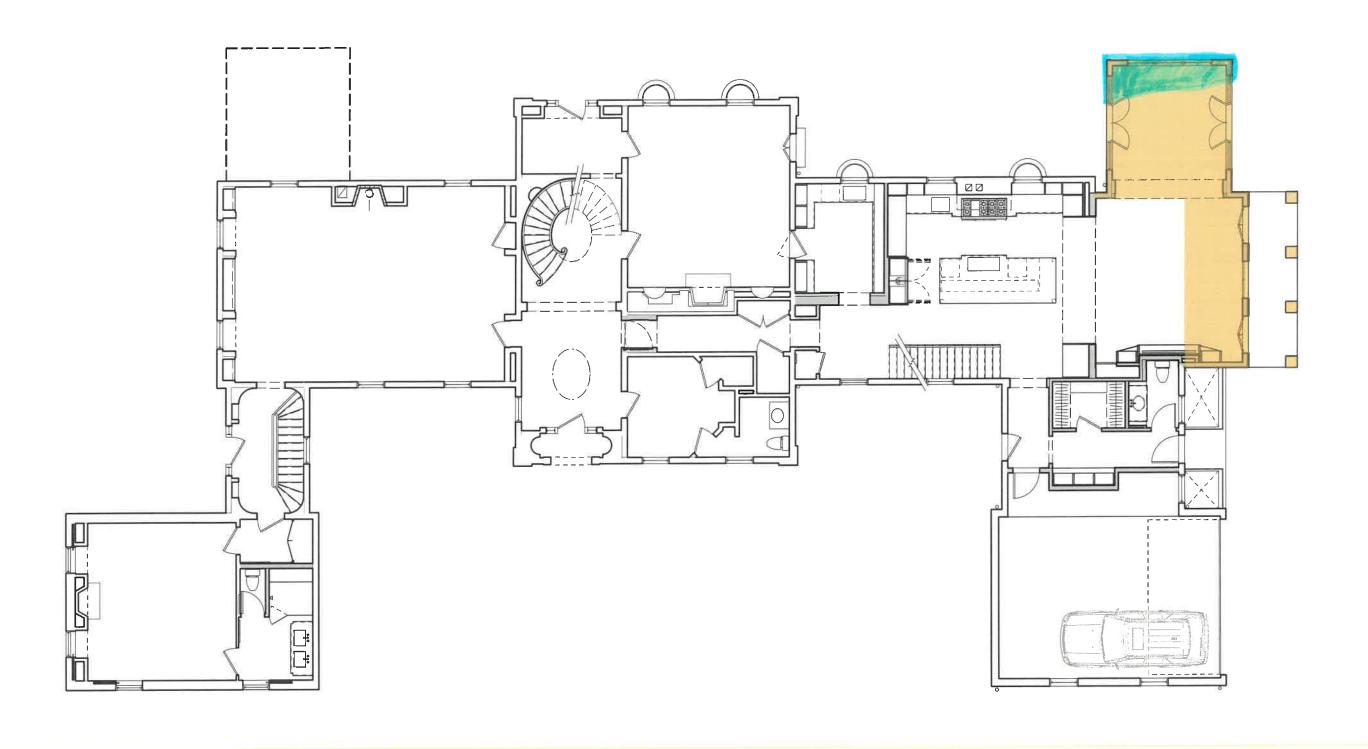


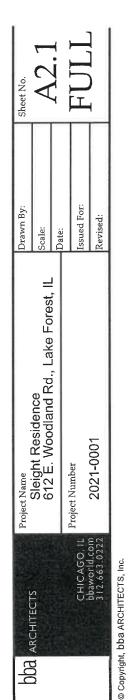








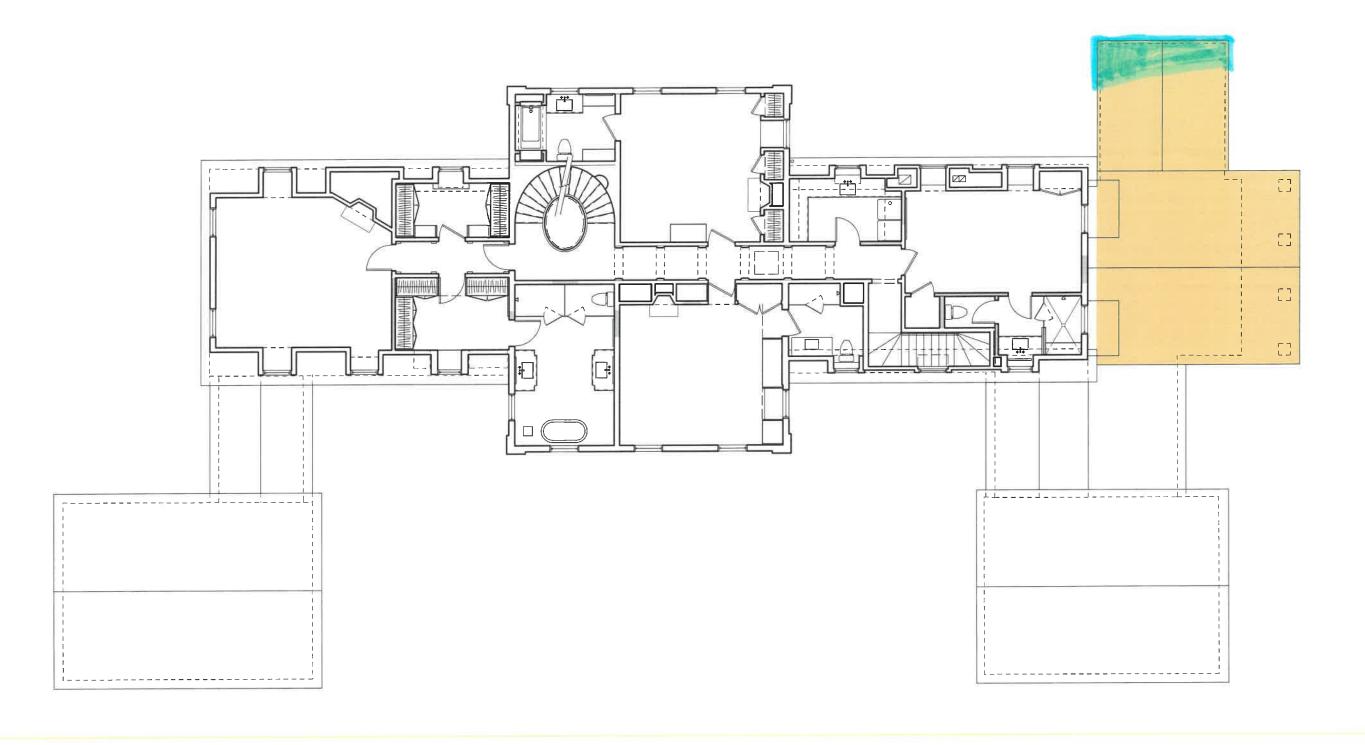

Lha san san	Project Name	Drawn By:	Sheet No.
DDU ARCHITECTS	Sleight Kesidence 612 F Woodland Rd Take Forest II	Scale:	Aフン
のなかとなったのはいいでは		Date:	7.77
	D)
CHICAGO, IL	Frojec	Issued For:	
312.663.0222	2021-0001	Revised:	1
© Convious the ARCHITECTS Inc.			





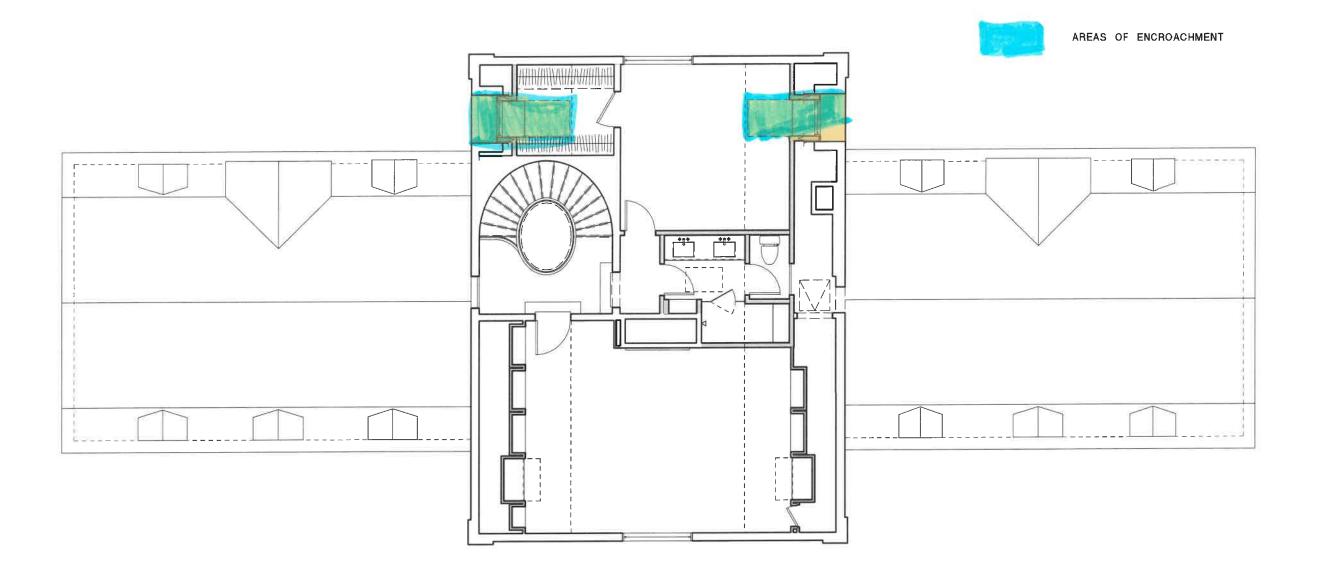




 $\begin{pmatrix} 1 \end{pmatrix}$

THIRD FLOOR PLAN

Scale: 1/8" = 1'-0"

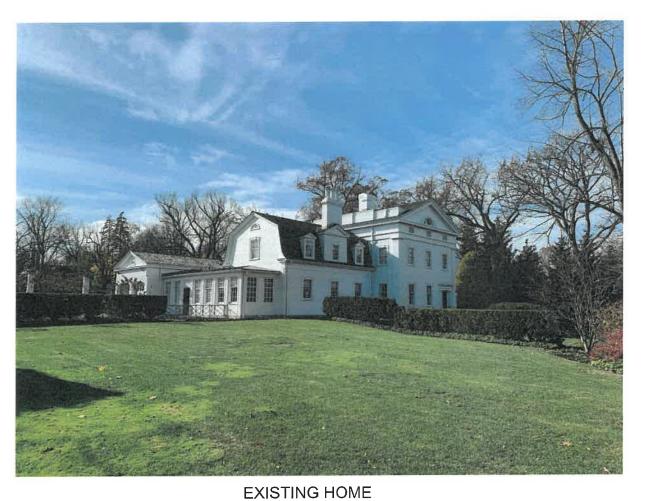


PROPOSED ADDITIONS & EXISTING HOME

VIEWS FROM NORTHEAST GARDEN




EXISTING PARAPET & PROPOSED 3RD FLOOR EGRESS DORMER

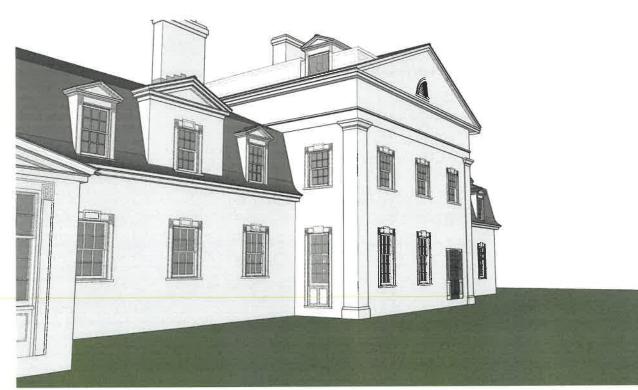

EXISTING FAN LIGHT DOES NOT PROVIDE SUFFICIENT NATURAL LIGHT & VENTILATION; DOES NOT QUALIFY AS AN EGRESS WINDOW



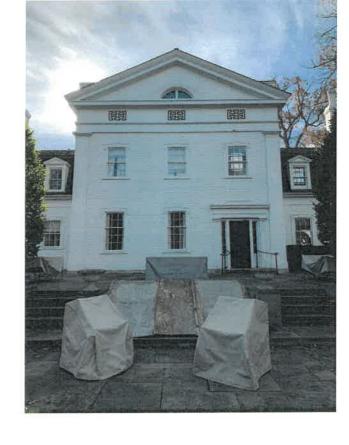


EXISTING HOME

PROPOSED DORMER IN THE DESK NICHE AREA






PROPOSED 3RD FLOOR EGRESS DORMERS; TALLER THAN EXISTING PARAPETS, LOWER THAN MAIN RIDGE

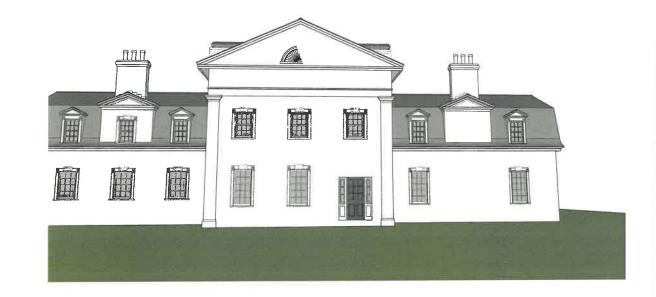

VIEWS FROM NORTH & NORTHWEST GARDENS

PROPOSED 3RD FLOOR DORMERS WILL PROVIDE NATURAL LIGHT & VENTILATION, AND EGRESS FOR THE 3RD FLOOR BEDROOM; DORMER IS PLACED TO MAINTAIN EXISTING MAIN ROOF EAVE AND FASCIA

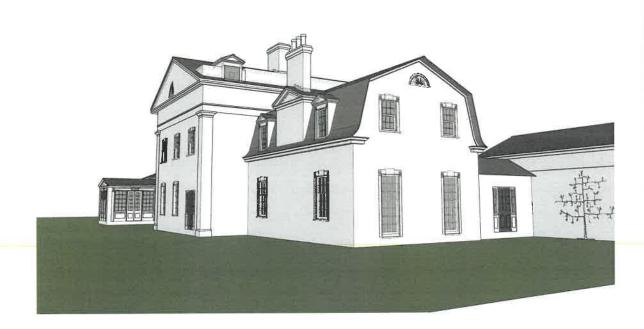

Project Name	Drawn By:	Sheet No.
Sleight Kesidence 612 F Woodland Rd Take Forest II	Scale:	
פוב בי ליססמומוות וימי, במונס ו פוסט, וב	Date:	T (<
	date:	
Froject Number	Issued For:	7./7
2021-0001	Dominod	
777	Weylsed:	

Dba ARCHITECTS

CHICAGO.1L
bbaworld.com
312.663.0222



BY ______REGISTERED ILLINOIS LAND SURVEYOR NO. 3591

†847.295.5200 F 847.295.7081 www.bleckeng.com