Agenda Item 3

650 Lake Road Side Yard Setback Variance

Staff Report Vicinity Map Air Photos

Materials Submitted by Petitioner
Application
Statement of Intent
Existing Site Plan
Proposed Site Plan
Existing and Proposed West Elevation
Existing and Proposed North Elevation
Existing and Proposed Garage Second Floor Plan
Proposed Roof Plan
Proposed Landscape Plan
Proposed Plant List
Neighborhood Air Photo
Garage Photographs



STAFF REPORT AND RECOMMENDATION

TO: Chairman Sieman and members of the Zoning Board of Appeals

DATE: October 25, 2021

FROM: Michelle E. Friedrich, Planning Technician

SUBJECT: Side Yard Setback Variance

OWNERS

PROPERTY LOCATION

ZONING DISTRICT

Stephanie Burke 401 E. Center Avenue Lake Bluff, IL 60044 West side of Lake Road, South of Spring Lane R4 – Single Family Residence

REPRESENTATIVE

Diana Melichar, architect

SUMMARY OF REQUEST

This request is for approval of a variance from the side yard setback requirement to allow expansion and alterations to the dormers on the existing garage. The existing living space above the garage has a low ceiling and is difficult to utilize.

The home at 650 Lake Road is located south of Spring Lane, on the west side of Lake Road. The overall project which includes additions and alterations to the main house, and a building scale variance, will be heard by the Historic Preservation Commission at an upcoming meeting.

FACTS

Compliance/Non-Compliance with Key Code Requirements

- The property meets the minimum lot width requirement.
- ❖ The property does not meet the minimum lot size requirement
- The existing house complies with the front, side and rear yard setbacks.
- ❖ The existing detached garage complies with the front and rear yard setbacks.
- The existing detached garage does not comply with the side yard setback.
- The proposed project complies fully with the lot coverage requirement.
- The proposed project does not comply with the Building Scale requirements and a Building Scale variance request, along with the design aspects of the project, will be reviewed by the Historic Preservation Commission.
- The expansion of the dormers on the rear elevation of the existing garage requires a side vard setback variance.

Physical, Natural or Practical Difficulties

* This house is a Contributing Structure in the East Lake Forest Historic District.

STAFF EVALUATION

This property is located within the R-4 zoning district. The property is developed with a single family home built in 1930 and a detached garage built in 1947 and was in compliance with the Code regulations that were in place at that time. The property is developed with a single family home and detached garage.

The existing garage has two dormers on the rear (west) elevation. The petitioner is requesting a variance to allow expansion of the dormers by connecting them to create a single, wider dormer. The proposed dormer expansion will be minimally visible from neighboring properties as it is tucked in between the existing dormers. Neighboring properties are heavily landscaped and the overall project on this site offers further landscaping throughout, but in particular, along the property lines.

A zoning variance for a similar proposal was granted in 1991 to a previous property owner however construction of the expanded dormers was never completed and the previously approved variance has expired.

FINDINGS OF FACT

Based on review of the information submitted by the petitioners, site visits and an analysis of this request based on applicable portions of the Zoning Code, staff submits the following findings.


- 1. The requested setback variance will not alter the essential character of the neighborhood since the proposed addition on the rear elevation, between the two existing dormers. The addition will be minimally visible from surrounding properties.
- 2. The conditions upon which the variance is requested are not applicable to other properties in the same zoning district due to the uniqueness of this historic property and the construction of the garage prior to current zoning regulations.
- 3. The hardship in conforming to the setback include the application of the R-4 zoning district and the related setback requirement after the garage was constructed.
- 4. The variance and the resulting additions will not impair light or ventilation to adjacent properties, increase congestion, endanger public safety, or substantially diminish property values in the area.

PUBLIC COMMENT

Standard public notice of this request was provided by the City to surrounding property owners. Notice was also provided in the <u>Lake Forester</u> and the agenda was posted at five public locations. As of the date of this writing, no correspondence has been received by staff.

RECOMMENDATION

Based on the findings presented in the staff report, recommend approval to the City Council of the side yard setback variance to allow expansion and connection of the dormers on the garage as depicted on the site plan included in the Board's packet.

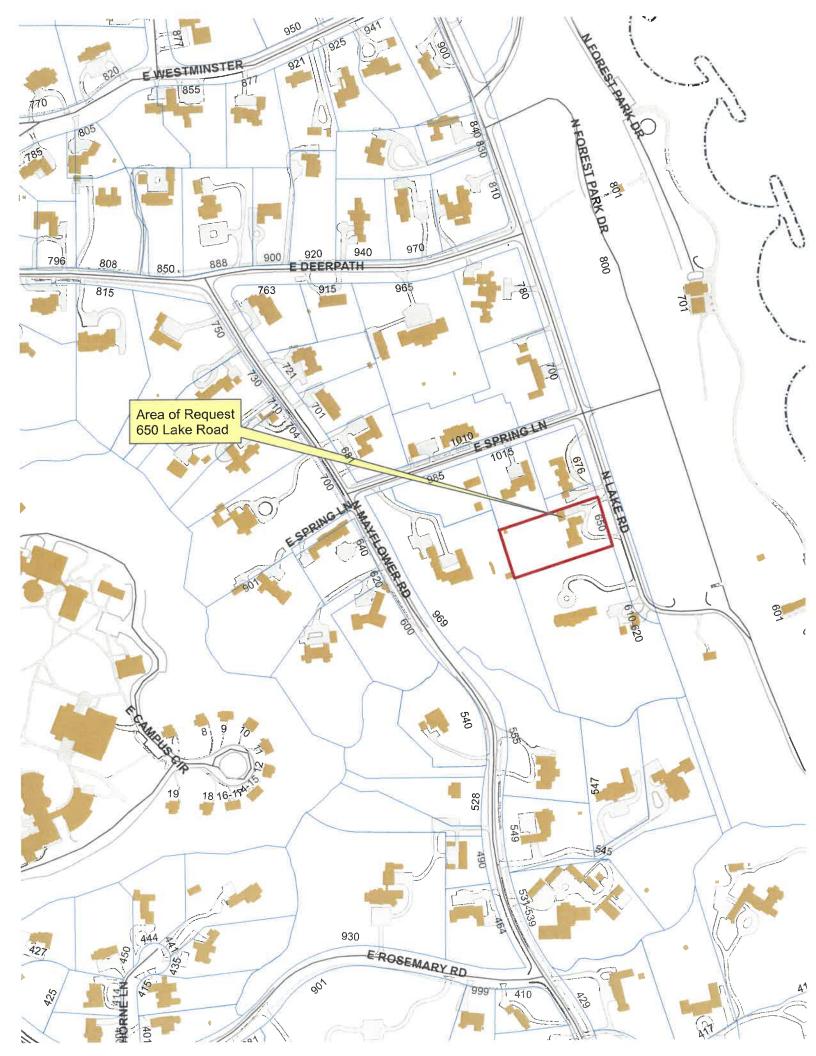







THE CITY OF LAKE FOREST ZONING BOARD OF APPEALS <u>APPLICATION OF ZONING VARIANCE</u>

| PROJECT ADDRESS | 650 R-4 | Lake Road | | | | |
|--|---------------|--|-----|--|--|--|
| | | | | | | |
| Property Owner (s) | Name | Stephanie Burke | | | | |
| (may be different from project address, | Address | A C C C A Amount I be BIN II a | 44 | | | |
| , <i>,</i> ,, | Phone | | • | | | |
| | Email | Stephanie Burke C ymail. com | | | | |
| | Lillan | 7, 7, 7, 7, 7, 7, 7, 7, 7, 7, 7, 7, 7, 7 | | | | |
| Applicant/Representative | Name | Melichar Architects (Diana Melichar) | | | | |
| , | Title | President | | | | |
| (if different from Property Owner) | | | Ł۲ | | | |
| , , , | Address | 207 E. Westminster, Lake Forest, 12 6004 (847) 295-2440 Fax (847) 295-2451 Diana @ Melicher Architects.com | 7.3 | | | |
| | Phone | (847) 295-24-40 Fax (847) 295-24-51 | | | | |
| | Email | Diana @ Melicher Architects.com | | | | |
| | | | | | | |
| Beneficial Interests N/A | | Staff Reports are Available the Friday before the Meeting | | | | |
| | See Exhibit A | Email Report: Owner Representative | | | | |
| | See Exhibit B | Fax Report: Owner Representative | • | | | |
| Trust, land or other | See Exhibit C | Pick Up Report: Owner Representative | | | | |
| Signatures I have read the complete application packet and understand the variance process and criteria. I understand that this matter will be scheduled for a public hearing when a determination has been made that my application is complete. | | | | | | |
| | | | | | | |
| | \leq | 9/8/21 Date | | | | |
| Owner | | Date | | | | |
| | | | | | | |
| Owner Date | | | | | | |
| 9 8 21 | | | | | | |
| Applicant/Representative Date | | | | | | |

LAKE FOREST ZONING BOARD OF APPEALS

Request for a dormer expansion over the side yard setback

Ms. Stephanie Burke Residence 650 Lake Road October 25, 2021

Submitted by Melichar Architects

Background

The intention of this project is to comprehensively rehabilitate and renovate/add onto an historic home for a new century of living. Currently the home and detached garage are permeated with toxic mold, and the house has been vacant for years. Ms. Burke's project program includes the removal of all existing deleterious materials, reconfiguration of the building interiors with all new mechanical, electrical, and plumbing systems, reinforcement of building structure where needed, installation of water remediation systems, brick and exterior restoration, and additions added to the home for a modern day lifestyle.

Currently the existing garage is detached, but just a little over four feet from the existing main structure. Ms. Burke intends on connecting the existing garage to the main home and completely renovating it in the same manner as the main home, so it will maintain the same quality and standards as the newly rehabilitated home.

The existing chauffer's bedroom over the existing garage has a small footprint, tightly sloping ceilings, and the majority of the ceiling height is below a habitable 7'-0". We would like to provide a new shed dormer that is located *between* the existing gable dormers, so we can provide more habitable space with a taller ceiling height. The shed dormer will also provide more light, ventilation, and views to the backyard, while minimizing changes to the existing roofline appearance.

Standards for Zoning Variance

- 1. The variance, if granted, will not alter the essential character of the subject property, the surrounding area or the larger neighborhood in which the property is located.
- The dormer addition is a minimal change to the rear of the existing home, and will not alter the character of the subject property, surrounding area, or neighborhood.
- 2. The conditions upon which a petition for a variance are based are unique to the property for which the variance is sought, and are not applicable, generally, to other property with the same zoning classification.


The existing garage was built in 1946. Almost half of the garage is currently over the side yard setback. The proposed dormer addition fits between the two existing dormers, one of which is over the side yard setback.

3. The alleged difficulty or hardship in conforming with the requirements of this chapter is caused by this chapter and has not been created by the actions of any persons presently or formerly having an interest in the property.

The existing garage was built in 1946. The current zoning setbacks were established after the garage was built, thereby making it a non-conforming structure within the R-4 Single Family Residential District.

4. The proposed variance will not impair an adequate supply of light and air to adjacent property or substantially increase the congestion of the public streets, or increase the danger of fire, or endanger the public safety, or substantially diminish or impair property values within the neighborhood.

The dormer addition is tucked into, and flanked by two existing dormers, so the north exterior elevation of the existing garage will appear the same to the adjacent property to the north. No additional height is being added to the existing dormer conditions. Homes on the adjacent properties to the north are set back far from Ms. Burke's garage, and their light and air will not be affected. Neither street congestion, fire, nor public safety will be affected. The garage will be completely rehabilitated and occupied by the homeowner, so the property value should increase.

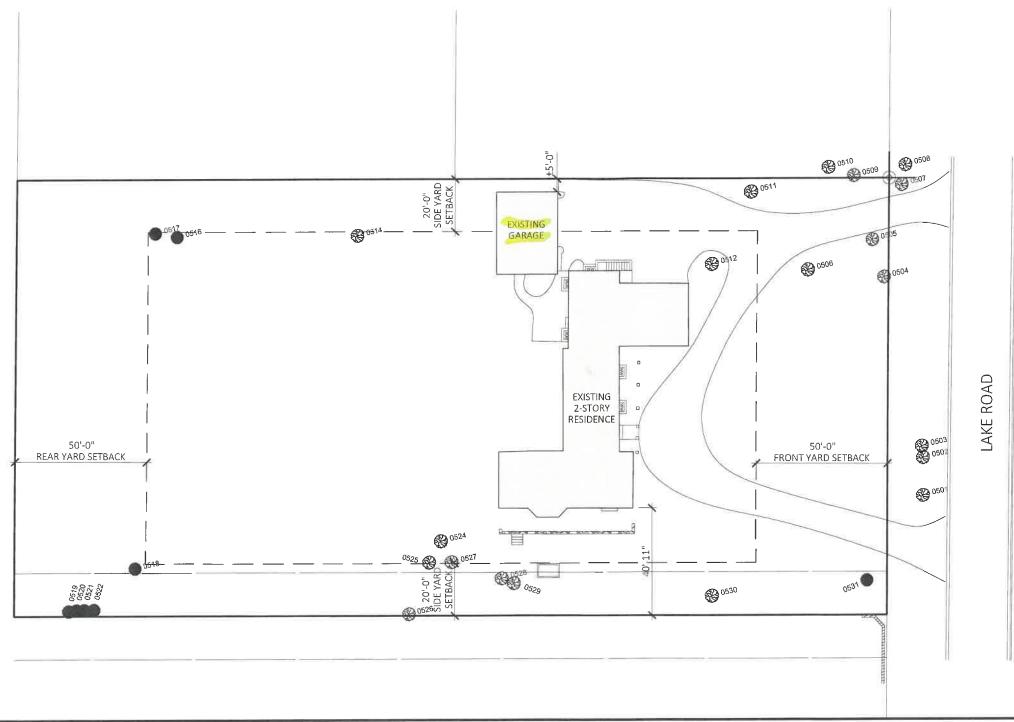

EXISTING SITE PLAN




STEPHANIE BURKE RESIDENCE 650 N. LAKE ROAD LAKE FOREST, IL 60045 SCALE: 1" = 30'-0"

JOB NO.: 1931

DWG. NO.:

ISSUE DATE: 09/17/2021

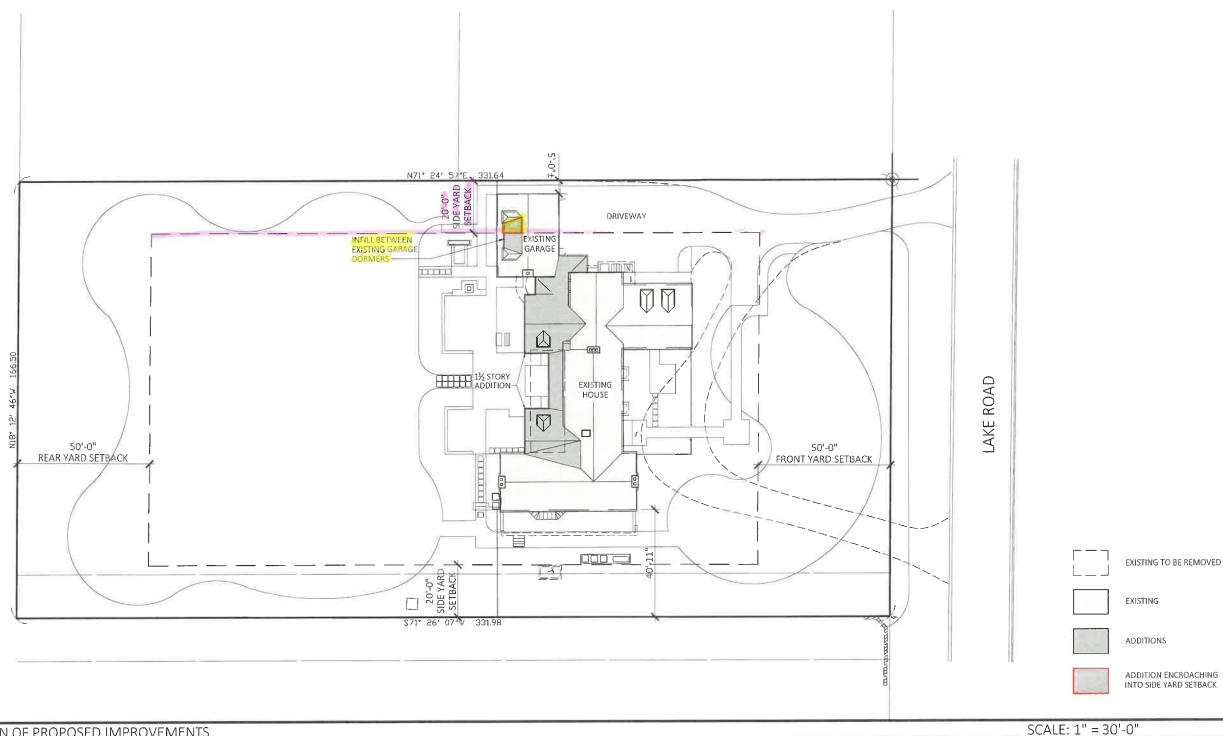

SITE PLAN OF PROPOSED IMPROVEMENTS




STEPHANIE BURKE RESIDENCE

650 N. LAKE ROAD LAKE FOREST, IL 60045 JOB NO.: 1931

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ISSUE DATE: 09/22/2021





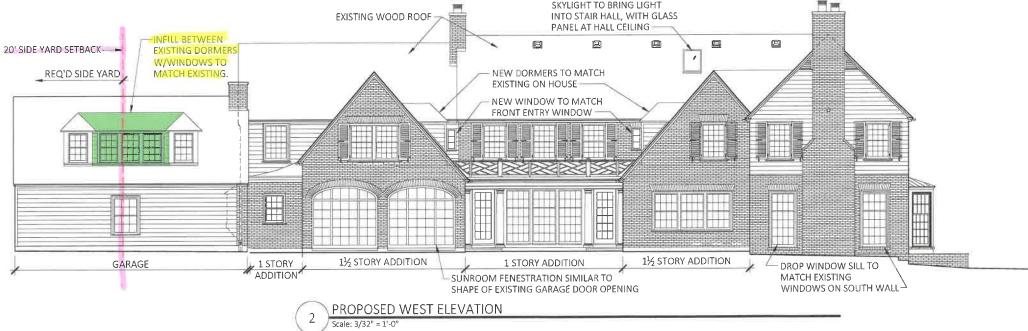

STEPHANIE BURKE RESIDENCE


650 N. LAKE ROAD LAKE FOREST, IL 60045 JOB NO.: 1931

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1 EXISTING NORTH ELEVATION







STEPHANIE BURKE RESIDENCE

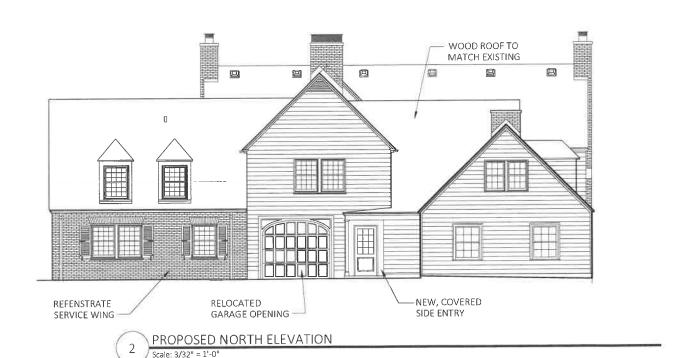650 N. LAKE ROAD LAKE FOREST, IL 60045 JOB NO.: 1931

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EXISTING DETACHED GARAGE SECOND FLOOR PLAN

PROPOSED ATTACHED GARAGE SUITE PLAN

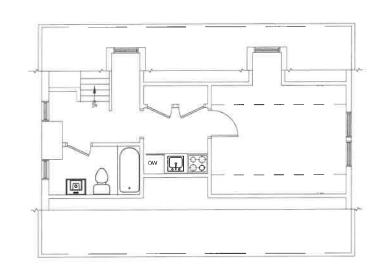
Scale: 1/8" = 1'-0"

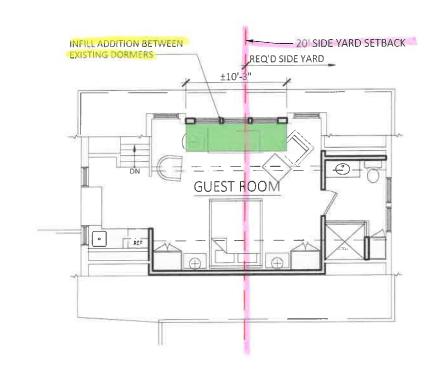

JOB NO.: 1931

DWG. NO.:

ISSUE DATE: 09/22/2021

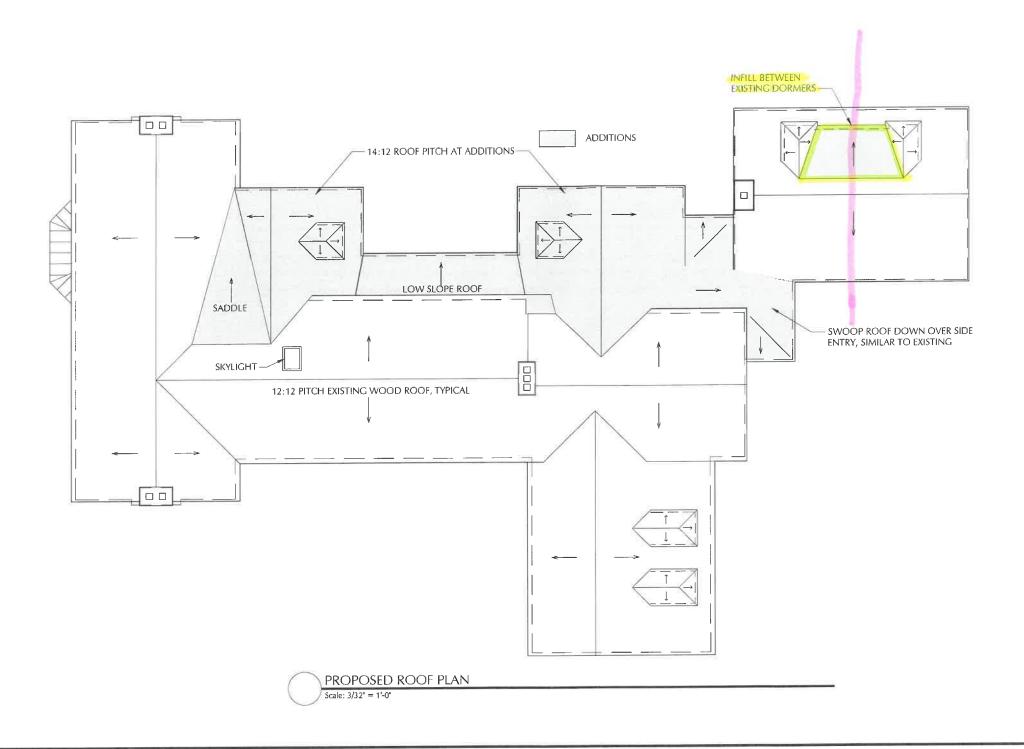



STEPHANIE BURKE RESIDENCE 650 N. LAKE ROAD LAKE FOREST, IL 60045


JOB NO.: 1931

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| BURKE RESIDENCE PLANT LIST | | | | | | | |
|----------------------------|-----|-----------------------------------|--------------------------------|------------------------|--|--|--|
| KEY | QTY | Botanical Name | Common Name | Size | | | |
| | | | | | | | |
| TRANSPL | | | | Ol aluman DRD | | | |
| MS | 4 | Malus species | Crabapple Tree | 8' clump B&B | | | |
| NS | 3 | Picea abies | Norway Spruce | 8' B&B 10' B&B | | | |
| QA | 1 | Quercus alba | Columnar White Oak | 10 8&8 | | | |
| TREES: | | | | | | | |
| AR | 1 | Acer rubrum 'October Glory' | October Glory Red Maple | 4" cal. B&B | | | |
| AG | 2 | Amelanchier grandiflora | Serviceberry | 10' clump | | | |
| ВР | 6 | Betula papyrifera | Paperbark Birch | 12' clump B&B | | | |
| CC | 1 | Cercis Canadensis | Redbud | 10' clump | | | |
| CV | 1 | Chionanthus virginiana | White Fringetree | 8' B&B | | | |
| CF | 1 | Cornus kousa | Flowering Dogwood | 10' clump B&B | | | |
| CM | 1 | Cornus mas | Cornellian Cherry | 8' clump B&B | | | |
| CH | 3 | Crataegus crusgalli var. inermis | Cockspur Hawthorn | 3" cal. B&B | | | |
| FG | 1 | Fagus sylvatica 'Riversii' | Rivers European Beech | 10' B&B | | | |
| GT | 2 | Gleditsia tricanthos var. inermis | Skyline Honeylocust | 3" B&B | | | |
| MJ | 1 | Malus Red Jewel | Red Jewel | 10' clump | | | |
| PA | 4 | Picea abies | Norway Spruce | 10' B&B | | | |
| PG | 2 | Picea pungens glauca | Blue Spruce | 10' B&B | | | |
| PS | 3 | Pinus strobus | White Pine | 10' B&B | | | |
| SR | 1 | Syringa reticulata | Ivory Silk Japanese Tree Lilac | 10' B&B | | | |
| EG | 13 | Thuja occidentalis Emerald Green | Emerald Green Arborvitae | 6' B&B | | | |
| то | 3 | Thuja occidentalis Techny | Techny Arborvitae | 7' B&B | | | |
| SHRUBS: | | | | | | | |
| AK | | Azalea Delaware Karens | Karens Azalea | 5 gal. cont. | | | |
| BT | | Berberis Crimson Pygmy | Crimson Barbery | 5 gal. cont. | | | |
| вм | | Buxus microphylla 'Green Velvet' | Green Velvet Boxwood | 5 gal. cont. | | | |
| CA | | Clethra alnifolia | Summersweet | 5 gal. cont. | | | |
| CH | | Cornus alba 'Ivory Halo' | Variegated Dogwood | 5 gal. cont. | | | |
| DG | | Deutzia gracilis | Deutzia | 5 gal. cont. | | | |
| DL | | Diervilla lonicera | Bush Honeysuckle | 5 gal. cont. | | | |
| F | | Forsythia varieties | Forsythia | 5 gal. cont. | | | |
| FG | | Fothergilla gardenii | Dwarf Fothergilla | 5 gal. cont. | | | |
| LV | | Ligustrum vulgare | Privet | 3' B&B | | | |
| HA | | Hydrangea arborescens 'Annabelle' | Annabelle Hydrangea | 5 gal. cont. | | | |
| HP | | Hydrangea paniculata varieties | PeeGee Hydrangea | 5 gal. cont. | | | |
| PS | | Physocarpus 'Summer Wine' | Summer Wine Ninebark | 5 gal. cont. | | | |
| GL | | Rhus aromatica | Gro Low Sumac | 3 gal. cont. | | | |
| RA | | Ribes alpinum | Alpine Currant | 5 gal. cont. | | | |
| SB | | Spiraea betuliflora 'Tor' | Tor Spirea | 5 gal. cont. | | | |
| SJ | | Spiraea japonica varieties | Froebel Spirea | 5 gal. cont. | | | |
| SN | | Spiraea nipponica | Snowmound spirea | 5 gal. cont. 3' B&B | | | |
| SV | | Spiraea vanhoutei 'Renaissance' | Renaissance Vanhoutte Spirea | | | | |
| SM | | Syringa meyeri | Dwarf Korean Lilac | 5 gal. cont. | | | |
| SV | | Syringa vulgaris varieties | Lilac Karaan Spica Viburnum | 5 gal. cont. | | | |
| VC | | Viburnum carlesi compacta | Korean Spice Viburnum | 30" B&B | | | |
| VC | | Viburnum juddi | Korean Spice Viburnum | 3' B&B 5' B&B | | | |
| VP | | Viburnum prunifolium | Blackhaw Viburnum | | | | |
| W | | Weigela varieties | Weigela | 5 gal. cont. | | | |



Satellite aerial of subject home and neighborhood SUBJECT PROPERTY OUTLINED IN RED

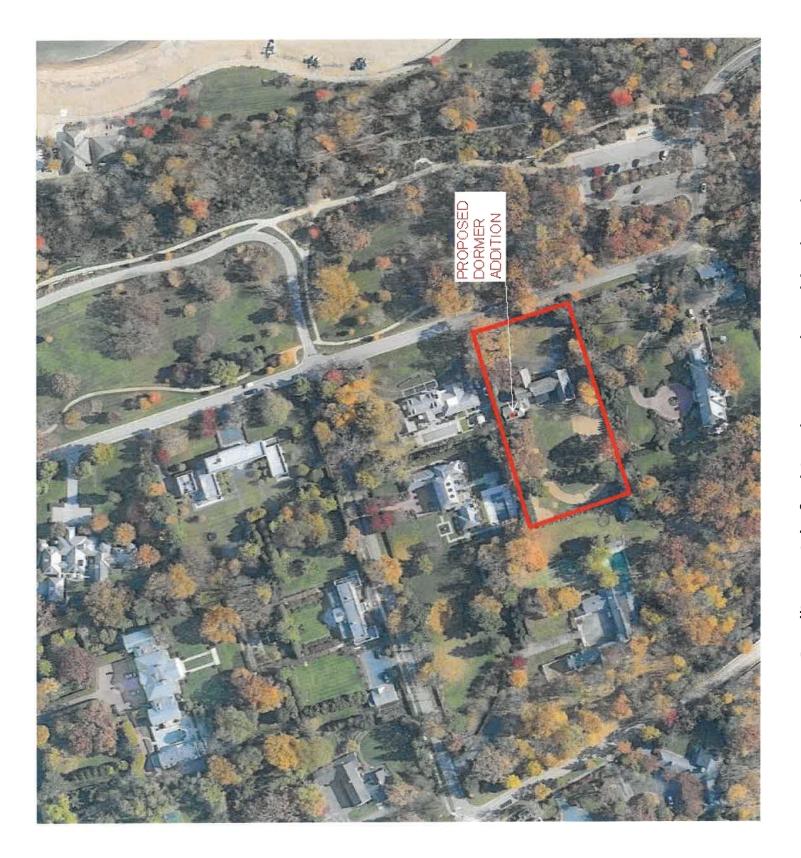

View of subject home detached garage from front (east)



View of subject home detached garage from rear (west)