Agenda Item 3 1525 Sage Court Revisions to Approved Plans

Staff Memorandum Vicinity Map

Materials Submitted by Petitioner
Application
Statement of Intent
Previously Approved Front Elevation
Color Elevation
Image of Front Door
Images of Light Fixtures



MEMORANDUM

To: Chairman Diamond and members of the Building Review Board

From: Jennifer Baehr, Planner

Date: November 3, 2021

Subject: 1525 Sage Court – Changes to Previously Approved Plans

Request: Approval of changes to limited aspects of previously approved plans.

The new home at 1525 Sage Court was presented to the Building Review Board at the April 7, 2021 meeting and was the first home in the Oak Knoll Woodlands subdivision to be recommended for approval. The City Council accepted the Board's recommendation and granted final approval of the petition on April 19, 2021 meeting. The Community Development Department issued the building permit for the home in September and construction is currently underway.

Background

The application and plans submitted by the developer for this property, for review and approval by the Building Review Board, specified black casement, aluminum clad wood windows with interior and exterior muntins. The Board's review and action was based on the plans as submitted and presented by the developer.

After approval of the plans by the Board and City Council, and during the review of the construction plans that were submitted for permit, staff noted that specifications for the windows did not appear on the plans as required. Staff requested that the specifications for the windows be added to the plans. In response, the developer provided specifications confirming that aluminum clad wood windows will be used consistent with the approved plans.

After the building permit was issued, based on the plans and specifications submitted for permit, the developer notified staff that the recent purchasers of the property plan to use vinyl clad wood windows instead of aluminum clad windows. The developer stated that the substitution of vinyl clad wood windows was based on a supply issue with the aluminum clad wood windows. Because vinyl clad wood windows are not consistent with the Board and City Council's approvals, this request for a change to the window type previously approved and presented is presented to the Board for consideration and action.

Applicable Regulations

The City's Residential Design Guidelines state the following: "The preferred material for residential windows is wood sashes and wood frames. As an alternative, vinyl coated wood and aluminum coated wood windows may be considered." Aluminum clad wood windows have commonly been approved by the Board for new construction projects. Vinyl clad wood windows

have been approved in some neighborhoods depending on the housing types and quality and overall character of surrounding homes. As the Board is aware, the Oak Knoll Woodlands subdivision is a new neighborhood without an established pattern yet of quality or character.

The Design Guidelines for the Oak Knoll Woodlands development were established by the original developer as part of the subdivision process however they were never presented to the Board for review and approval. The guidelines state: "Windows and doors shall have wood, aluminum, or vinyl clad exteriors with wood interiors. Glazing shall be clear or gray tinted only. Low-E insulated glass is strongly encouraged. Reflective glass or glass block will not be accepted. Fiberglass or metal entry door systems are permitted. Screen material shall be of dark gray fiberglass, aluminum, copper or bronze."

Although the City cannot specify a manufacturer or vendor for a product, the City can establish parameters or requirements for the product type. At staff's request, the developer provided samples of the proposed vinyl clad wood windows from Andersen Windows and provided a sample of the previously approved aluminum clad wood window from Pella Windows as well. Samples of the vinyl clad wood window were provided for both a double-hung and a casement window. A sample of the aluminum clad wood window product was provided for a casement window. The samples are available for viewing at the City's Municipal Services building, 800 Field Drive, on the lower level patio, on the west side of the building. Board members are encouraged to visit the Municipal Services building and inspect the samples.

Staff Review

Based on a review of the sample windows provided by the developer, staff offers the following observations. Note: Based on the information available to staff, and on the approved plans, only casement windows are proposed on the home.

- > There are some visual differences between the vinyl clad wood window and aluminum clad wood window.
- > The vinyl clad wood windows appear to have a sheen to the exterior finish that calls attention to the fact that the exterior is vinyl.
- > The aluminum clad wood window has a matte exterior finish which is more subtle, making it less apparent that the exterior is a non-natural material and gives the appearance of higher quality.
- > Both the vinyl clad wood window and aluminum clad wood window have miter joints that are visible at the corners.
- The double-hung vinyl clad wood window has a vinyl seal at the top corners that stands
- > The miter joints on the casement vinyl clad wood window are less prominent, although it appears that the adhesive used at the joints protrudes from the corners and is visible on the exterior frame.
- > The aluminum clad wood window has very thin miter joints that are smoother and cleaner in appearance than the vinyl clad wood window although some adhesive is also visible at the corners of the aluminum clad wood window.
- > The double hung vinyl clad window presents the sashes recessed from the frame, providing depth to the appearance of the window and shadowing.
- > The casement style windows for both the vinyl clad wood window and the aluminum clad wood window product do not offer as much of a reveal between the window frame and the window sash as the double hung windows.
- > The vinyl clad wood window sample shows the frame and sash almost flush with one another, while the aluminum clad wood window sample shows the sash slightly recessed from the frame.

> The exterior frame of the vinyl clad wood casement window presents a flat profile while the aluminum clad wood window has a beveled profile on the frame that adds a level of detail to the exterior of the window.

Other Minor Changes

Minor changes are also proposed to the design of the front door and the style of the exterior light fixtures. These minor changes could ordinarily be review and approved by staff in consultation with the Chairman however, given the change proposed to the windows staff felt it appropriate to present all of the proposed changes to the Board for consideration.

The plans previously presented and approved by the Board in April reflect a front door with a solid lower half and a window in the top half. The front door as now proposed is all glass with an iron frame and muntins. The front door as now proposed presents a more modern appearance than the previously approved door. The new light fixtures are similar in appearance to those shown on the previously approved plans but reflect a modern style in comparison to the traditional coach light fixture originally presented and approved.

The previously approved front elevation showing the front door and light fixtures are included in the Board's packet along with the proposed front door design and new light fixtures.


Staff Recommendation – Window Changes

Approve the change to vinyl clad wood windows subject to the following conditions.

- 1. A matte exterior finish shall be used.
- 2. The window shall have a detailed profile to avoid a flat appearance.
- 3. The miter joints shall be clean, without adhesive protruding from the joint.

Staff Recommendation – Front Door and Light Fixture Changes

Approve changes to the design of the front door and the style of the exterior light fixtures.

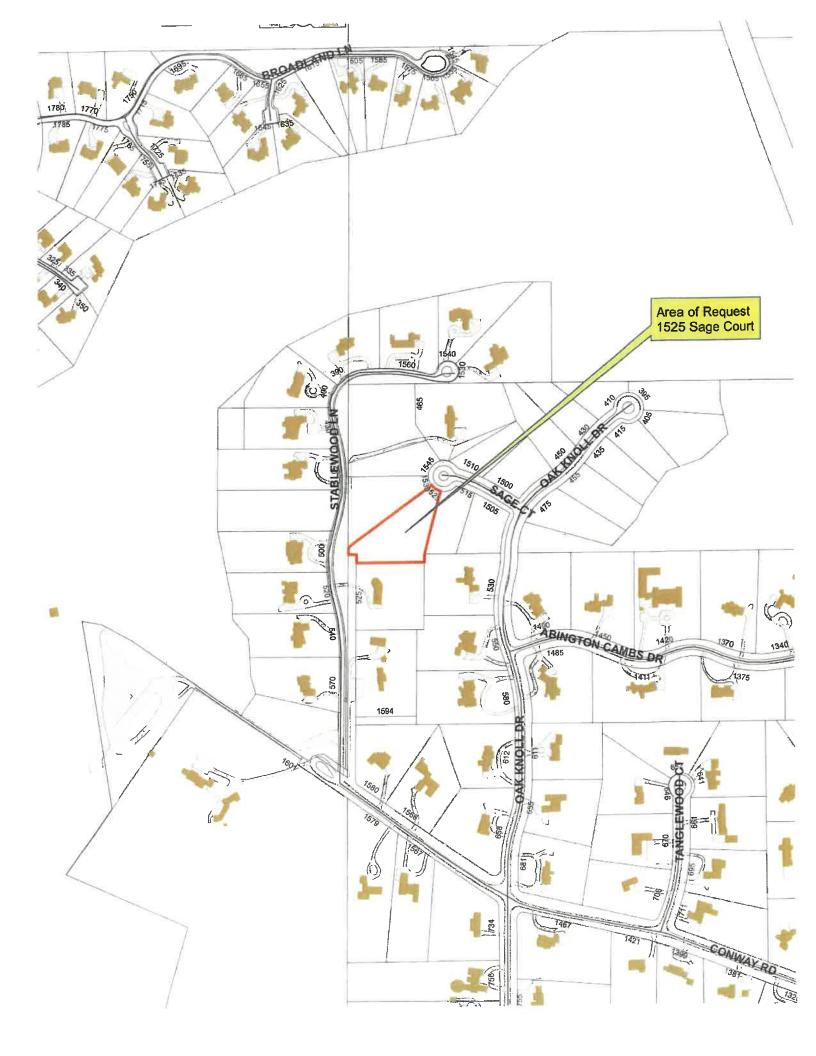



THE CITY OF LAKE FOREST BUILDING REVIEW BOARD APPLICATION

PROJECT ADDRESS 1525 SAGE CT. (OAK-KNILL WOODLANDS - LOT 14) **Changes to Previously Approved Plans** APPLICATION TYPE COMMERCIAL PROJECTS RESIDENTIAL PROJECTS New Residence **New Building** Landscape/Parking **Demolition Complete** Lighting **New Accessory Building Demolition Partial** Addition/Alteration Height Variance Addition/Alteration Height Variance Signage or Awnings **Building Scale Variance** Other Other PROPERTY OWNER INFORMATION ARCHITECT/BUILDER INFORMATION Quarer of Property 28 POETSHIPE De.

Oumer's Street Address (may be different from project address) City, State and Zip Code 201 Pateets
Street Address 913.221.60 + 8 Phone Number City, State and Zip Code 817. 986. 9666 Phone Number Fax Number Samantha A Bakas Thomas & Bakas Representative's Signature (Architect/ Builds)

The staff report is available the Friday before the meeting, after 3:00pm.				
Please email a copy of the staff report	□ OWNER	☐ REPRESENTATIVE		
Please fax a copy of the staff report	□ OWNER	☐ REPRESENTATIVE		
I will pick up a copy of the staff report at the Community Development Department	□ OWNER	□ REPRESENTATIVE		

From: <u>Carla Saldana</u>
To: <u>Baehr, Jennifer</u>

Cc: mike@fidelitywes.com; bakas.samantha@gmail.com; tibakas@gmail.com

Subject: Bakas Residence - BRB Submission for Changes to Previously Approved Plans

Date: Tuesday, October 26, 2021 10:50:08 PM
Attachments: Bakas Change Application (Bakas signed).pdf

Exterior Lighting .pdf

Bakas Residence - Color Rendering.pdf

Jen and City Staff -

On behalf of Tom and Samantha Bakas, homeowners at 1525 Sage Ct., we would like to propose the following changes to the Building Review Board for the November 3rd Meeting Agenda. The new construction home was previously approved by the BRB and is now under construction. Please find the attached information and external links below to support the changes and provide additional information regarding substitute materials. We have also included a copy of the currently approved Color Rendering of the home for the Board members reference.

Proposed Changes are as follows:

Window Material Change

- Requesting approval from the Board to change from Aluminum Clad Casement Windows to Vinyl Clad Casement Windows. Both windows have wood interiors.
 - Anderson 400 Series provides the same aesthetic consistent with previous approval, including Black Finish and Simulated Divided Lites with Muntin Pattern per plan as shown previously.
 - Samples of both the original Pella Aluminum Clad and the Anderson Vinyl Clad have been provided for the Board to review.

Front Door Style Change

- Requesting approval from the Board to change from a wood-stained Front Door to a custom Black Iron Door
- Shape, size and dimensions (including radius) of the front door will remain the same. The new selection will provide a more streamlined aesthetic consistent with the Black Finish selected for the Window Exterior as well as the more modern take on the traditional Tudor Style.
- The <u>AIR 5 selection</u> is fabricated with above industry standard 12 gauge material. Doors are 2" thick with steel threshold. This style is outfitted with 5/8" tempered dual pane glass and polyurethane dual foam weather stripping inside each frame, helping reduce hot and cold weather transfer.

Exterior Light Fixture Change


- Requesting approval from the Board to change the Exterior Light Fixtures to a more consistent selection to partner with the front door change
- Please see attached Exterior Fixtures Proposed
 - Front Door Fixture: Coppersmith Conception Street with Classic Moustache faux gas flame bulb and pebble frost glass in black finish
 - Rear Slider, Service Door and Garage Door Fixtures: Z-Lite Memphis Collection matte shade, seeded glass in black finish

Appreciate your time and consideration.

Carla

Carla Saldana

c. 312-656-5221
Fidelity Wes Builders Inc.
201 Robert Parker Coffin Rd.
Long Grove, Il 60047
VISIT OUR WEBSITE

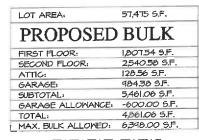



1 FRONT ELEVATION
AR 02

SCALE: I/4"=I'-0"

NOTE, ALL SCALE D
ARE FOR SHEETS PI

NOTE, ALL SCALE DESIGNATIONS ARE FOR SHEETS PRINTED ON 24" x 36" SIZE PAPER. (ARCH-D) PROJECT # AD20208
DRAWN BY: COM/MB
LOT 14
EXTERIOR ELEVATIONS

AR 02
2 OF 9 TOTAL SHEETS

T DESIGNINC.

1525 SAGB COURT OAK KNOLL WOODLANDS SUBDIV. LAKE FOREST, IL 60045

FIDELITY WES

9

LOT 14 BAKAS RESIDENCE

-NOT FOR CONSTRU



FIDELITY WES


PROJECT # AD20208
DRAWN BY: COM/M8 PROJECT# LOT 14 EXTERIOR ELEVATIONS AR 02

2 OF 9 TOTAL SHEETS





CS 42[CMS]

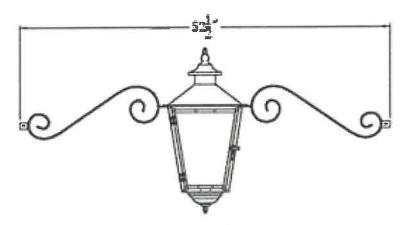

Conception Street 42 Classic Moustache

BACK SLIDER AND GARAGE

532M-BK



Category	Outdoor Wall Sconce
Collection	Memphis Outdoor
Frame Finish	Black
Shade Finish	Clear Seedy Outside; Matte Opal Inside
Bulbs	1 x 100W - Medium
Length/Extension	10.63"
Width	9.0"
Height	16.63"
Dimmable	Yes
LED Source Lumen	
LED Delivered Lumen	
LED Color Temperature	
LED Color Rendering Index (CRI)	
Vanity/Sconce Dual Mount	

GARAGE SERVICE DOOR

532S-BK + Wish List



Category	Outdoor Wall Sconce
Collection	Memphis Outdoor
Frame Finish	Black
Shade Finish	Clear Seedy Outside; Matte Opal Inside
Bulbs	1 x 100W - Medium
Length/Extension	8.88"
Width	7.75"
Height	13.25"
Dimmable	Yes
LED Source Lumen	
LED Delivered Lumen	
LED Color Temperature	
LED Color Rendering Index (CRI)	
Vanity/Sconce Dual Mount	

Agenda Item 3 410 Oak Knoll Drive New Residence

Staff Report Building Scale Summary Vicinity Map Air Photos

Materials Submitted by Petitioner

Application

Statements of Intent

Description of Exterior Materials

Staking Diagram

Proposed Site Plan

South (Front) Elevation

West Elevation

North (Rear) Elevation

East Elevation

Color Rendering

Roof Plan

Building Section

First Floor Plan

Second Floor Plan

Preliminary Site Grading Plan and Tree Removal Plan

Tree Inventory

Preliminary Landscape Plan

Images of Hardscape Materials

Supplemental Materials

Vicinity Map

Overall Subdivision Plan with Individual Site Plans

Previous Board Approvals

410 Oak Knoll Drive

Consideration of a request for approval of a new residence, an attached garage, a conceptual landscape plan and the overall site plan.

Property Owner/Developer: Fidelity Wes of Oak Knoll LLC (Mike DeMar, 100%)

Contract Purchasers: Andy and Maggie Timson Project Representative: Rick Swanson, architect

Staff Contact: Jen Baehr, Planner

Summary of Request

This is a request for approval of a new single family residence and attached garage on a vacant lot. Board consideration of the overall site plan and landscape plan is also requested.

Description of Property

The property is located on the west side of the cul-de-sac at the north end of Oak Knoll Drive and is Lot 7 in the Oak Knoll Woodlands subdivision. The property totals 23,806 square feet and is generally triangular in shape. The property is bordered by the Conway Farms Golf Course to the north.

To date, the Board has approved petitions for new residences on a total of nine lots in the subdivision. The petition currently presented to the Board was submitted by the developer on behalf of the contract purchasers. A statement of intent from the contract purchasers is included in the Board's packet.

Note: The contract purchasers are advised that critical infrastructure for the subdivision has not yet been completed by the developer. However, the City is willing to grant an exception to standard procedures and work with contract purchasers to advance review of the proposed residence and issue permits to allow construction of the home to begin subject to the homeowner and the developer signing an Acknowledgment that no Certificates of Occupancy can be issued until the critical infrastructure is completed, inspected and determined to be acceptable by the City.

Review and Evaluation of Applicable Standards from the City Code

Below is a review of the standards outlined in the City Code for the Board's consideration.

Site Plan - This standard is met.

The proposed residence is sited at an angle on the property to face the street and the attached side-load garage faces the northeast corner of the site. A single curb cut is proposed off of the cul-de-sac at the north side of the site. A paver walkway is proposed from the front entrance to the driveway and paver stoops are proposed on the front and rear of the residence.

The site plan and information submitted by the petitioner shows that the amount of impervious surface on the site will be 20%. The building footprint is 2,650 square feet and hardscape and driveway surfaces total 2,002 square feet.

Building Massing and Height – This standard is met.

Based on the lot size, a residence of up to 4,190 square feet is permitted on the site. In addition, a garage of up to 600 square feet is permitted along with up to 419 square feet of design elements.

Design elements are defined as those elements that provide human scale to a residence and help to mitigate the appearance of mass and include elements such as single dormers and porches.

- The proposed residence totals 3,936 square feet.
- The proposed garage totals 726 square feet. The garage overage of 126 square feet must be added to the total square footage of the residence.
- In addition to the above square footage, a total of 60 square feet of design elements are incorporated into the design of the house.
- In total, the residence is 4,062 square feet, and is 3 percent below the maximum allowable square footage.

At the maximum height, the residence is 35 feet and 1 inch tall as measured from the lowest point of existing adjacent grade to the tallest roof peak. The maximum height allowed for this lot is 40 feet.

Elevations – This standard is met.

According to the petitioner's statement of intent, the proposed residence is designed as an English Cottage style home. The residence presents a primary two-and-a-half-story mass with a one and half-story garage mass on the north side. The home presents features common to the English Cottage style, such as asymmetrical facades, steep gable and clipped gable roof forms, and tall, narrow windows.

Type, color, and texture of materials — This standard is generally met.

The exterior walls of the home are a combination of painted brick and stucco. The roof material is wood shingle. The roof saddles between the gable roof forms on the rear elevation will be copper. Wood will be used for the trim, fascia, soffits and decorative brackets. The window sills are cut limestone and the headers above the windows will be wood. Aluminum clad wood windows with exterior and interior muntin bars are proposed. A copper roof vent is proposed on the front elevation. Aluminum gutters and downspouts are proposed. The chimney will be brick with a clay chimney pot.

The proposed color palette includes white brick and white, stucco, trim, windows, gutters and downspouts. The front door will be blue. The roof will be natural cedar shingle. The petitioner provided a color rendering to reflect the proposed color palette which is included in the Board's packet. As previously noted by the Board, homes in the subdivision presented to date are predominately white, or an off white, creating the potential for monotony within the subdivision. The Design Guidelines for the Oak Knoll Woodlands development that were established by the original developer as part of the subdivision process includes language regarding the building materials and color. Unlike other subdivisions, the developers Design Guidelines were never presented to the Building Review Board for review and approval and, as a result, each house in the subdivision requires Board review individual. The developer's Design Guidelines state the following:

'The predominant colors for new homes should consist of primarily earth tones. While the natural brick and stone colors should predominate, contrasting and complementary colors should also be used to accent building components, highlight architectural elements and to help distinguish homes from one another. White and other light brick colors are not permitted unless they are to be painted appropriately with the historic architectural style of the home."

The Board has encouraged diversity in color palettes to allow homes to distinguish themselves from each other within the subdivision and to add visual interest and character to the subdivision. The Board has noted in the past that homes surrounding the development, particularly to the south on Oak Knoll Drive, are generally earth tones but incorporate a range of colors, materials and styles.

The proposed color scheme for the home proposed in this petition consists of white exterior walls. A white exterior is common for the English Cottage style however, historically, the Cottage style features elements such as window frames, trim and rake boards, brackets, and flower boxes in earth tones that highlight these elements and offset the light color of the exterior walls.

> Board input on the proposed color palette is requested.

During the preparation of this staff report, the developer notified staff that they plan to change the stucco color on a neighboring home, previously approved by the Board on the property addressed as 395 Oak Knoll Drive, from an off-white color to a light gray color, in an effort to create some variation in color across the subdivision.

Landscaping - This standard is met.

This particular property is fairly open within the buildable area of the site with many of the existing trees along the property lines. As currently proposed, a total of 12 trees are proposed to be removed. The trees proposed for removal consist of Ash, Shagbark Hickory, Black Walnut, Black Cherry and Oak trees. Most of the trees proposed for removal are either dead or in poor condition. Based on the information currently available 22 replacement tree inches must be incorporated into the landscape plan for the site.

The landscape plan submitted by the petitioner reflects shrub and ornamental plantings around the foundation of the home. The landscape plan reflects new shade trees in the front yard to soften the appearance of the new residence from the street and a row of arborvitae along the garage apron to screen views of the garage doors from the adjacent Conway Farms Golf Course. As currently proposed, the landscape plan meets the minimum landscaping requirements for new residential construction and the required replacement plantings for the healthy trees that are proposed for removal.

Public Comment

Public notice of this petition was provided in accordance with the City requirements and practices. Notice was mailed by the Community Development Department to surrounding property owners and the agenda for this meeting was posted at various public locations. As of the date of this writing, no correspondence was received regarding this request.

Recommendation

Recommend approval of the residence, attached garage, conceptual landscape and overall site plan based on the findings presented in this staff report and as they may be further detailed during the Board's deliberations. Staff recommends approval subject to the following conditions of approval.


Conditions of Approval

- 1. If so directed by the Board, further study of the color scheme shall be conducted in an effort to add visual interest and character to the subdivision.
- 2. All modifications to the plans including the refinements noted above and any others made in response to Board direction or as the result of final design development, shall be clearly called out on the plan and a copy of the plan originally provided to the Board shall be attached for comparison purposes. Staff is directed to review any changes, in consultation with the Chairman as appropriate to determine whether the modifications are in conformance with the Board's direction and approval prior to the issuance of any permits.
- 3. The final landscape shall include, but not be limited to, 22 replacement tree inches to account for trees removed on the site. In addition, the minimum landscape standards for new residences as detailed in the Code, including ground cover, mid level and canopy trees and evergreens across the site. Substantial year round plantings shall be included along the north property line to fully screen views of the garage and driveway from the adjacent golf course.
- 4. If determined to be necessary by the City's Certified Arborist, any declining or damaged parkway trees shall be removed and replaced by the developer prior to the issuance of a Certificate of Occupancy for this property.
- 5. The final grading and drainage plan shall demonstrate the project is consistent with the applicable Code requirements and will be subject to review and approval by the City Engineer. Grading or filling on the site should be kept to the absolute minimum necessary to meet good engineering practices, properly direct drainage and mitigate off site impacts.
- 6. Tree Protection Plan Prior to the issuance of a building permit, a plan to protect trees identified for preservation and to protect trees on neighboring properties during construction, must be submitted and will be subject to review and approval by the City's Certified Arborist.
- 7. Details of exterior lighting shall be submitted with the plans submitted for permit. Cut sheets for all light fixtures shall be provided and all fixtures, except those illuminated by natural gas at low light levels, shall direct light down and the source of the light shall be fully shielded from view. All exterior lights shall be set on automatic timers to go off no later than 11 p.m. except for security motion detector lights.
- 8. A plan for construction parking and materials' staging shall be submitted for review and will be subject to approval by the City's Certified Arborist, City Engineer and Director of Community Development.
- 9. If the petitioner desires the issuance of a building permit prior to the completion and approval of critical infrastructure in the development, an Acknowledgment prepared by the City will need to be signed, notarized and filed with the City.


THE CITY OF LAKE FOREST BUILDING REVIEW BOARD -- BUILDING SCALE INFORMATION SHEET

Address	41	0 Oak Knoll	Drive		Owner(s)		Fideli	ty Wes of	Oak Knoll	LLC	
Representative	Rick	Swanson, a	rchitect		Reviewed by	:	Jen E	Baehr			
Date	11/3/2										
Lot Area	23806	_sq. ft.									
Square Footag	e of New R	lesidence:									
1st floor	1817	_ + 2nd floo	r1712	+ 3rd floor	407		=	3936	sq. f	:.	
Design Eleme	nt Allowanc	e =	419								
Total Actual D	esign Elem	ents =	60			Excess	= ,	0	sq.ft		
Garage	726	_sf actual;	600			Excess	=	126	sq. f	.	
Garage Width	2	2'-0"	may not excee								
Basement Are	ea		lots 18,900 sf (or less in size.	•		=	0	sq. f	i.	
Accessory bui	ldings						=	0	sq. f	i.	
TOTAL SQUAF	RE FOOTAG	GE					=	4062	sq. f	i.	
TOTAL SQUAF	RE FOOTAG	GE ALLOWEI	o				=	4190	sq. f	i.	
DIFFERENTIAL	L						=	-128	sq. f	i.	
Allows	able Height:	40	ft. Actu	al Height	35'-1"	ft.	Un	der Maxi	mum		
Allowa	able Height.		_1 //010	arrioign						NET R	ESULT:
										128	sq. ft. is
										3% u Max. a	inder the llowed
DESIGN ELEM	ENT EXEM	PTIONS									
Des	sign Eleme	nt Allowance	:419	sq. ft.							
Rear	& Side Scr Cov Po Individ	een Porches : een Porches : Portico : orte-Cochere : Breezeway : Pergolas : ual Dormers : ay Windows :	0 = 48 = 0 = 0 = 0 = 0 = 12	sq. ft.							

Total Actual Design Elements = 60 sq. ft. Excess Design Elements = 0 sq. ft.

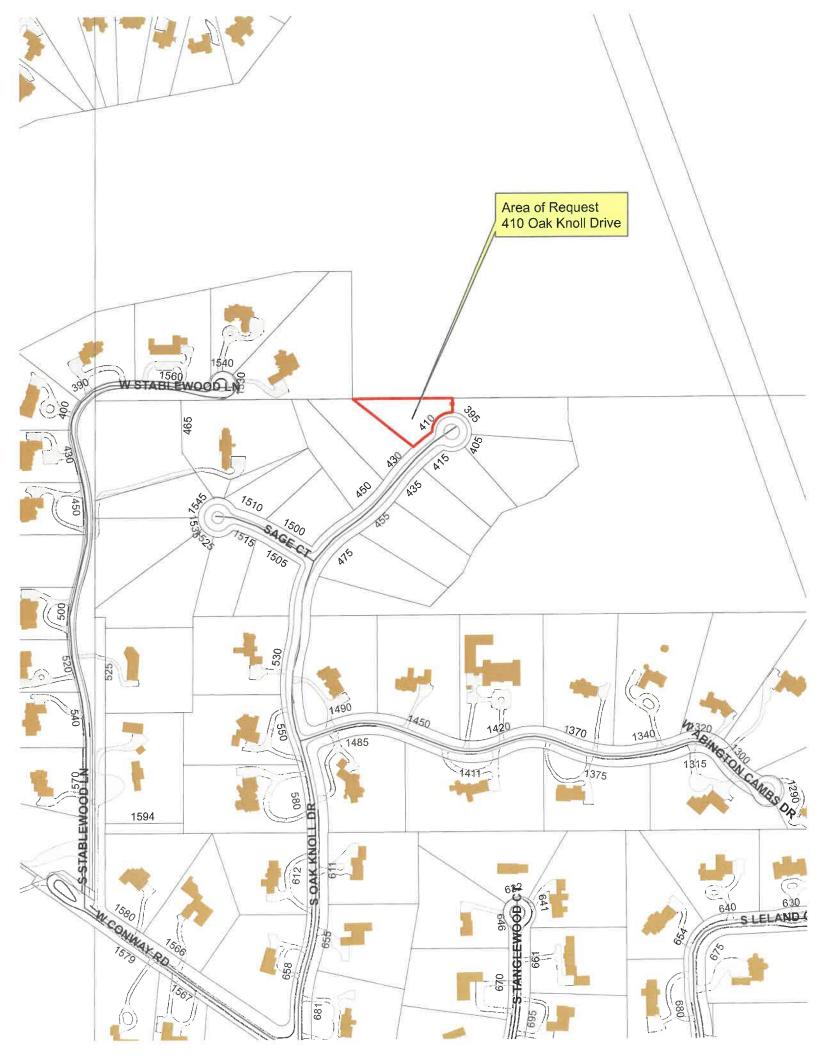



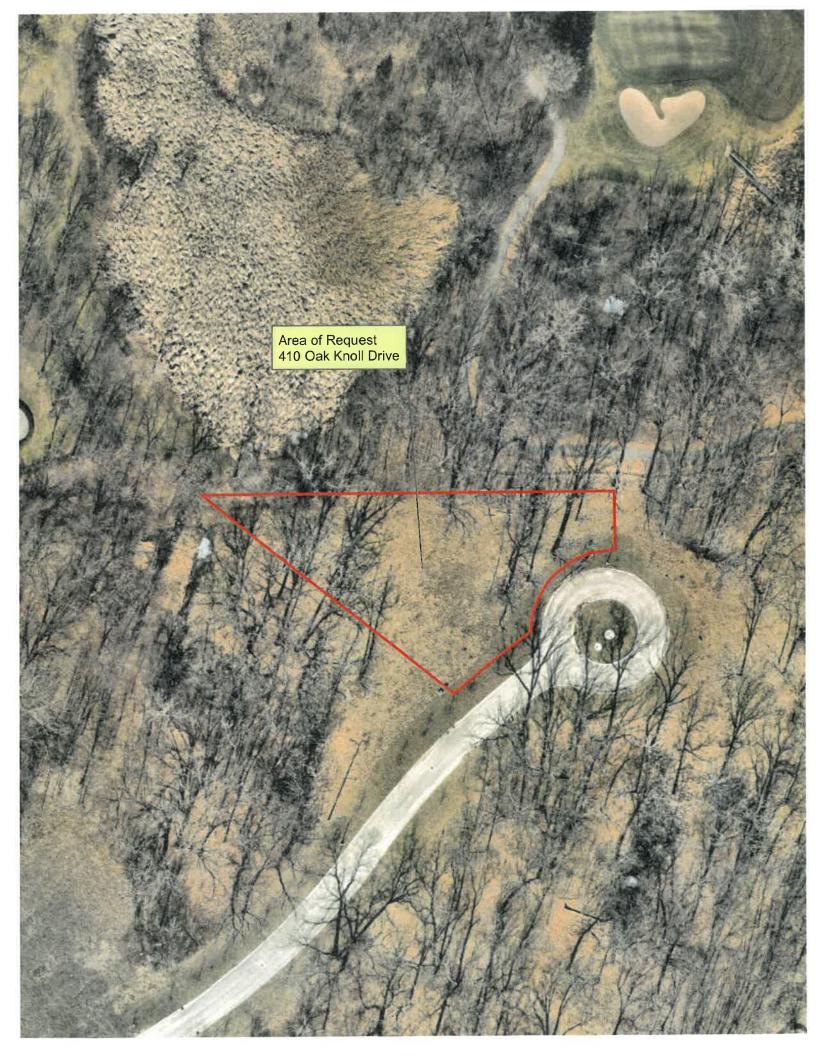



THE CITY OF LAKE FOREST BUILDING REVIEW BOARD APPLICATION

PROJECT ADDRESS 410 Oak Knoll Drive / Oak Knoll Woodlands Subdivision						
APPLICATION TYPE						
RESIDENTIAL PROJECTS	COMMERCIAL PROJECTS					
X New Residence □ Demolition Comple □ New Accessory Building □ Demolition Partial □ Addition/Alteration □ Height Variance □ Building Scale Variance □ Other	te					
PROPERTY OWNER INFORMATION	ARCHITECT/Builder Information					
Fidelity Wes of Oak Knoll LLC	Rick Swanson Architect					
Owner of Property	Name and Title of Person Presenting Project					
201 Robert Parker Coffin Road	R.M. Swanson Architects PC					
Owner's Street Address (may be different from project address)	Name of Firm					
Long Grove, Illinois 60047 City, State and Zip Code	11418 E Mission Ln Street Address					
Cuy, State and Zip Code	Street Authen					
(847) 980-9686	Scottsdale, AZ 85259					
Phone Number Fax Number	City, State and Zip Code					
mike@fidelitywes.com	(847) 757-3975					
Email Address	Phone Number Fax Number					
	rigk@rmswanson.com					
Meda	Email Address					
Own Signatur	Representative's Signature (Architect/Builder)					
The staff report is available the Friday before the meeting, after 3:00pm.						
Please email a copy of the staff report	OWNER REPRESENTATIVE					
Please fax a copy of the staff report	OWNER REPRESENTATIVE					
I will pick up a copy of the staff report at the Community Development Department	OWNER REPRESENTATIVE					



CORPORATE OWNERSHIP (EXHIBIT A)

Please list the names and addresses of all officers and directors of the Corporation and all shareholders who own individually or beneficially 5% or more of the outstanding stock of the corporation. In addition, this application must be accompanied by a resolution of the Corporation authorizing the execution and submittal of this application.

Name Mike Demar President	Name
Address 201 Robert Parker Coffin Rd Ownership Percentage 100 %	Address Ownership Percentage %
- Too is	
Name	Name
Address	Address
Ownership Percentage%	Ownership Percentage%
Name	Name
-	
Address	Address
Ownership Percentage%	Ownership Percentage %
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Address	Address
Ownership Percentage%	Ownership Percentage%
Name	Name
Address	Address
Ownership Percentage%	Ownership Percentage%

To Mr. Diamond and members of the Building Review Board,

Thank you for the opportunity to share our future home. We have deep roots to the City of Lake Forest as we both grew up here and met each other at Lake Forest High School. If we were lucky enough, we dreamt of going back and eventually raising a family in Lake Forest. We now have two little one's ages 2 years old and 4 months — Tatum and Barrett. They are the inspiration for this home. The layout and renderings of our quaint "English Cottage" were intentionally done in a way that make the home timeless, warm, and inviting.

Lastly, we really appreciate the time and effort in reviewing our future home!

Best,

Andy and Maggie Timson





Jennifer Baehr The City of Lake Forest Community Development Department 800 N. Field Drive Lake Forest, IL 60045

September 20, 2021

Re: The Timson Residence

Ms. Baehr,

We are respectfully requesting the Building Review Boards consideration and approval of the planned two-story residence for Andrew and Maggie Timson on Lot #7 in Oak Knoll Woodlands subdivision. The proposed architectural vernacular embraces the English Cottage style found throughout the British countryside. This interpretation is more akin to the coastal villages of North Wales where white painted brick, stone and stucco are applied to offer a stark contrast to the pastoral seaside background. Roof forms are generally a combination of steep hip and gabled eaves with subtle design elements to offer a charming aesthetic. Roughhewn cedar window and door headers have been implemented to express the casual nature of this quaint traditional character and capture the true historic essence of this classic architectural style.

The proposed exterior materials will be as follows:

Roof: Medium cedar shingles

Stucco: Soft-white with troweled finish

Brick Veneer: Painted white brick and mortar

Windows: SDL aluminum clad casement (Classic White)

Timber header above windows: Rough sawn cedar (stained natural cedar tone)

Exposed flashings: Copper

Exterior Trim: cedar (White)

Porch and Steps: Stone pavers

Front Door: Painted Insulated (Cabot's Federal Blue)

Gutters & Downspouts: Seamless aluminum (White)

Garage Doors: Insulated fiberglass overhead door (natural stained wood)

We appreciate this opportunity to present the proposed Timson residence on October 6th. Please let me know if you should have any questions or further information and thank you for your assistance in processing this application.

Respectfully,

Rick Swanson AIA, NCARB

R.M. Swanson Architects PC





THE CITY OF LAKE FOREST BUILDING REVIEW BOARD APPLICATION DESCRIPTION OF EXTERIOR MATERIALS

Façad	e Mat	terial				
	□ ⊠ □ ⊠ Color	Stone Brick Wood Clapboard Siding Stucco r of Material		Wood Shingle Aluminum Siding Vinyl Siding Synthetic Stucco Other		
Windo		eatment				
**IIIGO		ary Window Type	Finish and Color of Windows			
		Double Hung Casement Sliding Other		Wood Aluminum Clad Vinyl Clad Other of Finishclassic white		
	Wind	dow Muntins				
		Not Provided True Divided Lites				
	Simu	llated Divided Lites				
		Interior and Exterior muntin bars Interior muntin bars only Exterior muntin bars only Muntin bars contained between the glass				
Trim N	lateri	ial				
	Door Trim			Window Trim		
<u> </u>		Limestone Brick Wood Synthetic Material Other		Limestone Brick Wood Synthetic Material Other		
F	ascia	as, Soffits, Rakeboards				
		Wood OtherSynthetic Material				

THE CITY OF LAKE FOREST BUILDING REVIEW BOARD APPLICATION DESCRIPTION OF EXTERIOR MATERIALS – CONTINUED

Chimney Ma	aterial		
	Brick Stone Stucco Other		
Roofing			
Prima	ary Roof Material	Flasi	ning Material
	Wood Shingles Wood Shakes Slate Clay Tile Composition Shingles Sheet Metal Other		Copper Sheet Metal Other
Color	of Material		
Gutters and	Downspouts		
X	Copper Aluminum Other		
Driveway M			
	Asphalt Poured Concrete Brick Pavers Concrete Pavers Crushed Stone Other		
Terraces an	nd Patios		
	Bluestone Brick Pavers Concrete Pavers Poured Concrete Other stone pavers		

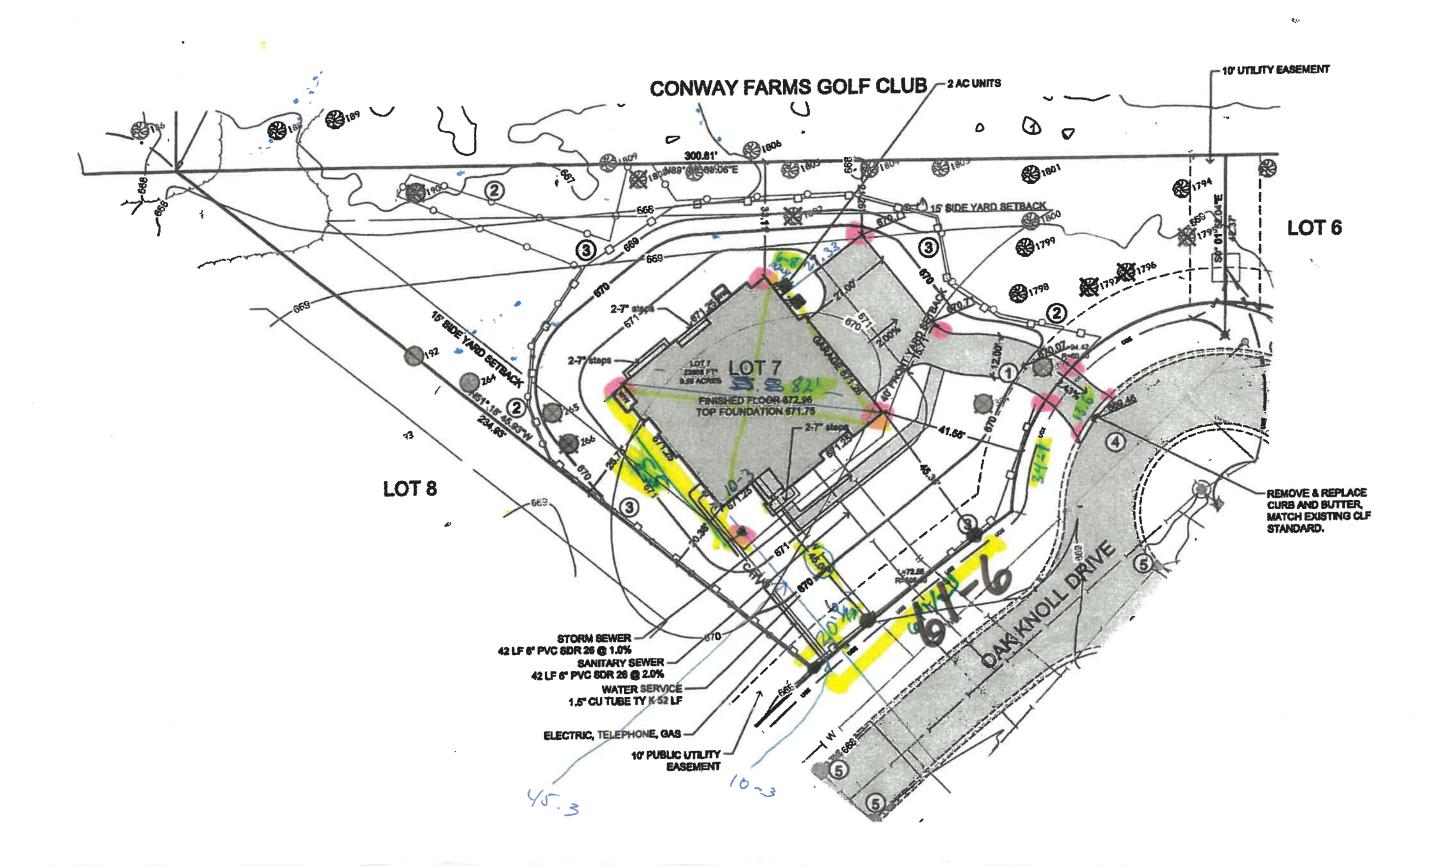


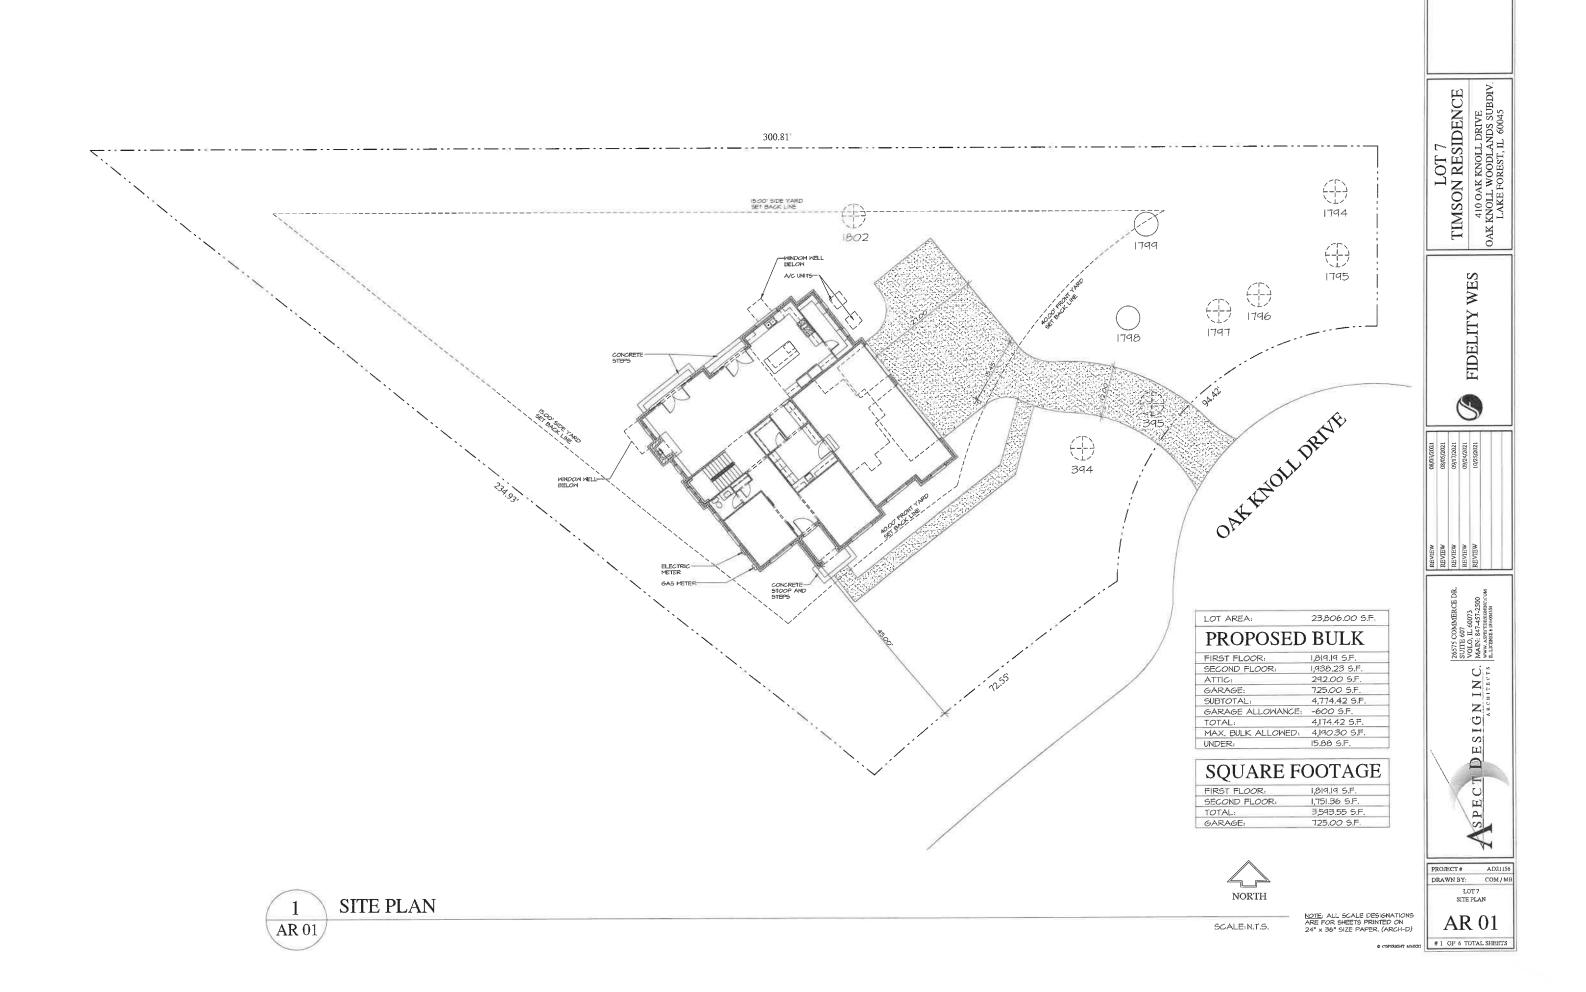







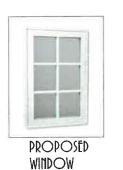





(OLOR



TRIM (OLOR





PROPOSED GUTTER & DOWNSPOUT (OLOR


EXTERIOR WALL SCONCE COLOR



4 LEFT SIDE ELEVATION

3/8" = 1'-0"




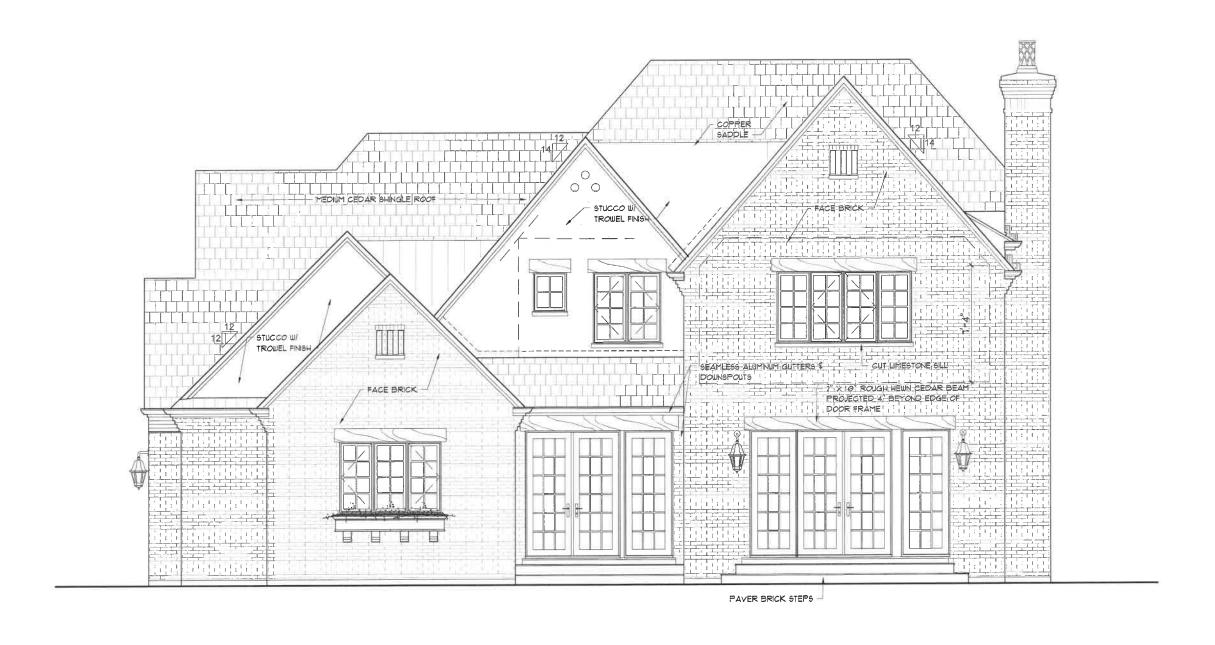

3 REAR SIDE ELEVATION

3/8" = 1'-0"



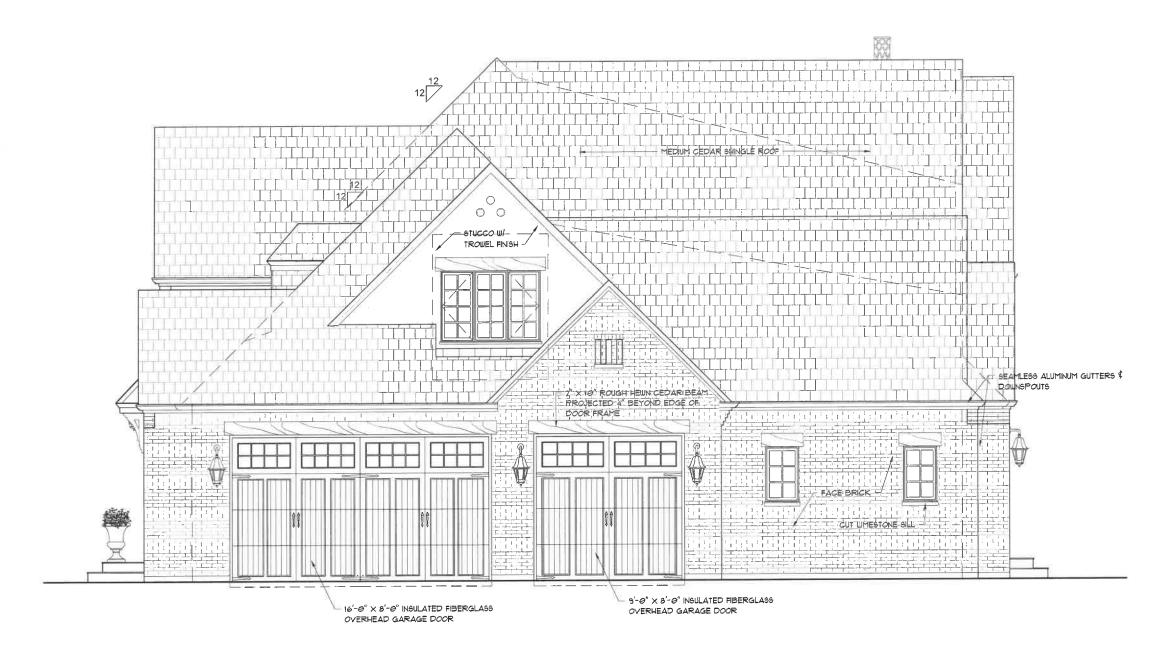


2 RICHT SIDE ELEVATION

3/8" = 1'-0"





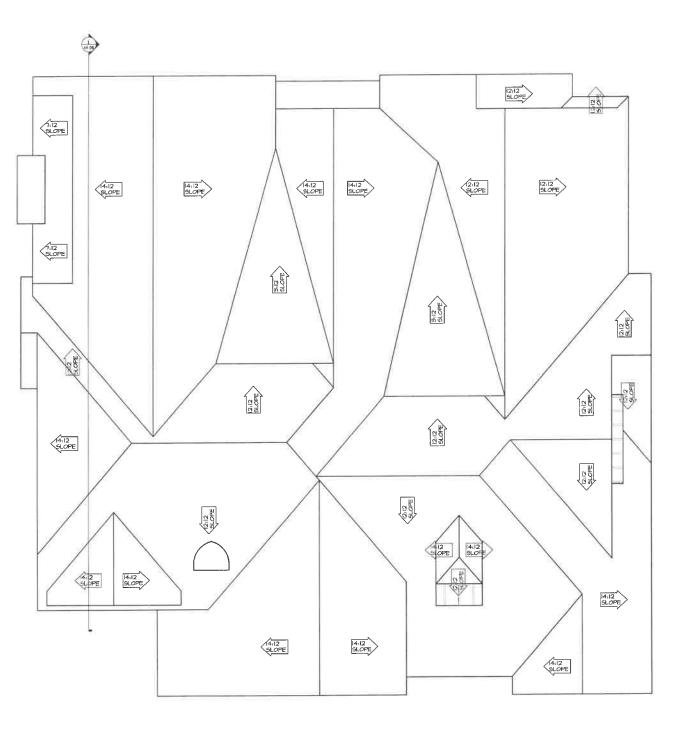

LOT 7
TIMSON RESIDENCE
410 OAK KNOLL DRIVE
OAK KNOLL WOODLANDS SUBDIV.
LAKE FOREST, IL. 60045 FIDELITY WES 9 STSTS COMMERCE DR. SUITE 607 U.C. IL 6073 VOLO. IL 6073 VO PROJECT# AD21156 DRAWN BY: COM/MB LOT 7 ROOF PLAN AR 05 COPYRIGHT MACK!


5 OF 6 TOTAL SHEETS

AR 05


ROOF PLAN


SCALE: N.T.S.

NOTE: ALL SCALE DESIGNATIONS ARE FOR SHEETS PRINTED ON 24" × 36" SIZE PAPER. (ARCH-D)

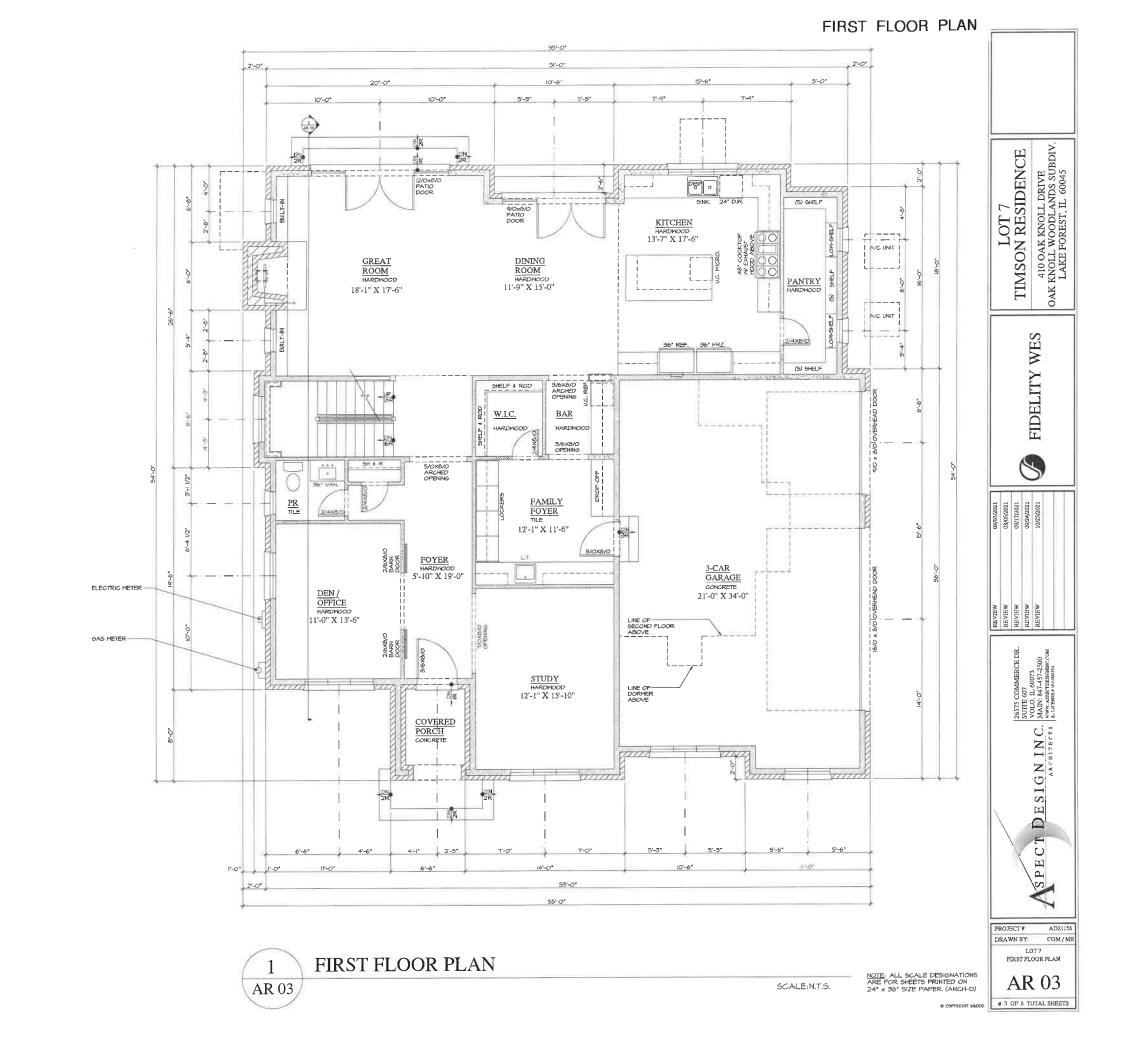

SECOND FLOOR PLAN

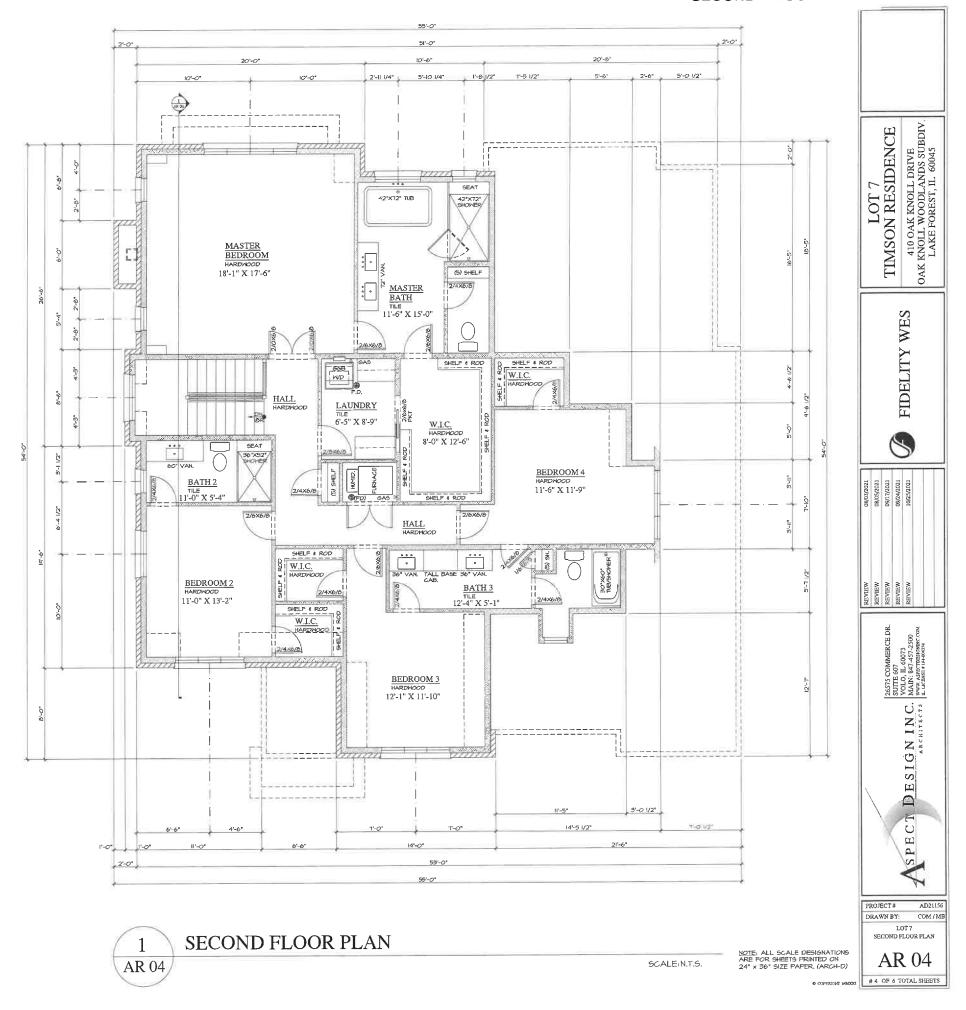

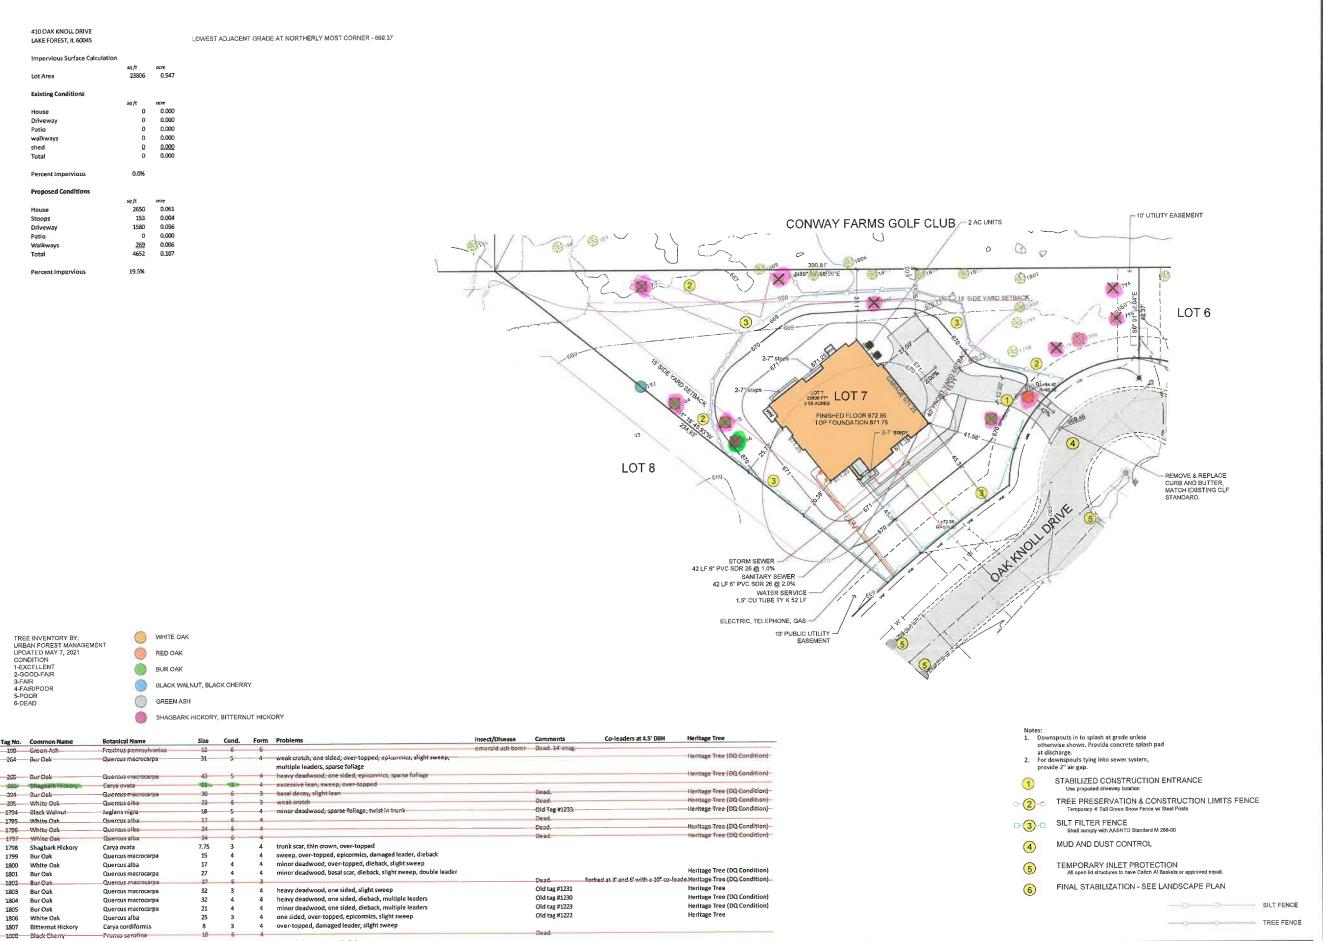

BLECK engineers surveyors Bleck Engineering Company, Inc. 1375 North Western Avenue Lake Forest, Illinois 60045 T847.295.5200 W bleckeng.com 410 OAK KNOLL DRIVE Lake Forest, IL City of Lake Forest Monument #10 Brass Disk in Concrete at NE Corner Oak Knoll Dr. & Conway Rd. Intersect Elev. 697.44 (NAVD 88) Site Benchmark: Mueller Nut on Fire Hydrant at Elev. 684.21 (NAVD 88) ISSUED DATE ISSUED FOR PROFESSIONAL SEAL
"To the best of our knowledge and beliet
the drainage of the surface waters will
not be changed by the construction of
this project or any part thereof, or that if
such surface waters drainage will be
changed, reasonable provisions have
been made for the collection and
diversion of such surface waters into
public areas or drains which the
developer has a right to use, and that
such surface waters will be planned for
in accordance with periorally accepted
angineering practices so as to reduce
the likelihood of the damage to the
adjoining property because of the
construction of the project."



Michael G. Bleck, PE 09.21.202

FIDELITY WES 201 Robert Parker Coffin Rd. Long Grove, Illinois 60045

70-859-7	Project No.
MB/CBS	Drawn By
MGB	Checked By
ting No	

Site Grading Plan

3

Red Oak

Quercus rubra

4 one sided, over-topped, slight sweep

Tag No.	Common Name	Size	Cond.	Form	Problems	Insect/Disease	Comments	Heritage Tree 5/7/20
190	Green Ash	12	6	6		emerald ash borer	Dead. 14' snag.	
264	Bur Oak	31	5	4	weak crotch, one sided, over-topped, epicormics, slight sweep, multiple leaders, sparse foliage			Heritage Tree (DQ Condition)
265	Bur Oak	43	5	4	heavy deadwood, one sided, epicormics, sparse foliage			Heritage Tree (DQ Condition)
266	Shagbark Hickory	11	3	4	excessive lean, sweep, over-topped			
394	Bur Oak	30	6	3	basal decay, slight lean		Dead.	Heritage Tree (DQ Condition)
395	White Oak	23	6	3	weak crotch		Dead.	Heritage Tree (DQ Condition)
1794	Black Walnut	18	5	4	minor deadwood, sparse foliage, twist in trunk		Old Tag #1233.	Heritage Tree (DQ Condition)
1795	White Oak	17	6	4			Dead.	
1796	White Oak	24	6	4			Dead.	Heritage Tree (DQ Condition)
1797	White Oak	24	6	4			Dead.	Heritage Tree (DQ Condition)
1798	Shagbark Hickory	7.75	3	4	trunk scar, thin crown, over-topped			
1799	Bur Oak	15	4	4	sweep, over-topped, epicormics, damaged leader, dieback			
1800	White Oak	17	4	4	minor deadwood, over-topped, dieback, slight sweep			
1801	Bur Oak	27	4	4	minor deadwood, basal scar, dieback, slight sweep, double leader			Heritage Tree (DQ Condition)
1802	Bur Oak	37	6	3			Dead.	Heritage Tree (DQ Condition)
1803	Bur Oak	32	3	4	heavy deadwood, one sided, slight sweep		Old tag #1231	Heritage Tree
1804	Bur Oak	32	4	4	heavy deadwood, one sided, dieback, multiple leaders		Old tag #1230	Heritage Tree (DQ Condition)
1805	Bur Oak	21	4	4	minor deadwood, one sided, dieback, multiple leaders		Old tag #1223	Heritage Tree (DQ Condition)
1806	White Oak	25	3	4	one sided, over-topped, epicormics, slight sweep		Old tag #1222	Heritage Tree
1807	Bitternut Hickory	8	3	4	over-topped, damaged leader, slight sweep			
1808	Black Cherry	10	6	4			Dead.	
1809	Red Oak	8	2	4	one sided, over-topped, slight sweep			

LANDSCAPE DEVELOPMENT PLAN

FIDELITY WES RESIDENCE

410 OAK KNOLL DRIVE LAKE FOREST, IL

	Legend				
Qty	Common Name	Botanical Name			
Flower, Perer	mial				
18 Daisy, St	nasta Banana Cream	Leucanthemum Banana Creem			
32 Mondo G	irass, Dwarf	Ophiopogon japonicus 'Nana'			
6 Sage, Ru	Beian	Perovskia atriplicifolia			
Shrub, Decida	IOUS				
3 Dogwood	d, Baileys Red Twig	Cornus sericea 'Bailey's'			
	d, Yellow Twig	Comus sericea 'Yellow Twig'			
	ea, Endless Summer Hedge	Hydrangea macrophylla 'Endless Summer			
	ea, Incrediball	Hydrangea arbonescens 'Abetwo'			
	uble Knockout	Rosa Double Knockout			
	reen Broadleaf				
	t, Micro Green Velvet	Buxas x 'Green Velvet'			
Shrub, Everge	reen Conifer				
8 Yew, Hic		Taxus "Hicksii"			
Tree, Decidus	ous				
3 Clak, Bur		Quercus macrocarpa var. olivaeformis			
1 Oak, Enc	alish	Quercus robur			
1 Oak Scr		Quercus coccinea			
2 Oak, Sw	amo White	Quercus bicolor			
2 Pear, Cle		Pyrus calleryana 'Cleveland Select'			
	e, London, Liberty	Platanus x acerifolia 'Liberty'			
Tree, Evergre	en				
	ae, Green Giant	Thuja 'Green Giant'			
	Norway Argento	Picea abies 'Argenteospicata'			


ALL PERENNIALS ARE IN 1 GALLON CONTAINER.
ALL SHRUBS ARE 36" OR GREATER, EXCEPT BOXWOODS
ALL CANOPY TREES ARE 3"
ALL EVERGREEN TREES ARE 8'



SCALE: 1" = 20' SEPTEMBER 22, 2021 PAGE 2 OF 2

PREPARED BY:



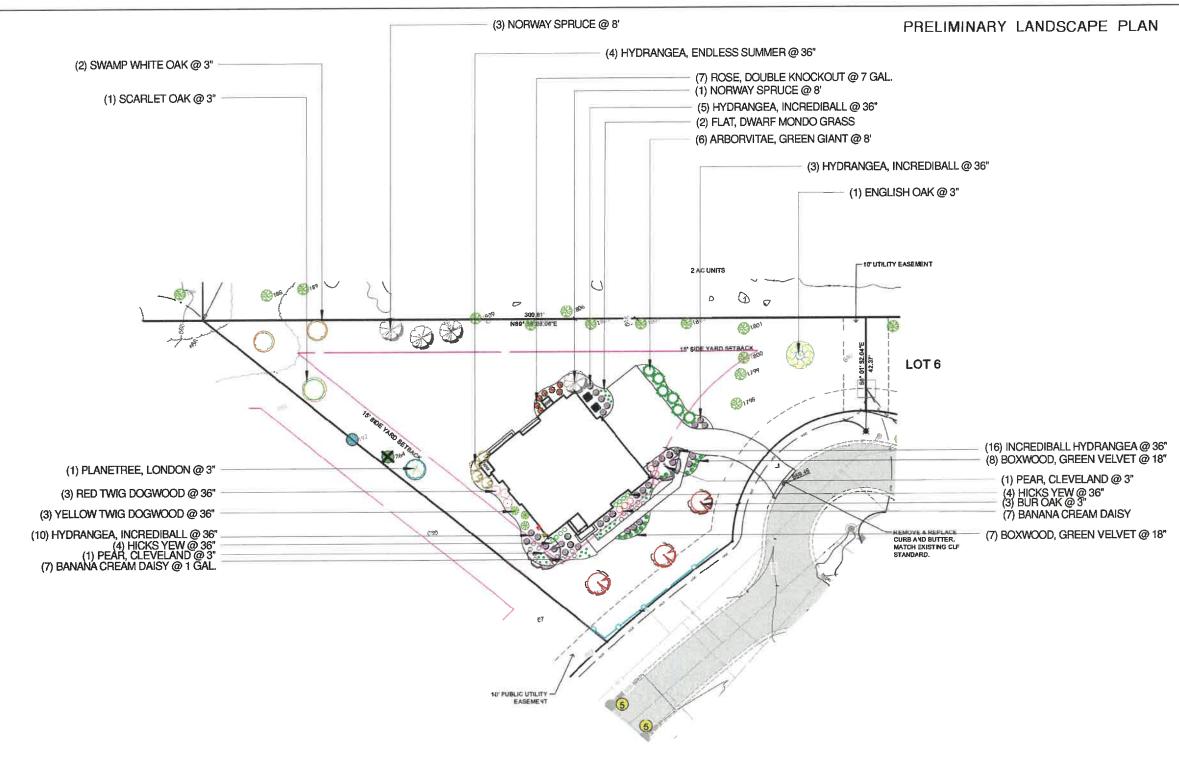

TOTAL REQUIRED TREE REPLACEMENT INCHES: 22 TOTAL REPLACEMENT INCHES IN LANDSCAPE PLAN: 24 REPLACEMENT INCH SURPLUS: 2

	· 1	Heritage Tree	Form	Cond.	Size	Butanical Name	Common Name	LOT NUMBER	Teg No.
			4	3	7.75	Carya ovata	Shagbork Hickory	7	1798
			4	4	15	Quercus macrocarpa	Bur Oak	7	1799
			4	4	17	Quercus alba	White Oak	7	1800
		Y	4	4	27	Quercus macrocarpa	Bur Oak	7	1801
	L	Y	4	3	32	Quercus macrocarpa	Bur Oak	7	1803
	i	Y	4	4	32	Quercus macrocarpa	Bur Oak	7	1804
		Y	4	4	21	Quercus macrocarpa	Bur Oak	7	1805
		Y	4	3	25	Quercus alba	White Oak	7	1806
			4	3	8	Carya cordiformis	Bitternut Hickory	7	1807
			4	2	8	Quercus rubra	Red Oak	7	1809
Inches	Replace?	Heritage?	Form	Cond.	Size	Botanical Name	Common Name	LOT NUMBER	Tag No.
	N :	N	6	6	12	i Fraxinus pennsylvanica	Green Ash	7	190
	N] Y	4	5	31	Quercus macrocarpa	Bur Oak	7	264
	N	I Y	4	5	43	Quercus macrocarpa	Bur Oak	7	265
22	Y	Υ	4	3	11	Carya ovata	Shagbark Hickory	7	266
	N	Υ	3	6	30	Quercus macrocarpa	Bur Oak	7	394
	N	Υ	3	- 6	23	Quercus alba	White Oak	7	395
	N I	γ	4	5	18	Juglans nigra	Black Walnut	7	1794
	N ;	N	Δ	- 6	1 17	Quercus alba	White Oak	7	1795
	N	l Y	4	6	24	Quercus alba	White Oak	7	1796
	N i	Y	4	6	24	Quercus alba	White Dak	7	1797
	N	Y	3	6	37	Quercus macrocarpa	Bur Oak	7	1802
	N I	N	4	6	10	Prunus serolina	Black Cherry	7	1808



Carlos Tapia Don Beto and Co, LLC 888 Tower Road Unit C Mundelein, IL 60060

RE: Hardscape at 410 Knoll Drive

To Whom It May Concern,

The sidewalk and stoops at 410 Oak Knoll Drive in Lake Forest will be constructed using an Open Graded Base up to ICPI standards and built using the following materials:


Stoop and Sidewalk:
Arctic Natural Cleft Pavers
Techo Bloc Squadra in Onyx Black
Techo Bloc Rafinatto Cap









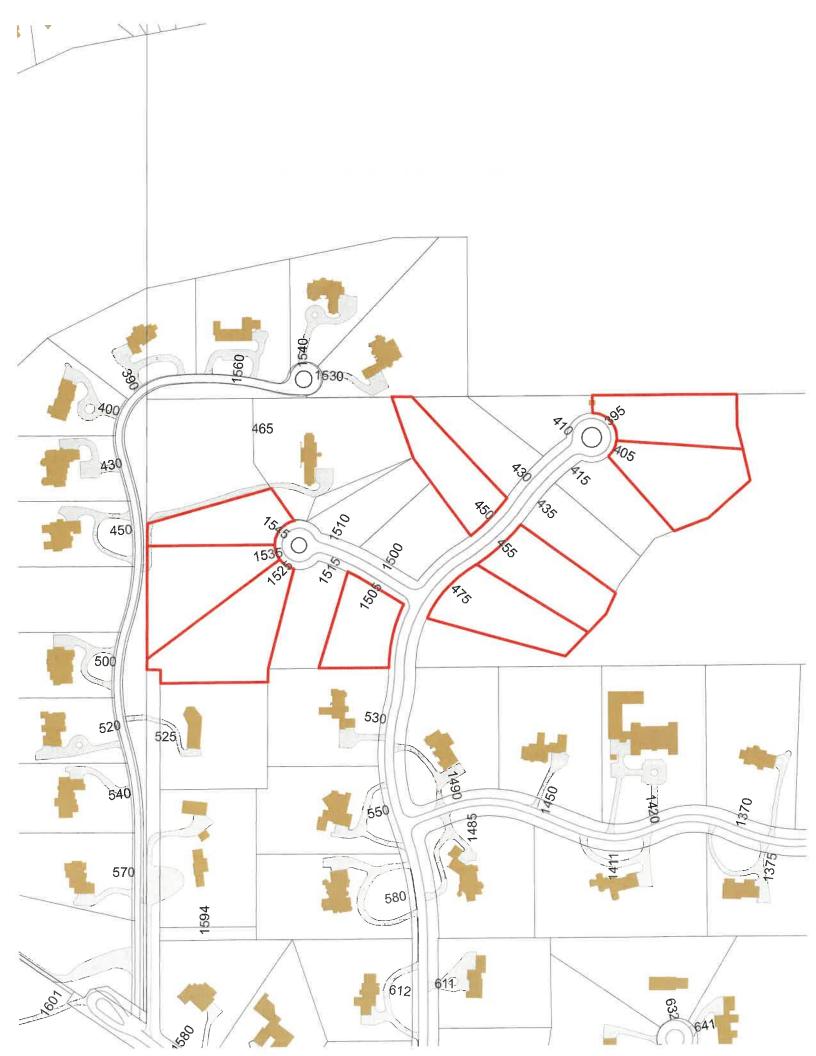



5:\Project Foldern - Shandig70 Lake Peneti859 Holestey Wes\70-639 Appr \$GP.cts, ABCH full bleed D (56.00 x 24.00 Inches), 10/26/2021 S:17 PH, H

REVIEW REVIEW REVIEW

1525 SAGE COURT OAK KNOLL WOODLANDS SUBDIV. LAKE FOREST, IL 60045

FIDELITY WES

ESIGNINC.

4

AD20208

COM / MI

LOT 14 BAKAS RESIDENCE

LOT 14 EXTERIOR ELEVATIONS AR 02 # 2 OF 9 TOTAL SHEETS

PROJECT# DRAWN BY:

NOTE: ALL SCALE DESIGNATIONS ARE FOR SHEETS PRINTED ON 24" × 36" SIZE PAPER. (ARCH-D)

SCALE: 1/4"=1'-0"

SCALE: N.T.S.

FIDELITY WES

SPECT DESIGNING.

PROJECT # AD20202 DRAWN BY: COM / MB LOT 12 EXTERIOR ELEVATIONS

AR 01 # 1 OF 14 TOTAL SHEETS

FRONT ELEVATION

AR 01















PROJECT# DRAWN BY: COM / MB EXTERIOR ELEVATIONS

WES

FIDELITY

ESIGNINC.

0

ASPECT

AR 02

AD21144

AR 02/

FRONT ELEVATION (EAST)

SCALE: N.T.S.

NOTE: ALL SCALE DESIGNATIONS ARE FOR SHEETS PRINTED ON 24" × 36" SIZE PAPER. (ARCH-D)